SYMBOL	DESCRIPTION	SYMBOL	DESCRIPTION
	CEILING MOUNTED LINEAR LUMINAIRE. DIMENSIONS AS SHOWN. REFER TO SCHEDULE FOR TYPE.	<b></b>	CEILING MOUNTED WALL WASHER LUMINAIRE. ILLUMINATION DIRECTION DENOTED BY HATCHED SIDE.
//////////////////////////////////////	DENOTES FIXTURE ON EMERGENCY/NIGHT LIGHT CIRCUIT.	$\Delta\Delta\Delta$	CEILING MOUNTED TRACK LIGHTING C/ NUMBER OF FIXTURES.
Ş	WALL MOUNTED LINEAR LUMINAIRE. DIMENSIONS AS SHOWN. REFER TO SCHEDULE FOR TYPE.	ф	WALL MOUNTED LUMINAIRE
	CEILING MTD. LUMINAIRE OR BASKET LUMINAIRE. LAMP ORIENTATION AS SHOWN. REFER TO SCHEDULE FOR TYPE.	<del> </del>	PENDANT FIXTURE
	EXISTING LUMINAIRE TO BE REMOVED	¢	CEILING MOUNTED LUMINAIRE
	EXISTING LUMINAIRE TO REMAIN	囹	FLOOR MOUNTED LUMINAIRE
	POLE MOUNTED LUMINAIRE. NUMBER OF HEADS SHOWN. REFER TO SCHEDULE FOR FIXTURE AND POLE TYPE.	<del>Г</del> ф-І	TRACK LIGHT WITH PENDANT LUMINAIR AS INDICATED
00000	CEILING MOUNTED LUMINAIRE WITH GIMBALLED HEADS. REFER TO SCHEDULE FOR TYPE AND NUMBER OF HEADS.	<del>-</del> +	BOLLARD LUMINAIRE
모	VERTICAL WALL MOUNTED FLUORESCENT LUMINAIRE		
	CONTINUOUS STRIP LIGHT. REFER TO SCHEDULE FOR FIXTURE TYPE.		
	STAGGERED COVE LIGHT. DIMENSIONS AND NUMBER OF FIXTURES SHOWN. REFER TO SCHEDULE FOR FIXTURE TYPE.		
•	RECESSED CEILING MOUNTED REMOTE ADJUSTABLE LUMINAIRE CONNECTED TO EMERGENCY LIGHTING BATTERY UNIT.	B	EMERGENCY LIGHTING BATTERY UNIT ON NUMBER OF HEADS SHOWN
Î	WALL MOUNTED EMERGENCY SINGLE REMOTE HEAD	□B_IP	EMERGENCY LIGHTING BATTERY UNIT
<b>5.</b>	WALL MOUNTED EMERGENCY DOUBLE REMOTE HEAD		EMERGENCY LIGHTING BATTERY + EXI LIGHT COMBINATION UNIT C/W NUMBE OF HEADS SHOWN
7	CEILING MOUNTED EMERGENCY SINGLE REMOTE HEAD	<u> </u>	EXIT LIGHT CEILING MOUNTED C/W FA AND ARROWS AS INDICATED
<b>C</b> >	CEILING MOUNTED EMERGENCY DOUBLE REMOTE HEAD	<b>₩</b>	EXIT LIGHT WALL MOUNTED C/W FACE AND ARROWS AS INDICATED

7 LIGHT	TING LEGEND 1		
SYMBOL	DESCRIPTION	SYMBOL	DESCRIPTION
\$	SINGLE POLE LINE VOLTAGE LIGHT SWITCH		
\$	2 GANG - LINE VOLTAGE LIGHT SWITCH		
\$	3 GANG - LINE VOLTAGE LIGHT SWITCH		
<b>\$</b> 3	3 WAY - LINE VOLTAGE LIGHT SWITCH		
<b>\$</b> <sup>4</sup>	4 WAY - LINE VOLTAGE LIGHT SWITCH		
\$ <sup>LV</sup>	LOW VOLTAGE LIGHT SWITCH		
<b></b> \$ <sup>K</sup>	KEY OPERATED LINE VOLTAGE SWITCH		
\$ <sup>MS</sup>	MASTER SWITCH		
\$ <sup>AO</sup>	ALL-OFF SWITCH		
\$	SINGLE POLE 347V SWITCH		
Φ	DIMMER TYPE TO SUIT LOAD		
PC	CEILING MOUNTED PHOTO CELL SWITCH		
PC	WALL MOUNTED PHOTO CELL SWITCH		
	DAY LIGHT PHOTO SENSOR		
Ø	TIME SWITCH		
OS)'X'	CEILING MOUNTED OCCUPANCY SENSOR.  TYPE DENOTED BY 'X'. REFER TO OCCUPANCY SENSOR SCHEDULE.		
OS 'X'	WALL MOUNTED OCCUPANCY SENSOR. TYPE DENOTED BY 'X'. REFER TO OCCUPANCY SENSOR SCHEDULE.		
LC	LIGHTING CONTROL MODULE		
DIM	MULTI-ZONE LIGHTING CONTROL PANEL		
RS	REMOTE STATION WITH PRESET SCENE SELECTION BUTTON		
[IR]	PARTITION POSITION INFRARED SENSOR FOR LIGHTING CONTROL		

NOTE: NOT ALL SYMBOLS APPLY, REFER TO FLOOR PLANS AND DRAWINGS

8 LIGHTING LEGEND 2

6 FIRE ALARM LEGEND 2

SYMBOL

DESCRIPTION

CEILING MOUNTED PHOTO-ELECTRIC SMOKE DETECTOR

CEILING MOUNTED PHOTO-ELECTRIC

SMOKE DETECTOR C/W RELAY BASE

DETECTOR

DETECTOR

HEAT DETECTOR

CEILING MOUNTED RATE-OF-RISE HEAT

WALL MOUNTED RATE-OF-RISE HEAT

CEILING MOUNTED FIXED TEMPERATURE

WALL MOUNTED FIXED TEMPERATURE

DUCT TYPE PHOTO-ELECTRIC SMOKE

CEILING MOUNTED COMBINATION HEAT + SMOKE DETECTOR

LOCAL 120V COMBINATION CARBON

MONOXIDE AND SMOKE ALARM

LOCAL 120V CARBON MONOXIDE DETECTOR

LOCAL 120V COMBINATION STROBE AND SMOKE ALARM

LOW PRESSURE SUPERVISED SWITCH

NOTE: NOT ALL SYMBOLS APPLY, REFER TO FLOOR PLANS AND DRAWINGS

SPRINKLER SUPERVISED VALVE

(SUPPLIED BY OTHERS)

(SUPPLIED BY OTHERS)

LOCAL 120V SMOKE ALARM

WALL MOUNTED PHOTO-ELECTRIC SMOKE

SYMBOL

FS

DPV

BDTX

ALARM INITIATING DEVICES

SUPERVISORY INITIATING DEVICES

DESCRIPTION

AIR SAMPLING SYSTEM C/W

MANUAL PULL STATION

OTHERS)

OTHERS)

OTHERS)

OTHERS)

FLAME DETECTOR

SUPERVISORY AND ALARM ZONE

ALARM FLOW SWITCH (SUPPLIED BY

ALARM CHECK VALVE (SUPPLIED BY

ALARM DRY PIPE VALVE (SUPPLIED BY

BEAM SMOKE DETECTOR (TRANSMITTER)

BEAM SMOKE DETECTOR (RECEIVER)

ALARM PRESSURE SWITCH (SUPPLIED BY

SYMBOL	DESCRIPTION	SYMBOL	DESCRIPTION
	SIGNALING	DEVICES	
×	HORN	<u>s</u>	CEILING MOUNTED EMERGENCY EVACUATION SPEAKER
	DOUBLE SIDED HORN	<u>©</u>	WALL MOUNTED EMERGENCY EVACUATION SPEAKER
<b>☆</b>	HORN+STROBE COMBINATION. STROBE INTENSITY TO BE MIN. 15CD UNLESS OTHERWISE NOTED.  DOUBLE SIDED HORN+STROBE COMBINATION. STROBE INTENSITY TO BE MIN. 15CD UNLESS OTHERWISE NOTED.	<b>*</b> S*	CEILING MOUNTED EMERGENCY EVACUATIONS SPEAKER + STROBE COMBINATION. STROBE INTENSITY TO BE MIN. 15CD UNLESS OTHERWISE NOTED.
<b>X</b>	MINI HORN SPEAKER HORN	<b>₽</b>	WALL MOUNTED EMERGENCY EVACUATION SPEAKER + STROBE COMBINATION. STROBE INTENSITY TO BE MIN. 15CD UNLESS OTHERWISE NOTED.
	FIRE ALARM BELL. 103mm(4") UNLESS OTHERWISE NOTED.	₩	CEILING MOUNTED FIRE ALARM STROBE. STROBE INTENSITY TO BE MIN. 15CD UNLESS OTHERWISE NOTED.
	FIRE ALARM BELL/STROBE. 103mm(4") BELL UNLESS OTHERWISE NOTED. 15CD INTENSITY UNLESS OTHERWISE NOTED.	₩	WALL MOUNTED FIRE ALARM STROBE. STROBE INTENSITY TO BE MIN. 15CD UNLESS OTHERWISE NOTED.
SS	10 MINUTES SILENCE SWITCH FOR SPEAKERS IN SUITES		
	ANCILLARY	DEVICES	
ISO.	ISOLATION MODULE	PACP	TROUBLE AND ALARM CONNECTION TO PRE-ACTION CONTROL PANEL
CTL	FIELD INSTALLED ADDRESSABLE CONTROL POINT	Þ	FLOOR MOUNTED DOOR HOLD OPEN DEVICE
FIRE	"FIRE, DO NOT ENTER" SIGN	н	WALL MOUNTED DOOR HOLD OPEN DEVICE
FPG	FIRE ALARM PASSIVE GRAPHIC		FIRE ALARM PANEL. CONTROL, DGP OR ANNUNCIATOR AS NOTED.
VDT	VIDEO DISPLAY TERMINAL, FOR BUILDING OPERATIONS PERSONNEL	<b>-</b> √√-	END-OF-LINE RESISTOR TERMINATION
HS	SUPERVISED FIRE FIGHTERS HAND SET	<b>□</b> ##	SMOKE DAMPER, USED IN CONJUNCTION WITH MONITORING DEVICE FOR POSITION ANNUNCIATION AND CONTROL DEVICE
FASD	FIRE ALARM SHUT DOWN		
FASU	FIRE ALARM START UP		
RT	REMOTE TESTING STATION FOR DUCT SMOKE DETECTORS		
MON	FIELD INSTALLED MONITORING MODULE FOR ALARM OR SUPERVISORY		

DESCRIPTION DESCRIPTION SYMBOL SYMBOL OUTLET(S). CABLE TYPE AS PER EMERGENCY PHONE STATION. CABLE TYP AS PER SPECIFICATION SPECIFICÁTION
WALL MOUNTED ABOVE COUNTER VOICE WALL MOUNTED ABOVE COUNTER VOICE AND DATA OUTLET(S). CABLE TYPE AS PER SPECIFICATION OUTLET FOR EMERGENCY PHONE STATION. CABLE TYPE AS PER SPECIFICATION WALL MOUNTED VOICE OUTLET(S). CABLE COMMUNICATIONS INTERCOM TYPE AS PER SPECIFICATION. WALL MOUNTED ABOVE COUNTER VOICE OUTLET(S). CABLE TYPE AS PER SPECIFICATION. SERVICE POLE MOUNTED VOICE AND DATA OUTLET(S). CABLE TYPE AS PER SPECIFICÁTION.

RACEWAY MOUNTED VOICE AND DATA WALL MOUNTED DATA OUTLET(S). CABLE OUTLET(S). CABLE TYPE AS PER TYPE AS PER SPECIFICATION. SPECIFICÁTION. WALL MOUNTED ABOVE COUNTER DATA OUTLET(S). CABLE TYPE AS PER COAXIAL CATV OUTLET LOOR MOUNTED VOICE AND DATA MAIN CABLE SUPPORT ROUTE FOR OUTLET(S). CABLE TYPE AS PER -J-J-J-J-COMMUNICATIONS CABLING SPECIFICATION. FLOOR MOUNTED VOICE OUTLET(S). CB COMMUNICATIONS BOX CABLE TYPE AS PER SPECIFICATION. FLOOR MOUNTED DATA OUTLET(S). CABLE POWER ZONE BOX TYPE AS PER SPECIFICATION. FURNITURE MOUNTED VOICE AND DATA OUTLET(S). CABLE TYPE AS PER TELEPHONE ZONE BOX SPECIFICATION. FURNITURE MOUNTED VOICE OUTLET(S). CABLE TYPE AS PER SPECIFICATION. FURNITURE MOUNTED DATA OUTLET(S). CABLE TYPE AS PER SPECIFICATION. CEILING MOUNTED VOICE AND DATA OUTLET(S). CABLE TYPE AS PER SPECIFICATION. CEILING MOUNTED DATA OUTLET(S). CABLE TYPE AS PER SPECIFICATION. NOTE: NOT ALL SYMBOLS APPLY, REFER TO FLOOR PLANS AND DRAWINGS

3 DATA AND COMMUNICATIONS LEGEND

SYMBOL	DESCRIPTION	SYMBOL	DESCRIPTION
6	DETAIL NUMBER	12	SECTION NUMBER
E-01	DRAWING NUMBER	E-01	DRAWING NUMBER
4	REVISION NUMBER		REVISION BUBBLE
	AMPS	МО	MOTOR OPERATED
AD	ACCESS DOOR	MOD	MOTOR OPERATED DAMPER
AFCI	ARC FAULT CIRCUIT INTERRUPTER	MW	MICROWAVE
AFF	ABOVE FINISHED FLOOR	N	NEW
BBH	BASEBOARD HEATER	NC	NORMALLY CLOSED
BU	BATTERY UNIT	NIC	NOT IN CONTRACT
С	CONDUIT	NL	NIGHT LIGHT
CD	CANDELA	NO	NORMALLY OPEN
CL	CEILING MOUNTED	ос	OVER COUNTER
CS	CHARGING STATION	OL	OBSTRUCTION LIGHT
CV	CONVENTIONAL STYLE DEVICE	Р	PARABOLIC LOUVRE
D	DEDICATED	PL	PATIENT LIFT
DG	DEDICATED GROUND	R	RELOCATE
DHWT	DOMESTIC HOT WATER TANK	RA	RANGE
DNC	DEDICATED NEUTRAL + BOND	RC	REVISE EXISTING CIRCUIT
DR	LAUNDRY DRYER	RH	RANGE HOOD
DW	DISHWASHER	RIC	ROUGH IN AND CONNECT
E	EXISTING	RO	ROUGH IN ONLY
EF	EXHAUST FAN	RR	REMOVE AND REINSTALL
EM	EMERGENCY CIRCUIT	SC	SEPARATE CIRCUIT
EP	ELECTRICAL SUITE PANEL	SF	SYSTEM FURNITURE
ER	EXISTING TO BE REMOVED	SP	SUITE ALARM PANEL
F	REFRIGERATOR	SSP	SLAVE SUITE ALARM PANEL
FF	FLOOR FEED	TYP	TYPICAL
FFH	FORCE FLOW HEATER	UC	UNDER CABINET MOUNTED
FL	FLOOR MOUNTED	U	UPS CIRCUIT
GFCI	GROUND FAULT CIRCUIT INTERRUPTER	UH	UNIT HEATER
GFI	GROUND FAULT INTERRUPTER	UPS	UNINTERRUPTIBLE POWER SUPPLY
GND	GROUND	V V	VOLTS
HK	HOUSE KEEPING	T w	WATTS
HMT	HARMONIC MITIGATING TRANSFORMER	WG	WIRE GUARD
ICE	ICE MACHINE	WAP	WIRELESS ACCESS POINT
IG	ISOLATED GROUND	WF	WALL FEED
JB	JUNCTION BOX	WP	WEATHERPROOF
KW	KILOWATTS	x	EXPLOSION PROOF DEVICE + BACK
LV	LOW VOLTAGE	ZSCT	ZERO SEQUENCE CURRENT TRANSFO

DRAWING LIST

ELECTRICAL DRAWING LIST Sheet Number | Sheet Title GENERAL DRAWING LIST AND LEGEND LEGEND ELECTRICAL STANDARD DETAILS ELECTRICAL DETAILS E003 ELECTRICAL DETAILS E004 ELECTRICAL DETAILS SITE PLAN SITE PLAN - ELECTRICAL SCHEMATICS AND DIAGRAMS SINGLE LINE DIAGRAM POWER AND SYSTEMS GROUND LEVEL - POWER AND SYSTEMS E301 SECOND LEVEL - POWER AND SYSTEMS E302 ROOF - POWER AND SYSTEMS LIGHTING E400 GROUND LEVEL - LIGHTING SECOND LEVEL - LIGHTING PART PLANS AND DETAILS ENLARGED PLANS

REVISIONS AND ISSUES

DESCRIPTION

ISSUED FOR COSTING

ISSUED FOR TENDER

ISSUED FOR REVISED

TENDER/BUILDING PERMIT

3 ISSUED FOR BUILDING PERMIT 2021.09.09

maclennan jaunkalns miller architects 425 adelaide street west level 6

Contractor must check and verify all dimensions on the job, and report any discrepancies to the Architect before proceeding with the work.

DATE

2021.08.17

2021.08.27

2022.01.31

toronto ontario m5v 3c1 416 593 6796 www.mjmarchitects.com

TRITON ENGINEERING SERVICES LTD CIVIL ENGINEERS

18 ROBB BOULEVARD - UNIT 8 ORANGEVILLE, ONTARIO

TEL 519 941 0330 FAX 519 941 1830

BLACKWELL STRUCTURAL ENGINEERS

134 PETER STREET, SUITE 1301 TORONTO, ONTARIO, M5V 2H2 TEL 416.593.5300 FAX 416.593.4840

SMITH + ANDERSON MECHANICAL AND ELECTRICAL ENGINEERS

1100 - 100 SHEPPARD AVENUE EAST TORONTO, ONTARIO, M2N 6N5 TEL 416.487.8151 -




Smith + Andersen

1100 - 100 Sheppard Ave. East, Toronto On, M2N 6N5 416 487 8151 f 416 487 9104 smithandandersen.com

## SAYERS FOOD LIMITED

132 BURLEIGH STREET t: 705.656.4531 e: sayers@apsley.ca

NORTH ARROW

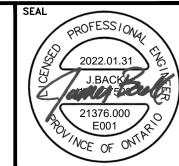

PROJECT TITLE

NEW SAYERS FOOD STORE BURLEIGH STREET, APSLEY

DRAWING TITLE

DRAWING LIST AND LEGEND

SCALE NTS

JUNE 16, 2021

PROJECT NUMBER

21376.000.e001

DRAWING NUMBER

LIGHTING SWITCH/RELAY
NUMBER
CIRCUIT NUMBER
PANEL LETTER PANEL LETTER

PANEL LETTER

BLANK'-NORMAL POWER
X-LIFE SAFETY EMERG.
E-NON-LIFE SAFETY EMERG.
U-UPS

FLOOR LOCATION:
B-BASEMENT
G-GROUND FLOOR
2-SECOND FLOOR

:

LAST
CHARACTERS
ONLY
SHOWN
ON
FLOOR
FLOOR
PLANS
FOR
CIRCUITING PANEL TYPE: 
SWGR-MAIN SWITCHGEAR
SWBD-SWITCHBOARD
DP-120/208V DISTRIBUTION PANELBOARD RP-120/208V RECEPTACLE/LIGHTING PANELBOARD LP-LIGHTING PANELBOARD (120V OR 347V, AS INDICATED)
SP-SPLITTER
LV-LOW VOLTAGE RELAY PANEL
TX-TRANSFORMER . PH-PENTHOUSE TRANSFORMER LETTER X-LIFE SAFETY E-EMERGENCY U-UPS TRANSFORMER -TRANSFORMER FLOOR LOCATION:
B-BASEMENT
G-GROUND FLOOR
2-SECOND FLOOR PH-PENTHOUSE

DESIGNATION DIAGRAM

GENERAL LEGEND AND ABBREVIATIONS

NOTE: NOT ALL SYMBOLS APPLY, REFER TO FLOOR PLANS AND DRAWINGS

SYMBO	DESCRIPTION	SYMBOL	DESCRIPTION	SYMBOL	DESCRIPTION	SYMBOL	DESCRIPTION
STWID			DESCRIPTION		ISOLATION TRANSFORMER - DELTA-WYE		
		ACCESS CONTROL  NEL KS	KEY SWITCH		UNLESS OTHERWISE NOTED.  ISOLATION TRANSFORMER WITH ELECTROSTATIC SHIELD — DELTA—WYE	DMS.	GROUND FAULT ALARM RELAY  IP BASED POWER QUALITY DIGITAL METER.  PROVIDE 21mm(3/4") CONDUIT TO
			LATCH BOLT MONITOR		UNLESS OTHERWISE NOTED.  MOLDED CASE CIRCUIT BREAKER, SIZE		PROVIDE 21mm(3/4") CONDUIT TO NEAREST TELECOM ROOM.  EMERGENCY GENERATOR
	AUTOMATIC DOOR OPERATOR	LRX	LATCH BOLT MONITOR REQUEST TO EXIT	——————————————————————————————————————	AS SHOWN  LOW VOLTAGE, DRAW—OUT CIRCUIT BREAKER, TRIP PLUG AND FRAME SIZE		GROUND CONNECTION POINT
	BIOMETRIC READER	MKR	MAGLOCK KEY RESET SWITCH	~~~	AS SHOWN  DRAW-OUT VACUUM CIRCUIT BREAKER, PROTECTIVE RELAY FUNCTIONS AND	Ē.	ELECTRONIC TRIP SETTING CONTROL (GROUND FAULT)
	CARD READER	MHO	MAGNETIC DOOR HOLD/OPEN DEVICE		FRAME SIZE AS SHOWN.  FUSIBLE LOAD BREAK ISOLATION SWITCH.  VOLTAGE, FUSE AND FRAME SIZE AS	<u> </u>	GROUND LOOP
	CENTRAL MANAGEMENT STATION	N ML	MAGNETIC LOCK		SHOWN. FUSE	HRG	HIGH RESISTANCE GROUND FAULT SYSTEM
	DOOR ALARM	MRX	MOTION REQUEST TO EXIT	-0-0-0-	INSULATED CASE CIRCUIT BREAKER	-> ⊶I'	LIGHTNING SURGE ARRESTOR
	DOOR CONTACT	PSCU	POWER SUPPLY CONTROL UNIT		INTEGRAL BREAKER AND STARTER UNIT, BREAKER AND FRAME SIZE AS SHOWN		LOAD BANK
EHO	ELECTRIC DOOR HOLD/OPEN D	DEVICE •	PUSH BUTTON DOOR OPERATOR		INTEGRAL SWITCH AND FUSE UNIT, FUSE AND FRAME SIZE AS SHOWN	LS	ELECTRONIC TRIP SETTING CONTROL (LONG, SHORT)
ELR	ELECTRIC LATCH RETRACTION	PRX	PUSH BUTTON REQUEST TO EXIT	-	LOAD BREAK ISOLATION SWITCH. VOLTAGE AND FRAME SIZE AS SHOWN.	[LSI]	ELECTRONIC TRIP SETTING CONTROL (LONG, SHORT, INSTANTANEOUS)
EML	ELECTRIC MORTISE LOCK	RR	REMOTE RELEASE	$\overline{\Sigma}$	AUTOMATIC TRANSFER SWITCH WITH BY-PASS	LSIG	ELECTRONIC TRIP SETTING CONTROL (LONG, SHORT, INSTANTANEOUS, GROUND FAULT)
ES	ELECTRIC STRIKE	RFN	RF NODE	$\triangleright$	AUTOMATIC TRANSFER SWITCH WITHOUT BY-PASS	(M)	METERING SOCKET
GTW	GATEWAY	RFR	RF RECEIVER		FIRE PUMP AUTOMATIC TRANSFER SWITCH AND STARTER UNIT (BY OTHERS)	<b>₩</b>	METERING CABINET
	IP DOOR CONTROLLER	⟨xx⟩	SECURITY DOOR TAG. XX DENOTES TYPE	=	MANUAL TRANSFER SWITCH OR DOUBLE THROW SWITCH	EM	DIGITAL ELECTRONIC METER
KEN	KEY ENCODER	WL	WIRELESS LOCK	(A)	AMMETER	-[SPD]	SURGE PROTECTION DEVICE
	REAL TIME	LOCATING SYSTE	M (RTLS)	<b>—</b>	AUTO-TRANSFORMER		
		(FRI)	RF READER MASTER	<b>⊣</b>    <del> </del>	BATTERY		
	RR INFRARED READER	(RFR)	RF READER	-C)-	CONTACTOR		
RDU	REMOTE DISPLAY UNIT	RFER	RF ETHERNET READER	⊱	CURRENT TRANSFORMER		
<u>[LAR</u>	LOCAL AREA RECEIVER	<b>RFLR</b>	RF LONG RANGE READER	<u> </u>	CURRENT TRANSFORMER (Z.S. – DENOTES ZERO SEQUENCE)		
5 SE	CURITY LEGEND 1			3 SINGL	E LINE DIAGRAM LEGEND 1		
	DESCRIPTION	CVMDOL	DESCRIPTION		DESCRIPTION	CYMDOL	DESCRIPTION
SYMBO		SYMBOL	DESCRIPTION			SYMBOL	DESCRIPTION
		IC PERSONAL PRO	_		POTENTIAL TRANSFORMER  ZERO SEQUENCE CURRENT TRANSFORMER	® ®	KEY INTERLOCK SYSTEM - ONE KEY  KEY INTERLOCK SYSTEM - N LOCKS,
	EMERGENCY PHONE STATION  STROBE LIGHT	DAS	DURESS ALARM STATION  PANIC ALARM RECEIVER		UPS DIODE	(E) (E)	N-1 KEYS UNLESS NOTED OTHERWISE  ELECTRONIC INTERLOCK SYSTEM - N
	PANIC BUTTON	ARS	ASSISTANCE REQUIRED SIGN	HØ	VOLTAGE INDICATOR	© <b>★</b>	MEDIUM VOLTAGE CABLE TERMINATION
		NTERCOM LEGEND	1	(195KW)	DENOTES CONNECT 'ED' LOAD APPLIED TO DESIGNATED APPARATUS.	TR]	POINT WITH STRESS CONE  ELECTRONIC TRANSFORMER TEMPERATURE RELAY
	INTERCOM	MIC	MASTER INTERCOM	PFC -KVAR	AUTOMATIC POWER FACTOR CORRECTION CAPACITOR SYSTEM, SIZE AS SHOWN.	[РМ]	POWER METER
ENT	ENTRY PHONE CONSOLE			<u> </u>	COMPLETE WITH TUNED INPUT FILTER.  HIGH RESISTANCE GROUNDING RESISTOR  – MAXIMUM CONTINUOUS AMPS AS	[DTU]	DIGITAL TRIP UNIT WITH METERING FUNCTION
	1	CCTV	1	50 51	SHOWN RELAY FUNCTION NUMBER	(ST)	SHUNT TRIP
	FIXED CAMERA	[CCTVSS]	CCTV SYSTEM SERVER			[GW]	IP BASED GATEWAY FOR POWER MONITORING
	PAN-TILT-ZOOM CAMERA	PI	POWER INJECTOR				
	PERSONAL COMPUTER	VM	VIDEO MONITOR				
	COMPUTER MONITOR		FIXED CCTV CAMERA HORIZONTAL ANGLE OF VIEW				
□ DVR	DIGITAL VIDEO RECORDER		LCD MONITOR, SIZE AS INDICATED				
NVR							
		RUSION DETECTIO	_				
	SIREN		INTRUSION DETECTION SYSTEM PANEL				
BG	BREAK GLASS SENSOR	POW	POWER SUPPLY WALL MOUNTED				
	MOISTURE SENSOR	<b>(4)</b>	SECURITY MOTION SENSOR  CEILING MOUNTED				
	KEYPAD	<b>(4)</b>	SECURITY 360° MOTION SENSOR				
NOTE:	IOT ALL SYMBOLS APPLY, REFER TO	O FLOOR PLANS AND DRA	WINGS	NOTE: NOT /	ALL SYMBOLS APPLY, REFER TO FLOOR F	LANS AND DRAV	VINGS
	CURITY LEGEND 2			4 SINGL	E LINE DIAGRAM LEGEND 2		
$\begin{pmatrix} 6 \\ E001 \end{pmatrix}$ S I	OOMII LLGENU Z			E001 SINGL	L LINE DIAGNAM LEGEND Z		

SYMBOL	DESCRIPTION	SYMBOL	DESCRIPTION
	ISOLATION TRANSFORMER — DELTA—WYE UNLESS OTHERWISE NOTED.	DSP	GROUND FAULT ALARM RELAY
	ISOLATION TRANSFORMER WITH ELECTROSTATIC SHIELD — DELTA—WYE UNLESS OTHERWISE NOTED.	DMS	IP BASED POWER QUALITY DIGITAL METER. PROVIDE 21mm(3/4") CONDUIT TO NEAREST TELECOM ROOM.
<b>⊸</b> ~	MOLDED CASE CIRCUIT BREAKER, SIZE AS SHOWN	<u>Q</u> -	EMERGENCY GENERATOR
<b>-≪^≫</b>	LOW VOLTAGE, DRAW-OUT CIRCUIT BREAKER, TRIP PLUG AND FRAME SIZE AS SHOWN	$\dot{\bar{\mathcal{T}}}$	GROUND CONNECTION POINT
<del>~</del>	DRAW-OUT VACUUM CIRCUIT BREAKER, PROTECTIVE RELAY FUNCTIONS AND FRAME SIZE AS SHOWN.	GF	ELECTRONIC TRIP SETTING CONTROL (GROUND FAULT)
→ □	FUSIBLE LOAD BREAK ISOLATION SWITCH. VOLTAGE, FUSE AND FRAME SIZE AS SHOWN.	Q	GROUND LOOP
	FUSE	HRG	HIGH RESISTANCE GROUND FAULT SYSTEM
-□-^-□-	INSULATED CASE CIRCUIT BREAKER	-• ⊶I'	LIGHTNING SURGE ARRESTOR
	INTEGRAL BREAKER AND STARTER UNIT, BREAKER AND FRAME SIZE AS SHOWN		LOAD BANK
	INTEGRAL SWITCH AND FUSE UNIT, FUSE AND FRAME SIZE AS SHOWN	LS	ELECTRONIC TRIP SETTING CONTROL (LONG, SHORT)
-~-	LOAD BREAK ISOLATION SWITCH. VOLTAGE AND FRAME SIZE AS SHOWN.	[LSI]	ELECTRONIC TRIP SETTING CONTROL (LONG, SHORT, INSTANTANEOUS)
$\longrightarrow$	AUTOMATIC TRANSFER SWITCH WITH BY-PASS	LSIG	ELECTRONIC TRIP SETTING CONTROL (LONG, SHORT, INSTANTANEOUS, GROUND FAULT)
$\supset$	AUTOMATIC TRANSFER SWITCH WITHOUT BY-PASS	<b>W</b>	METERING SOCKET
<b>&gt;</b>	FIRE PUMP AUTOMATIC TRANSFER SWITCH AND STARTER UNIT (BY OTHERS)	(W) (₩ <b>\</b>	METERING CABINET
	MANUAL TRANSFER SWITCH OR DOUBLE THROW SWITCH	EM	DIGITAL ELECTRONIC METER
(A)	AMMETER	-[SPD]	SURGE PROTECTION DEVICE
*	AUTO-TRANSFORMER		
<b>-</b> ₩ <del>-</del>	BATTERY		
-Ch	CONTACTOR		
⊱	CURRENT TRANSFORMER		
8_	CURRENT TRANSFORMER (Z.S. – DENOTES ZERO SEQUENCE)		
NOTE: NOT A	LL SYMBOLS APPLY, REFER TO FLOOR P	LANS AND DRAW	INGS

	J L		
GRAM LEGEND 1	7	1	POWER LEGEND 1
	7	E001	)

SYMBOL

DESCRIPTION

5-20R (T-SLOT)

VOLT, 15 AMP, CSA 5-15R

WALL MOUNTED DUPLEX RECEPTACLE 120

WALL MOUNTED ABOVE COUNTER DUPLEX

WALL MOUNTED DUPLEX RECEPTACLE 120

WALL MOUNTED ABOVE COUNTER DUPLEX

WALL MOUNTED DUPLEX RECEPTACLE 120

WALL MOUNTED DUPLEX RECEPTACLE 120

VOLT, 15 AMP, CSA 5-15R, DEDICATED

VOLT, 20 AMP, CSA 5-20R, DEDICATED

CONTROLLED DUPLEX RECEPTACLE 120

RECEPTACLE 120 VOLT, 15 AMP, CSA

WALL MOUNTED ABOVE COUNTER DUPLEX
GROUND FAULT RECEPTACLE 120 VOLT,
15 AMP, CSA 5-15R

WALL MOUNTED DUPLEX GROUND FAULT

WALL MOUNTED ABOVE COUNTER DUPLEX

RECEPTACLE 120 VOLT, 20 AMP CSA

GROUND FAULT RECEPTACLE 120 VOLT,

WALL MOUNTED QUADPLEX RECEPTACLE

WALL MOUNTED DUPLEX RECEPTACLE 120

WALL MOUNTED ABOVE COUNTER DUPLEX RECEPTACLE 120 VOLT, 15 AMP, 2 POLE, SPLIT CIRCUIT

VOLT, 15 AMP, 2 POLE, SPLIT CIRCUIT

WALL MOUNTED SIMPLEX RECEPTACLE

SPECIAL RECEPTACLE. TYPE AND DETAILS

WALL MOUNTED ABOVE COUNTER SIMPLEX

RECEPTACLE 120 VOLT, 15 AMP, CSA

WALL MOUNTED SIMPLEX RECEPTACLE

WALL MOUNTED SIMPLEX RECEPTACLE

WALL MOUNTED SIMPLEX RECEPTACLE

WALL MOUNTED SIMPLEX RECEPTACLE

NOTE: NOT ALL SYMBOLS APPLY, REFER TO FLOOR PLANS AND DRAWINGS

120 VOLT, 20 AMP, CSA 5-20R

250 VOLT, 30 AMP, CSA 14-30R

120 VOLT, 30 AMP, CSA 5-30R

250 VOLT, 50 AMP, CSA 14-50R

250 VOLT, 15 AMP, 30 CSA 15-15R

120 VOLT, 15 AMP, CSA 5-15R

20 AMP CSA 5-20R

AS NOTED ON DRAWING.

WALL MOUNTED DUPLEX GROUND FAULT

WALL MOUNTED, SPLIT SWITCH

VOLT, 15 AMP, CSA 5-15R

RECEPTACLE 120 VOLT, 15 AMP, CSA

VOLT, 20 AMP, CSA 5-20R (T-SLOT)

RECEPTACLE 120 VOLT, 20 AMP, CSA

SYMBOL

DESCRIPTION

QUADPLEX RECEPTACLE 120 VOLT, 15 AMP, CSA 5-15R. REFER TO DETAIL.

SHOWN) COMBINATION COMMUNICATION QUADPLEX RECEPTACLE 120 VOLT, 15 AMP, CSA 5-15R. REFER TO

FLOOR POKE THROUGH COMBINATION

COMMUNICATION / QUADPLEX
RECEPTACLE 120 VOLT, 15 AMP, CSA
5-15R. REFER TO CORRESPONDING

FLOOR POKE THROUGH AS ABOVE WITH

AUDIO/VISUAL REQUIREMENT. REFER TO

WALL MOUNTED COMBINATION COMMS./

DUPLEX RECEPTACLE 120 VOLT, 15 AMP,

CSA 5-15R. REFER TO CORRESPONDING

FLOOR POKE THROUGH COMBINATION

COMMUNICATION / DUPLEX RECEPTACLE 120 VOLT, 15 AMP, CSA 5-15R. REFER

FLOOR POKE THROUGH AS ABOVE WITH

AUDIO/VISUAL REQUIREMENT. REFER TO

SYSTEMS FURNITURE FEED POINT FOR

FLOOR, P= PAC POLE, WM = WIREMOLD

CEILING MOUNTED DUPLEX RECEPTACLE

CEILING MOUNTED SIMPLEX RECEPTACLE

CEILING MOUNTED QUADPLEX RECEPTACLE

FLOOR MOUNTED DUPLEX RECEPTACLE

FLOOR MOUNTED QUADPLEX RECEPTACLE 120 VOLT, 15 AMP, CSA 5-15R

SERVICE POLE, TYPE AS SPECIFIED C/W

120 VOLT, 15 AMP, CSA 5-15R

RACEWAY RECEPTACLE, TYPE AS

QUANTITY OF DEVICES INDICATED

Φ Φ SPECIFIED C/W QUANTITY OF DEVICES

INDICATED

POWER & COMMS. CABLING. LETTER DENOTES FEED LOCATION: W= WALL, F=

TO CORRESPONDING DETAIL.

FLOOR OR CEILING MOUNTED (AS

FLOOR OR CEILING MOUNTED (AS

CORRESPONDING DETAIL.

DUPLEX RECEPTACLE 120 VOLT,
15 AMP, CSA 5-15R. REFER TO DETAIL.

SHOWN) COMBINATION COMMUNICATION

DETAIL.

SYMBOL	DESCRIPTION	SYMBOL	DESCRIPTION
	FLUSH MOUNTED SINGLE TUB PANEL. RATING AS NOTED ON SINGLE LINE/PANEL SCHEDULE.	©	CONTACTOR
	FLUSH MOUNTED DOUBLE TUB PANEL RATING AS NOTED ON SINGLE LINE/PANEL SCHEDULE. SURFACE MOUNTED SINGLE TUB PANEL.	P	GROUND ROD WITH INSPECTION PIT
	RATING AS NOTED ON SINGLE LINE/PANEL SCHEDULE.	Ū	THERMOSTAT-16mm (1/2") CONDUIT ACCESSIBLE CEILING SPACE
	SURFACE MOUNTED DOUBLE TUB PANEL. RATING AS NOTED ON SINGLE LINE/PANEL SCHEDULE.	JB	JUNCTION BOX (SIZE SPECIFIED ON DRAWING)
	TRANSFORMER (SIZE NOTED ON SINGLE LINE DIAGRAM)		ELECTRIC UNIT HEATER
마	DISCONNECT		ELECTRIC BASEBOARD HEATER. 'X' DENOTES TYPE. REFER TO BASEBOAR HEATER SCHEDULE.
ď	COMBINATION MANUAL STARTER WITH INTEGRAL DISCONNECT	<u> </u>	GROUND BAR
	COMBINATION STARTER WITH INTEGRAL DISCONNECT	HD	HAND DRYER HARD WIRED CONNECTI
<b>(A)</b>	DIRECT CONNECTION	M	METER
	DIRECT CONNECTION C/W DISCONNECT	R	RELAY
	MOTOR C/W DISCONNECT	PB	PULL BOX
	MOTOR C/W RELAY DISCONNECT DISCONNECT	•————• •———•	GROUND BUS
	MOTOR C/W COMBINATION STARTER WITH INTEGRAL DISCONNECT	$\diamondsuit$	DENOTES RECEPTACLE TYPE. REFER RECEPTACLE SCHEDULE.
	VARIABLE FREQUENCY DRIVE AND VFD CABLE CONNECTION TO MOTOR. LINE		UTILITY METERING CABINET
	AND LOAD SIDE WIRING OF HARMONIC FILTER AND VFD BY ELECTRICAL CONTRACTOR. MOTOR, VFD AND	□	DOOR BELL/CHIME
	HARMONIC FILTER SUPPLIED BY MECHANICAL DIVISION.	Ф	CLOCK WALL MOUNTED
	VARIABLE FREQUENCY DRIVE. LINE AND LOAD SIDE WIRING OF HARMONIC	Ф	CLOCK CEILING MOUNTED
VFD	FILTER AND VFD BY ELECTRICAL CONTRACTOR, LOAD SIDE WIRING OF VFD TO BE VFD CABLE. VFD AND	•	PUSH BUTTON
	HARMONIC FILTER SUPPLIED BY MECHANICAL DIVISION.	NÒ	MOTOR
[Jeen]	HARMONIC FILTER (SUPPLIED BY MECH. CONTRACTOR UNLESS NOTED		
HF	OTHERWISE.) LINE AND LOAD SIDE WIRING OF HARMONIC FILTER BY ELECTRICAL CONTRACTOR.		

NOTE: NOT ALL SYMBOLS APPLY, REFER TO FLOOR PLANS AND DRAWINGS

POWER LEGEND 2

Contractor must check and verify all dimensions on the job, and report any discrepancies to the Architect before proceeding with the work. Do not scale this drawing.

REVISIONS AND ISSUES

DESCRIPTION DATE ISSUED FOR COSTING 2021.08.19 ISSUED FOR TENDER 2021.08.27 3 ISSUED FOR BUILDING PERMIT 2021.09.09 ISSUED FOR REVISED 2022.01.31 TENDER/BUILDING PERMIT

maclennan jaunkalns miller architects

toronto ontario m5v 3c1 416 593 6796 www.mjmarchitects.com

### TRITON ENGINEERING SERVICES LTD CIVIL ENGINEERS

18 ROBB BOULEVARD - UNIT 8

ORANGEVILLE, ONTARIO TEL 519 941 0330 FAX 519 941 1830

#### BLACKWELL STRUCTURAL ENGINEERS

134 PETER STREET, SUITE 1301 TORONTO, ONTARIO, M5V 2H2 TEL 416.593.5300 FAX 416.593.4840

## SMITH + ANDERSON

MECHANICAL AND ELECTRICAL ENGINEERS 1100 - 100 SHEPPARD AVENUE EAST TORONTO, ONTARIO, M2N 6N5 TEL 416.487.8151 -




Smith + Andersen

1100 — 100 Sheppard Ave. East, Toronto On, M2N 6N5 416 487 8151 f 416 487 9104 smithandandersen.com

## SAYERS FOOD LIMITED

132 BURLEIGH STREET t: 705.656.4531 e: sayers@apsley.ca

NORTH ARROW

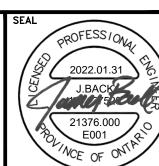

PROJECT TITLE

NEW SAYERS FOOD STORE BURLEIGH STREET, APSLEY


DRAWING TITLE LEGEND

SCALE NTS

JUNE 16, 2021

PROJECT NUMBER


21376.000.e001

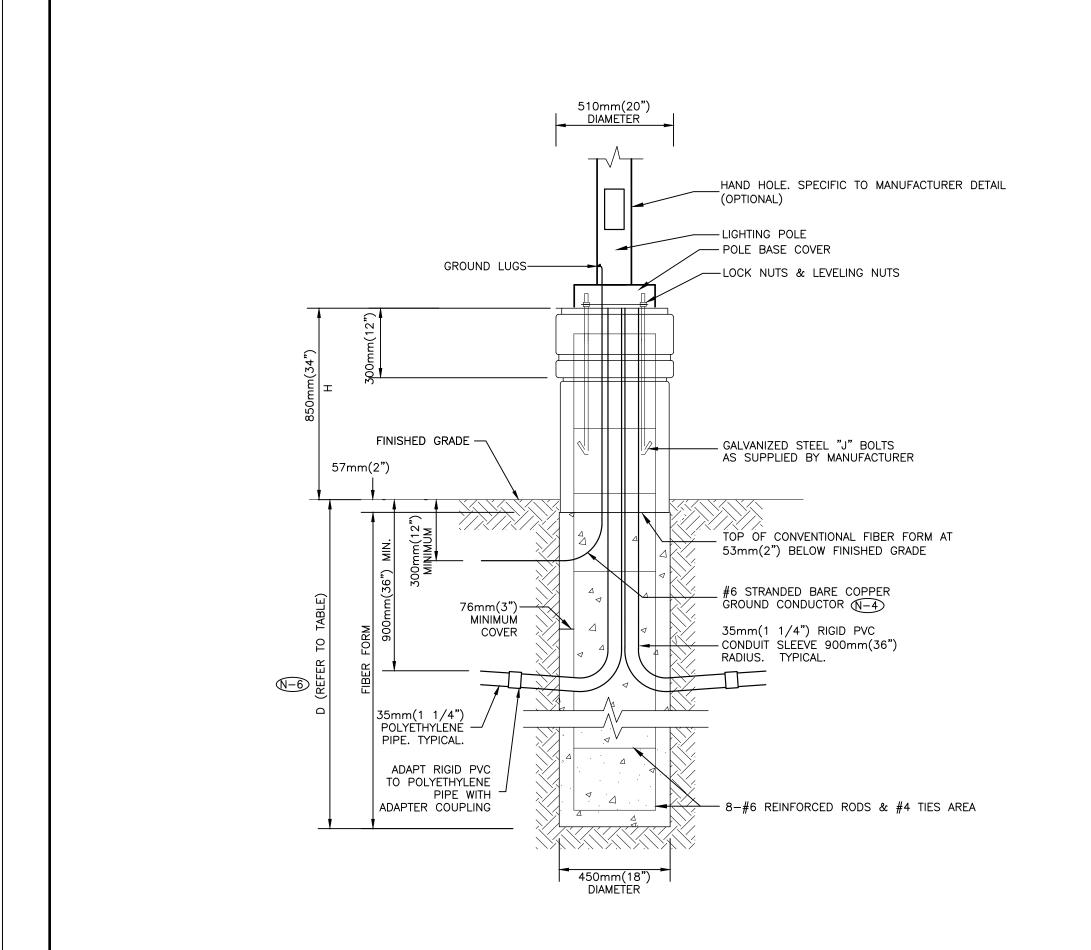

- TOP OF FOUNDATION SHALL BE TROWELLED SMOOTH & LEVEL.
- N-2 CLASS OF CONCRETE SHALL BE 25mPa (3500 P.S.I.) CONCRETE SHALL BE VIBRATED.
- MINIMUM OF TWO SLEEVES REQUIRED FOR EACH CONC. FOUNDATION UNLESS
- PROVIDE A 20mm (0.75") DIAMETER 3000mm(10') STEEL COPPER COATED GROUND ROD ADJACENT TO POLES AS SPECIFIED ON PLAN AND CONNECT TO METAL POLE WITH BARE COPPER CONDUCTOR.
- (N-5) CONTRACTOR TO VERIFY OPENING SIZE IN POLE BASE PLATE PRIOR TO SETTING CONDUIT SLEEVES.
- N-6 SUBJECT TO SOIL CONDITIONS, REFER TO SOIL REPORT.
- N-7 FORM RELEASE AGENT HAS BEEN FACTORY-APPLIED TO INSIDE SURFACE OF "ArtFORM".
- N-8 CHAMFER ALL EDGES ABOVE GRADE.
- N-9 SOIL BEARING CAPACITY AND CONCRETE BASE DIMENSIONS TO BE CONFIRMED BY ELECTRICAL CONTRACTOR PRIOR TO INSTALLATION.
- N-10 FOR FINISHING, REFER TO ARCHITECTURAL PLANS.
- (N-11) HEIGHTS VARIES, REFER TO ARCHITECTURAL PLANS. N-12) FOR EXACT CONCRETE, REBAR, AND DEPTH SEE STRUCTURAL ENGINEERING DRAWINGS.
- N-13) POLE TO BE GROUNDED.
- N-14) THIS DETAIL IS PROVIDED FOR INSTALLATION REQUIREMENTS WHERE THE ARCHITECTURAL DRAWINGS DO NOT SPECIFY A BASE DETAIL. THIS DETAIL SHALL BE USED FOR ELECTRICAL INSTALLATION REQUIREMENTS. COORDINATE ALL SITE WORK WITH THE ARCHITECTURAL

PO LEN	LE GTH	BASE BURIAL DEPTH D		REINFORCED ROD LENGTH	
(ft.)	(m)	(ft.)	(m)	(ft.)	(m)
10	3.0	5	1.50	H + 4.5	H + 1.35
19	5.6	7	2.15	H + 6.5	H + 2
23	7.0	7	2.15	H + 6.5	H + 2
25	7.5	7	2.15	H + 6.5	H + 2
29	8.7	8	2.45	H + 7.5	H + 2.3
30	9.0	8	2.45	H + 7.5	H + 2.3
35	10.5	8.5	2.60	H + 8.0	H + 2.45

4 HIGH BASE ARTFORM LIGHTING POLE, FLAGPOLE, FLOODLIGHT, SIGN AND CONCRETE BASE FOR PARKING AREAS SCALE: N.T.S.

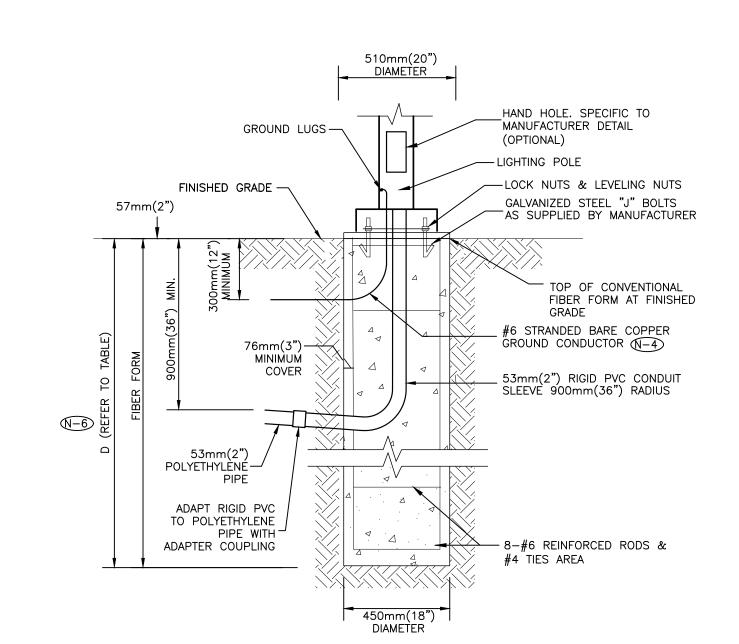


 $^{\prime}$ 5  $\setminus$  low base pedestrian walkway lighting pole on finished grade concrete base detail

(E002) SCALE: N.T.S.


## NOTES:

- N-1 TOP OF FOUNDATION SHALL BE TROWELLED SMOOTH & LEVEL.
- CLASS OF CONCRETE SHALL BE 25mPa (3500 P.S.I.) CONCRETE SHALL BE VIBRATED. MINIMUM OF TWO SLEEVES REQUIRED FOR EACH CONC. FOUNDATION UNLESS OTHERWISE SHOWN.
- PROVIDE A 20mm (0.75") DIAMETER 3000mm(10') STEEL COPPER COATED GROUND ROD ADJACENT TO POLES AS SPECIFIED ON PLAN AND CONNECT TO METAL POLE WITH BARE COPPER CONDUCTOR.
- N-5) CONTRACTOR TO VERIFY OPENING SIZE IN POLE BASE PLATE PRIOR TO SETTING CONDUIT SLEEVES.
- N-6 SUBJECT TO SOIL CONDITIONS, REFER TO SOIL REPORT.
- N-7) CHAMFER ALL EDGES ABOVE GRADE.
- N-8 SOIL BEARING CAPACITY AND CONCRETE BASE DIMENSIONS TO BE CONFIRMED BY ELECTRICAL CONTRACTOR PRIOR TO INSTALLATION.
- N-9 FOR FINISHING, REFER TO ARCHITECTURAL PLANS.
- (N-10) HEIGHTS VARY, REFER TO ARCHITECTURAL PLANS.
- N-11) FOR EXACT CONCRETE, REBAR, AND DEPTH SEE STRUCTURAL ENGINEERING DRAWINGS.
- N-12) POLE TO BE GROUNDED.
- THIS DETAIL IS PROVIDED FOR INSTALLATION REQUIREMENTS WHERE THE ARCHITECTURAL DRAWINGS DO NOT SPECIFY A BASE DETAIL. THIS DETAIL SHALL BE USED FOR ELECTRICAL INSTALLATION REQUIREMENTS. COORDINATE ALL SITE WORK WITH THE ARCHITECTURAL DRAWINGS.

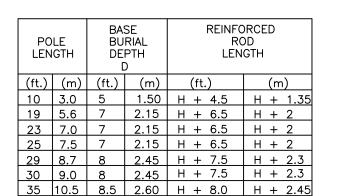


 $\longrightarrow$  RED WARNING TAPE  $\bigcirc$  0 300 mm (11-4/5")1500mm(60") N-8450mm(17-3/4") 190mm(7-1/2") → 450mm(17−3/4") N-1) 9mm (3/8") POLYPROPYLENE ROPE REQUIRED IN ALL DUCTS N-2) REFER TO SITE PLAN FOR CONDUIT SIZE IN 20 MPa CONCRETE. FOR INCOMING SERVICES TO RIVER VALLEY PARK SOUTH DUCTS ARE TO BE 103mm (4") I.D.  $\mathbb{N}$ -3 16mm (1/2") REINFORCING RODS N-4 PROVIDE BELL ENDS AT TERMINATION OF ALL DUCTS N-5 PRE-FABRICATES DUCT SPACER AND HOLDERS N-6 RED WARNING TAPE TO EXTEND THE FULL WIDTH OF TRENCH N-7 DUCT BANK TO BE CONSTRUCTED TO HYDRO ONE REQUIREMENTS N-8 CLEAN BACKFILL MATERIAL

1 PRIMARY CONCRETE ENCASED DUCT BANK - 2×2

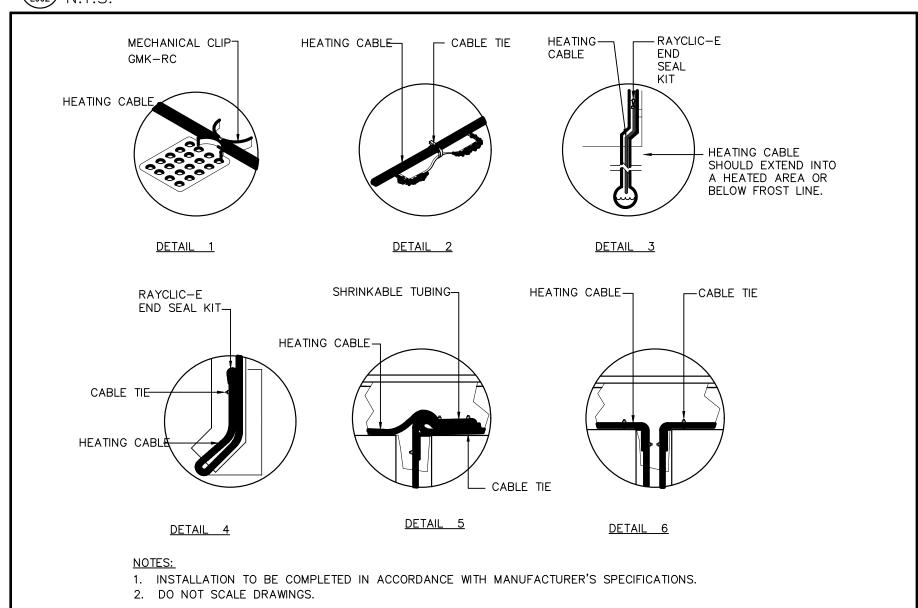

ROOF AND CUTTER DE-ICING SYSTEM DETAILS-ROOF CLIPS, GUTTER DOWN SPOUT, SPLICE KIT N.T.S.

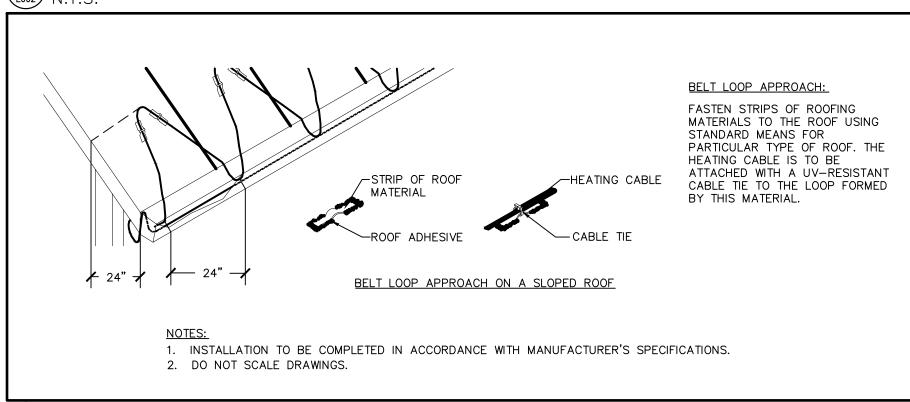

3 ROOF AND GUTTER DE-ICING - DESIGN-BELT LOOP APPROACH N.T.S.

Contractor must check and verify all dimensions on the job, and report any discrepancies to the Architect before proceeding with the work.

REVISIONS AND ISSUES

REV	DESCRIPTION	DATE
1	ISSUED FOR COSTING	2021.08.17
2	ISSUED FOR TENDER	2021.08.27
3	ISSUED FOR BUILDING PERMIT	2021.09.09
4	ISSUED FOR REVISED TENDER/BUILDING PERMIT	2022.01.31
5		
6		
7		

## MJMA

maclennan jaunkalns miller architects

425 adelaide street west level 6 toronto ontario m5v 3c1 416 593 6796 www.mjmarchitects.com

#### TRITON ENGINEERING SERVICES LTD CIVIL ENGINEERS

18 ROBB BOULEVARD - UNIT 8 ORANGEVILLE, ONTARIO

TEL 519 941 0330 FAX 519 941 1830

#### **BLACKWELL** STRUCTURAL ENGINEERS

134 PETER STREET, SUITE 1301 TORONTO, ONTARIO, M5V 2H2 TEL 416.593.5300 FAX 416.593.4840

### SMITH + ANDERSON MECHANICAL AND ELECTRICAL ENGINEERS

1100 - 100 SHEPPARD AVENUE EAST TORONTO, ONTARIO, M2N 6N5



TEL 416.487.8151 -


Smith + Andersen

1100 - 100 Sheppard Ave. East, Toronto On, M2N 6N5 416 487 8151 f 416 487 9104 smithandandersen.com

## SAYERS FOOD LIMITED

132 BURLEIGH STREET t: 705.656.4531 e: sayers@apsley.ca

NORTH ARROW

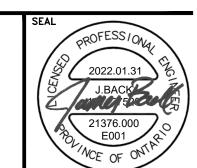

## PROJECT TITLE

NEW SAYERS FOOD STORE BURLEIGH STREET, APSLEY

ELECTRICAL DETAILS

### SCALE 1:100


JUNE 16, 2021

PROJECT NUMBER

21376.000.e001 DRAWING NUMBER

LIGHTING CONTROL SCHEDULE								
TYPE	SYMBOL	DESCRIPTION	MAUFACTURER: CAT. #	APPLICATION	REMARKS			
А	(OS) 'A'	HIGH BAY COLD TEMPERATURE PASSIVE INFRARED OCCUPANCY SENSOR	HB-300C WITH HBL2 LENS	LOADING DOCK MEAT PREP PRODUCE PREP	- STEM MOUNT - MOUNT SENSOR ALIGNED WITH LIGHT FIXTURES			
В	OS 'B'	PASSIVE INFRARED WALL SWITCH OCCUPANCY SENSOR	PW-301	WASHROOM				
С	OS) 'c'	PASSIVE INFRARED CEILING SENSOR	CI-305	DELI/BAKERY				
D	(OS) 'D'	DUAL TECHNOLOGY CEILING SENSOR	DT-305	OFFICE STORAGE STAFF LOUNGE				
E	OS 'E'	ULTRASONIC CEILING SENSOR	UT-305-3 HALLWAY	CORRIDOR				
РС	PC	PHOTOCELL	LMPO-200 c/w LMIN-104	EXTERIOR				
		RELAY PANEL	LMCP8-10V-115/27 7 C/W LENC8S and LMCT-100-2	EXTERIOR				


## 5 LIGHTING CONTROL SCHEDULE N.T.S.

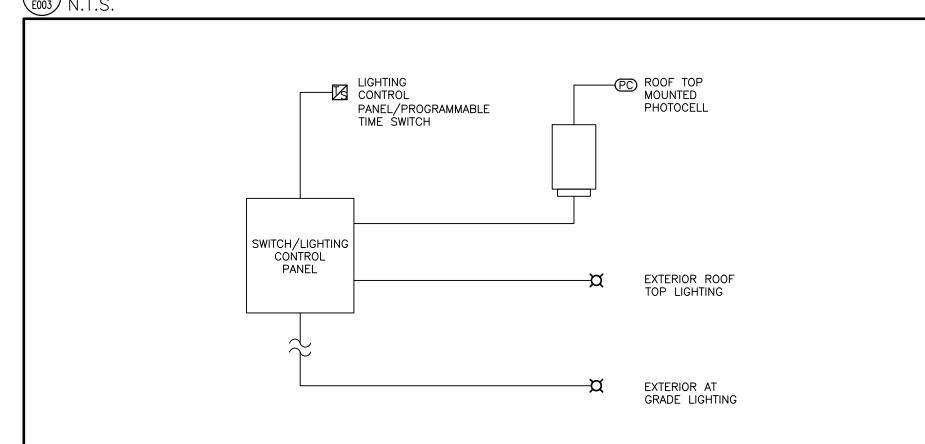


## <u>GENERAL NOTES:</u>


- 1. REFER TO FLOOR PLANS FOR LOCATION OF LIGHTING CONTROL DEVICES.
- 2. TIME SWITCH/LIGHTING CONTROL PANEL TO SIGNAL EXTERIOR LIGHTING ON ROOF AND AT GRADE TO TURN ON AND OFF BASED ON TIME SCHEDULE AND EXTERIOR PHOTOCELL CONTROL. CONTRACTOR TO COORDINATE PROGRAMMING OF TIMER WITH OWNER.

## 6 TYPICAL OUTDOOR LIGHTING CONTROL DIAGRAM

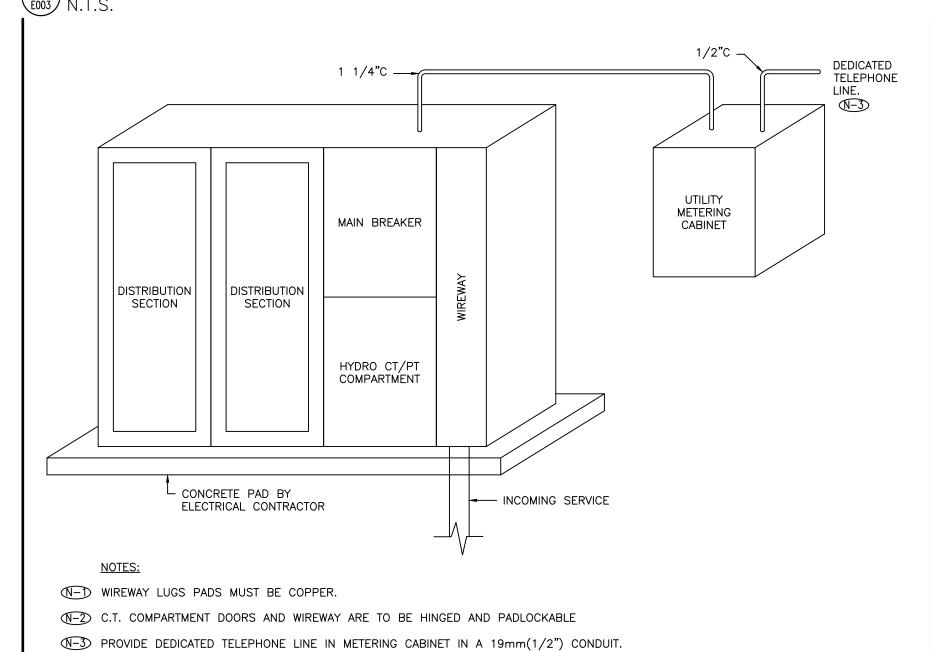

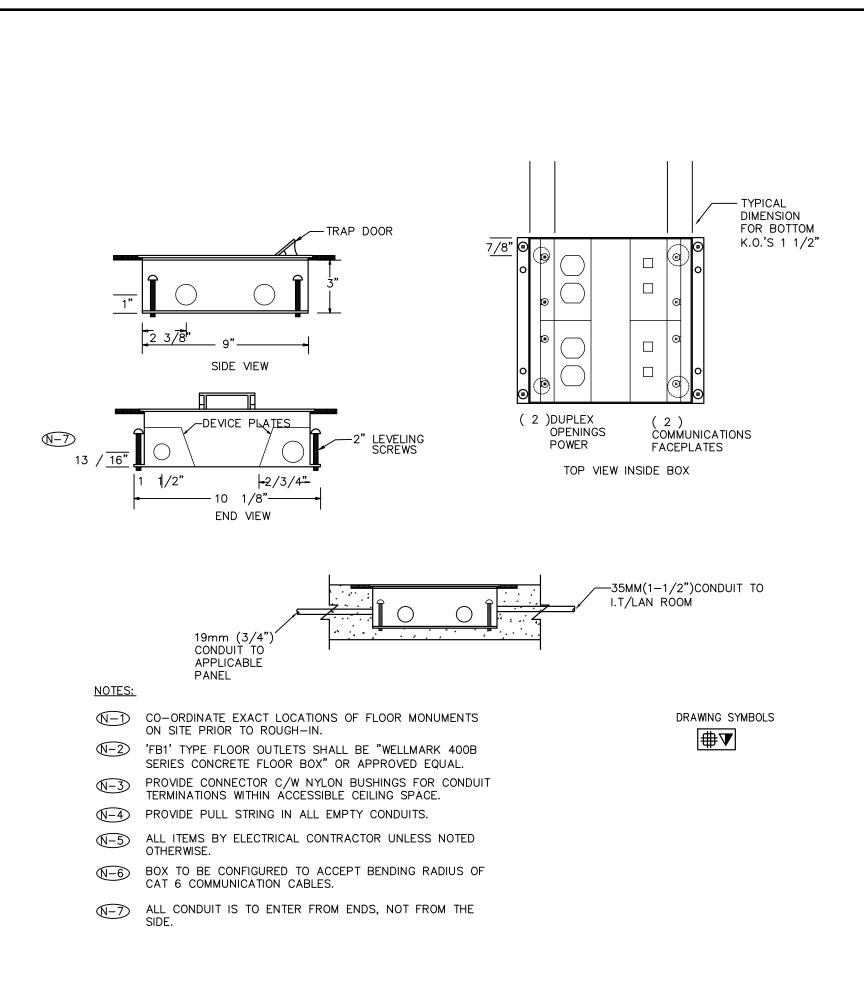


## FLOOR BOX DETAIL (IN SLAB) N.T.S.

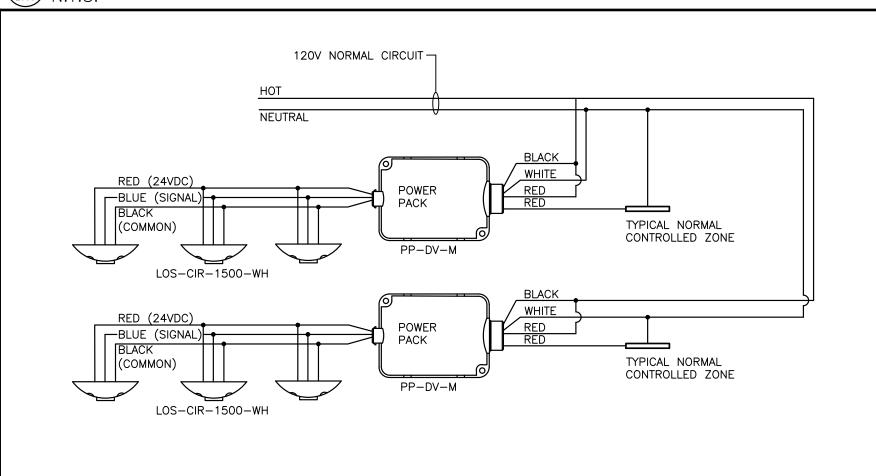

## **GENERAL NOTES:**

- 1. LIGHTING CONTROL SCHEMATIC TO MEET ASHRAE 90.1-2013. COMMON SPACE TYPES 'SALES AREA', 'FOOD PREPARATION AREA', 'LOADING DOCK, 'CORRIDOR', 'ELECTRICAL/MECHANICAL ROOM', 'OFFICE', 'STORAGE ROOM', INTERIOR', 'LOUNGE/BREAKROOM'.
- 2. REFER TO 'LIGHTING SEQUENCE OF OPERATION' IN ELECTRICAL SPECIFICATION FOR SEQUENCING REQUIREMENTS.
- 3. LIGHTING IN ROOM SHALL BE NON-DIMMABLE.
- 4. LIGHTING CONTROL MANUFACTURER TO CONFIRM ALL PRODUCT CAT# DURING SHOP DRAWING STAGE.
- 5. DETAIL IS SCHEMATIC. REFER TO MANUFACTURERS INSTRUCTION FOR DETAILED WIRING DIAGRAM.
- 6. BASIS OF DESIGN IS A SALEX LIGHTING CONTROL SYSTEM. ELECTRICAL CONTRACTOR TO PROVIDE REVISED CONTROLS SCHEMATICS, TO BE REVIEWED BY ENGINEER, FOR ANY PROPOSED ALTERNATES. ELECTRICAL CONTRACTOR SHALL BE RESPONSIBLE THAT ANY ALTERNATE MEET THE INTENDED SEQUENCE OF OPERATION, ENERGY CODE REQUIREMENTS AND ENSURE COMPATIBILITY WITH LUMINAIRES.
- 7. MOTION SENSORS SHALL NOT CONTROL AN AREA MORE THAN 334M2
- 8. DRAWING SYMBOLS DEPICT WHAT THE APPEARS ON THE FLOOR PLAN TO SHOW LIGHTING CONTROL DETAIL. REFER TO LIGHTING CONTROL DETAIL 5/E003 FOR OCCUPANCY SENSOR TYPE AND DRAWING SYMBOL. REFER TO FLOOR PLANS E400 SERIES DRAWINGS FOR EXACT LOCATION AND QUANTITY OF ALL LIGHTING CONTROL DEVICES.
- MAXIMUM OF THREE (3) OCCUPANCY SENSORS TO BE CONNECTED TO EACH POWERPAK. REFER TO MANUFACTURER INSTRUCTION MANUAL FOR DETAILS.

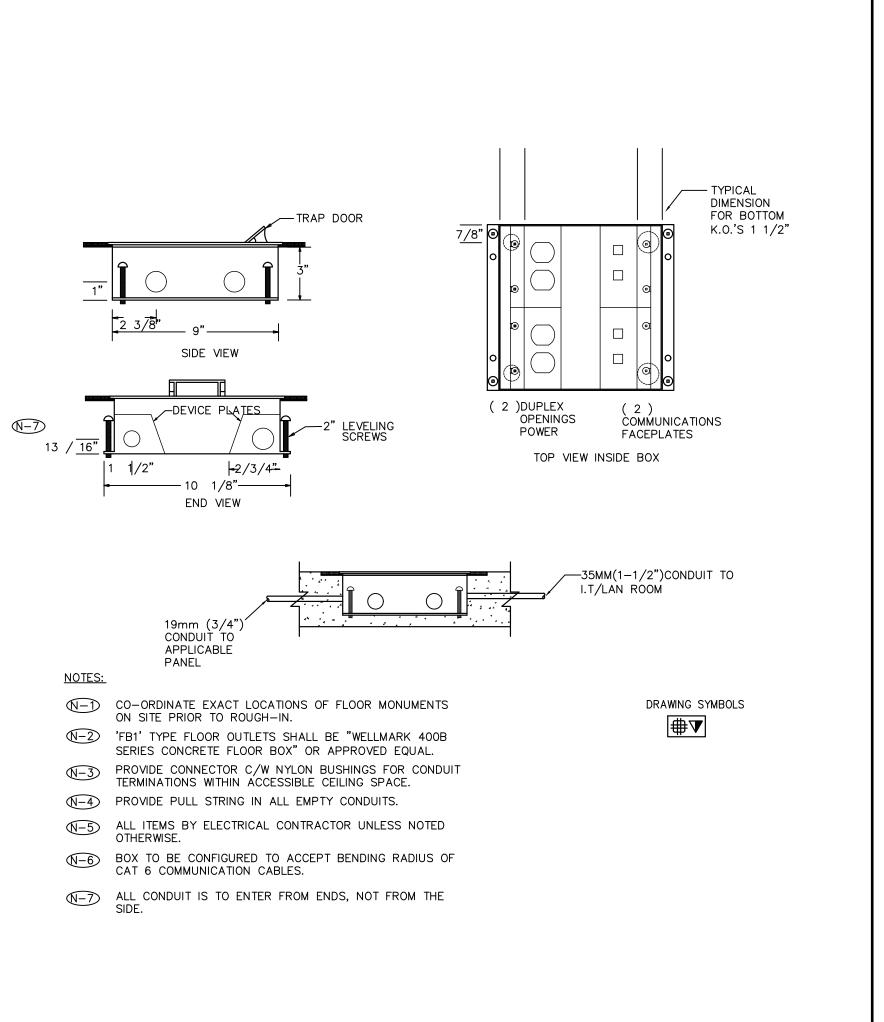

SINGLE GANG DUPLEX RECEPTACLE W/ COMMUNICATION OUTLETS N.T.S.

DUPLEX RECEPTACLE

PLATE

**GENERAL NOTES:** 

**DETAIL NOTES:** 

SINGLE GANG BACK

ACCESSIBLE CEILING SPÁCE.

2. PROVIDE PULL STRINGS IN ALL EMPTY CONDUIT.

COMMUNICATIONS CONTRACTORS.


**→**100mm(4") →

1. PROVIDE CONNECTOR, C/W NYLON BUSHINGS FOR CONDUIT TERMINATIONS WITHIN

REFER TO SPECIFICATIONS FOR COORDINATION BETWEEN ELECTRICAL AND

(N-2) COMMUNICATIONS CONDUIT TO RUN BACK TO 2ND FLOOR IT ROOM.

BOX AND COVER

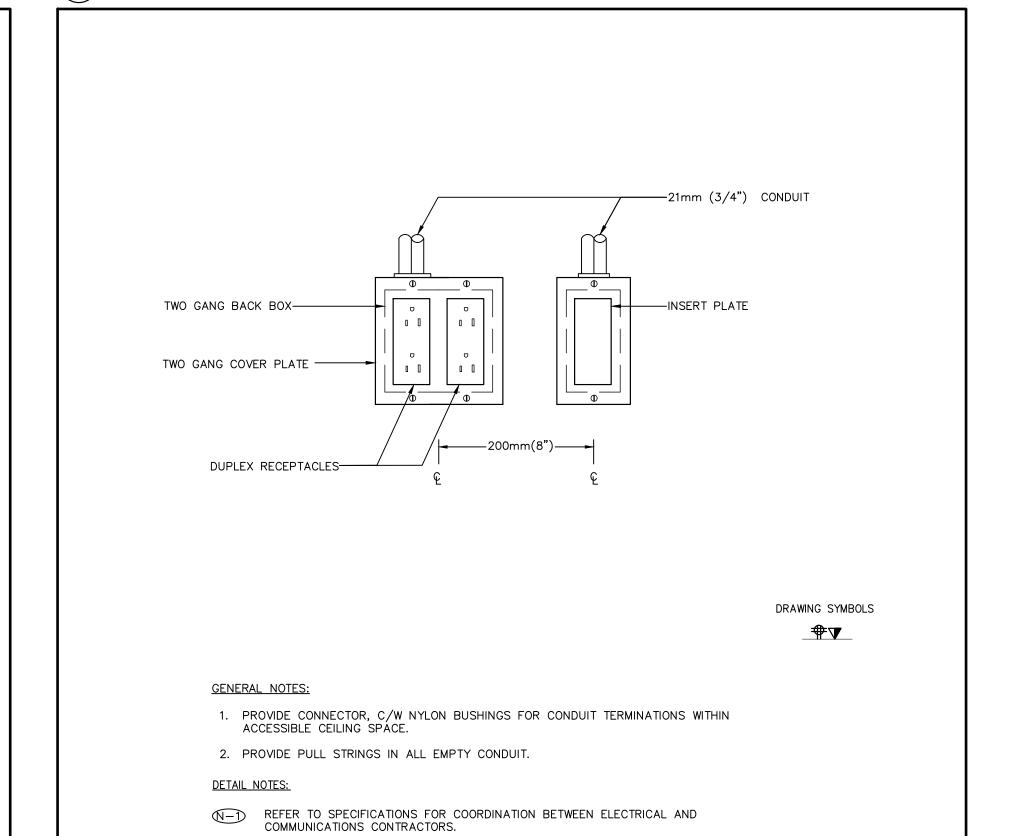

N-2 COMMUNICATIONS CONDUIT TO RUN BACK TO 2ND FLOOR IT ROOM.

QUAD DUPLEX RECEPTACLE W/ COMMUNICATION OUTLETS N.T.S.

Contractor must check and verify all dimensions on the job, and report any discrepancies to the Architect before proceeding with the work. Do not scale this drawing.

### REVISIONS AND ISSUES

-21mm (3/4") CONDUIT

-INSERT PLATE

DRAWING SYMBOLS

 $\blacksquare \Phi \Delta$ 

REV	DESCRIPTION	DATE	В
1	ISSUED FOR COSTING	2021.08.17	
2	ISSUED FOR TENDER	2021.08.27	
3	ISSUED FOR BUILDING PERMIT	2021.09.09	
4	ISSUED FOR ADD-E01	2021.09.15	
5	ISSUED FOR REVISED TENDER/BUILDING PERMIT	2022.01.31	
6			
7			
$\overline{}$			

maclennan jaunkalns miller architects 425 adelaide street west level 6 toronto ontario m5v 3c1

416 593 6796 www.mjmarchitects.com

TRITON ENGINEERING SERVICES LTD

18 ROBB BOULEVARD - UNIT 8 ORANGEVILLE, ONTARIO TEL 519 941 0330 FAX 519 941 1830

#### BLACKWELL STRUCTURAL ENGINEERS

134 PETER STREET, SUITE 1301 TORONTO, ONTARIO, M5V 2H2
TEL 416.593.5300 FAX 416.593.4840

SMITH + ANDERSON MECHANICAL AND ELECTRICAL ENGINEERS

1100 - 100 SHEPPARD AVENUE EAST TORONTO, ONTARIO, M2N 6N5 TEL 416.487.8151




Smith + Andersen

1100 - 100 Sheppard Ave. East, Toronto On, M2N 6N5 416 487 8151 f 416 487 9104 smithandandersen.com

## SAYERS FOOD LIMITED

132 BURLEIGH STREET t: 705.656.4531 e: sayers@apsley.ca

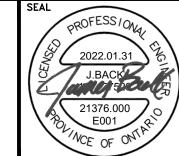

PROJECT TITLE

NEW SAYERS FOOD STORE BURLEIGH STREET, APSLEY

DRAWING TITLE

ELECTRICAL DETAILS

1:100

JUNE 16, 2021


PROJECT NUMBER

21376.000.e00

DRAWING NUMBER

MAIN SERVICE ENTRANCE SWITCHBOARD AND METERING CABINET ELEVATION DETAIL N.T.S.

OCCUPANCY SENSOR WIRING DIAGRAM N.T.S.

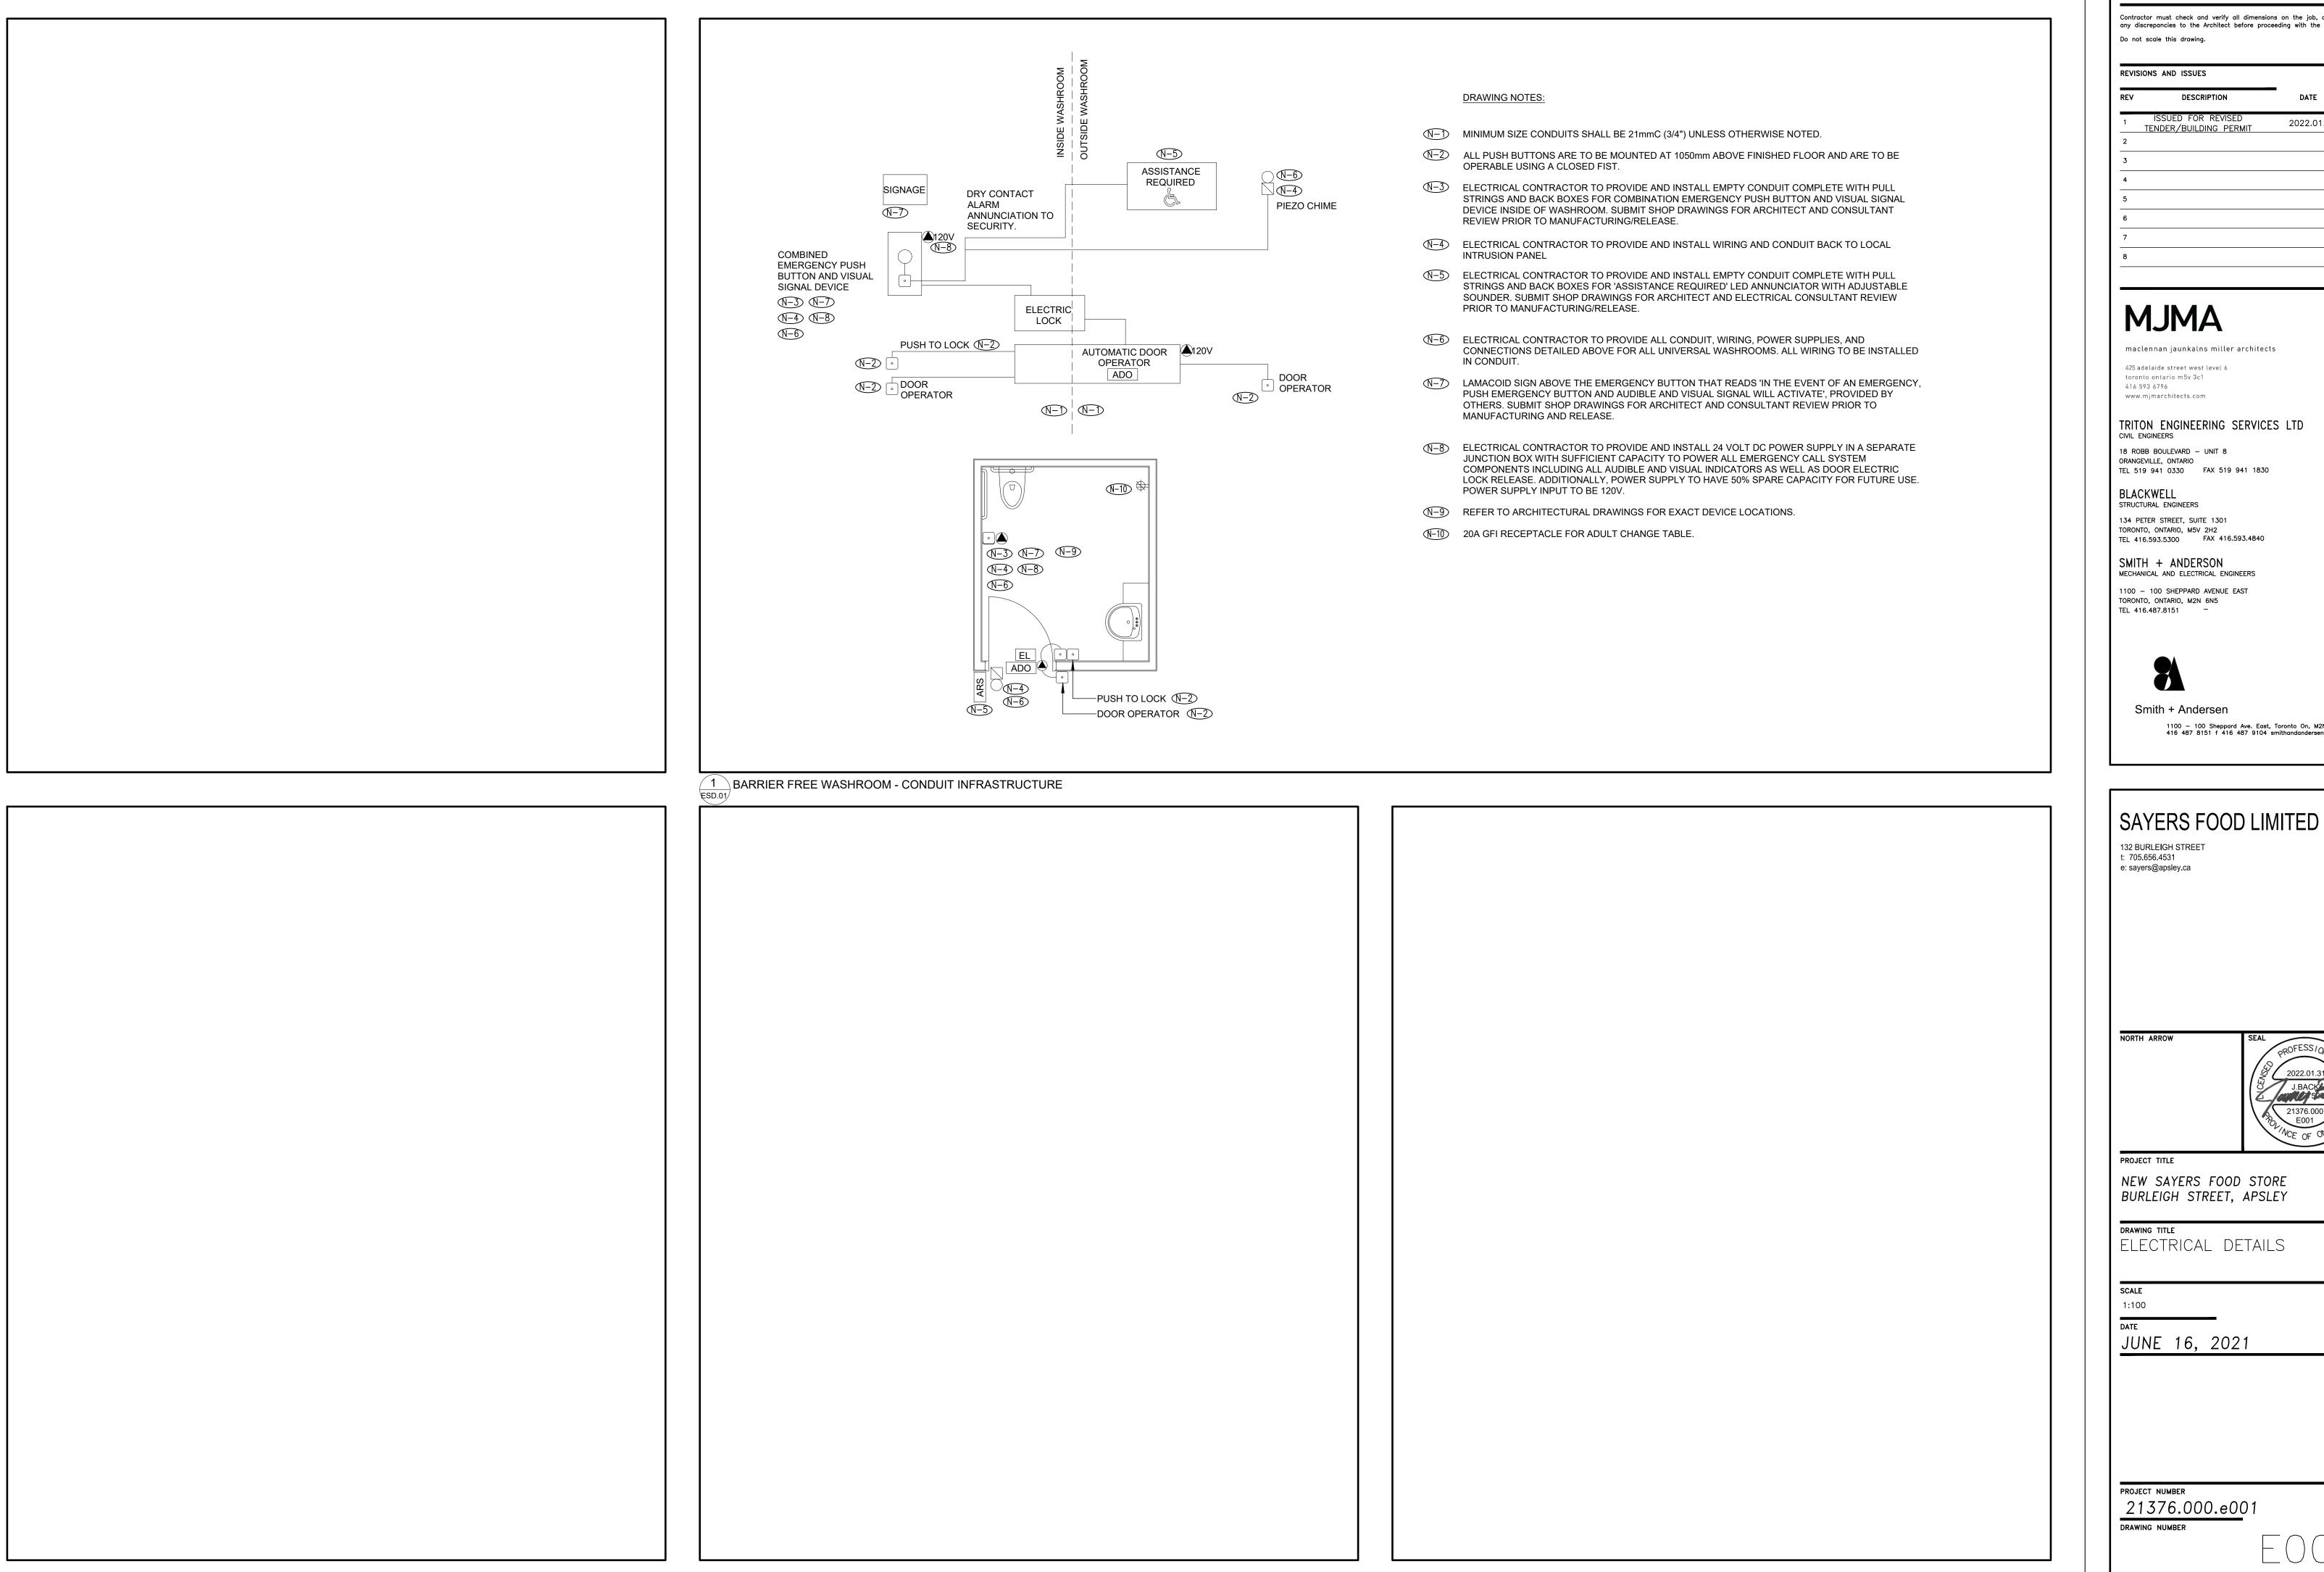


Contractor must check and verify all dimensions on the job, and report any discrepancies to the Architect before proceeding with the work.

2022.01.31 TENDER/BUILDING PERMIT


maclennan jaunkalns miller architects

## TRITON ENGINEERING SERVICES LTD

1100 - 100 Sheppard Ave. East, Toronto On, M2N 6N5 416 487 8151 f 416 487 9104 smithandandersen.com

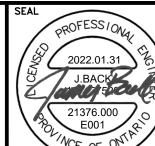

NEW SAYERS FOOD STORE BURLEIGH STREET, APSLEY

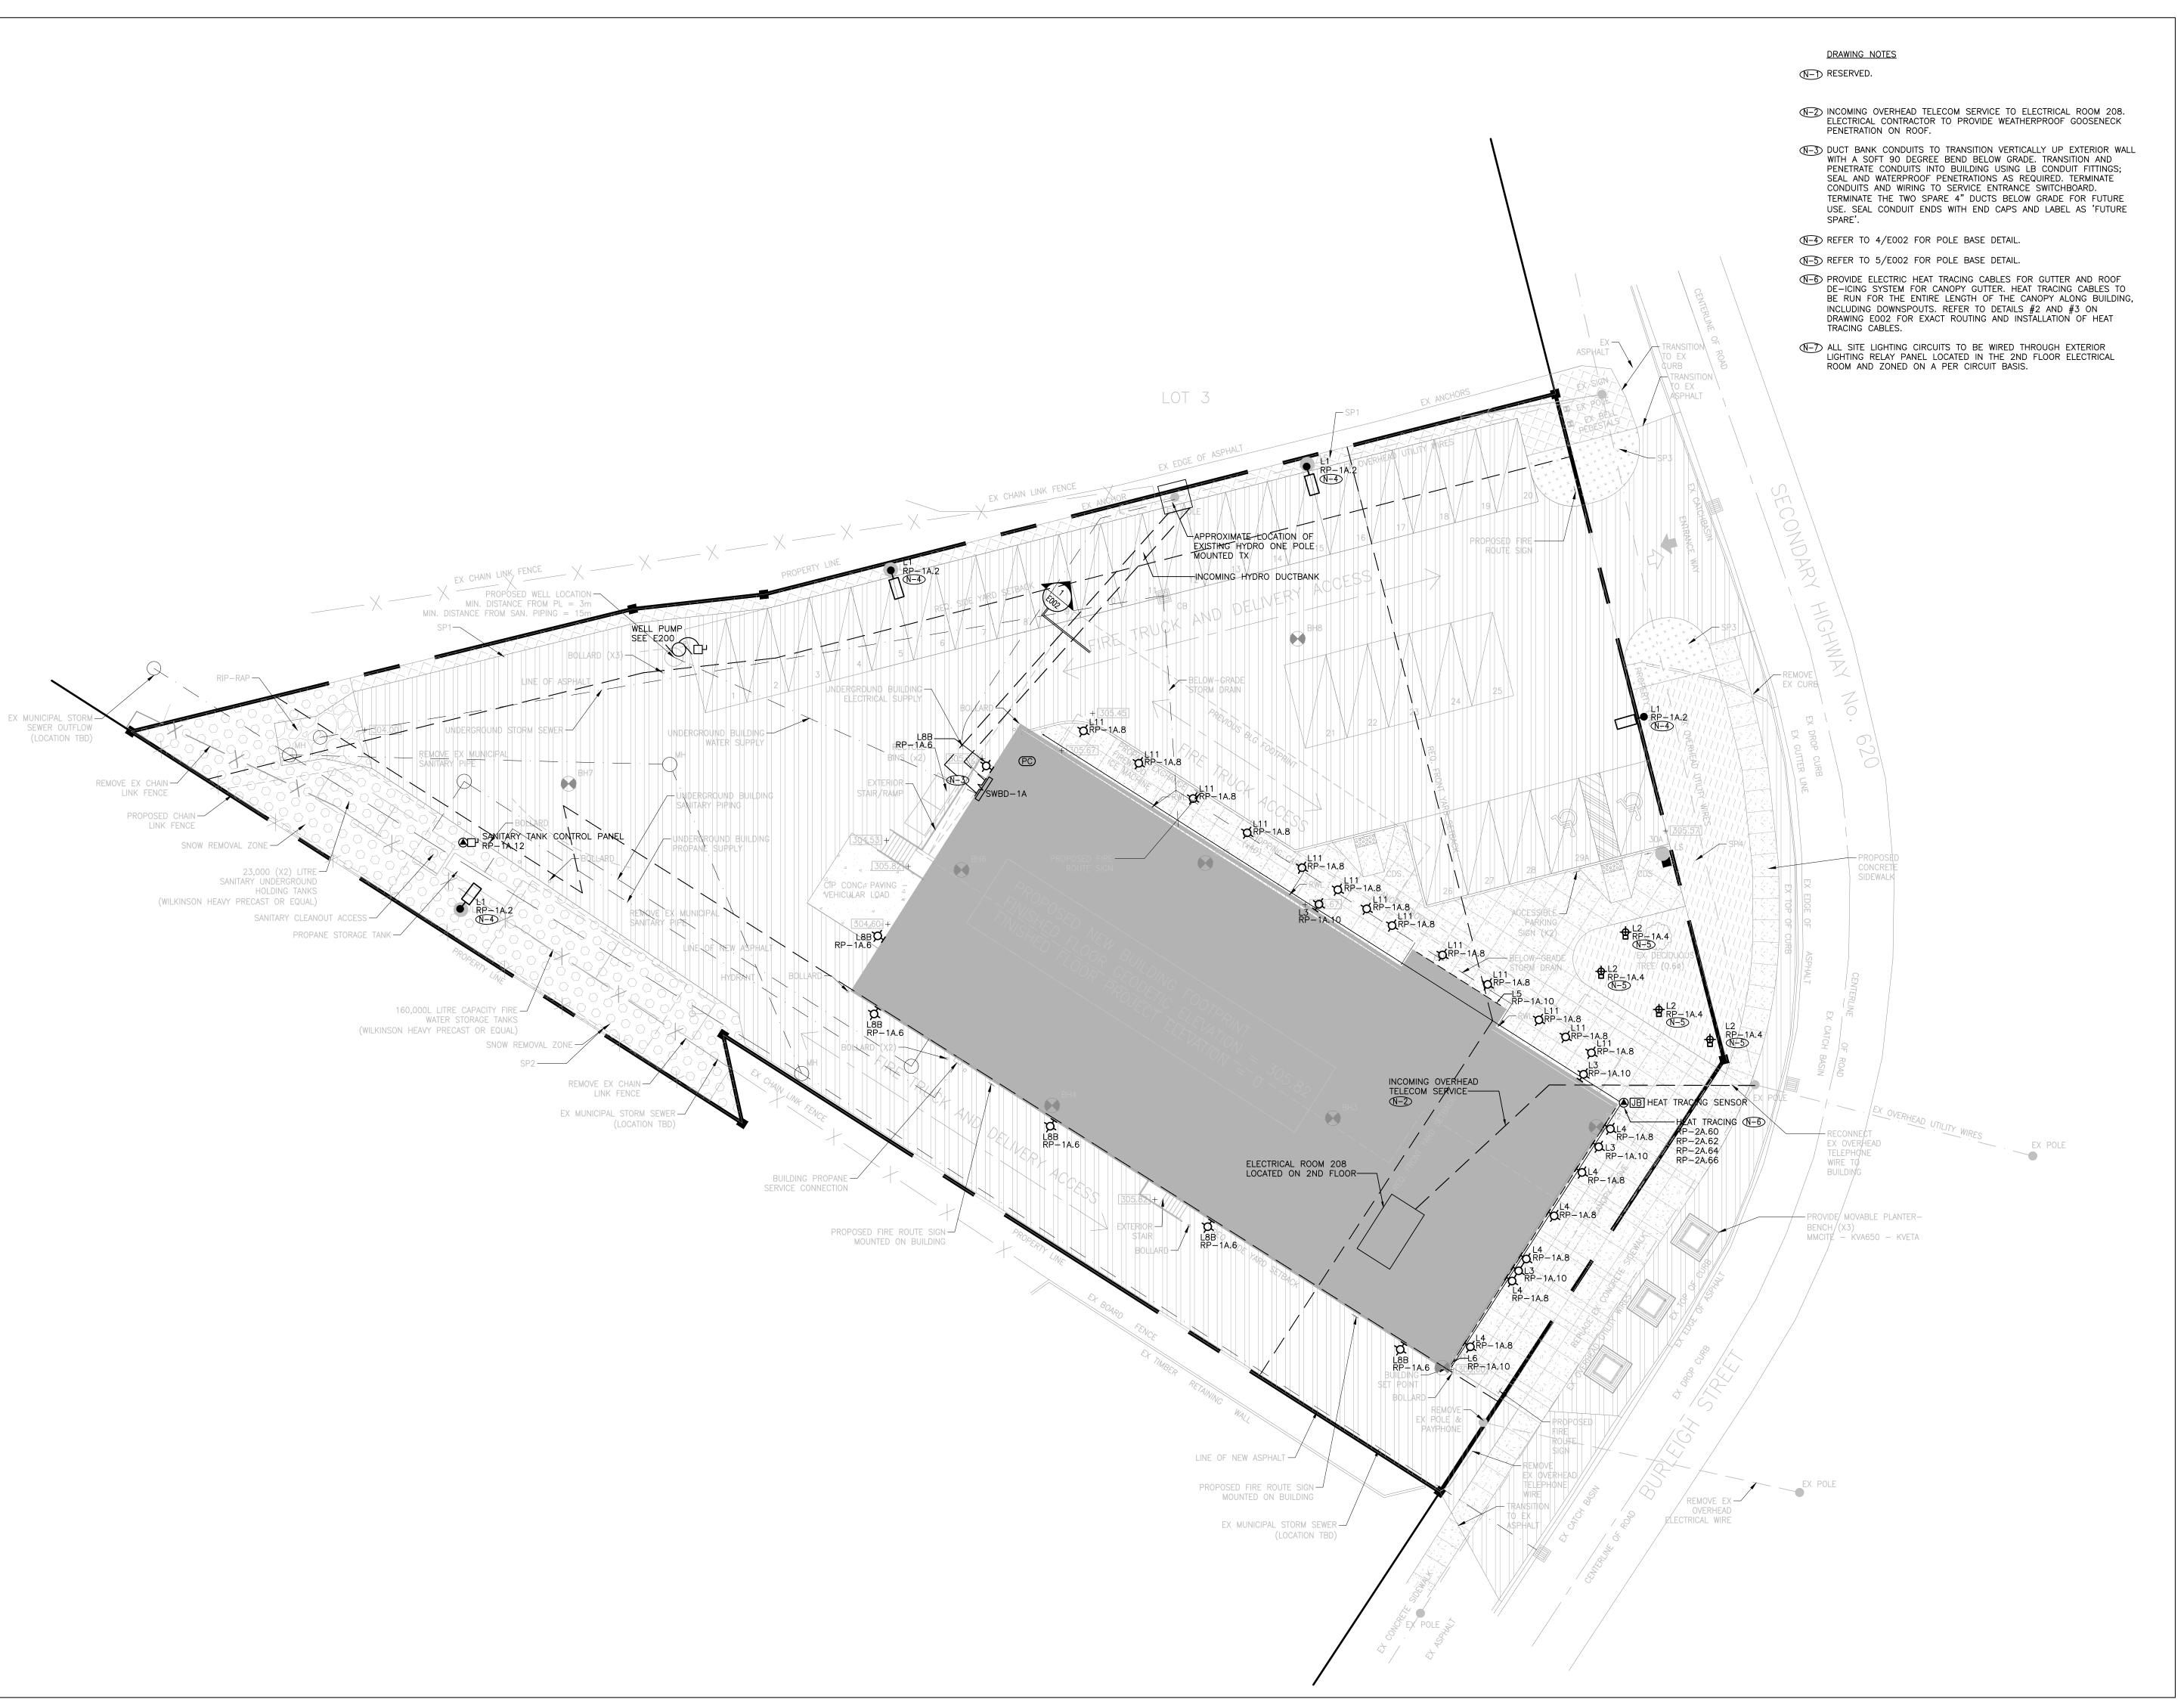

Contractor must check and verify all dimensions on the job, and report any discrepancies to the Architect before proceeding with the work. Do not scale this drawing.

REVISIONS AND ISSUES

REV	DESCRIPTION	DATE
1	ISSUED FOR COSTING	2021.08.17
2	ISSUED FOR TENDER	2021.08.27
3	ISSUED FOR BUILDING PERMIT	2021.09.09
4	ISSUED FOR ADD-E01	2021.09.15
5	ISSUED FOR ADD-E03	2021.09.27
6	ISSUED FOR REVISED TENDER/BUILDING PERMIT	2022.01.31
7	·	

maclennan jaunkalns miller architects

425 adelaide street west level 6 toronto ontario m5v 3c1 416 593 6796 www.mjmarchitects.com

TRITON ENGINEERING SERVICES LTD

18 ROBB BOULEVARD - UNIT 8 ORANGEVILLE, ONTARIO TEL 519 941 0330 FAX 519 941 1830

#### BLACKWELL STRUCTURAL ENGINEERS

134 PETER STREET, SUITE 1301 TORONTO, ONTARIO, M5V 2H2
TEL 416.593.5300 FAX 416.593.4840

### SMITH + ANDERSON MECHANICAL AND ELECTRICAL ENGINEERS

1100 - 100 SHEPPARD AVENUE EAST TORONTO, ONTARIO, M2N 6N5 TEL 416.487.8151 -




Smith + Andersen

1100 — 100 Sheppard Ave. East, Toronto On, M2N 6N5 416 487 8151 f 416 487 9104 smithandandersen.com

## SAYERS FOOD LIMITED

132 BURLEIGH STREET t: 705.656.4531 e: sayers@apsley.ca

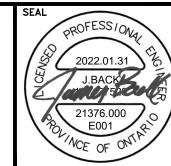

PROJECT TITLE


NEW SAYERS FOOD STORE BURLEIGH STREET, APSLEY

DRAWING TITLE

SITE PLAN — ELECTRICAL

JUNE 16, 2021

PROJECT NUMBER 21376.000.e001

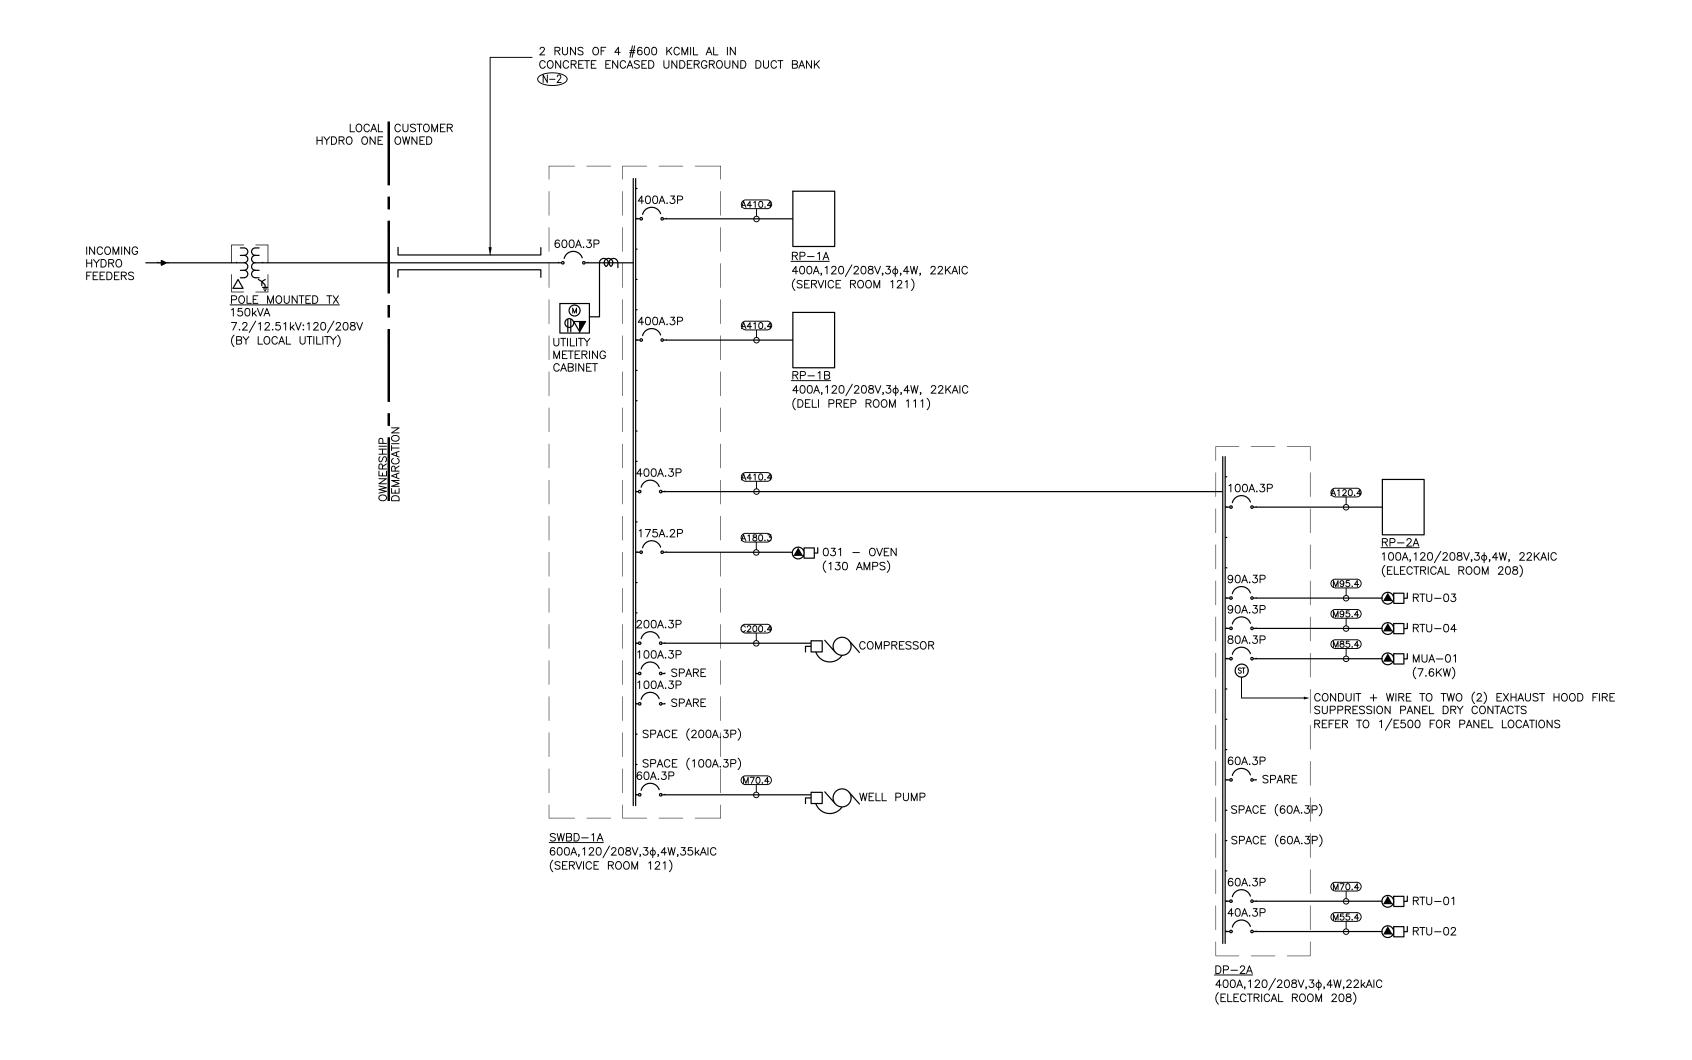

### GENERAL NOTES:

- CONTRACTOR SHALL SUBMIT THE PROTECTION COORDINATION STUDY REPORT AND SHOP DRAWINGS OF THE MAIN SWITCHBOARD TO THE LOCAL HYDRO UTILITY FOR REVIEW AND APPROVAL. ALSO, SUBMIT POWER SYSTEMS STUDY SHOP DRAWING TO ELECTRICAL ENGINEER FOR REVIEW PRIOR TO SUBMISSION OF ANY ELECTRICAL DISTRIBUTION EQUIPMENT SHOP DRAWINGS. ELECTRICAL DISTRIBUTION SHOP DRAWINGS WILL NOT BE REVIEWED UNTIL POWER SYSTEMS STUDY SHOP DRAWING IS REVIEWED FIRST.
- (N-2) INSTALL SECONDARY CONDUCTORS IN A 1Hx2W CONFIGURATION. THE OTHER 2 DUCTS ARE TO BE RESERVED AS FUTURE SPARE DUCTS.

	(PE	ER TABLE 4 CEC (2018) AND	4-006, 60C (FOR	EQUIPMENT TO			DEE 0B, 1000 1	MITTOOT UACI			
		M-COF	PPER (MOTOR), C-C	COPPER, A-ALU AMPACITY F	I		BOND), 4—(4WIRI	E+BOND), 5—	(5WIRE+BOND)		
	CHEDULE I	S TO BE USED FOR FEEDERS	AND UNDER	90 WIRING IS TO	O BE USED FOR	uit size	110A, THE B		EEDERS GREATE UCTOR SHALL B 10-614.		
		NG FROM PANELBOARDS	1000\	/ INSULATION R MAXII		PACITY	ORS)			IM CIRCUIT CA 75°C/90°C COL	
		CONDUCTOR SIZE +	FEEDER		·		·	E WIDE I	FEEDER		(DOUBLE )+BONDING
FEEDER NO.	NO. OF RUNS	BONDING CONDUCTOR SIZE [AWG OR KCMIL] PER RUN	AMPACITY FOR 3 AND 4 WIRE SYSTEMS		ING CONDUCTOR IZE PER RUN RWU90		NG CONDUCTOR ZE PER RUN RWU90	5 WIRE + BONDING FEEDER NO.	AMPACITY FOR 5 WRE SYSTEMS	CONDUCTOR MITIGATING THE CONDUIT SI RW90	RANSFORME
M20	1	#12 AWG + #12 AWG	20	21 (¾")	21 (¾")	N/A	N/A	N/A	N/A	N/A	N/A
м30	1	#10 AWG + #10 AWG	30	21 (3")	27 (1")	N/A	N/A	N/A	N/A	N/A	N/A
M40	1	#8 AWG + #8 AWG	40	27 (1")	27 (1")	N/A	N/A	N/A	N/A	N/A	N/A
M55	1	#6 AWG + #6 AWG	55	27 (1")	35 (1⅓")	N/A	N/A	N/A	N/A	N/A	N/A
M70	1	#4 AWG + #6 AWG	70	35 (1¼")	41 (1½")	N/A	N/A	N/A	N/A	N/A	N/A
M85	1	#3 AWG + #6 AWG	85	35 (1¼")	41 (1½")	N/A	N/A	N/A	N/A	N/A	N/A
M95	1	#2 AWG + #6 AWG	95	41 (1½")	41 (1½")	N/A	N/A	N/A	N/A	N/A	N/A
M110	1	#1 AWG + #4 AWG	110	53 (2")	53 (2")	N/A	N/A	N/A	N/A	N/A	N/A
C20	1	#12 AWG + #12 AWG	20	21 (¾")	21 (¾")	21 (¾")	27 (1")	C20	20	21 (¾")	27 (1"
C30	1	#10 AWG + #12 AWG	30	21 (¾")	27 (1")	27 (1")	27 (1")	C30	30	27 (1")	27 (1"
C50	1	#8 AWG + #10 AWG	50	27 (1")	27 (1")	27 (1")	35 (1½")	C44	44	27 (1")	35 (11/4"
C65	1	#6 AWG + #8 AWG	65	27 (1")	35 (1½")	35 (1¼")	35 (1¼")	C60	60	35 (1¼")	41 (1½"
C85	1	#4 AWG + #8 AWG	85	35 (1½")	41 (1½")	41 (1½")	41 (1½")	C76	76	41 (1½")	53 (2"
C100	1	#3 AWG + #6 AWG	100	35 (1½")	41 (1½")	41 (1½")	53 (2")	C92	92	53 (2")	53 (2"
C115	1	#2 AWG + #6 AWG	115	41 (1½")	41 (1½")	41 (1½")	53 (2")	C104	104	53 (2")	53 (2"
C200	'	#3/0 AWG + #4 AWG	200	63 (2½")	63 (2½")	63 (2½") 53 (2")	63 (2½")	C180	180	78 (3")	78 (
A120 A135	1	#1/0 AWG + #4 AWG #2/0 AWG + #4 AWG	120	53 (2") 53 (2")	53 (2") 53 (2")	63 (2½")	63 (2½") 63 (2½")	A108 A120	108 120	63 (2½")	63 (2)
A155	1	#3/0 AWG + #4 AWG	155	63 (2½")	63 (2½")			A140	140	63 (2½") 78 (3")	63 (2)
A180	1	#4/0 AWG + #4 AWG	180	63 (2½)	63 (2½)	63 (2½") 78 (3")	63 (2½") 78 (3")	A164	164	78 (3")	78 (3 78 (3
A205	1	250 KCMIL + #2 AWG	205	63 (2½")	78 (3")	78 (3 ) 78 (3")	78 (3")	A184	184	78 (3")	91 (3
A230	1	300 KCMIL + #2 AWG	230	78 (3")	78 (3")	78 (3")	91 (3½")	A208	208	91 (3½")	91 (3
A250	1	350 KCMIL + #2 AWG	250	78 (3")	78 (3")	91 (3½")	91 (3½")	A224	224	91 (3½")	91 (3
A270	1	#2 AWG	270	78 (3")	91 (3½")	91 (3½")	91 (3½")	A244	244	103 (4")	103 (4
A340	1	600 KCMIL + #1 AWG	340	91 (3½")	103 (4")	103 (4")	116 (4½")	A308	308	116 (4½")	116 (4
A385	1	750 KCMIL + #1/0 AWG	385	103 (4")	116 (4½")	116 (4½")	116 (4½")	A348	348	129 (5")	129 (5
A445	1	1000 KCMIL + #1/0 AWG	445	116 (4½")	129 (5")	129 (5")	155 (6")	A400	400	155 (6")	155 (6
A240	2	#1/0 AWG + #4 AWG	240	53 (2")	53 (2")	53 (2")	63 (2½")	A216	216	63 (2½")	63 (2
A270	2	#2/0 AWG + #4 AWG	270	53 (2")	53 (2")	63 (2½")	63 (2 <mark>1</mark> ")	A240	240	63 (2½")	63 (2
A360	2	#4/0 AWG + #4 AWG	360	63 (2½")	63 (2½")	78 (3")	78 (3")	A328	328	78 (3")	78 (3
A410	2	250 KCMIL + #2 AWG	410	63 (2½")	78 (3")	78 (3")	78 (3")	A368	368	78 (3")	91 (3
A460	2	300 KCMIL + #2 AWG	460	78 (3")	78 (3")	78 (3")	91 (3½")	A416	416	91 (3½°)	91 (3
A500	2	350 KCMIL + #2 AWG	500	78 (3")	78 (3")	91 (3 <mark>1</mark> ")	91 (3½°)	A448	448	91 (3½")	91 (3
A620	2	500 KCMIL + #1 AWG	620	91 (3½")	91 (3½")	103 (4")	103 (4")	A560	560	103 (4")	116 (4
A680	2	600 KCMIL + #1 AWG	680	91 (3½")	103 (4")	103 (4")	116 (4½")	A616	616	116 (4½")	116 (4
A770	2	750 KCMIL + #1/0 AWG	770	103 (4")	116 (4½")	116 (4½")	116 (4½")	A696	696	129 (5")	129 (5
A890	2	1000 KCMIL + #1/0 AWG	890	116 (4½")	129 (5")	129 (5")	155 (6")	A800	800	155 (6")	155 (6
A405	3	#2/0 AWG + #4 AWG	405	53 (2")	53 (2")	63 (2 <mark>1</mark> ")	63 (2½")	A360	360	63 (2 <mark>1</mark> ")	63 (2)
A465	3	#3/0 AWG + #4 AWG	465	63 (2 <mark>1</mark> ")	63 (2 <mark>1</mark> ")	63 (2½")	63 (2½")	A420	420	78 (3")	78 (3
A615	3	250 KCMIL + #2 AWG	615	63 (2½")	78 (3")	78 (3")	78 (3")	A552	552	78 (3")	91 (32
A690	3	300 KCMIL + #2 AWG	690	78 (3")	78 (3")	78 (3")	91 (3 <mark>1</mark> ")	A624	624	91 (3½")	91 (32
A750	3	350 KCMIL + #2 AWG	750	78 (3")	78 (3")	91 (3½")	91 (3½")	A672	672	91 (3½")	91 (3½
A810	3	400 KCMIL + #2 AWG	810	78 (3")	91 (3½")	91 (3½")	91 (3½")	A732	732	103 (4")	103 (4
A930	3	500 KCMIL + #1 AWG	930	91 (3½")	91 (3½")	103 (4")	103 (4")	A840	840	103 (4")	116 (4
A1020	3	600 KCMIL + #1 AWG	1020	91 (3½")	103 (4")	103 (4")	116 (4½")	A924	924	116 (4½")	116 (4:
A1155 A1335	3	750 KCMIL + #1/0 AWG 1000 KCMIL + #1/0 AWG	1155	103 (4")	116 (4½")	116 (4½")	116 (4½") 155 (6")	A1044 A1200	1044	129 (5") 155 (6")	129 (5 155 (6
A1335 A480	4	#1/0 AWG + #4 AWG	1335	116 (4½") 53 (2")	129 (5") 53 (2")	129 (5") 53 (2")		A1200 A432	432	63 (2½")	63 (2)
A620	4	#3/0 AWG + #4 AWG	620	63 (2½")	63 (2½")	63 (2½")	63 (2½") 63 (2½")	A560	560	63 (2½) 78 (3")	78 (3 <sup>1</sup>
A720	4	#3/0 AWG + #4 AWG	720	63 (2½)	63 (2½) 63 (2½")	78 (3")	78 (3")	A656	656	78 (3")	78 (3
A820	4	250 KCMIL + #2 AWG	820	63 (2½) 63 (2½)	63 (2½) 78 (3")	78 (3")	78 (3 ) 78 (3")	A736	736	78 (3")	91 (3)
A920	4	300 KCMIL + #2 AWG	920	78 (3")	78 (3")	78 (3")	91 (3½")	A832	832	91 (3½")	91 (32
A1000	4	350 KCMIL + #2 AWG	1000	78 (3")	78 (3")	91 (3½")	91 (3½)	A896	896	91 (3½")	91 (3)
A1080	4	400 KCMIL + #2 AWG	1080	78 (3")	91 (3½")	91 (3½)	91 (32)	A976	976	103 (4")	103 (4
A1240	4	500 KCMIL + #1 AWG	1240	91 (3½")	91 (3½")	103 (4")	103 (4")	A1120	1120	103 (4")	116 (4
A1360	4	600 KCMIL + #1 AWG	1360	91 (3½")	103 (4")	103 (4")	116 (4½")	A1232	1232	116 (4½")	116 (4:
A1540	4	750 KCMIL + #1/0 AWG	1540	103 (4")	116 (4½")	116 (4½")	116 (4½")	A1392	1392	129 (5")	129 (5
		, " <i>'</i>								. ,	. \

Contractor must check and verify all dimensions on the job, and report any discrepancies to the Architect before proceeding with the work. Do not scale this drawing.

REV	DESCRIPTION	DATE
1	ISSUED FOR COSTING	2021.08.17
2	ISSUED FOR TENDER	2021.08.27
3	ISSUED FOR BUILDING PERMIT	2021.09.09
4	ISSUED FOR ADD-E01	2021.09.15
5	ISSUED FOR ADD-E02	2021.09.23
6	ISSUED FOR REVISED TENDER/BUILDING PERMIT	2022.01.31
7	·	

# MJMA

maclennan jaunkalns miller architects

425 adelaide street west level 6 toronto ontario m5v 3c1 416 593 6796 www.mjmarchitects.com

TRITON ENGINEERING SERVICES LTD

18 ROBB BOULEVARD - UNIT 8 ORANGEVILLE, ONTARIO TEL 519 941 0330 FAX 519 941 1830

BLACKWELL STRUCTURAL ENGINEERS

134 PETER STREET, SUITE 1301 TORONTO, ONTARIO, M5V 2H2
TEL 416.593.5300 FAX 416.593.4840

SMITH + ANDERSON MECHANICAL AND ELECTRICAL ENGINEERS

1100 - 100 SHEPPARD AVENUE EAST TORONTO, ONTARIO, M2N 6N5 TEL 416.487.8151 -




Smith + Andersen

1100 — 100 Sheppard Ave. East, Toronto On, M2N 6N5 416 487 8151 f 416 487 9104 smithandandersen.com

## SAYERS FOOD LIMITED

132 BURLEIGH STREET t: 705.656.4531 e: sayers@apsley.ca

NORTH ARROW

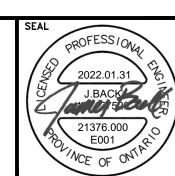

PROJECT TITLE


NEW SAYERS FOOD STORE BURLEIGH STREET, APSLEY

DRAWING TITLE

SINGLE LINE DIAGRAM

JUNE 16, 2021

PROJECT NUMBER 21376.000.e001

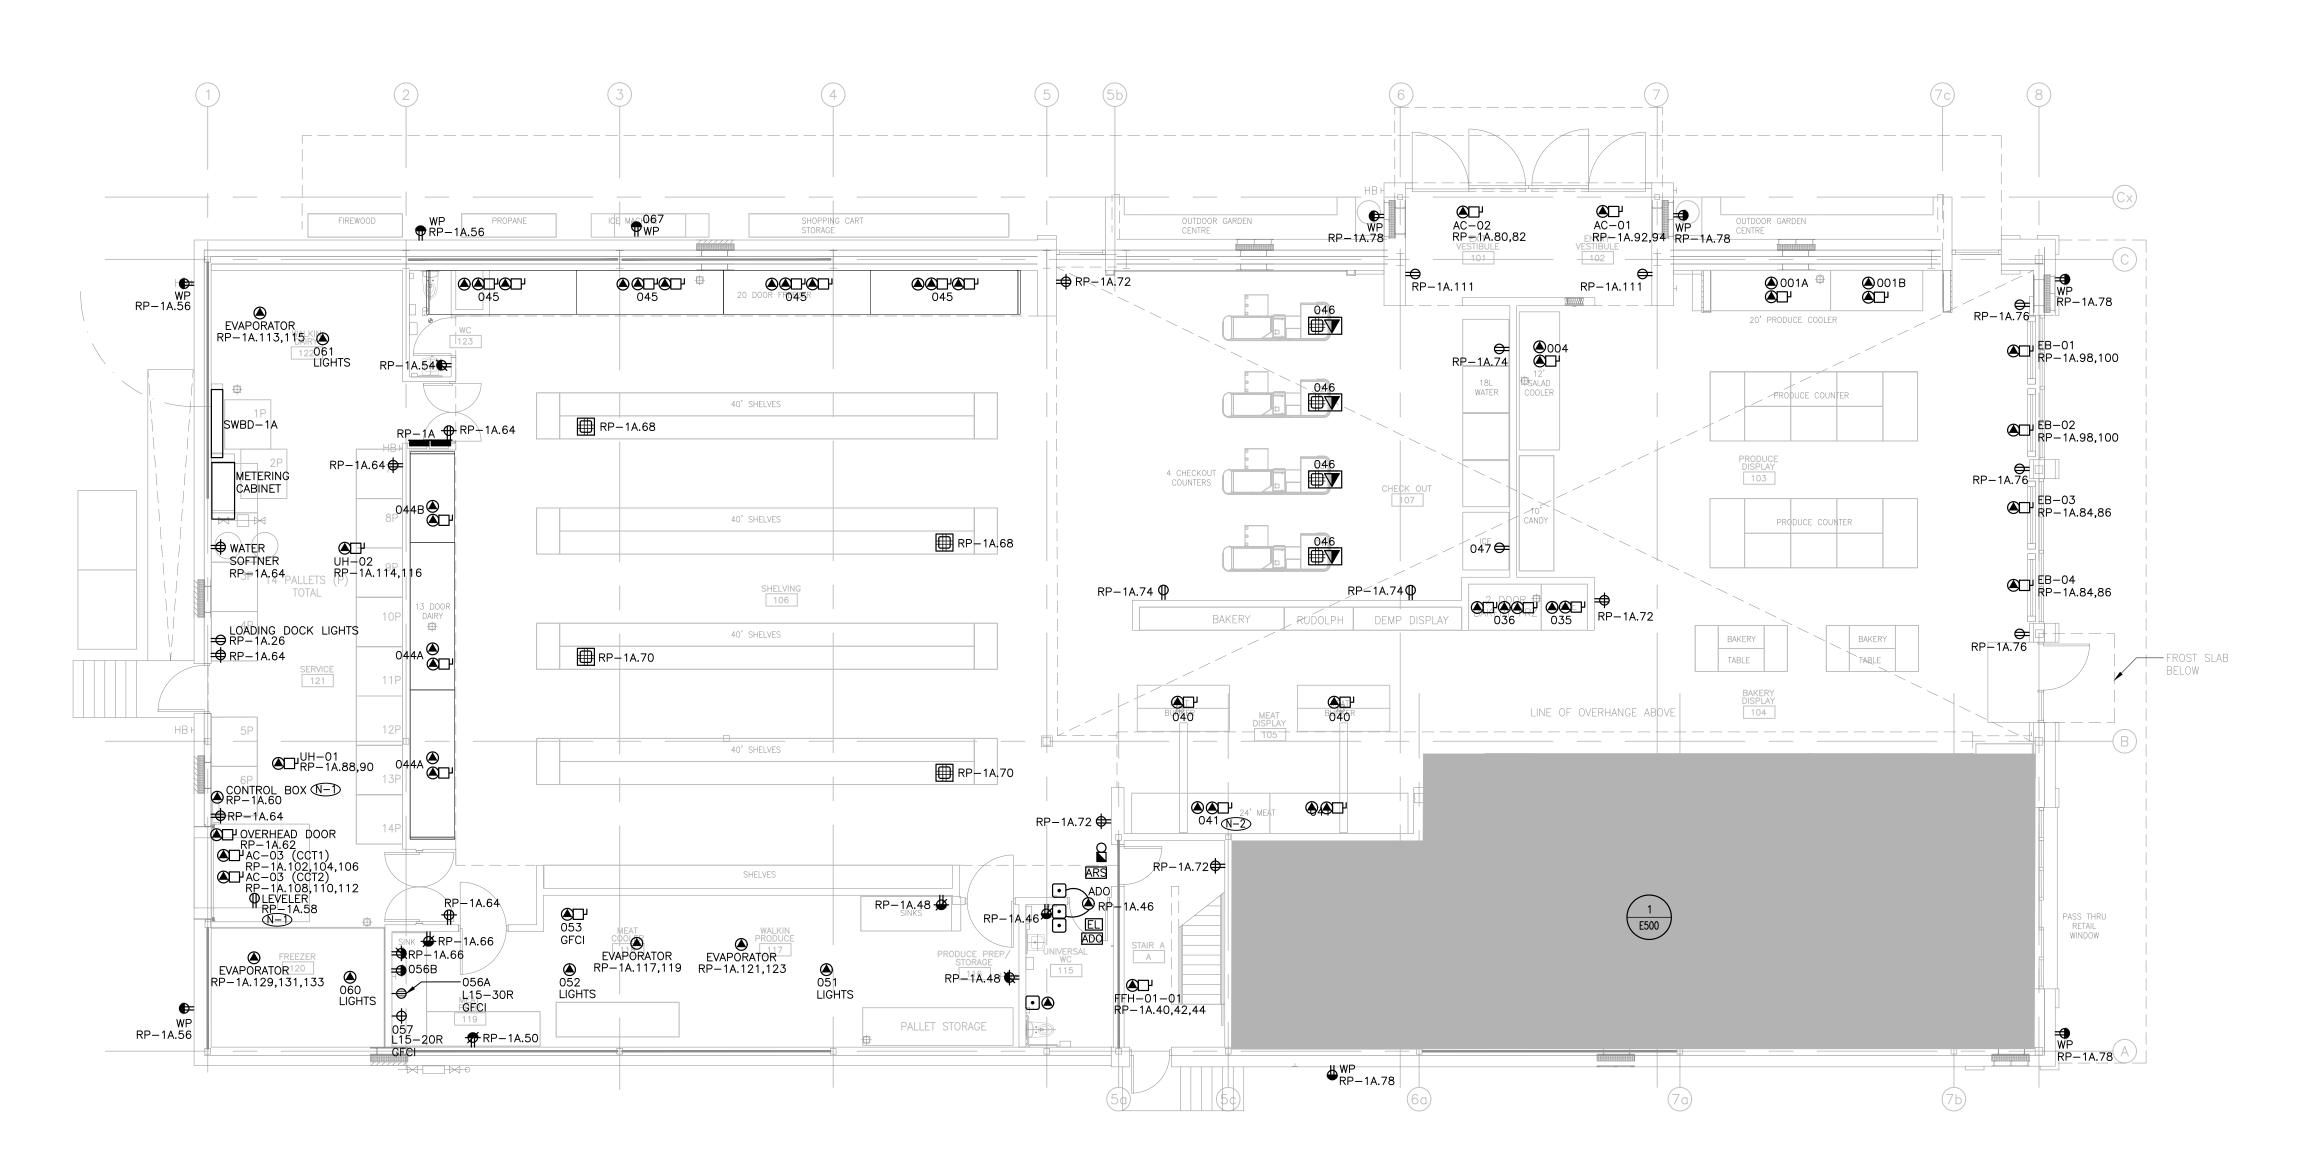

					EQUIPMENT										
TEM NO.	QTY	LOCATION	DESCRIPTION		PANEL	CIRCUIT NUMBER	CONNECTION TYPE	VOLTAGE (V)	CYCLE (HZ)	PHASE	AMPS (A)	НР	CONNECTED LOAD (W)	MOP (A)	MCA (A
001A 1		103 - PRODUCE DISPLAY	12' PRODUCE COOLER	FANS	RP-1A	1	DC	120	60	1	0.57		60	15	0.62
00271		100 11100002 0101 211	12 1 110 20 21 20 212 11	LIGHTS	RP-1A	14	DC	120	60	1	0.72		86.4		
001B	1	103 - PRODUCE DISPLAY	8' PRODUCE COOLER	FANS	RP-1A	3	DC	120	60	1	0.38		45	15	0.43
				LIGHTS	RP-1A	14	DC	120	60	1	0.48		57.6		
004	1	103 - PRODUCE DISPLAY	12' SALAD COOLER	FANS	RP-1A	5	DC	120	60	1	0.57		45	15	0.62
			1 111	LIGHTS	RP-1A	14	DC	120	60	1	2.25				
035	1	105 - MEAT DISPLAY	CAKE	FANS	RP-1A	7	DC	120	60	1	0.19		15	15	0.23
				LIGHTS	RP-1A	14	DC	120	60	1	0.41				
				FANS & HEAT	RP-1A	9	DC	120	60	1	4.19				
036	1	105 - MEAT DISPLAY	2 DOOR BAKERY FREEZER	LIGHTS	RP-1A	14	DC	120	60	1	0.36		43.2		
				ELECTRIC DEFROST HEATER	RP-1A	11, 13	DC	208	60	1	6.72		1400		
040	2	105 - MEAT DISPLAY	MEAT BUNKER		RP-1A	17,19 21,22	DC	208	60	1	8.08			30	21.3
041	41 2 105	105 - MEAT DISPLAY	12' MEAT SHELF	FANS	RP-1A	25 27	DC	120	60	1	1.52				
041	2	103 - WILAT DISPLAT	12 WILAT STILLF	LIGHTS	RP-1A	14	DC	120	60	1	1.75				
	_			FANS & HEAT	RP-1A	29 31	DC	120	60	1	2.87				
)44A	2	106 - SHELVING	5 DOOR DAIRY SHELVING	LIGHTS	RP-1A	16	DC	120	60	1	0.84		100.5		
				FANS & HEAT	RP-1A	33	DC	120	60	1	1.12				
044B	1	106 - SHELVING	3 DOOR DAIRY SHELVING	LIGHTS	RP-1A	16	DC	120	60	1	0.53		63.8		
				FANS & HEAT	RP-1A	35 55 57 59	DC	120	60	1	15.87				
045	4	106 - SHELVING	5 DOOR FREEZER SHELVING	LIGHTS	RP-1A	16	DC	120	60	1	0.84		100.5		
				ELECTRIC DEFROST HEATER	RP-1A	37,39,41 43,45,47 49,51,53 61,63,65	DC	208	60	3	16.82		3500		
046	4	107 - CHECKOUT	CHECKOUT	·	RP-1A	67 69 71 73	FLOORBOX	120	60	1	2.5				
047	1	107 - CHECKOUT	ICE MACHINE		RP-1A	75	NEMA 5-15R	120	60	1				15	
051	1	117 - WALKIN PRODUCE	COOLER	LIGHTS	RP-1A	18	DC	120	60	1				15	
-	-	TI. WALKINT RODUCE	COOLEN	COILS	RP-1A	77	DC	120	60	1				15	
052	1	118 - MEAT COOLER	COOLER	LIGHTS	RP-1A	20	DC	120	60	1				15	
053	1	118 - MEAT COOLER	MEAT GRINDER	COILS	RP-1A RP-1A	79 81,83,85	DC DC	120 208	60 60	3	13.29	5	2660	15	
					RP-1A	<u> </u>		+			13.29	7.5 (GRIND	2000		
)56A	1	119 - MEAT PREP		MEAT GRINDER		87,89,91	L15-30R	208	60	3		1 (MIX)	400		
056B	1	119 - MEAT PREP	MEAT GRINDER - TENDERIZER ADD MEAT BONE SAW, ELECTRIC	-UN	RP-1A	93 95,97,99	NEMA 5-15R L15-20R	120	60	1	7.25	1/2	460	-	
057	1	119 - MEAT PREP	IVILAT BOINL SAW, ELECTRIC		RP-1A			208	60	3	7.25	3	1595		
060	1	120 FREEZER	EDEEZED.	LIGHTS	RP-1A	22	DC	120	60	1				15	
060	1	120 - FREEZER	FREEZER	COILS	RP-1A	101,103,105	DC	208	60					15	
061	1	121 - WALKIN DAIRY	COOLER	LIGHTS	RP-1A	24	DC	120	60	1				15	
	1	000 - EXTERIOR	ICE MACHINE	COILS	RP-1A RP-1A	107 109	DC NEMA 5-15R	120 120	60 60	1				15 15	

GENERAL NOTES:

N-D RECEPTACLE FOR AIR ACTIVATED LEVELER TO BE FLUSH MOUNTED AND WIRED THROUGH THE PUSH BUTTON STATION PER LEVELER'S USER MANUAL WIRING DIAGRAM. ELECTRICAL CONTRACTOR TO PROVIDE 3/4" CONDUITS FROM RECEPTACLE TO CONTROL BOX. CONDUITS AND RECEPTACLE TO BE SET BEFORE POURING CONCRETE.

N-2) REFER TO EQUIPMENT SCHEDULE FOR ITEM NUMBER AND CORRESPONDING CIRCUIT NUMBER(S). TYPICAL.

Contractor must check and verify all dimensions on the job, and report any discrepancies to the Architect before proceeding with the work.

Do not scale this drawing.

REVISIONS AND ISSUES

REV	DESCRIPTION	DATE	BY
1	ISSUED FOR COSTING	2021.08.17	
2	ISSUED FOR TENDER	2021.08.27	
3	ISSUED FOR BUILDING PERMIT	2021.09.09	
4	ISSUED FOR ADD-E01	2021.09.15	
5	ISSUED FOR ADD-E03	2021.09.27	
6	ISSUED FOR REVISED TENDER/BUILDING PERMIT	2022.01.31	
7			

# **AMLM**

maclennan jaunkalns miller architects

toronto ontario m5v 3c1 416 593 6796 www.mjmarchitects.com

## TRITON ENGINEERING SERVICES LTD

18 ROBB BOULEVARD — UNIT 8

ORANGEVILLE, ONTARIO TEL 519 941 0330 FAX 519 941 1830

### BLACKWELL STRUCTURAL ENGINEERS

134 PETER STREET, SUITE 1301 TORONTO, ONTARIO, M5V 2H2 TEL 416.593.5300 FAX 416.593.4840

## SMITH + ANDERSON MECHANICAL AND ELECTRICAL ENGINEERS

1100 - 100 SHEPPARD AVENUE EAST TORONTO, ONTARIO, M2N 6N5 TEL 416.487.8151 -




Smith + Andersen

1100 — 100 Sheppard Ave. East, Toronto On, M2N 6N5 416 487 8151 f 416 487 9104 smithandandersen.com

## SAYERS FOOD LIMITED

132 BURLEIGH STREET t: 705.656.4531 e: sayers@apsley.ca

NORTH AR

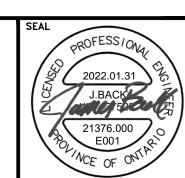

PROJECT TITLE

NEW SAYERS FOOD STORE BURLEIGH STREET, APSLEY

DRAWING TITLE

GROUND LEVEL — POWER AND SYSTEMS

1:100

JUNE 16, 2021

PROJECT NUMBER


21376.000.e001

DRAWING NUMBER

E300

DRAWING NOTES:

REFER TO EQUIPMENT SCHEDULE FOR ITEM NUMBER AND CORRESPONDING CIRCUIT NUMBER(S). TYPICAL.

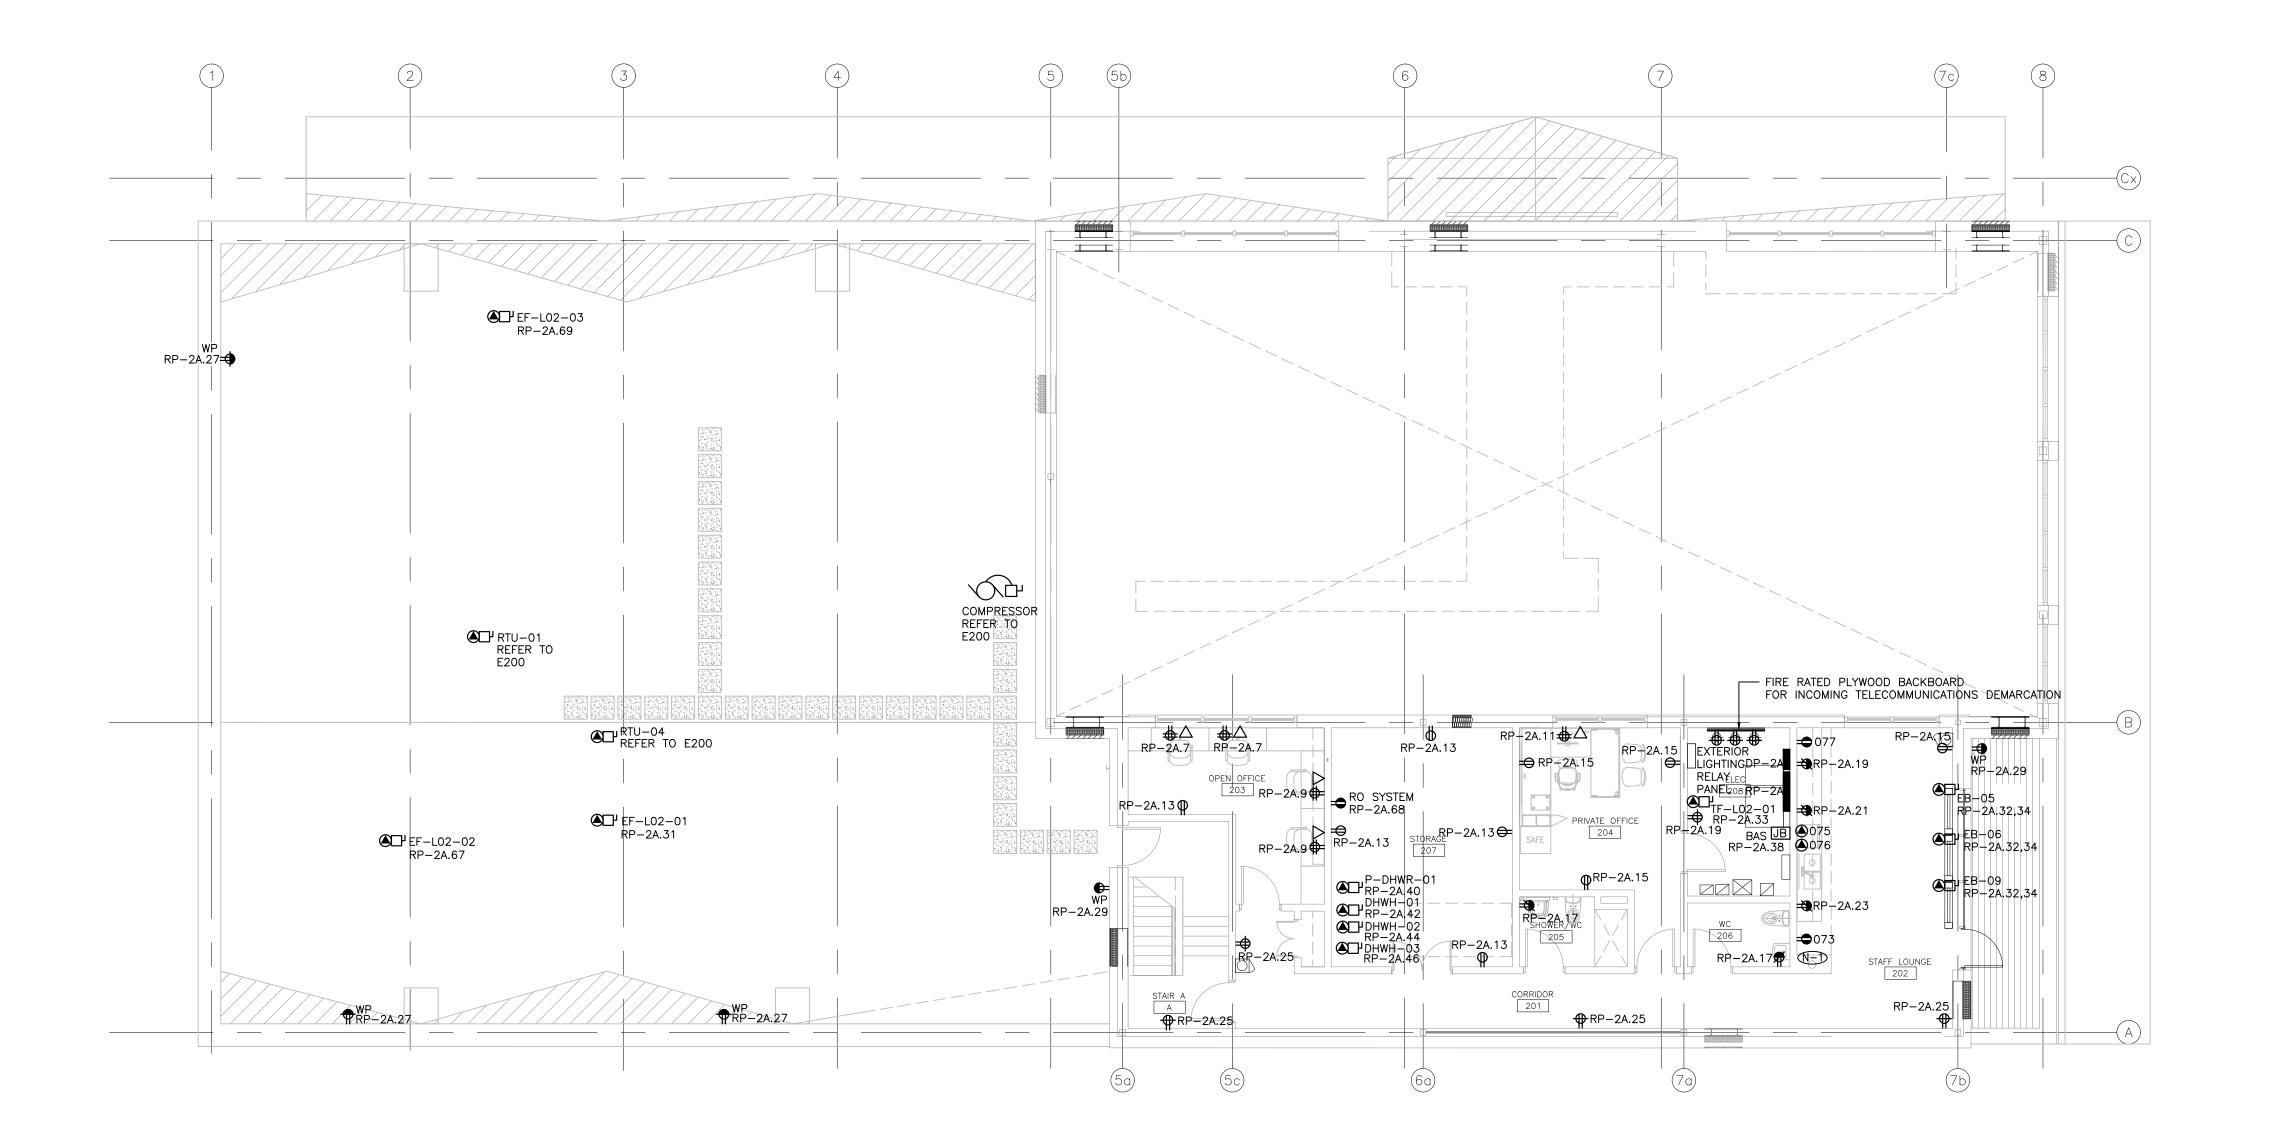

						EQUIPMENT LEVE									
NO.	QTY	LOCATION	DESCRIPT	ION	PANEL	CIRCUIT NUMBER	CONNECTION TYPE	VOLTAGE (V)	CYCLE (HZ)	PHASE	AMPS (A)	НР	CONNECTED LOAD (W)	MOP (A)	MCA (A
033															
034															
051															
052															
060															
061															
073	1	202 - STAFF LOUNGE	RESIDENTIAL FRIDGE	•	RP-2A	1	NEMA 5-15R	120	60	1				15 OR 20	
075	1	203 - STAFF LOUNGE	STOVE - STANDARD ELE RANGE/OVEN	CTRIC	RP-2A	59,61,63	DC	208	60	3				50	
076	1	203 - STAFF LOUNGE	STOVE - HOOD		RP-2A	65	DC	120	60	1				15	
077	1	204 - STAFF LOUNGE	MICROWAVE		RP-2A	3	NEMA 5-15R	120	60	1	13		1500		

Contractor must check and verify all dimensions on the job, and report any discrepancies to the Architect before proceeding with the work. Do not scale this drawing.

REVISIONS AND ISSUES

REV	DESCRIPTION	DATE	ВҮ
1	ISSUED FOR COSTING	2021.08.17	
2	ISSUED FOR TENDER	2021.08.27	
3	ISSUED FOR BUILDING PERMIT	2021.09.09	
4	ISSUED FOR ADD-E01	2021.09.15	
5	ISSUED FOR ADD-E02	2021.09.23	
6	ISSUED FOR ADD-E03	2021.09.27	
7	ISSUED FOR REVISED TENDER/BUILDING PERMIT	2022.01.31	
		-	

maclennan jaunkalns miller architects

toronto ontario m5v 3c1 416 593 6796 www.mjmarchitects.com

### TRITON ENGINEERING SERVICES LTD CIVIL ENGINEERS

18 ROBB BOULEVARD - UNIT 8

ORANGEVILLE, ONTARIO TEL 519 941 0330 FAX 519 941 1830

### BLACKWELL STRUCTURAL ENGINEERS

134 PETER STREET, SUITE 1301 TORONTO, ONTARIO, M5V 2H2
TEL 416.593.5300 FAX 416.593.4840

## SMITH + ANDERSON MECHANICAL AND ELECTRICAL ENGINEERS

1100 – 100 SHEPPARD AVENUE EAST TORONTO, ONTARIO, M2N 6N5 TEL 416.487.8151 —




Smith + Andersen

1100 — 100 Sheppard Ave. East, Toronto On, M2N 6N5 416 487 8151 f 416 487 9104 smithandandersen.com

## SAYERS FOOD LIMITED

132 BURLEIGH STREET t: 705.656.4531 e: sayers@apsley.ca

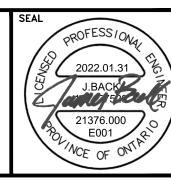


PROJECT TITLE

NEW SAYERS FOOD STORE BURLEIGH STREET, APSLEY

SECOND LEVEL - POWER AND SYSTEMS

JUNE 16, 2021

PROJECT NUMBER 21376.000.e001

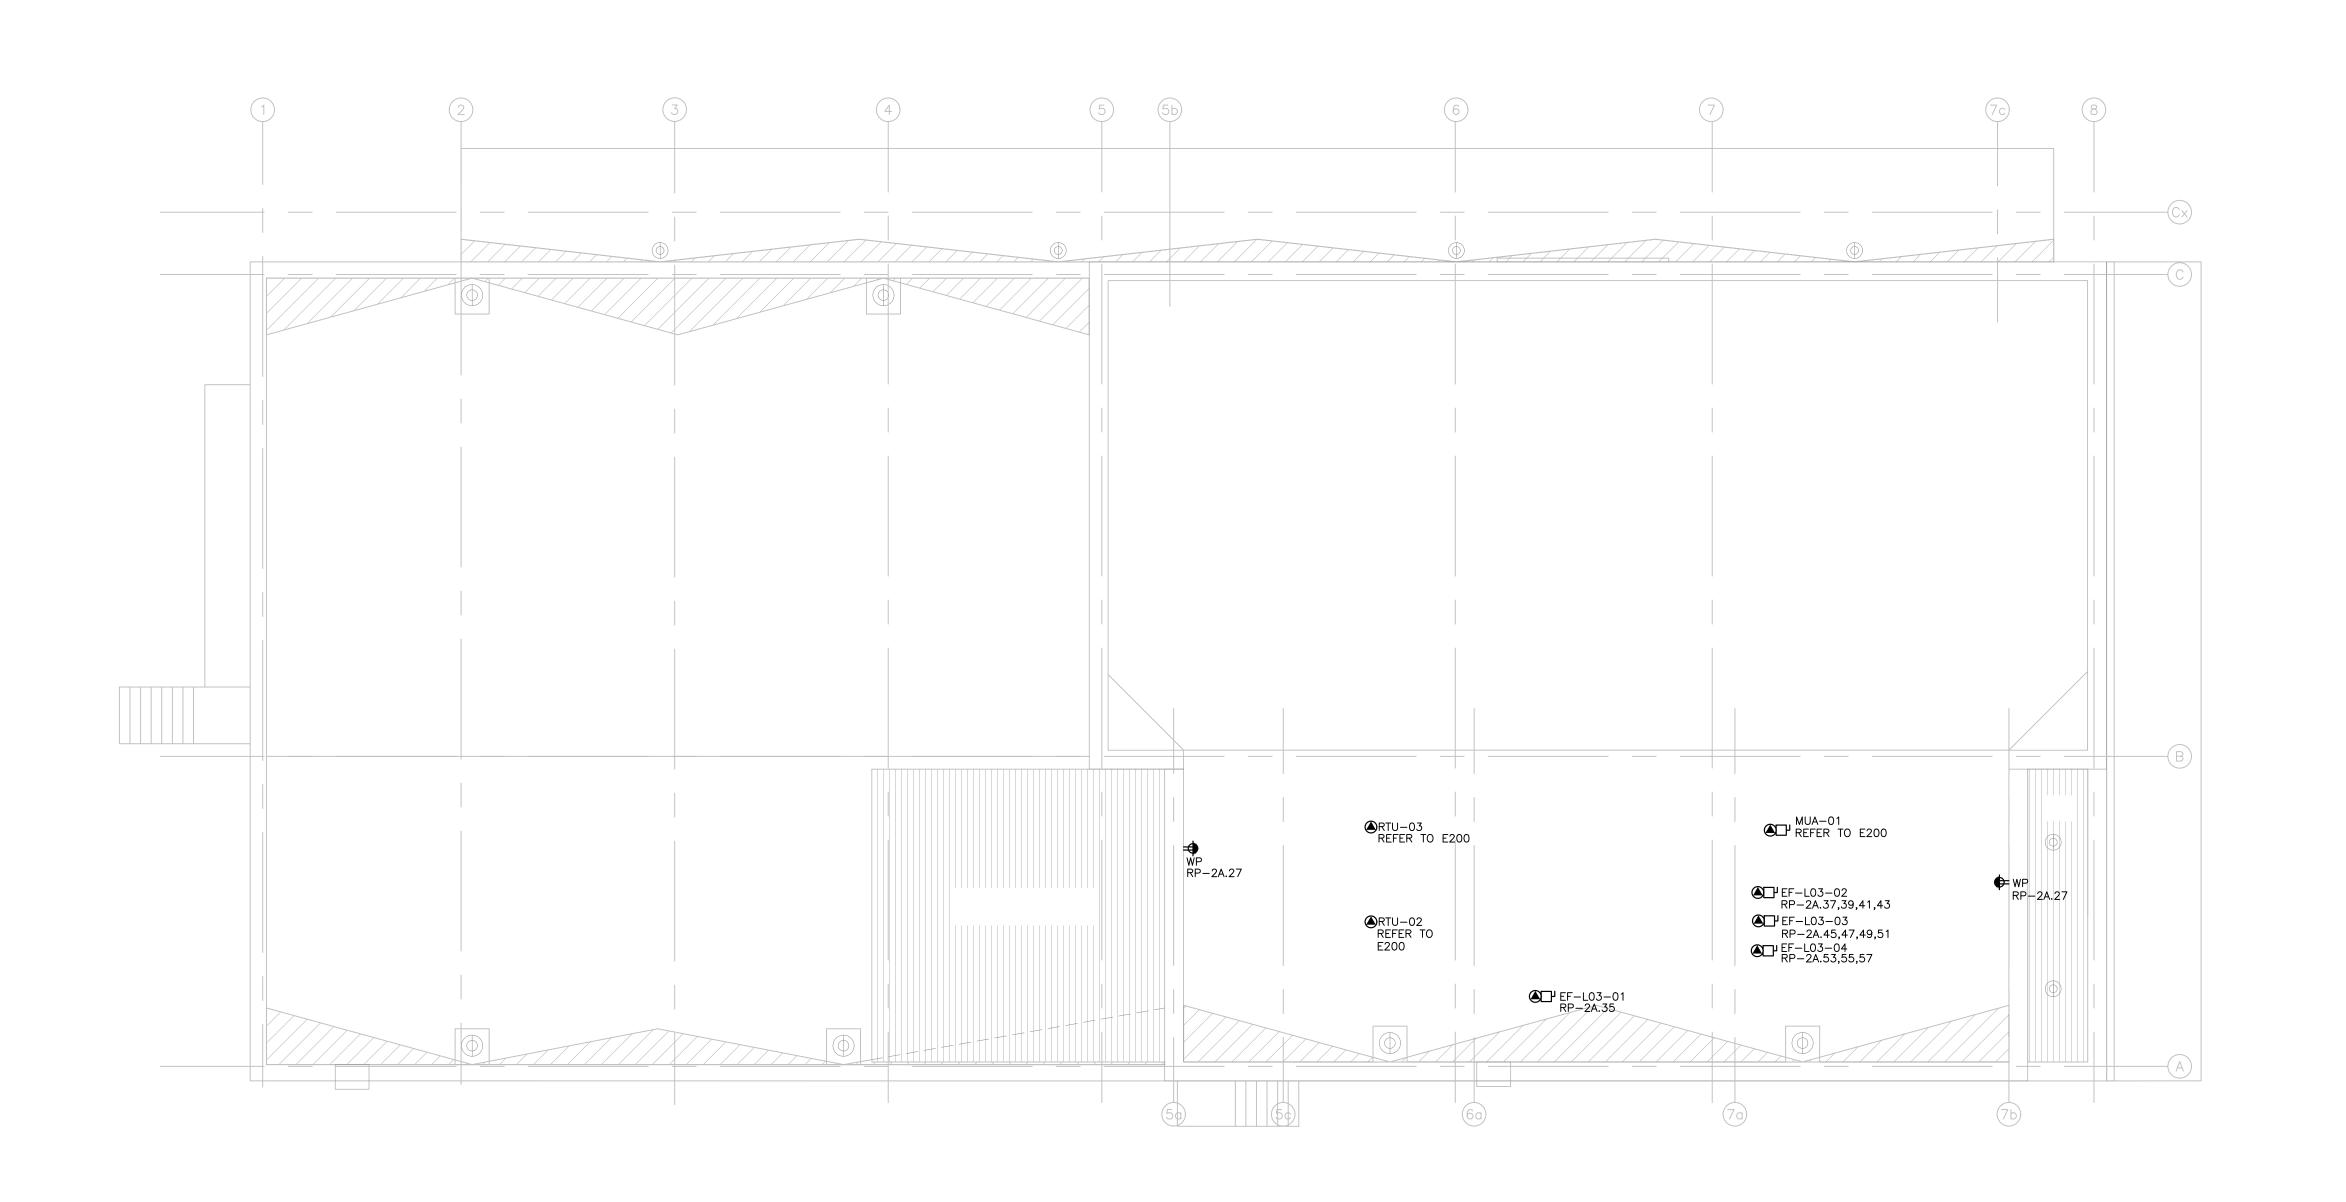

Contractor must check and verify all dimensions on the job, and report any discrepancies to the Architect before proceeding with the work. Do not scale this drawing.

REVISIONS AND ISSUES

DATE DESCRIPTION ISSUED FOR COSTING 2021.08.17 ISSUED FOR TENDER 2021.08.25 3 ISSUED FOR BUILDING PERMIT 2021.09.09 4 ISSUED FOR ADD-E01 2021.09.15

2022.01.31

ISSUED FOR REVISED

TENDER/BUILDING PERMIT

**MJMA** 

maclennan jaunkalns miller architects

toronto ontario m5v 3c1 416 593 6796 www.mjmarchitects.com

TRITON ENGINEERING SERVICES LTD CIVIL ENGINEERS

18 ROBB BOULEVARD - UNIT 8 ORANGEVILLE, ONTARIO TEL 519 941 0330 FAX 519 941 1830

BLACKWELL STRUCTURAL ENGINEERS

134 PETER STREET, SUITE 1301 TORONTO, ONTARIO, M5V 2H2 TEL 416.593.5300 FAX 416.593.4840

SMITH + ANDERSON MECHANICAL AND ELECTRICAL ENGINEERS

1100 - 100 SHEPPARD AVENUE EAST TORONTO, ONTARIO, M2N 6N5 TEL 416.487.8151 —




Smith + Andersen

1100 - 100 Sheppard Ave. East, Toronto On, M2N 6N5 416 487 8151 f 416 487 9104 smithandandersen.com

SAYERS FOOD LIMITED

132 BURLEIGH STREET t: 705.656.4531 e: sayers@apsley.ca

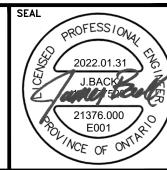

PROJECT TITLE


NEW SAYERS FOOD STORE BURLEIGH STREET, APSLEY

drawing title ROOF — POWER AND

SYSTEMS

JUNE 16, 2021

PROJECT NUMBER 21376.000.e001

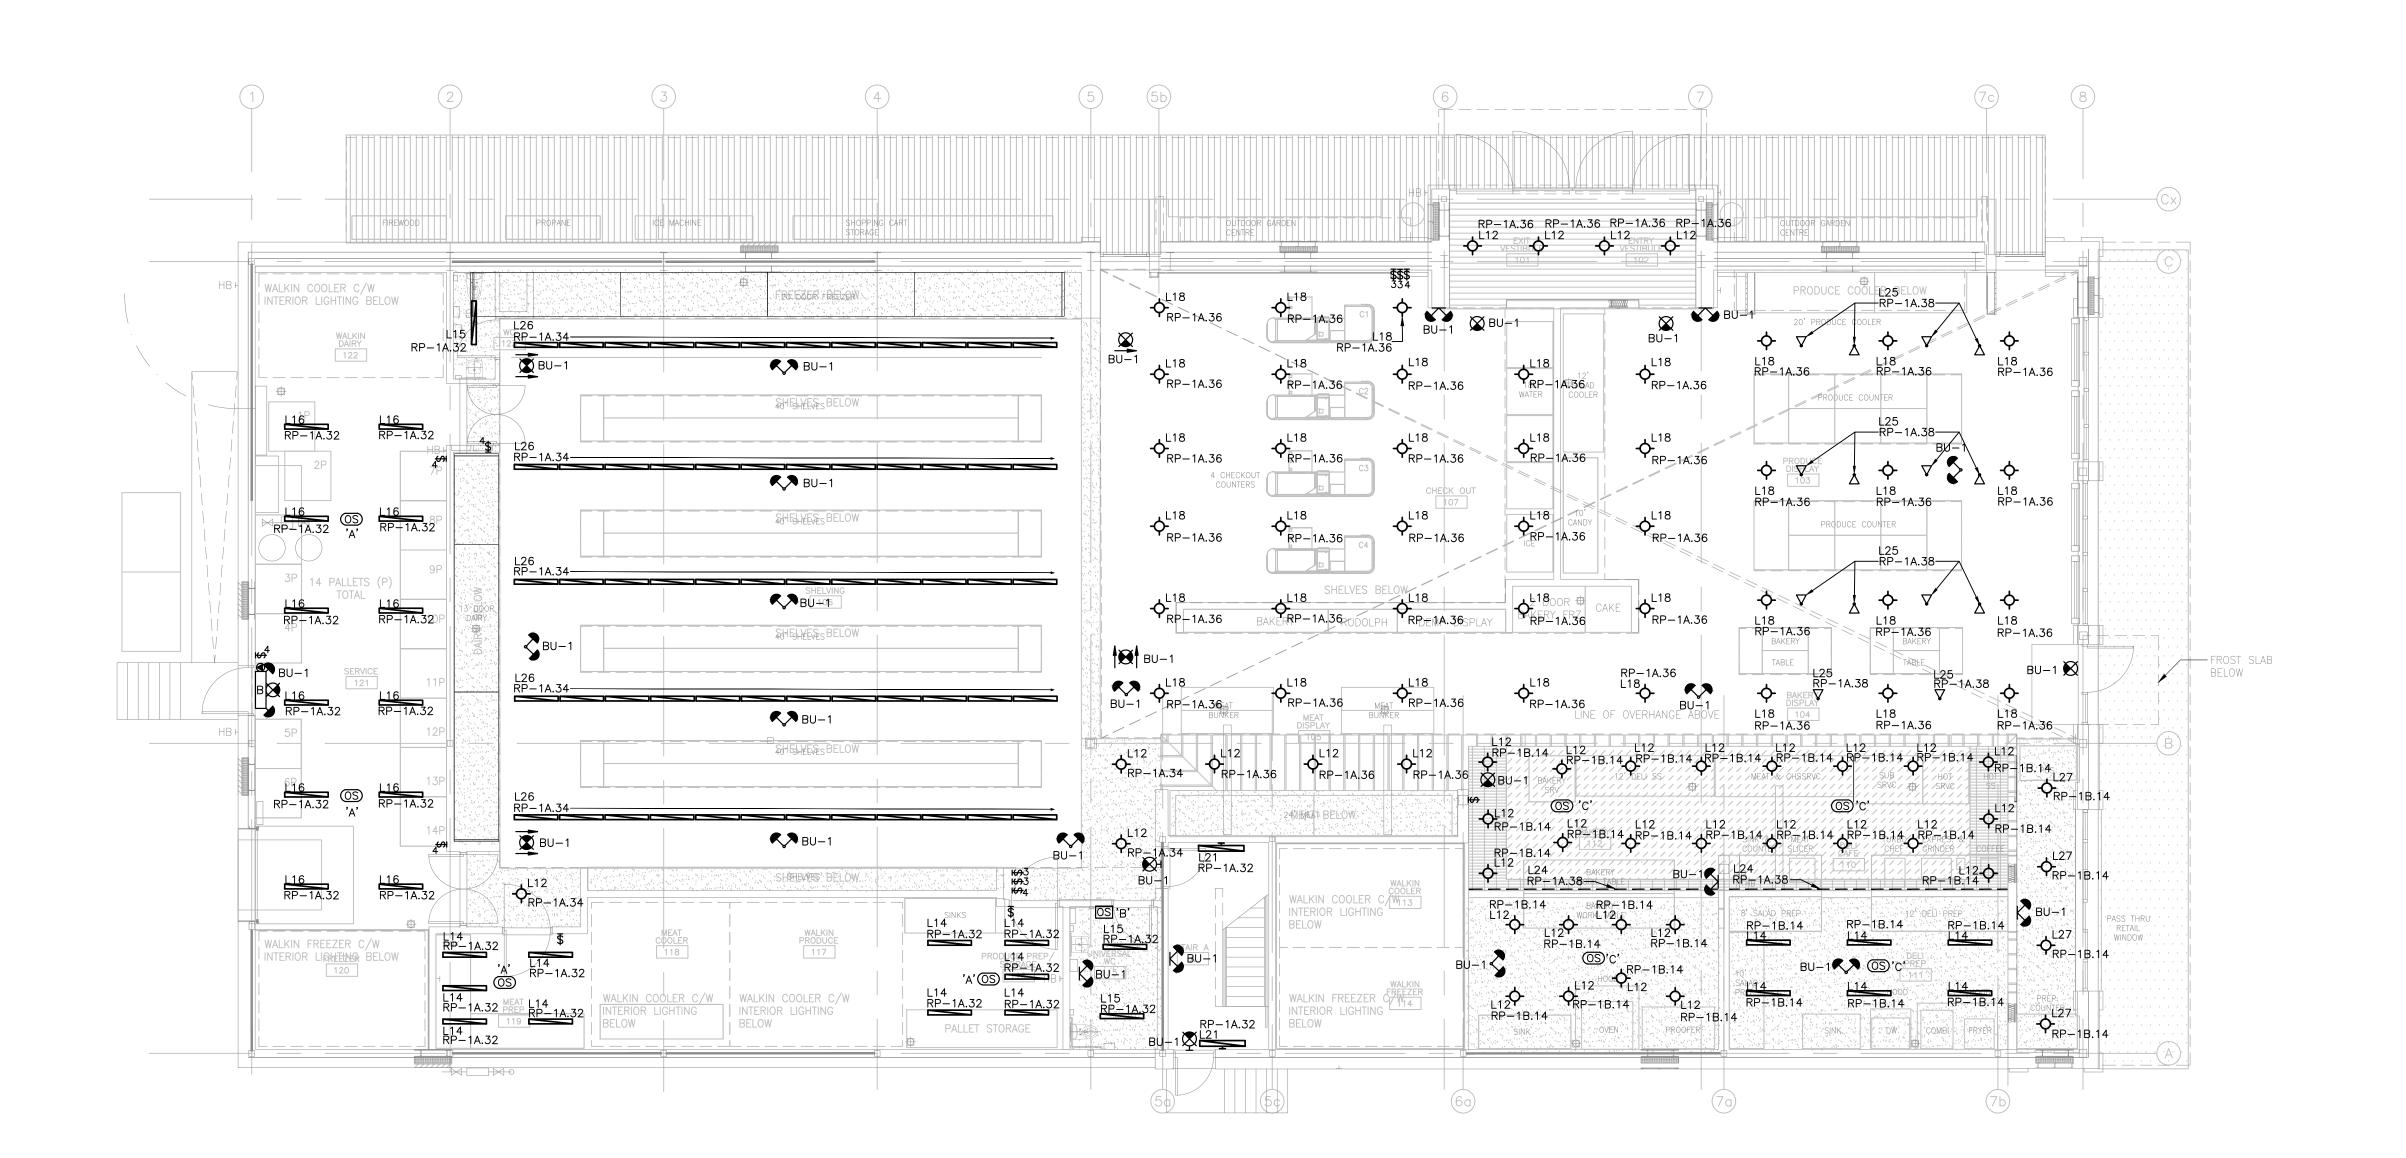

Contractor must check and verify all dimensions on the job, and report any discrepancies to the Architect before proceeding with the work. Do not scale this drawing.

REVISIONS AND ISSUES

DESCRIPTION ISSUED FOR COSTING 2021.08.17 ISSUED FOR TENDER 2021.08.27 3 ISSUED FOR BUILDING PERMIT 2021.09.09 ISSUED FOR ADD-E03 2021.09.27 ISSUED FOR REVISED 2022.01.31 TENDER/BUILDING PERMIT

# **MJMA**

maclennan jaunkalns miller architects

toronto ontario m5v 3c1 416 593 6796 www.mjmarchitects.com

#### TRITON ENGINEERING SERVICES LTD CIVIL ENGINEERS

18 ROBB BOULEVARD — UNIT 8 ORANGEVILLE, ONTARIO
TEL 519 941 0330 FAX 519 941 1830

### BLACKWELL STRUCTURAL ENGINEERS

134 PETER STREET, SUITE 1301 TORONTO, ONTARIO, M5V 2H2
TEL 416.593.5300 FAX 416.593.4840

## SMITH + ANDERSON MECHANICAL AND ELECTRICAL ENGINEERS

1100 - 100 SHEPPARD AVENUE EAST TORONTO, ONTARIO, M2N 6N5 TEL 416.487.8151 -




Smith + Andersen

1100 - 100 Sheppard Ave. East, Toronto On, M2N 6N5 416 487 8151 f 416 487 9104 smithandandersen.com

## SAYERS FOOD LIMITED

132 BURLEIGH STREET t: 705.656.4531 e: sayers@apsley.ca

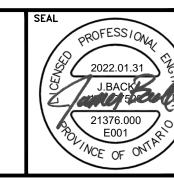

PROJECT TITLE

NEW SAYERS FOOD STORE BURLEIGH STREET, APSLEY


GROUND LEVEL - LIGHTING

JUNE 16, 2021

PROJECT NUMBER

DRAWING NUMBER

21376.000.e001

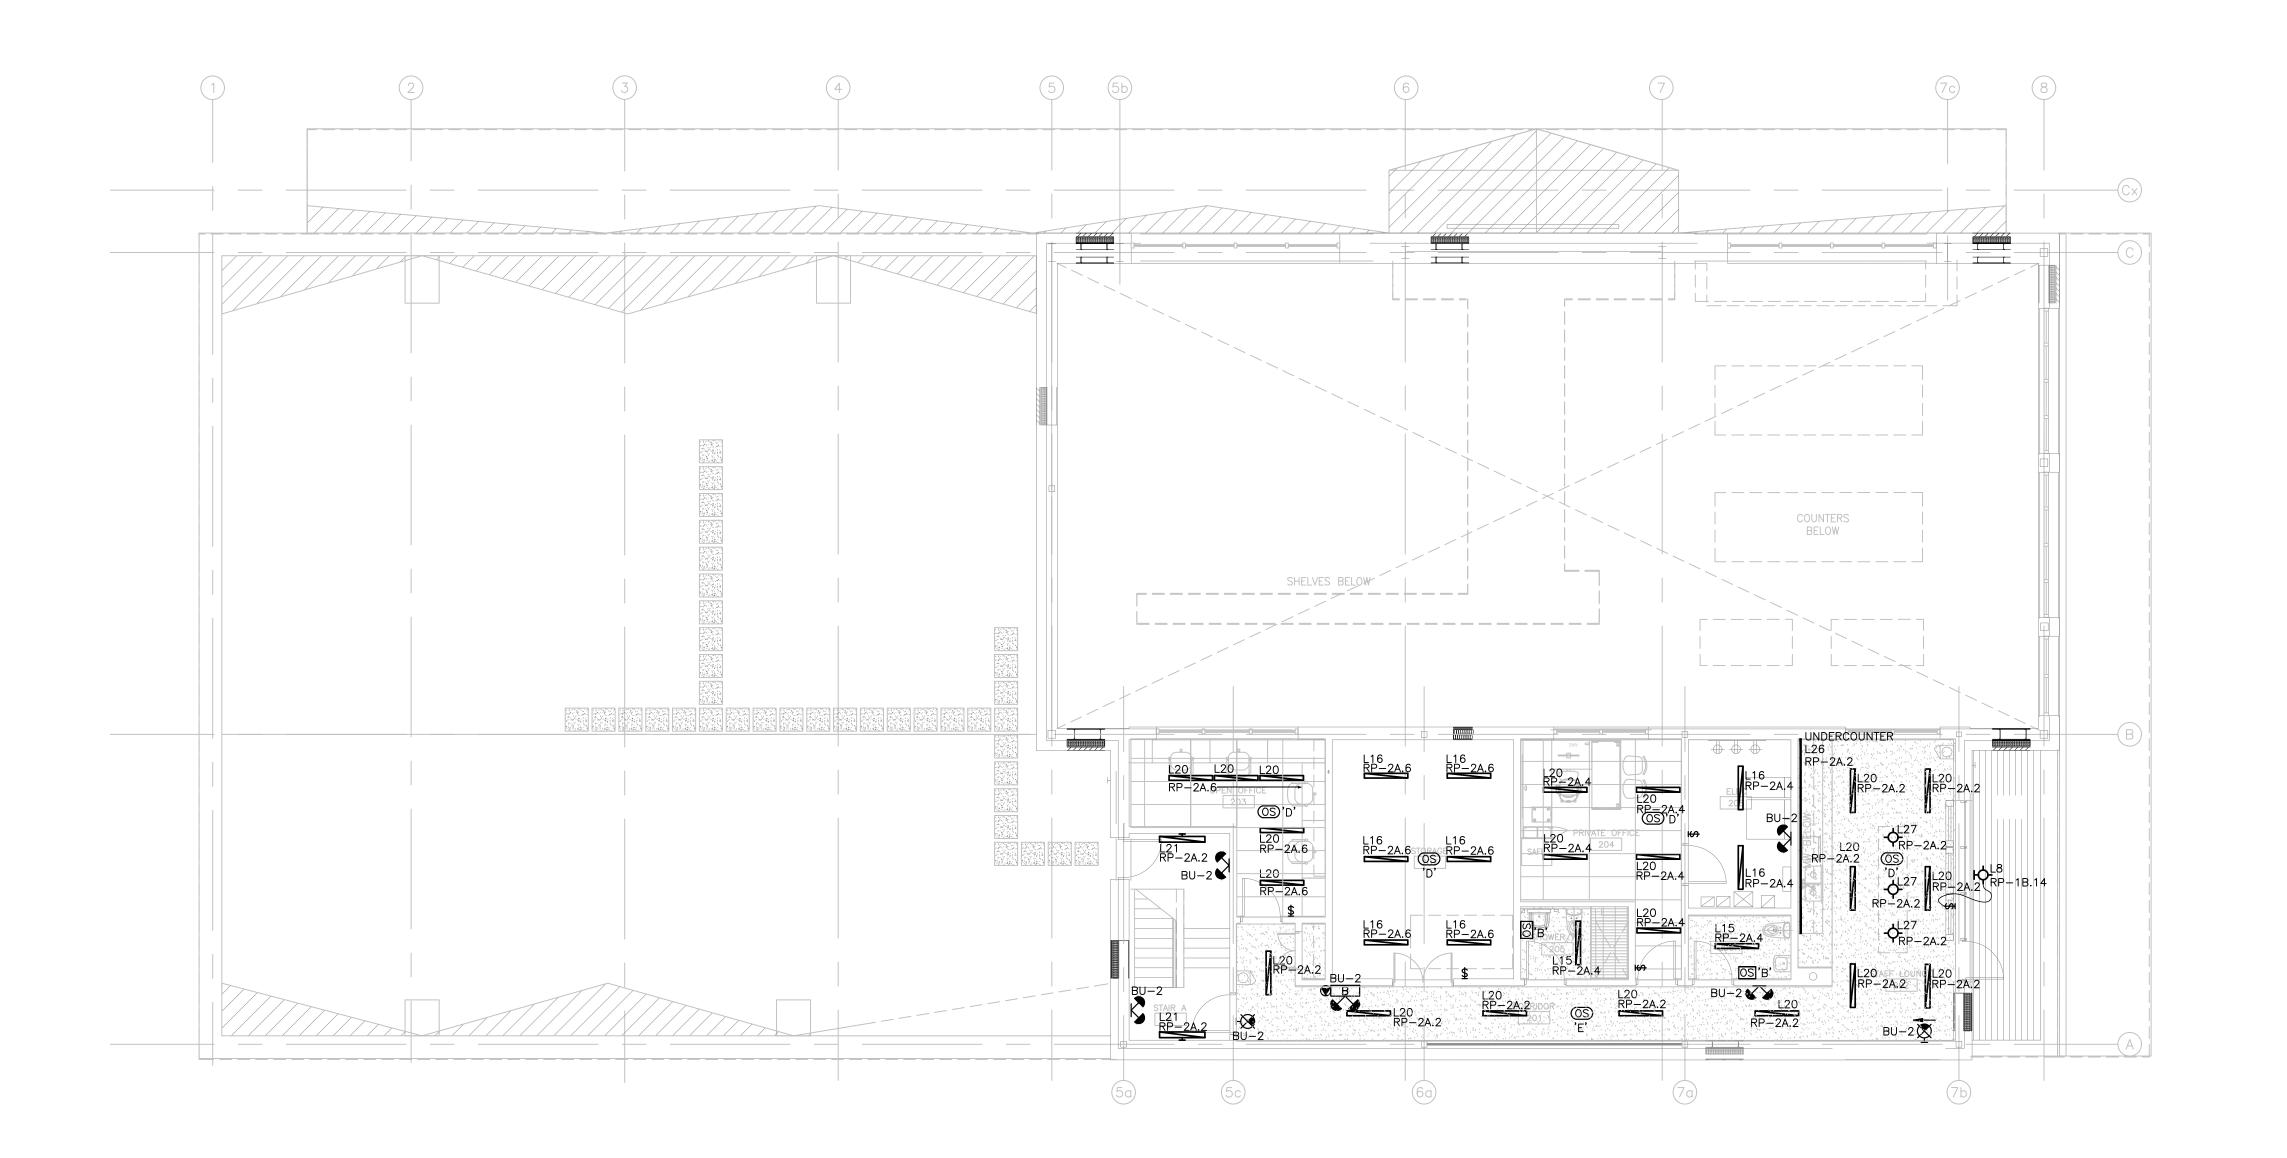

Contractor must check and verify all dimensions on the job, and report any discrepancies to the Architect before proceeding with the work. Do not scale this drawing.

REVISIONS AND ISSUES

DATE DESCRIPTION ISSUED FOR COSTING 2021.08.17 ISSUED FOR TENDER 2021.08.27 3 ISSUED FOR BUILDING PERMIT 2021.09.09 4 ISSUED FOR ADD-E03 2021.09.27 ISSUED FOR REVISED 2022.01.31 TENDER/BUILDING PERMIT

maclennan jaunkalns miller architects

toronto ontario m5v 3c1 416 593 6796 www.mjmarchitects.com

### TRITON ENGINEERING SERVICES LTD CIVIL ENGINEERS

18 ROBB BOULEVARD - UNIT 8 ORANGEVILLE, ONTARIO TEL 519 941 0330 FAX 519 941 1830

## BLACKWELL STRUCTURAL ENGINEERS

134 PETER STREET, SUITE 1301 TORONTO, ONTARIO, M5V 2H2
TEL 416.593.5300 FAX 416.593.4840

## SMITH + ANDERSON MECHANICAL AND ELECTRICAL ENGINEERS

1100 - 100 SHEPPARD AVENUE EAST TORONTO, ONTARIO, M2N 6N5 TEL 416.487.8151 —




Smith + Andersen

1100 — 100 Sheppard Ave. East, Toronto On, M2N 6N5 416 487 8151 f 416 487 9104 smithandandersen.com

## SAYERS FOOD LIMITED

132 BURLEIGH STREET t: 705.656.4531 e: sayers@apsley.ca

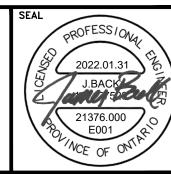


PROJECT TITLE


NEW SAYERS FOOD STORE BURLEIGH STREET, APSLEY


DRAWING TITLE
SECOND LEVEL — LIGHTING


JUNE 16, 2021


PROJECT NUMBER 21376.000.e001

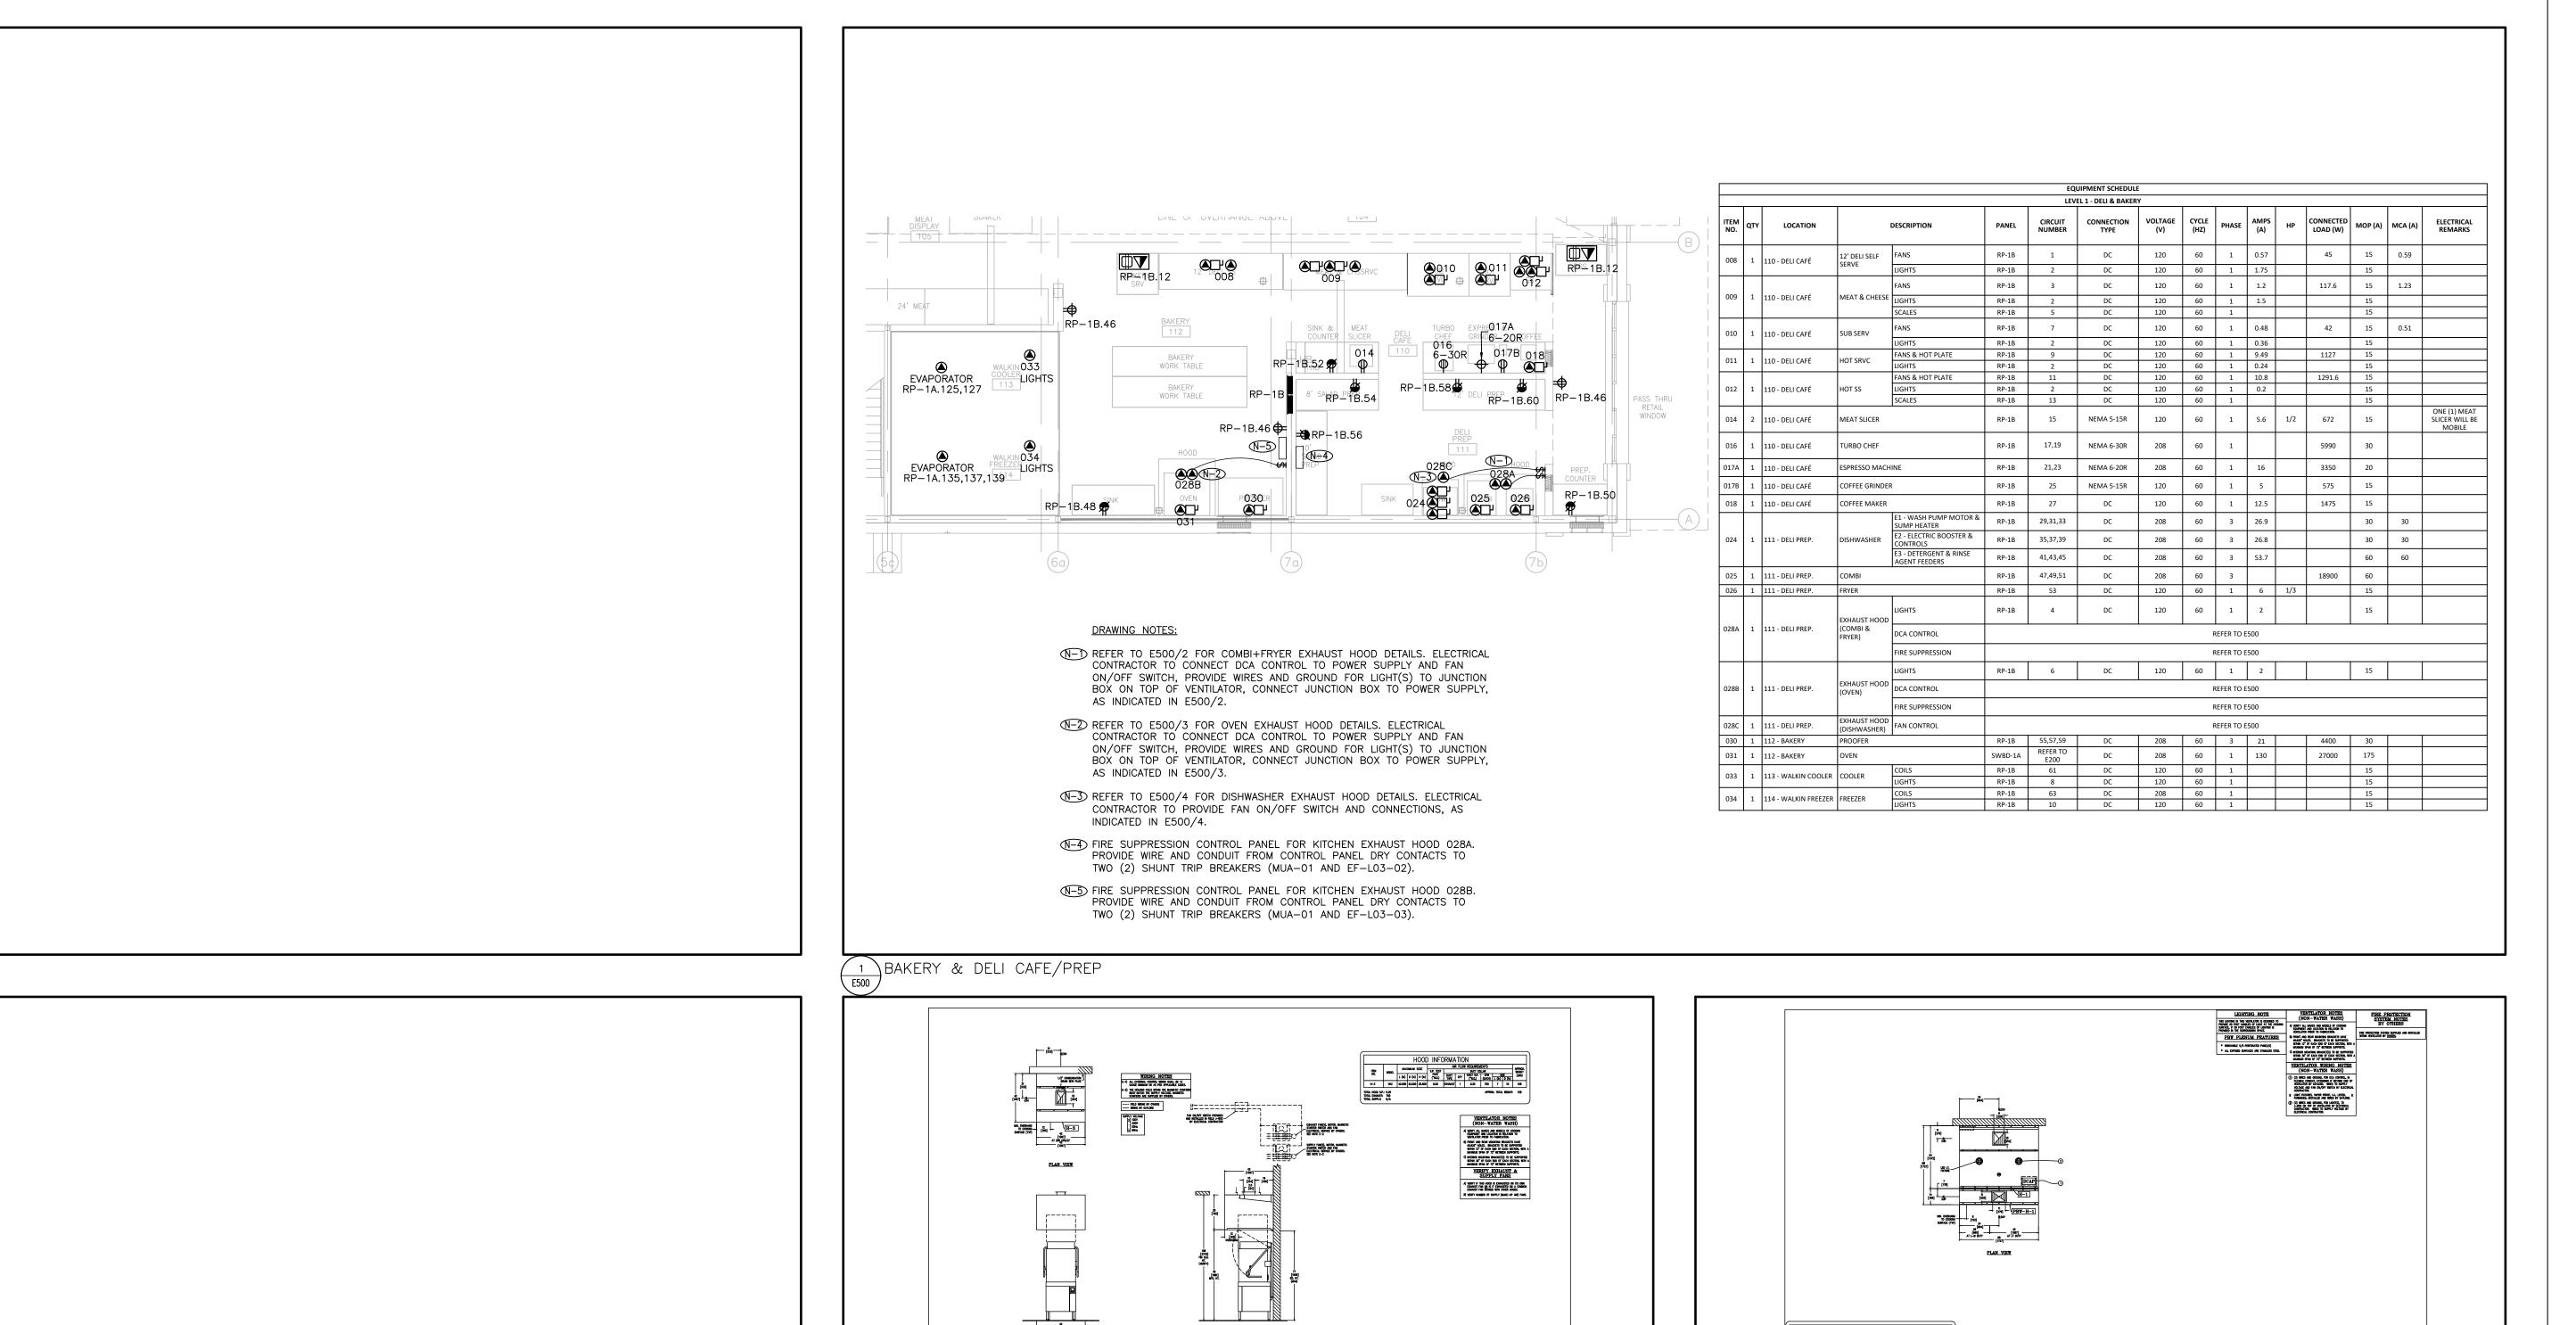

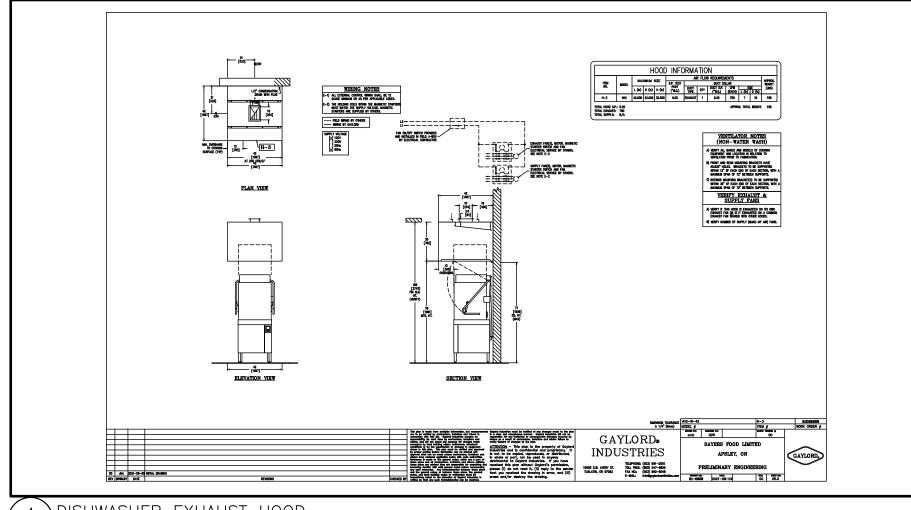

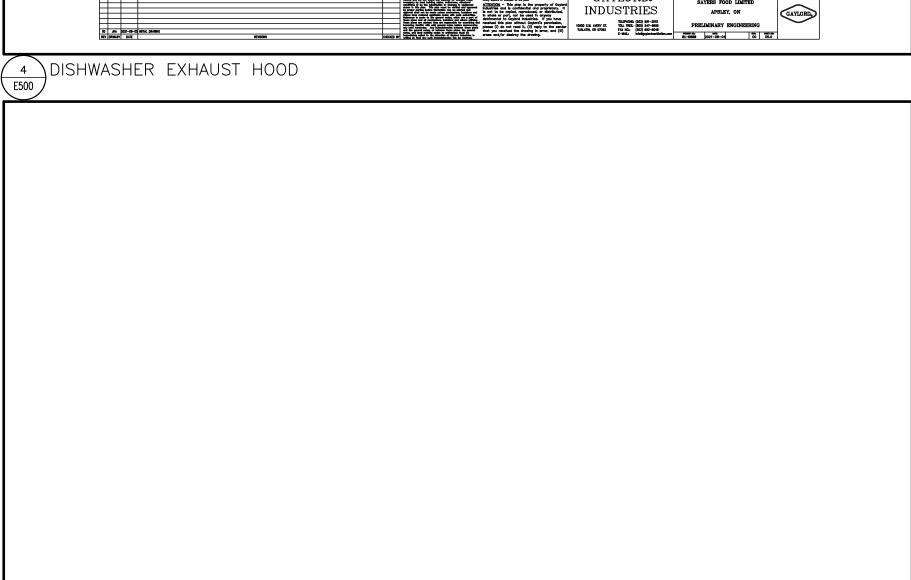

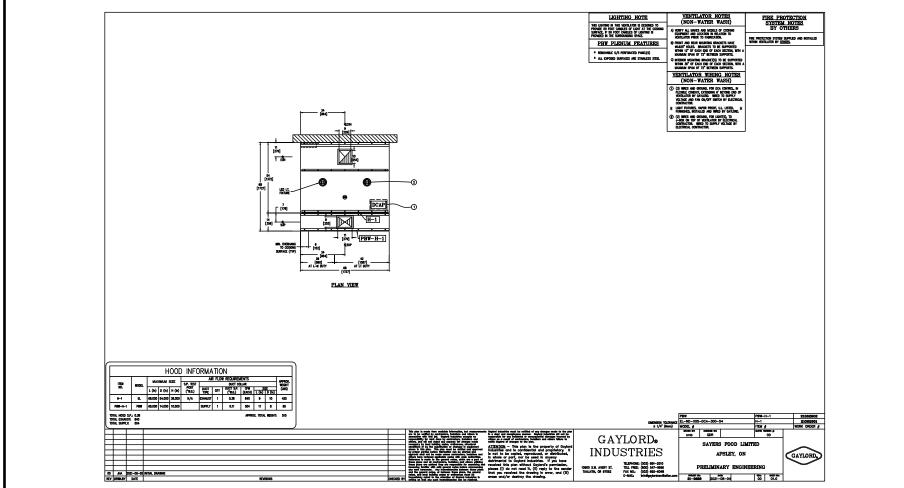

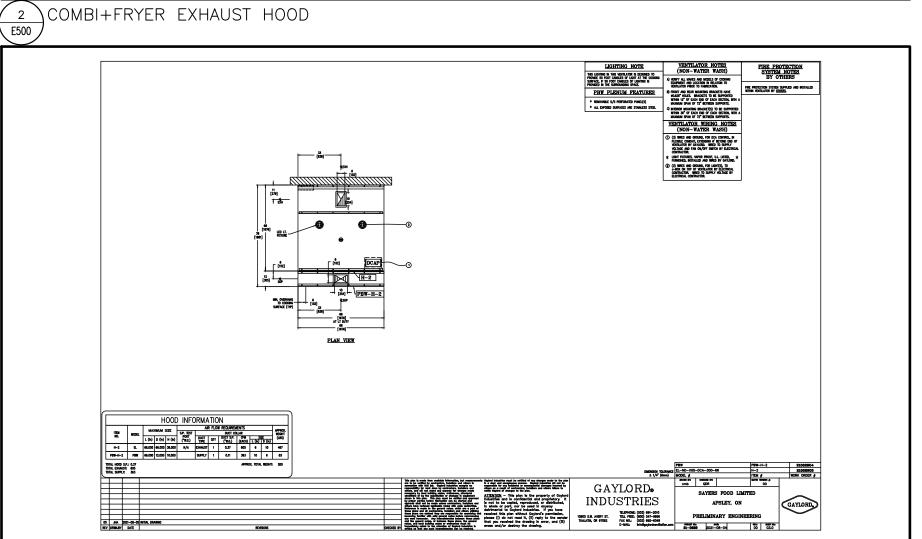

3 OVEN EXHAUST HOOD

Contractor must check and verify all dimensions on the job, and report any discrepancies to the Architect before proceeding with the work. Do not scale this drawing.

REVISIONS AND ISSUES

REV	DESCRIPTION	DATE	ı
1	ISSUED FOR COSTING	2021.08.17	
2	ISSUED FOR TENDER	2021.08.27	
3	ISSUED FOR BUILDING PERMIT	2021.09.09	
4	ISSUED FOR ADD-E01	2021.09.15	
5	ISSUED FOR ADD-E03	2021.09.27	
6	ISSUED FOR REVISED TENDER/BUILDING PERMIT	2022.01.31	
7			

# MJMA

maclennan jaunkalns miller architects

425 adelaide street west level 6 416 593 6796 www.mjmarchitects.com

TRITON ENGINEERING SERVICES LTD

18 ROBB BOULEVARD - UNIT 8 ORANGEVILLE, ONTARIO TEL 519 941 0330 FAX 519 941 1830

BLACKWELL STRUCTURAL ENGINEERS

134 PETER STREET, SUITE 1301 TORONTO, ONTARIO, M5V 2H2
TEL 416.593.5300 FAX 416.593.4840

SMITH + ANDERSON

MECHANICAL AND ELECTRICAL ENGINEERS 1100 - 100 SHEPPARD AVENUE EAST TORONTO, ONTARIO, M2N 6N5




TEL 416.487.8151 -

Smith + Andersen

1100 — 100 Sheppard Ave. East, Toronto On, M2N 6N5 416 487 8151 f 416 487 9104 smithandandersen.com

## SAYERS FOOD LIMITED

132 BURLEIGH STREET t: 705.656.4531 e: sayers@apsley.ca

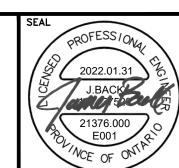

PROJECT TITLE

NEW SAYERS FOOD STORE BURLEIGH STREET, APSLEY

ENLARGED PLANS

1:100

JUNE 16, 2021

21376.000.e001