NEW SAYERS FOOD STORE APSLEY, ONTARIO

MACLENNAN JAUNKALNS MILLER ARCHITECTS TRITON ENGINEERING SERVICES LTD, CIVIL ENGINEERS BLACKWELL STRUCTURAL ENGINEERS SMITH AND ANDERSEN, MECHANICAL AND ELECTRICAL ENGINEERS



ISSUED FOR REVISED TENDER - JAN. 24, 2022

CIVIL

CONSTRUCTION GRADING & SERVICING PLAN

NOTES AND DETAILS

STANDARDS

STANDARDS

STANDARDS

ARCHITECTURAL

COVER SHEET

SITE SURVEY

SITE PLAN

EX FOUNDATION REMOVAL SITE PLAN

SITE PLAN DETAILS 2

SITE PLAN DETAILS 3

SITE PLAN DETAILS 4

OBC MATRIX

LIFE SAFETY & CODE

ASSEMBLIES & FLOOR TYPES

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LEVEL 2 FLOOR PLAN

ROOF PLAN

REFLECTED CEILING PLAN

LEVEL 2 REFLECTED CEILING PLAN

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BUILDING SECTIONS

WALL SECTIONS EAST & SOUTH FACADES

WALL SECTIONS NORTH & WEST FACADES

WALL SECTIONS

SECTION DETAILS

UNIVERSAL WC - ENLARGED PLANS

EQUIPMENT FLOOR PLANS

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EQUIPMENT SCHEDULE

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INTERIOR ELEVATIONS

INTERIOR WALL SECTIONS

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DOOR SCHEDULE AND DETAILS

EXTERIOR & INTERIOR SCREEN SCHEDULES

FINISH FLOOR PLANS AND SCHEDULE

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MILLWORK DRAWINGS

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TYPICAL DETAILS

TYPICAL DETAILS

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SECOND & LOW ROOF FRAMING PLAN

HIGH ROOF FRAMING PLAN

WIND UPLIFT DIAGRAMS

SHEAR FORCE DIAGRAMS

COLUMN SCHEDULE

FRAMING ELEVATIONS

FRAMING ELEVATIONS

BUILDING SECTIONS

BUILDING SECTIONS

BUILDING SECTIONS

DETAILED SECTIONS

DETAILED SECTIONS

DETAILED SECTIONS

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PLUMBING SCHEMATICS

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GROUND FLOOR PLAN PLUMBING AND DRAINAGE

SECOND FLOOR PLAN PLUMBING AND DRAINAGE

GROUND FLOOR PLAN KITCHEN PLUMBING AND DRAINAGE

ROOF PLAN PLUMBING AND DRAINAGE

GROUND FLOOR PLAN HVAC

SECOND FLOOR PLAN HVAC

ROOF PLAN HVAC

GROUND FLOOR PLAN KITCHEN HVAC

ELECTRICAL

DRAWING LIST AND LEGEND

LEGEND

ELECTRICAL DETAILS

ELECTRICAL DETAILS

SITE PLAN - ELECTRICAL

SINGLE LINE DIAGRAM

GROUND LEVEL - POWER AND SYSTEMS

SECOND LEVEL - POWER AND SYSTEMS

ROOF - POWER AND SYSTEMS

GROUND LEVEL - LIGHTING SECOND LEVEL - LIGHTING

ENLARGED PLAN

anv discrepancies to the Architect before proceeding with the work.

REVISIONS AND ISSUES

REV	DESCRIPTION	DAIL	В
1	ISSUED FOR SPA	210618	А
2	REVISED SPA	210709	А
3	REVISED SPA	210809	А
4	ISSUED FOR TENDER	210824	А
5	ISSUED FOR BUILDING PERMIT	210909	А
6	REVISED TENDER	220124	А
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12	_	_	_

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maclennan jaunkalns miller architects

toronto ontario m5v 3c1

416 593 6796 www.mjmarchitects.com

TRITON ENGINEERING SERVICES LTD

229 BROADWAY, UNIT 1 ORANGEVILLE, ONTARIO, L9W 1K4

TEL 519 941 0330 FAX 519 941 1830

BLACKWELL 134 PETER STREET, SUITE 1301 TORONTO, ONTARIO, M5V 2H2


TEL 416.593.5300 FAX 416.593.4840 SMITH + ANDERSON

MECHANICAL AND ELECTRICAL ENGINEERS 1100 - 100 SHEPPARD AVENUE EAST

TORONTO, ONTARIO, M2N 6N5

SAYERS FOOD LIMITED

132 BURLEIGH STREET t: 705.656.4531 e: sayers@apsley.ca

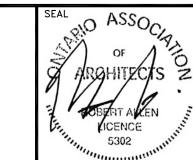


NEW SAYERS FOOD STORE BURLEIGH STREET, APSLEY

COVER SHEET

JANUARY 24, 2022

2102

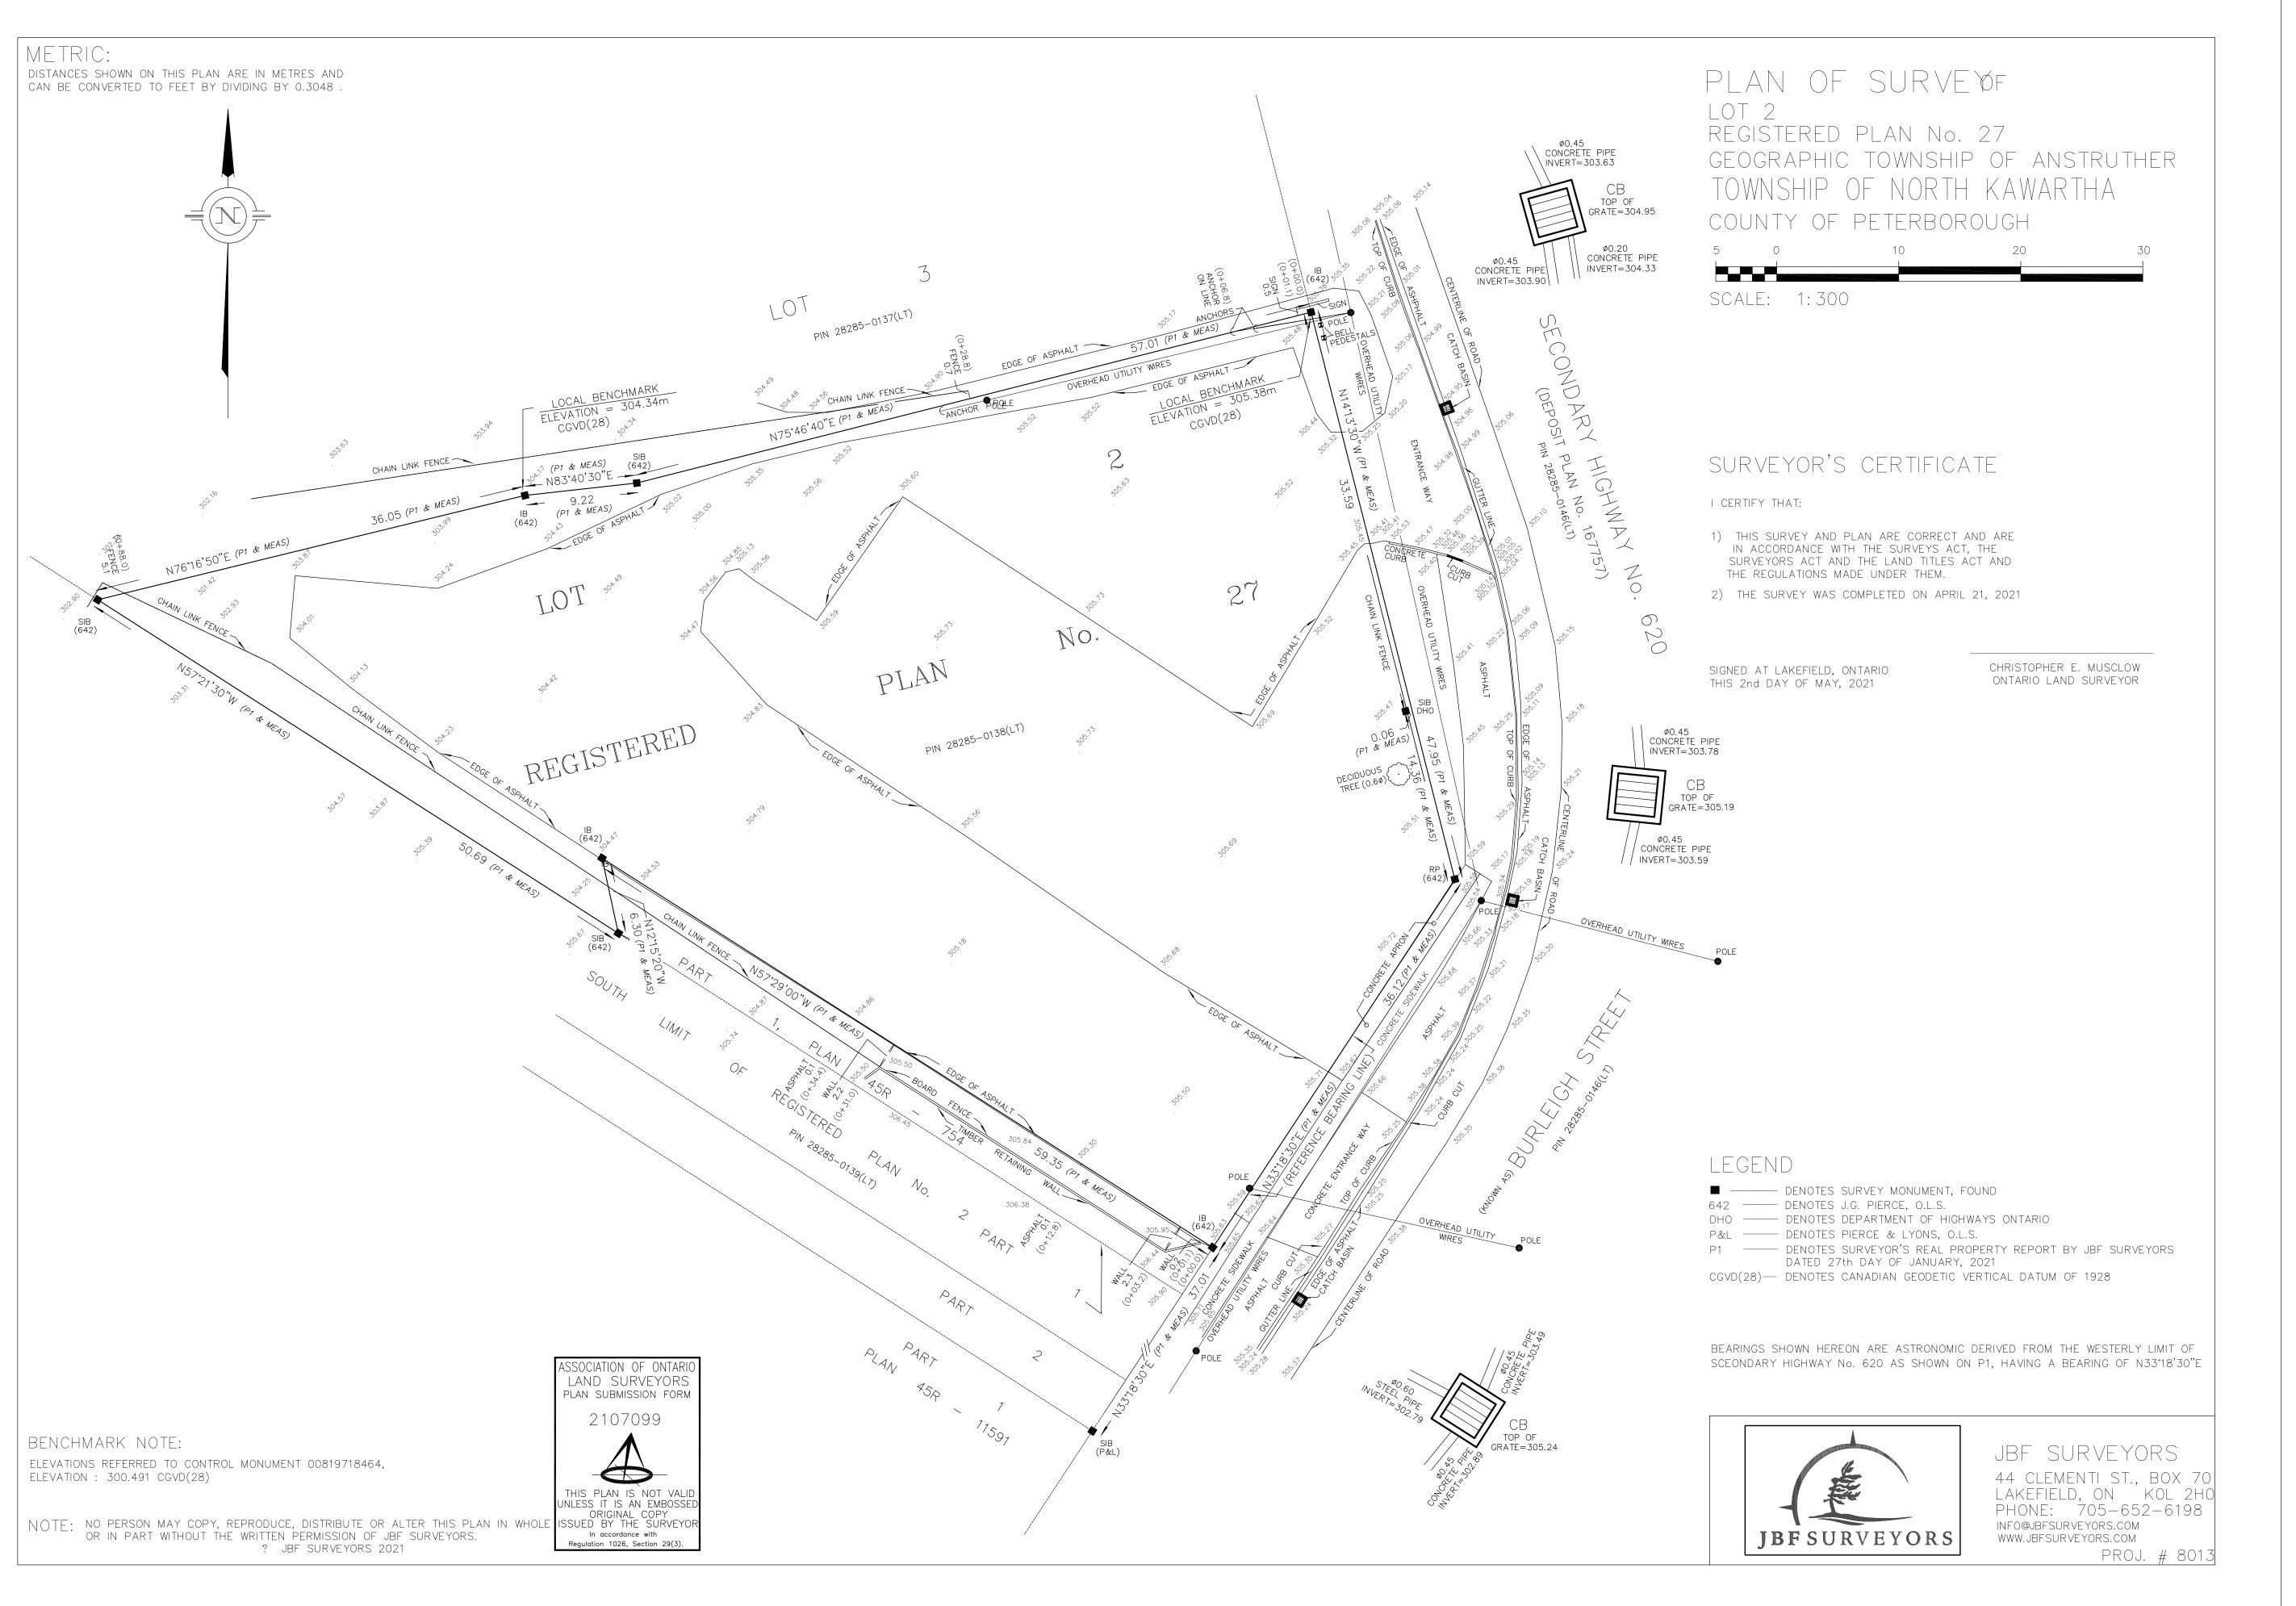

REVISIONS AND ISSUES

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REV	DESCRIPTION	DATE	E
1	ISSUED FOR SPA	210618	Д
2	REVISED SPA	210709	Δ
3	ISSUED FOR COSTING	210721	Д
4	REVISED SPA	210809	Δ
5	ISSUED FOR TENDER	210824	Д
6	REVISED TENDER	220124	Д
7	_	_	_

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229 BROADWAY, UNIT 1
ORANGEVILLE, ONTARIO, L9W 1K4
TEL 519 941 0330 FAX 519 941 1830

BLACKWELL STRUCTURAL ENGINEERS

134 PETER STREET, SUITE 1301 TORONTO, ONTARIO, M5V 2H2 TEL 416.593.5300 FAX 416.593.4840

SMITH + ANDERSON

MECHANICAL AND ELECTRICAL ENGINEERS

1100 - 100 SHEPPARD AVENUE EAST
TORONTO, ONTARIO, M2N 6N5
TEL 416.487.8151 -

SAYERS FOOD LIMITED

132 BURLEIGH STREET t: 705.656.4531 e: sayers@apsley.ca

N

PROJECT TITLE

NEW SAYERS FOOD STORE
BURLEIGH STREET, APSLEY

DRAWING TITLE


SITE SURVEY

NTS

JANUARY 24, 2022

PROJECT NUMBER 2102

DRAWING NUMBER

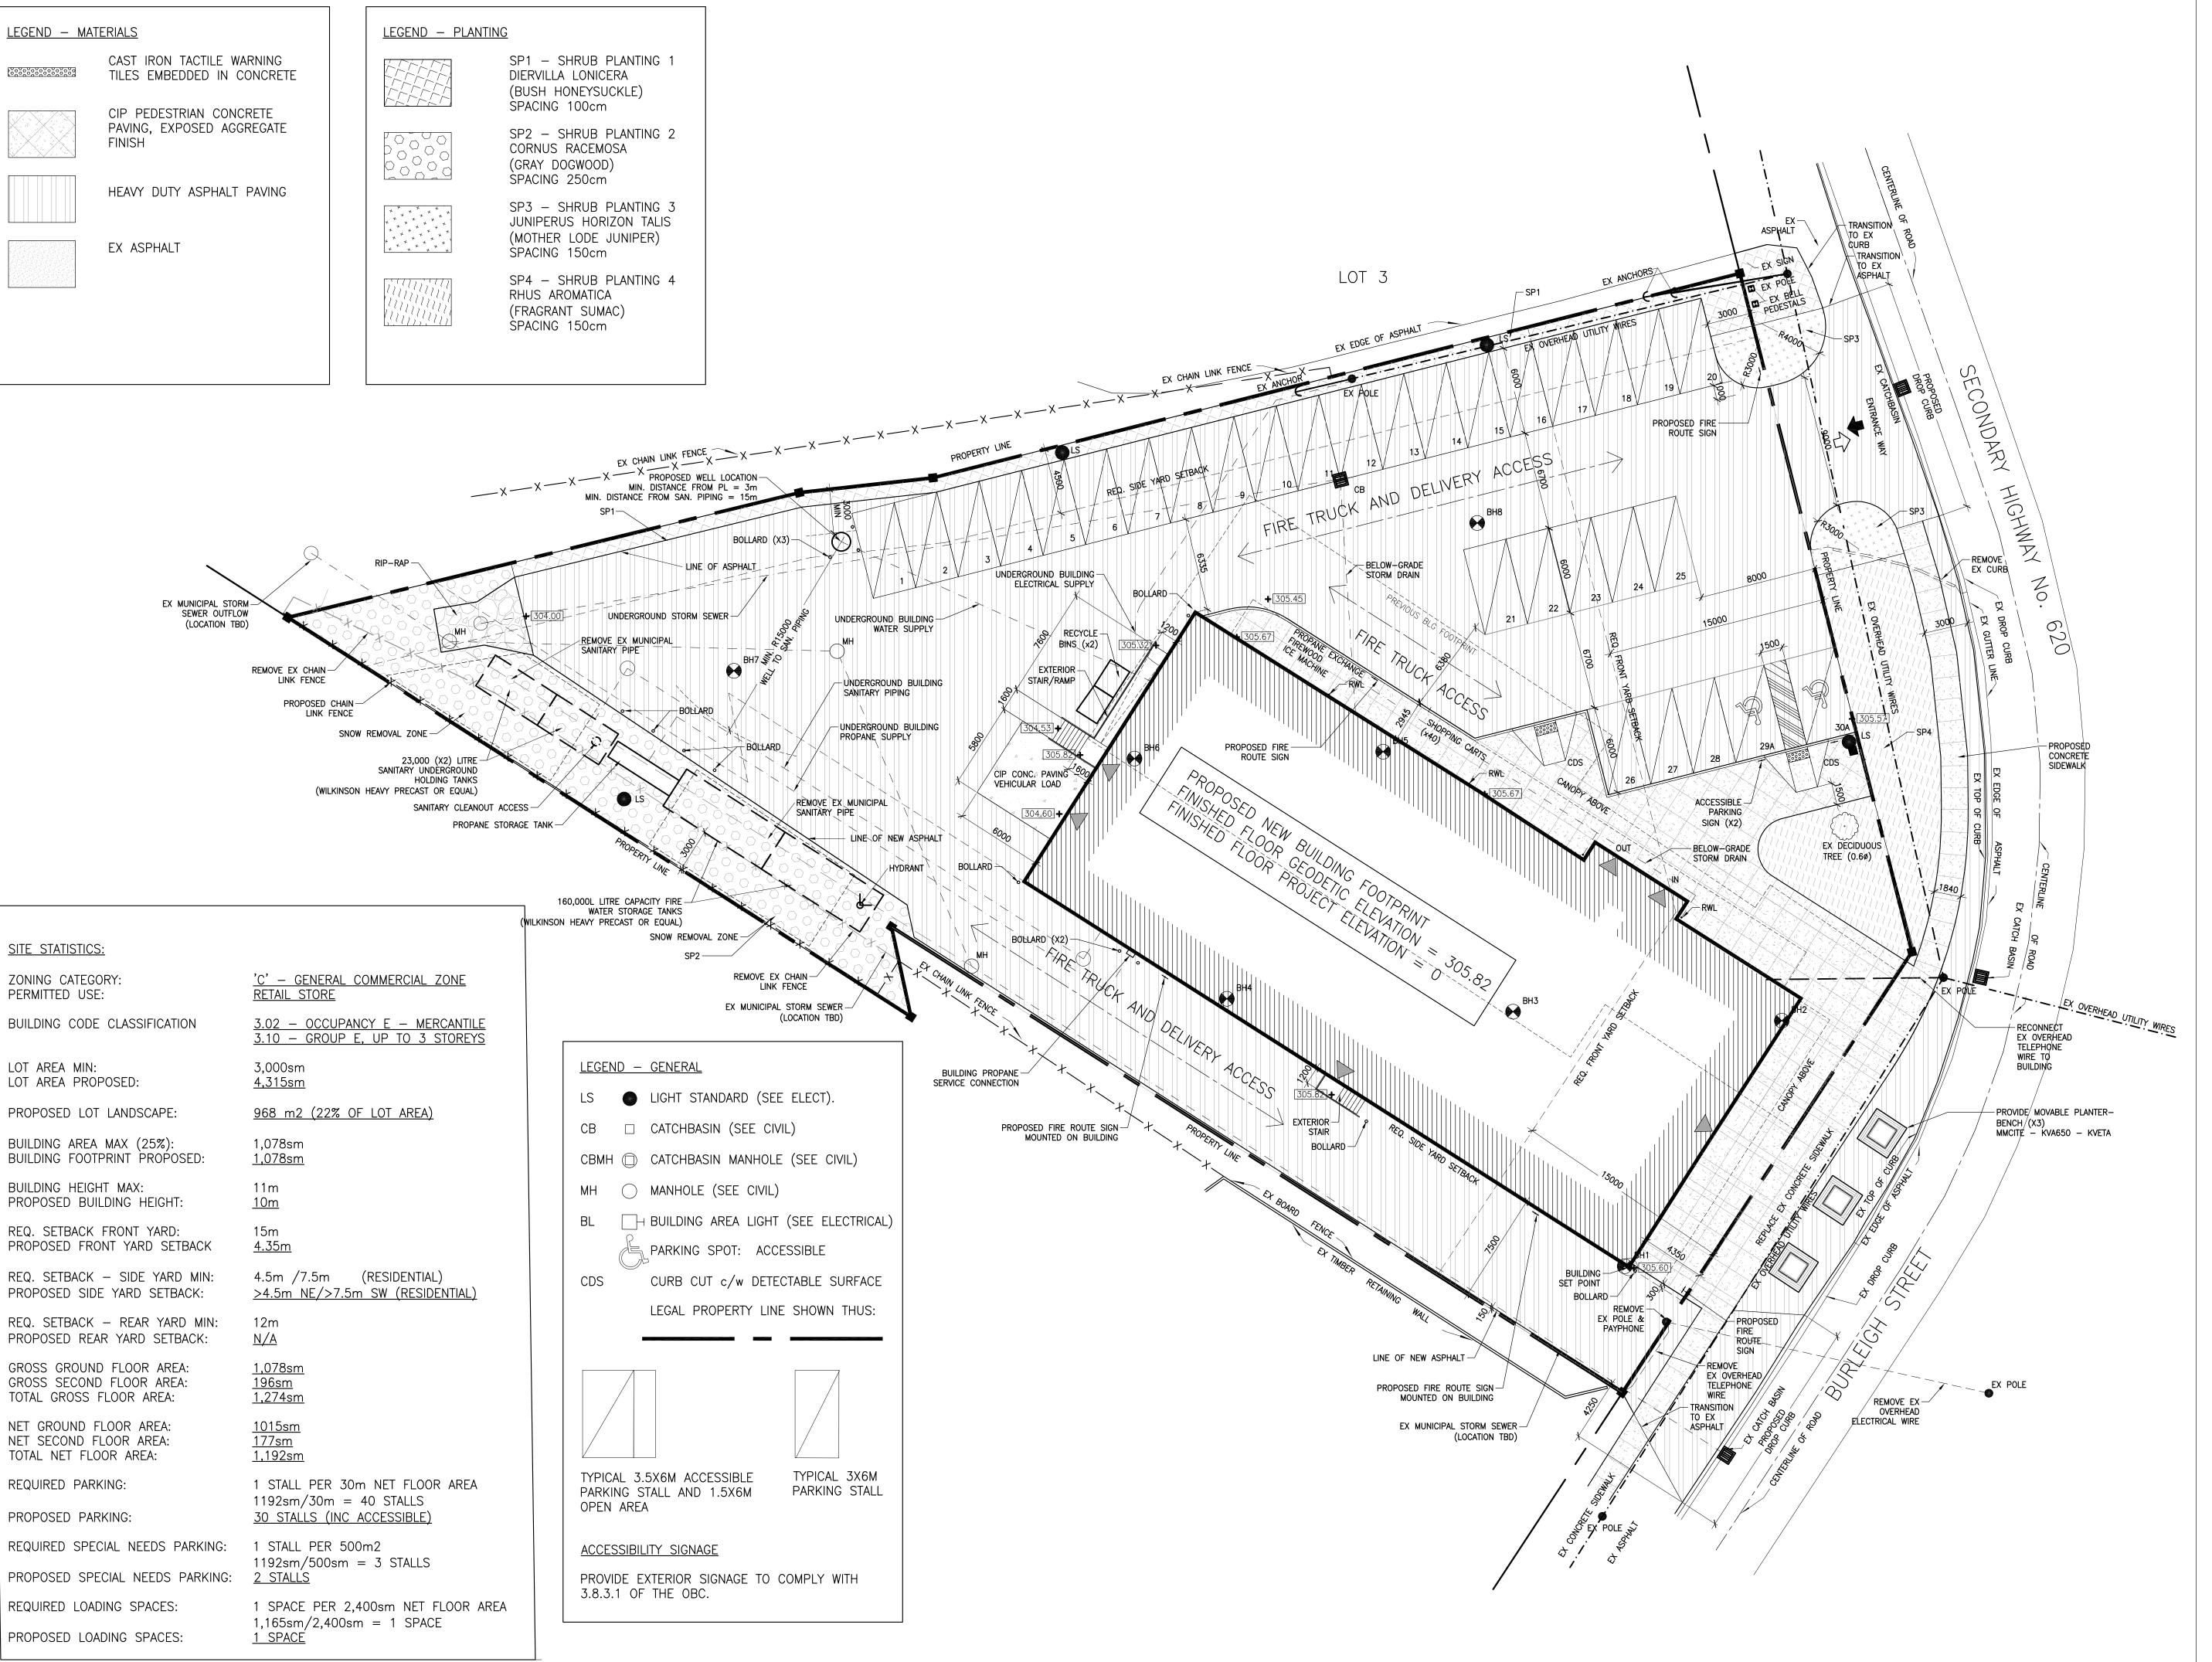

REVISIONS AND ISSUES

1	ISSUED FOR SPA	210618	AB
2	REVISED SPA	210709	AB
3	REVISED SPA	210809	AB
4	ISSUED FOR TENDER	210824	AB
5	ISSUED FOR BUILDING PERMIT	210909	AB
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CIVIL ENGINEERS

229 BROADWAY, UNIT 1
ORANGEVILLE ONTARIO 19W 1K4

ORANGEVILLE, ONTARIO, L9W 1K4
TEL 519 941 0330 FAX 519 941 1830

BLACKWELL STRUCTURAL ENGINEERS

TEL 416.487.8151

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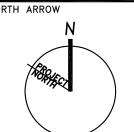
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TORONTO, ONTARIO, M2N 6N5

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PROJECT TITLE

NEW SAYERS FOOD STORE BURLEIGH STREET, APSLEY

DRAWING TITLE

SITE PLAN

CALE


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JANUARY 24, 2022

PROJECT NUMBER 2102

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DRAWING NUMBER



REVISIONS AND ISSUES
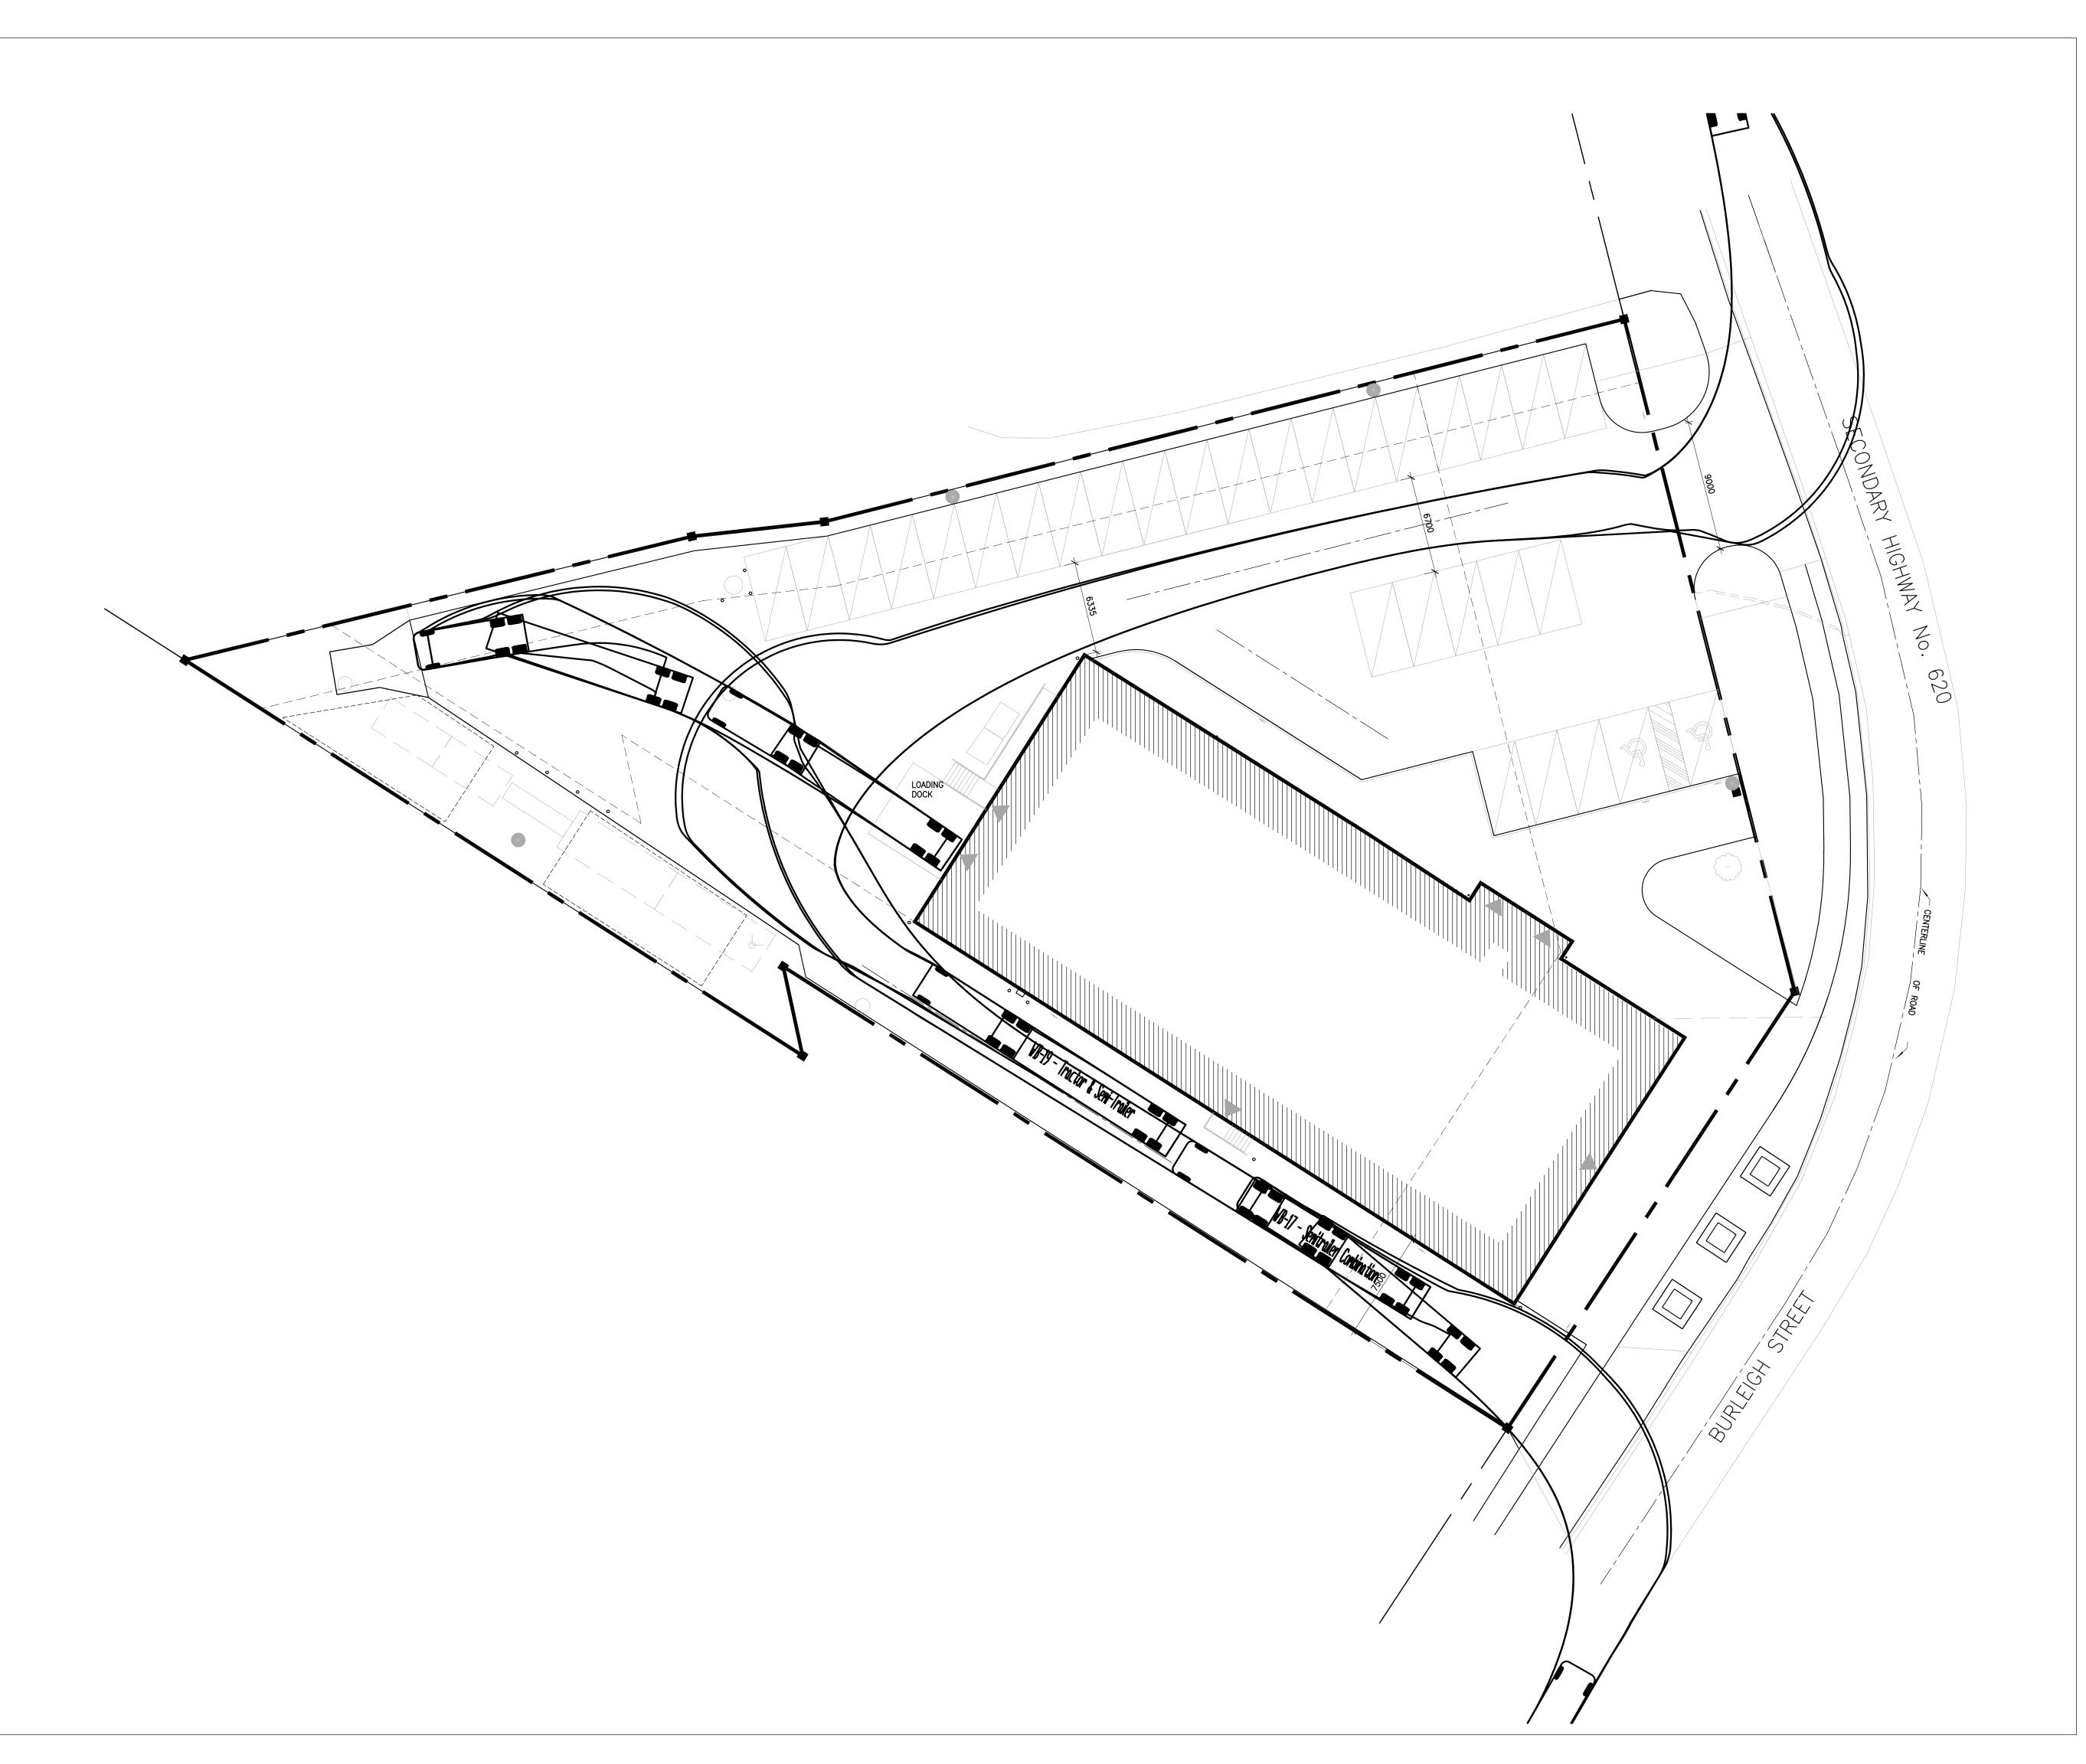
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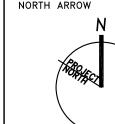
134 PETER STREET, SUITE 1301 TORONTO, ONTARIO, M5V 2H2 TEL 416.593.5300 FAX 416.593.4840


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132 BURLEIGH STREET t: 705.656.4531 e: sayers@apsley.ca





PROJECT TITLE

NEW SAYERS FOOD STORE BURLEIGH STREET, APSLEY

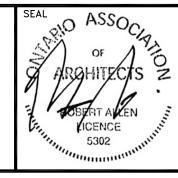DRAWING TITLE

LOADING STUDY PLAN

1:200

JANUARY 24, 2022

PROJECT NUMBER

2102
DRAWING NUMBER



REVISIONS	AND ISSUES		
REV	DESCRIPTION	DATE	В
1	ISSUED FOR SPA	210618	AE
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229 BROADWAY, UNIT 1
ORANGEVILLE, ONTARIO, L9W 1K4
TEL 519 941 0330 FAX 519 941 1830

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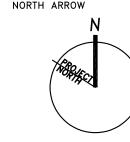
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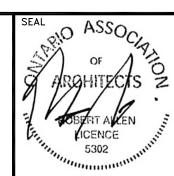
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PROJECT TITLE

NEW SAYERS FOOD STORE BURLEIGH STREET, APSLEY

DRAWING TITLE

EX FOUNDATION REMOVAL
SITE PLAN
scale


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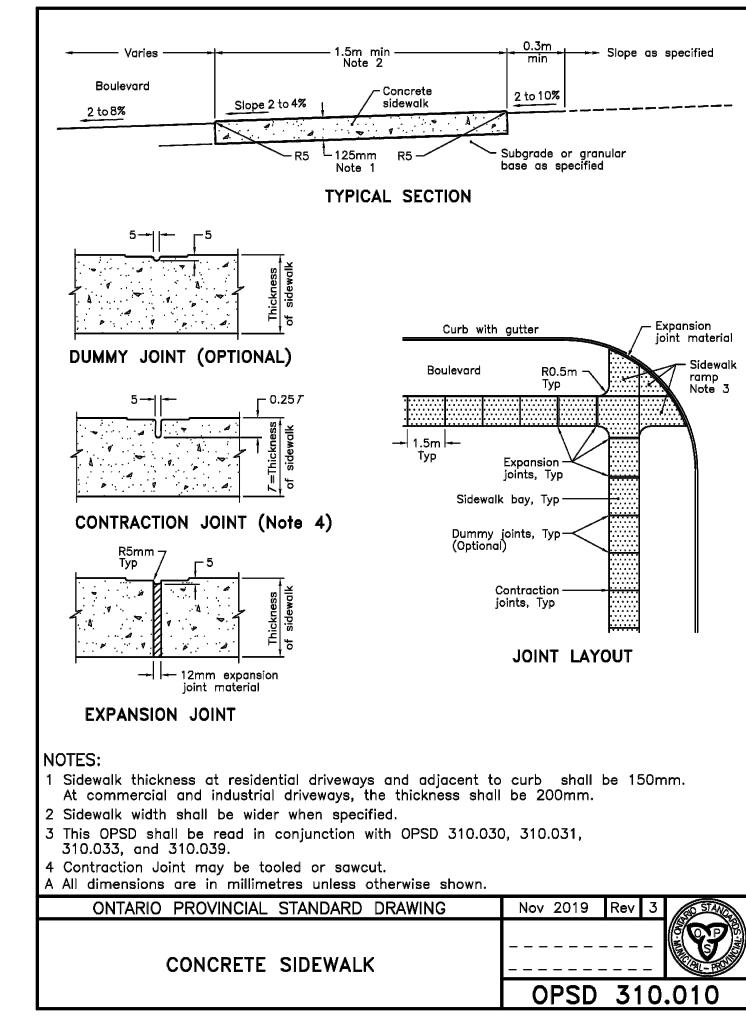
JANUARY 24, 2022

PROJECT NUMBER
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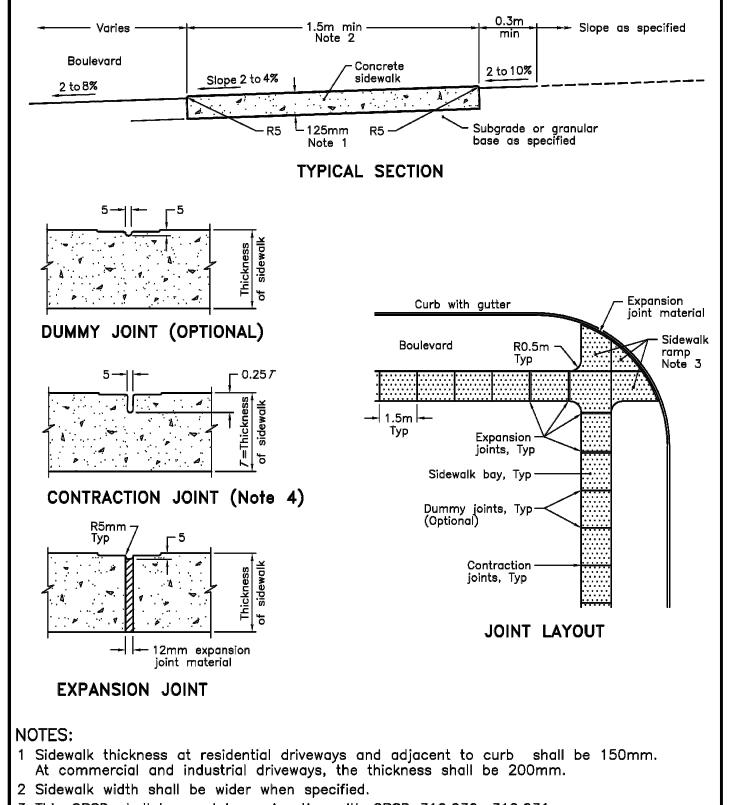
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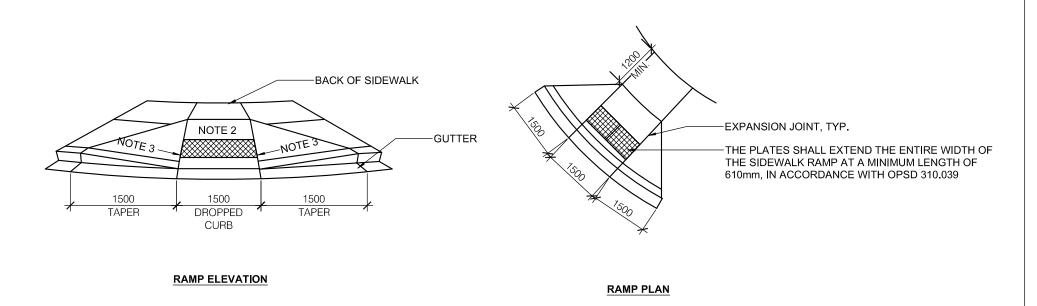





CONCRETE SIDEWALK

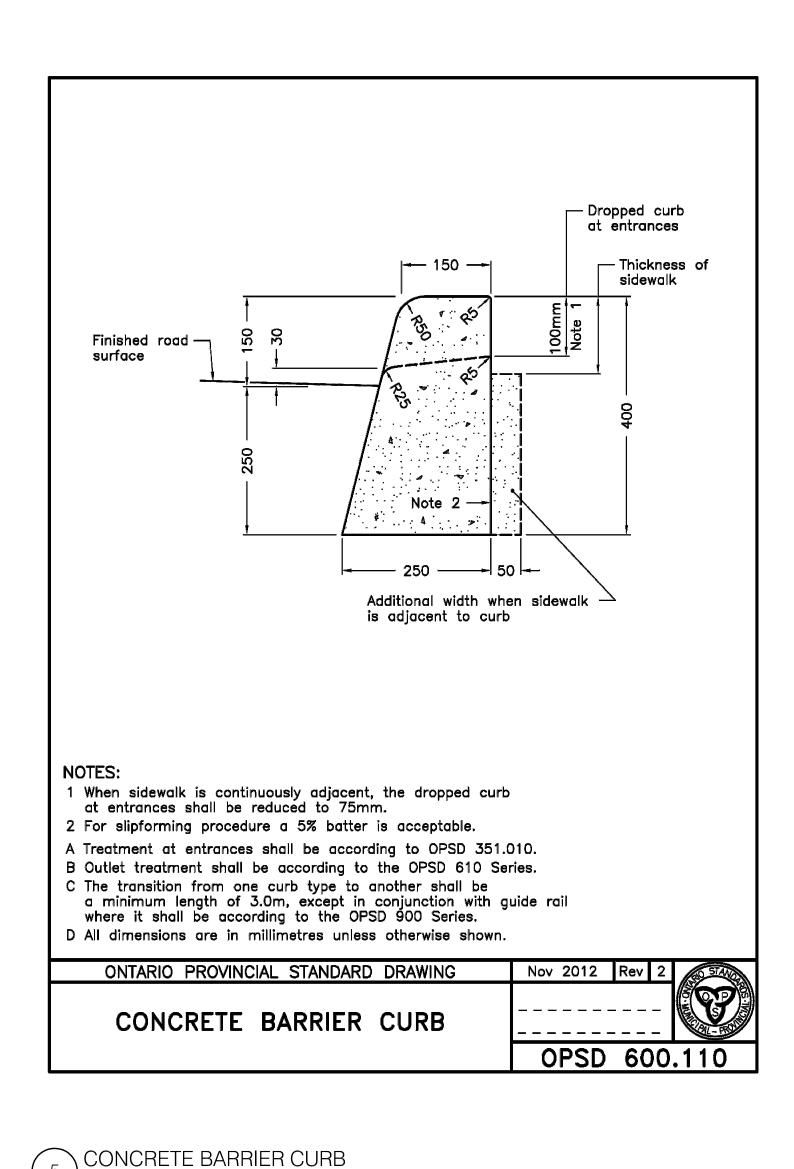

1. SLOPE OF RAMP SHALL NOT EXCEED 8%.
2. CROSS SLOPE OF RAMP SHALL NOT EXCEED 2% IN EITHER DIRECTION.
3. CROSS SLOPE OF FLARED SIDE OF RAMP SHALL NOT EXCEED 10%.
4. DROPPED CURB TO SEE BAMP SHALL BOOMER TO ELIMINATE 30mm STEP AT GUTTER LINE. 5. MINIMUM THICKNESS OF RAMP IS 200mm. MINIMUM THICKNESS OF SIDEWALK AND FLARE SIDES ADJACENT TO RAMP IS 150mm.




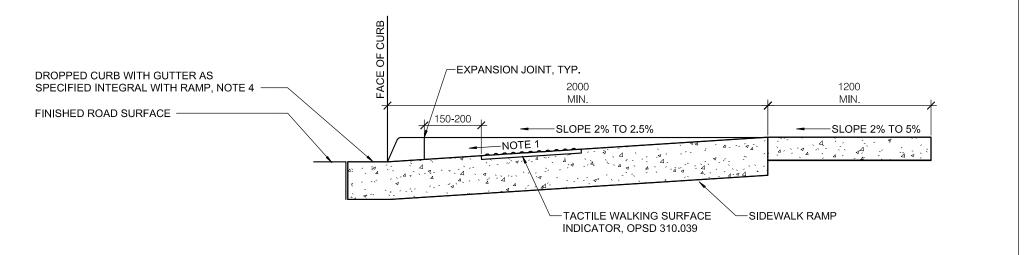

RAMP SECTION

CONCRETE SIDEWALK RAMP

1. CONCRETE PAVING BASE TO BE PROVIDED SLOPE TOWARD SUBDRAIN; REFER TO CIVIL DRAWINGS FOR GRADING AND SUBDRAIN DETAILS.

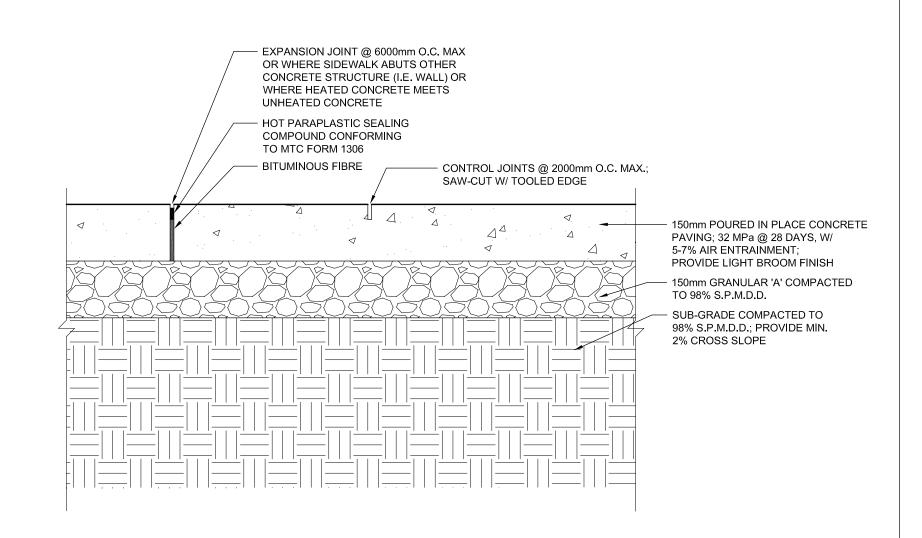

CIP CONCRETE PAVING

Contractor must check and verify all dimensions on the job, and report any discrepancies to the Architect before proceeding with the work. Do not scale this drawing.

REVISIONS AND ISSUES DESCRIPTION DATE ISSUED FOR SPA 210618 REVISED SPA 210709 REVISED SPA 210809 ISSUED FOR TENDER 210824 ISSUED FOR BUILDING PERMIT 210909 REVISED TENDER 220124

maclennan jaunkalns miller architects

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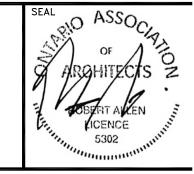
SMITH + ANDERSON MECHANICAL AND ELECTRICAL ENGINEERS 1100 - 100 SHEPPARD AVENUE EAST

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TEL 416.487.8151 -

SAYERS FOOD LIMITED 132 BURLEIGH STREET

t: 705.656.4531 e: sayers@apsley.ca



PROJECT TITLE

NEW SAYERS FOOD STORE BURLEIGH STREET, APSLEY

DRAWING TITLE

SITE PLAN DETAILS 1

SCALE AS NOTED


JANUARY 24, 2022

PROJECT NUMBER


2102 DRAWING NUMBER

1. THE SHAPE, COLOUR, HEIGHT AND LOCATION OF SIGNS SHALL BE IN ACCORDANCE WITH THE ONTARIO TRAFFIC MANUAL AS PUBLISHED BY THE

MINISTRY OF TRANSPORTATION. 2. ALL SIGNS SHALL BE MANUFACTURED USING "HIGH INTENSITY" SHEETING CONFORMING TO ASTM D4956-90 TYPE III OR TYPE IV MATERIAL. 3. CONTRACTOR TO SUBMIT DETAILED SHOP DRAWINGS WITH LICENSED ENGINEER'S STAMP FOR REVIEW AND APPROVAL.

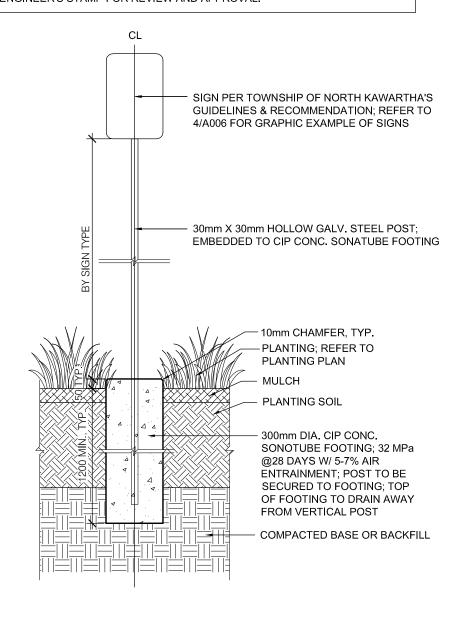

1. THE SHAPE, COLOUR, HEIGHT AND LOCATION OF SIGNS SHALL BE IN ACCORDANCE WITH THE ONTARIO TRAFFIC MANUAL AS PUBLISHED BY THE MINISTRY OF TRANSPORTATION. 2. ALL SIGNS SHALL BE MANUFACTURED USING "HIGH INTENSITY" SHEETING CONFORMING TO ASTM D4956-90 TYPE III OR TYPE IV MATERIAL. 3. CONTRACTOR TO SUBMIT DETAILED SHOP DRAWINGS WITH LICENSED

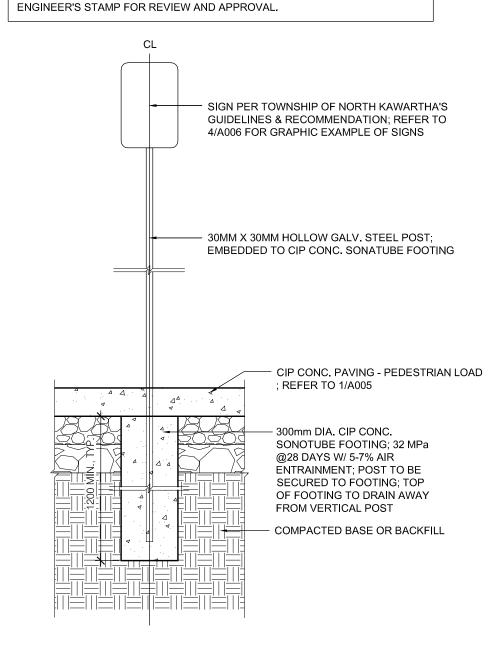



ROUTE


ACCESSIBLE ROUTE PARKING 1200mm MOUNT HT 2200mm MOUNT HT

SIGN POST AT PLANTING BEDS


SIGN POST AT CIP CONCRETE PAVING

GRAPHIC EXAMPLES OF SIGNS


1. BOLLARD - MANUFACTURER: RELIANCE FOUNDRY - MODEL: 'R-7307-EX' - FINISH: ANODIZED SILVER - MOUNTING: EMBEDDED; FILLED WITH CONC. - INSTALLATION: SET SCREW - ADD REFLECTIVE STRIP: COLOUR TO BE WHITE 2. CONTRACTOR TO SUBMIT DETAILED SHOP DRAWINGS WITH LICENSED ENGINEER'S STAMP FOR REVIEW AND APPROVAL.

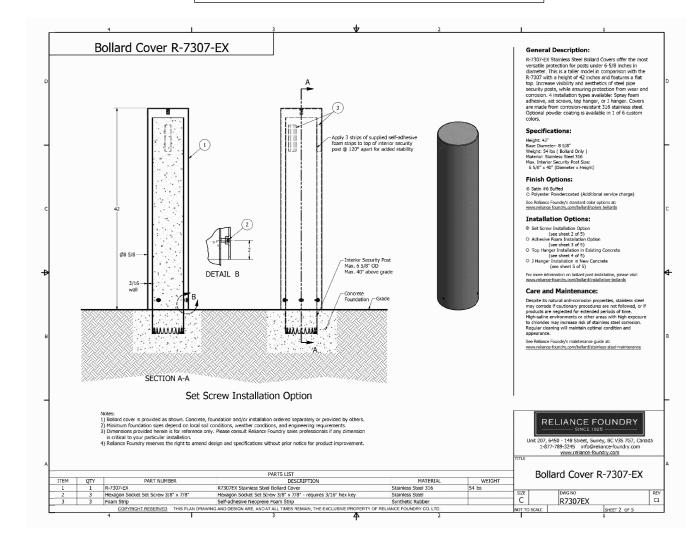

1. CONTRACTOR TO SUBMIT DETAILED SHOP DRAWINGS WITH LICENSED ENGINEER'S STAMP FOR REVIEW AND APPROVAL.

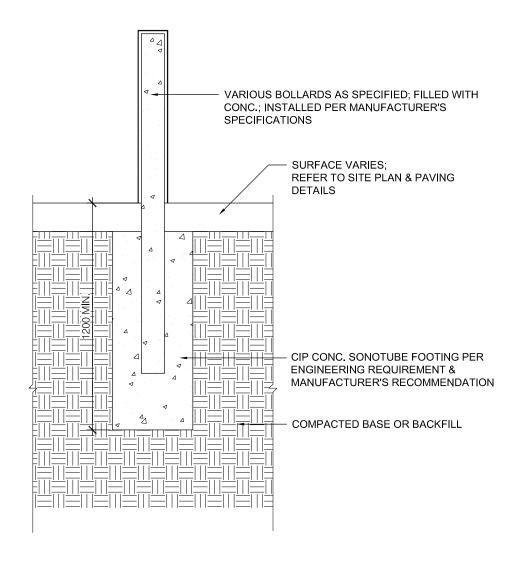

1. TACTILE PLATE
- MANUFACTURER: KINESIK - MODEL: 'ADVANTAGE CAST IRON' - COLOUR: DARK GRAY 2. TO BE INSTALLED PER MANUFACTURER'S SPECIFICATIONS. 3. CONTRACTOR TO SUBMIT DETAILED SHOP DRAWINGS WITH LICENSED ENGINEER'S STAMP FOR REVIEW AND APPROVAL.

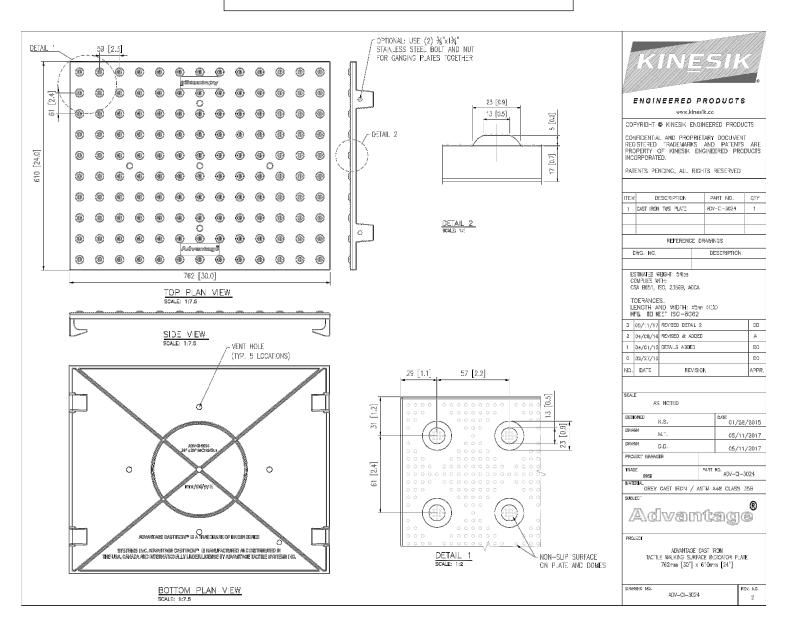

Contractor must check and verify all dimensions on the job, and report any discrepancies to the Architect before proceeding with the work. Do not scale this drawing.

REV	DESCRIPTION	DATE	B,
1	ISSUED FOR SPA	210618	AE
2	REVISED SPA	210709	AE
3	REVISED SPA	210809	AE
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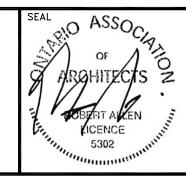
134 PETER STREET, SUITE 1301 TORONTO, ONTARIO, M5V 2H2 TEL 416.593.5300 FAX 416.593.4840

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1100 - 100 SHEPPARD AVENUE EAST TORONTO, ONTARIO, M2N 6N5 TEL 416.487.8151 -

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PROJECT TITLE

NEW SAYERS FOOD STORE BURLEIGH STREET, APSLEY

DRAWING TITLE

SITE PLAN DETAILS 2


AS NOTED


JANUARY 24, 2022

PROJECT NUMBER 2102


DRAWING NUMBER

1.CONTRACTOR TO VERIFY DIMENSIONS ON SITE. 2. CONTRACTOR TO SUBMIT SHOP DRAWINGS FOR APPROVAL BY LANDSCAPE ARCHITECT PRIOR TO FABRICATION. 3. ALL POSTS AND RAILS SHALL BE GALVANIZED STEEL PIPE 'STANDARD WEIGHT', AND CONFORMING TO CURRENT SPECIFICATIONS DOE HOT DIPPED ZINC COATED (GALVANIZED) WELDED AND SEAMLESS PIPE FOR 4. ALL FENCE COMPONENTS TO BE OF A SUITABLE ALUMINUM ALLY OR OF A STEEL DUCTILE IRON. 5. LINE POSTS SHALL BE SET AT 3.0m CENTRES. 6. BOTTOM RAIL AND FINISHED GRADE 38-75mm CLEARANCE MAX.

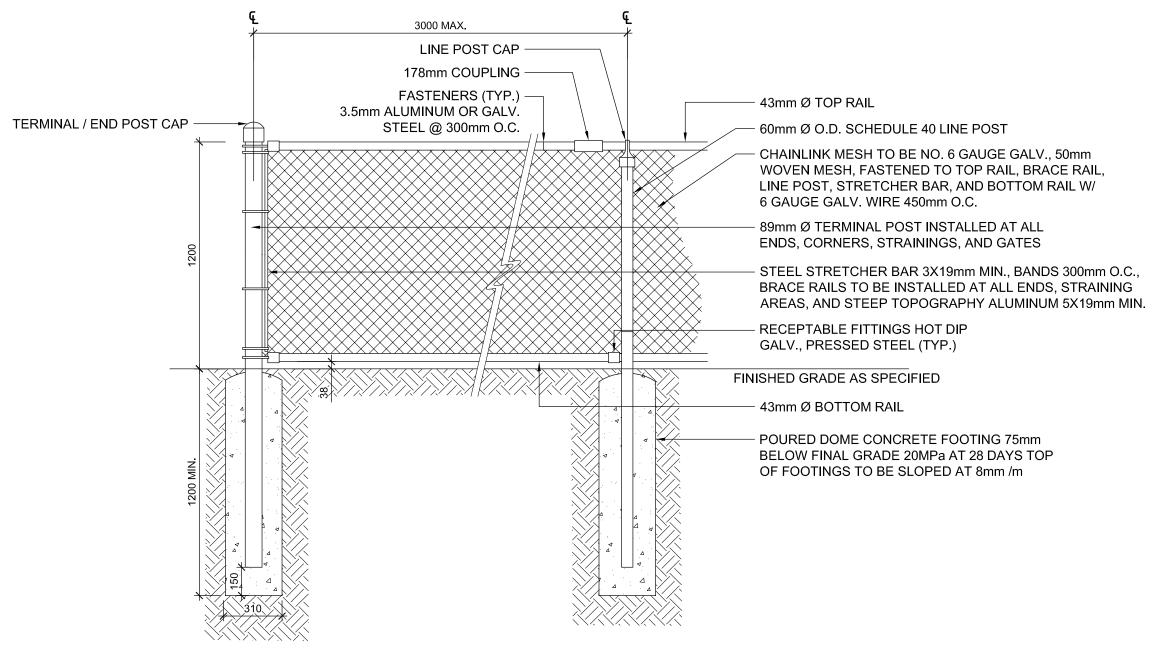

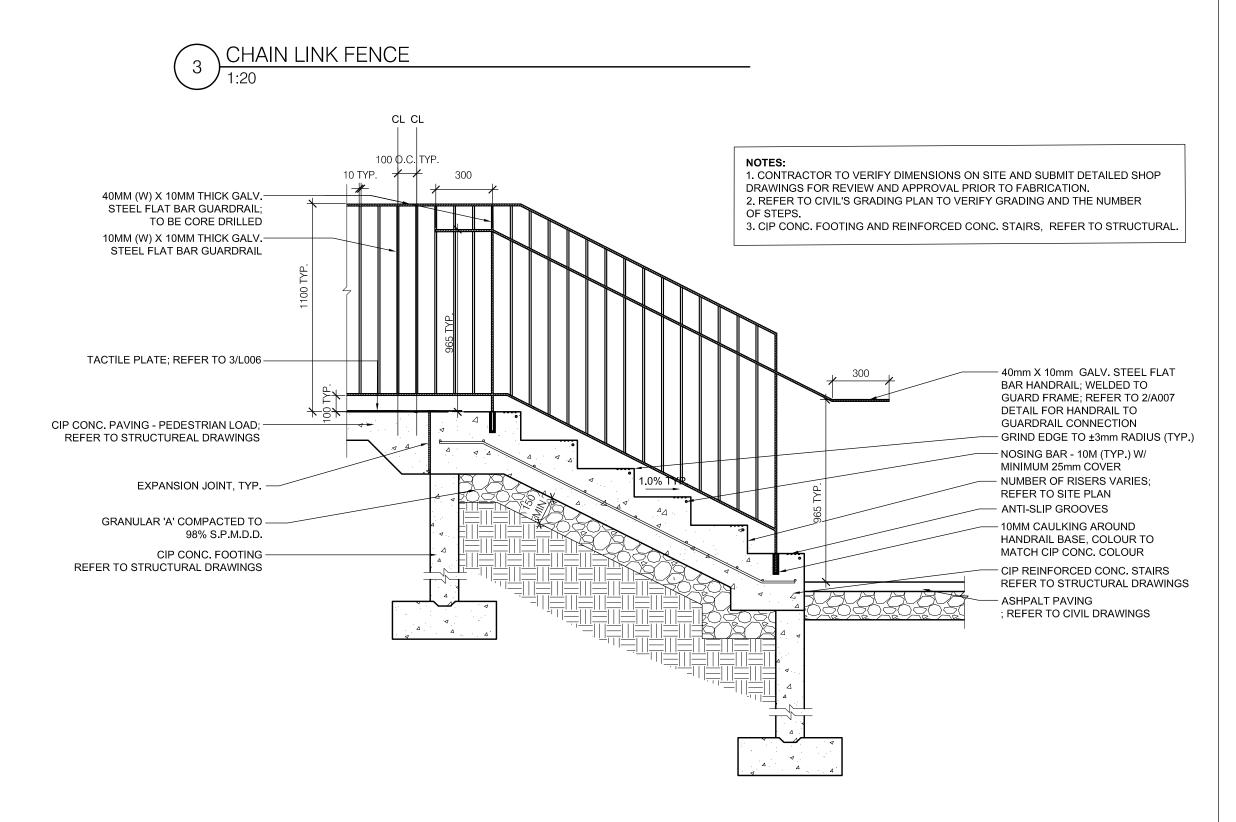

CIP CONCRETE STEPS/ GUARDRAIL/ HANDRAIL

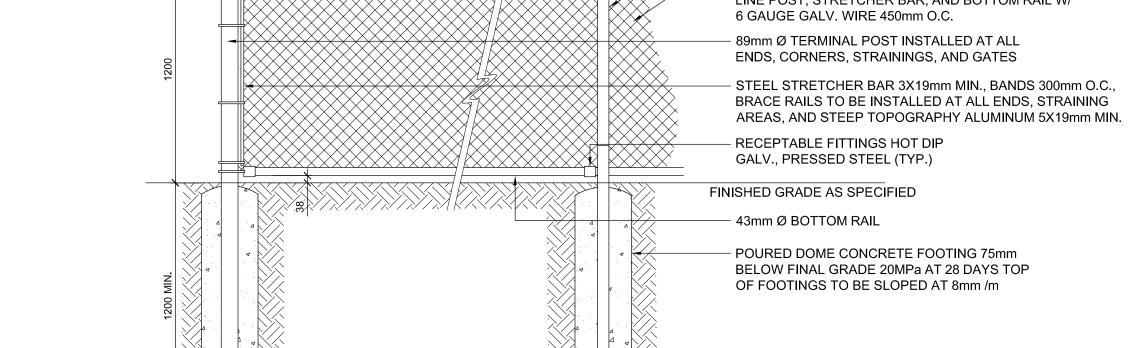

SAYERS FOOD LIMITED

Contractor must check and verify all dimensions on the job, and report any discrepancies to the Architect before proceeding with the work.

DATE

210618

210709

210809

210824

220124

Do not scale this drawing.

REVISIONS AND ISSUES

DESCRIPTION

ISSUED FOR SPA

REVISED SPA

REVISED SPA

ISSUED FOR TENDER

REVISED TENDER

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TRITON ENGINEERING SERVICES LTD

425 adelaide street west level 6

toronto ontario m5v 3c1

www.mjmarchitects.com

416 593 6796

CIVIL ENGINEERS

BLACKWELL

229 BROADWAY, UNIT 1

STRUCTURAL ENGINEERS

ORANGEVILLE, ONTARIO, L9W 1K4

134 PETER STREET, SUITE 1301

TORONTO, ONTARIO, M5V 2H2

SMITH + ANDERSON

TEL 519 941 0330 FAX 519 941 1830

TEL 416.593.5300 FAX 416.593.4840

MECHANICAL AND ELECTRICAL ENGINEERS

1100 - 100 SHEPPARD AVENUE EAST TORONTO, ONTARIO, M2N 6N5 TEL 416.487.8151 -

ISSUED FOR BUILDING PERMIT 210909

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PROJECT TITLE

NEW SAYERS FOOD STORE BURLEIGH STREET, APSLEY

DRAWING TITLE


SITE PLAN DETAILS 3

AS NOTED

JANUARY 24, 2022

PROJECT NUMBER

DRAWING NUMBER

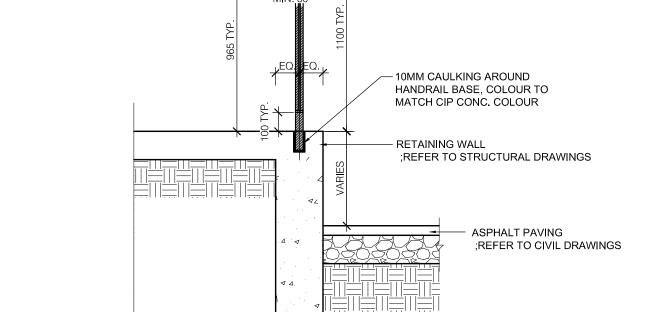

SECTION

40mm X 10mm GALV. STEEL FLAT BAR —

10mm X 10mm GALV. STEEL FLAT BAR -


HANDRAIL; WELDED TO GUARD FRAME

40MM (W) X 10MM THICK GALV.

STEEL FLAT BAR GUARDRAIL;

STEEL FLAT BAR GUARDRAIL

TO BE CORE DRILLED 10MM (W) X 10MM THICK GALV.

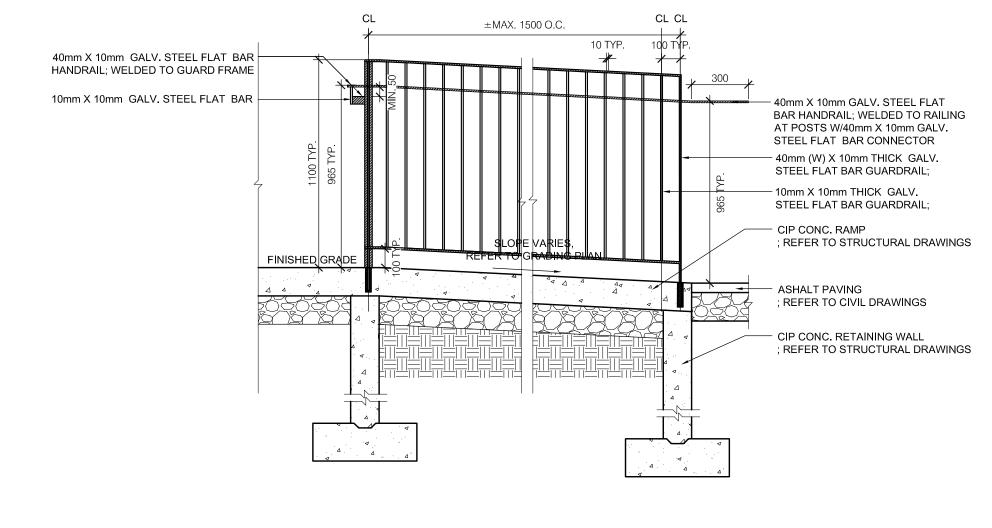

1. CONTRACTOR TO VERIFY DIMENSIONS ON SITE AND SUBMIT DETAILED SHOP DRAWINGS WITH LICENSED ENGINEER'S STAMP FOR REVIEW AND APPROVAL BEFORE FABRICATION.

2. ALL FASTENERS TO BE GALVANIZED AND NON-CORROSIVE.. 3. WELD ALL JOINTS TO CREATE A RIGID SECURE STRUCTURE.

5. REFER TO CIVIL'S GRADING PLAN TO VERIFY GRADING.


7. REFER TO SITE PLAN FOR EXTENT OF GUARDRAIL.

4. ALL WELDS GROUND SMOOTH AND NO WELDS OR SEAMS TO SHOW.


6. CIP CONC. FOOTING, RAMP AND RETAINING WALL REFER TO STRUCTURAL.

ELEVATION

CIP CONCRETE RAMP/ GUARDRAIL/ HANDRAIL

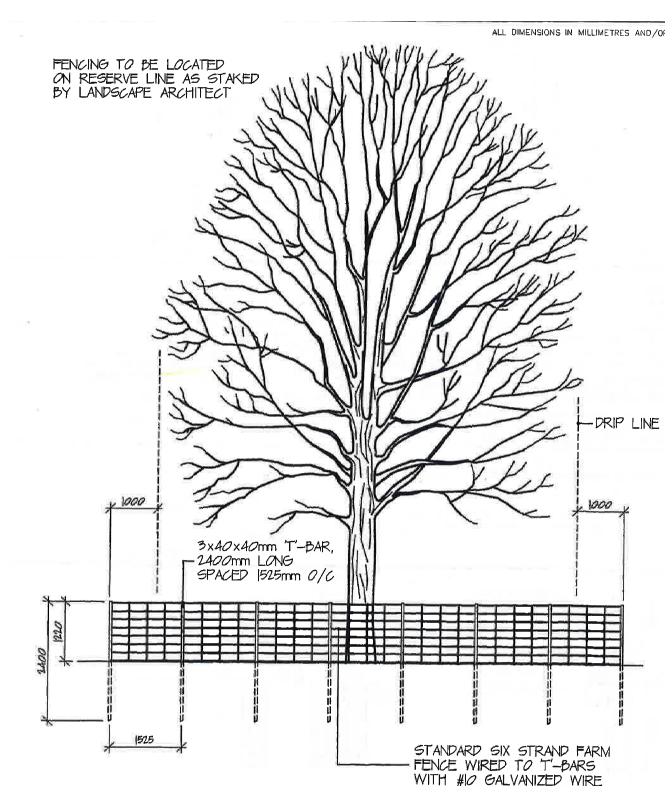

TREE PRESERVATION PROTECTION FENCE

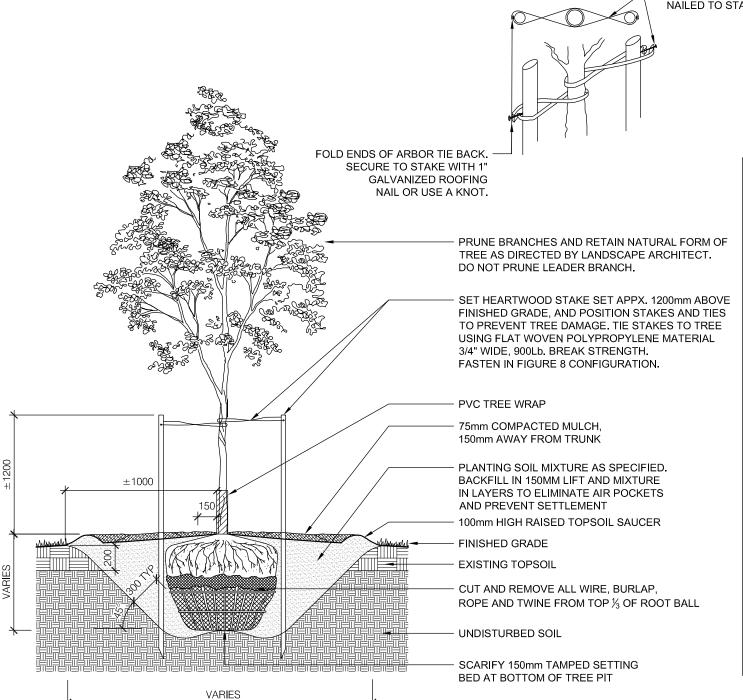

GENERAL NOTES:

1. OBTAIN WRITTEN CONFIRMATION OF UTILITY LOCATES PRIOR TO COMMENCEMENT OF DIGGING.

DIG ALL HOLES BY HAND WHEN CLOSER THAN 1000mm TO UNDERGROUND POWER, TELEPHONE AND GAS ALIGNMENTS. USE ROOT DEFLECTOR ON THE UTILITY SIDE IF REQUIRED. ENSURE BASE OF TREE PIT IS STABLE IN ORDER TO MAINTAIN THE DESIRED TREE LEVEL AND GRADE. TREES TO BE SPRAYED WITH APPROVED ANTI-DESSICANT PRIOR

TO TRANSPLANTING UNLESS PLANTED WITHIN 48 HOURS OF DIGGING (IF PLANTED IN FULL LEAF). SET TREE 50mm HIGHER THAN SURROUNDING GRADE TO ALLOW

FOR SETTLEMENT. SCARIFY COMPACTED SUB-GRADE TO 500mm DEEP IN AREA 5 X ROOTBALL DIAMETER.

DIG PIT 300mm WIDER THAN ROOTBALL PERIMETER. MULCH PER SPECIFICATIONS. 10. REMOVE TREE STAKES AND TREE WRAP AFTER ONE SEASON.

11. PROVIDE SUB-DRAIN CONNECTED TO CB TO PLANTING BEDS LOCATED NORTH OF FIELD HOUSE; REFER TO PLANTING PLAN FOR LOCATIONS AND CIVIL FOR DETAIL (219130-C-STD).

TRUNK PROTECTION NOTES: MECHANICAL INJURY: USE PLASTIC TREE COLLAR.

ANIMAL INJURY: USE SPIRAL TREE GUARDS OR SCREEN SUNSCALD INJURY: PAINT TRUNK WITH WHITE LATEX OR

WHITE-WASH, OR WRAP WITH BURLAP, 'KRAFT WRAP' INSTALLED FROM THE GROUND UP TO ABOVE LOWEST BRANCHES . LAWN MOWER INJURY: USE SPLIT CORRUGATED BRAIN COLLARS

STAKES & TIES NOTES: STAKE BEFORE PLANTING USE ONE ROUNDED WOODEN STAKE, MINIMUM 2000MM LONG, 75MM AVERAGE DRIVEN 300MM INTO SUBSOIL PRIOR TO PLANTING.

TIE USING BIODEGRADABLE MATERIAL SUCH AS FOLDED BURLAP, STAPLED TO STAKE WITH FENCE STAPLES OR ROOFING NAILS. APPLY RODENT PROTECTION WHERE REQUIRED (TREES UNDER

DECIDUOUS TREE PLANTING

Contractor must check and verify all dimensions on the job, and report any discrepancies to the Architect before proceeding with the work. Do not scale this drawing.

REV	DESCRIPTION	DATE	BY
1	ISSUED FOR SPA	210618	AB
2	REVISED SPA	210709	AB
3	REVISED SPA	210809	AB
4	ISSUED FOR TENDER	210824	AB
5	ISSUED FOR BUILDING PERMIT	210909	AB
6	REVISED TENDER	220124	AB
7	-	-	_
8	-	-	_
9	-	-	-
10	-	-	_
11	-	_	_

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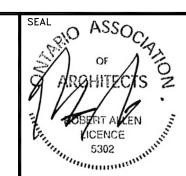
134 PETER STREET, SUITE 1301 TORONTO, ONTARIO, M5V 2H2 TEL 416.593.5300 FAX 416.593.4840

SMITH + ANDERSON MECHANICAL AND ELECTRICAL ENGINEERS

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SAYERS FOOD LIMITED

132 BURLEIGH STREET t: 705.656.4531 e: sayers@apsley.ca



PROJECT TITLE

NEW SAYERS FOOD STORE BURLEIGH STREET, APSLEY

DRAWING TITLE

SITE PLAN DETAILS 4

AS NOTED

JANUARY 24, 2022

PROJECT NUMBER

DRAWING NUMBER

SHRUB PLANTING

ROOT

EXISTING SUB-GRADE

PLANTING BED WIDTH VARIES

450mm MIN. BACK OF

ROOT

2. PREPARATION: EXCAVATE PLANTING BED TO SIZE OUTLINED

SET SHRUB 50mm HIGHER THAN SURROUNDING GRADE TO

. ALL ROOT BALLS REMOVED FROM POTS TO BE SCARIFIED

TRIM AND REMOVE ALL BROKEN, DISEASED, OR WEAK

TRIM BRANCHES AND TWIGS TO RETAIN NATURAL FORM OF SHRUB, DO NOT PRUNE LEADERS.
 PLANTING IN GROUPS SHALL BE SET IN EQUAL O.C. SPACING.

1. APPLY APPROVED WATER SOLUBLE FERTILIZER AT A RATE OF

ENSURE FERTILIZER IS CONTAINED WITHIN SAUCER AND EVENLY RAKED INTO PLANTING SOIL MIXTURE.

ON DRAWINGS. MAINTAIN MINIMUM 450mm DEPTH.

TO COMMENCEMENT OF DIGGING.

ALLOW FOR SETTLEMENT.

PRUNING TO SUIT SPECIES.

SPACING PER A004 SITE PLAN.

FERTILIZER NOTES:

9kg PER 100m².

BRANCHES AND TWIGS.

PRIOR TO SETTING IN GROUND.

75mm COMPACTED MULCH

- PLANTING SOIL MIXTURE AS

SPECIFIED. TAMP SOIL

MIXTURE IN LAYERS TO

PREVENT AIR POCKETS

SCARIFY 150mm TAMPED


SETTING BED AT BOTTOM

- 100mm HIGH RAISED

- CUT CLEAN BED EDGE

TOPSOIL SAUCER

- EXISTING TOPSOIL

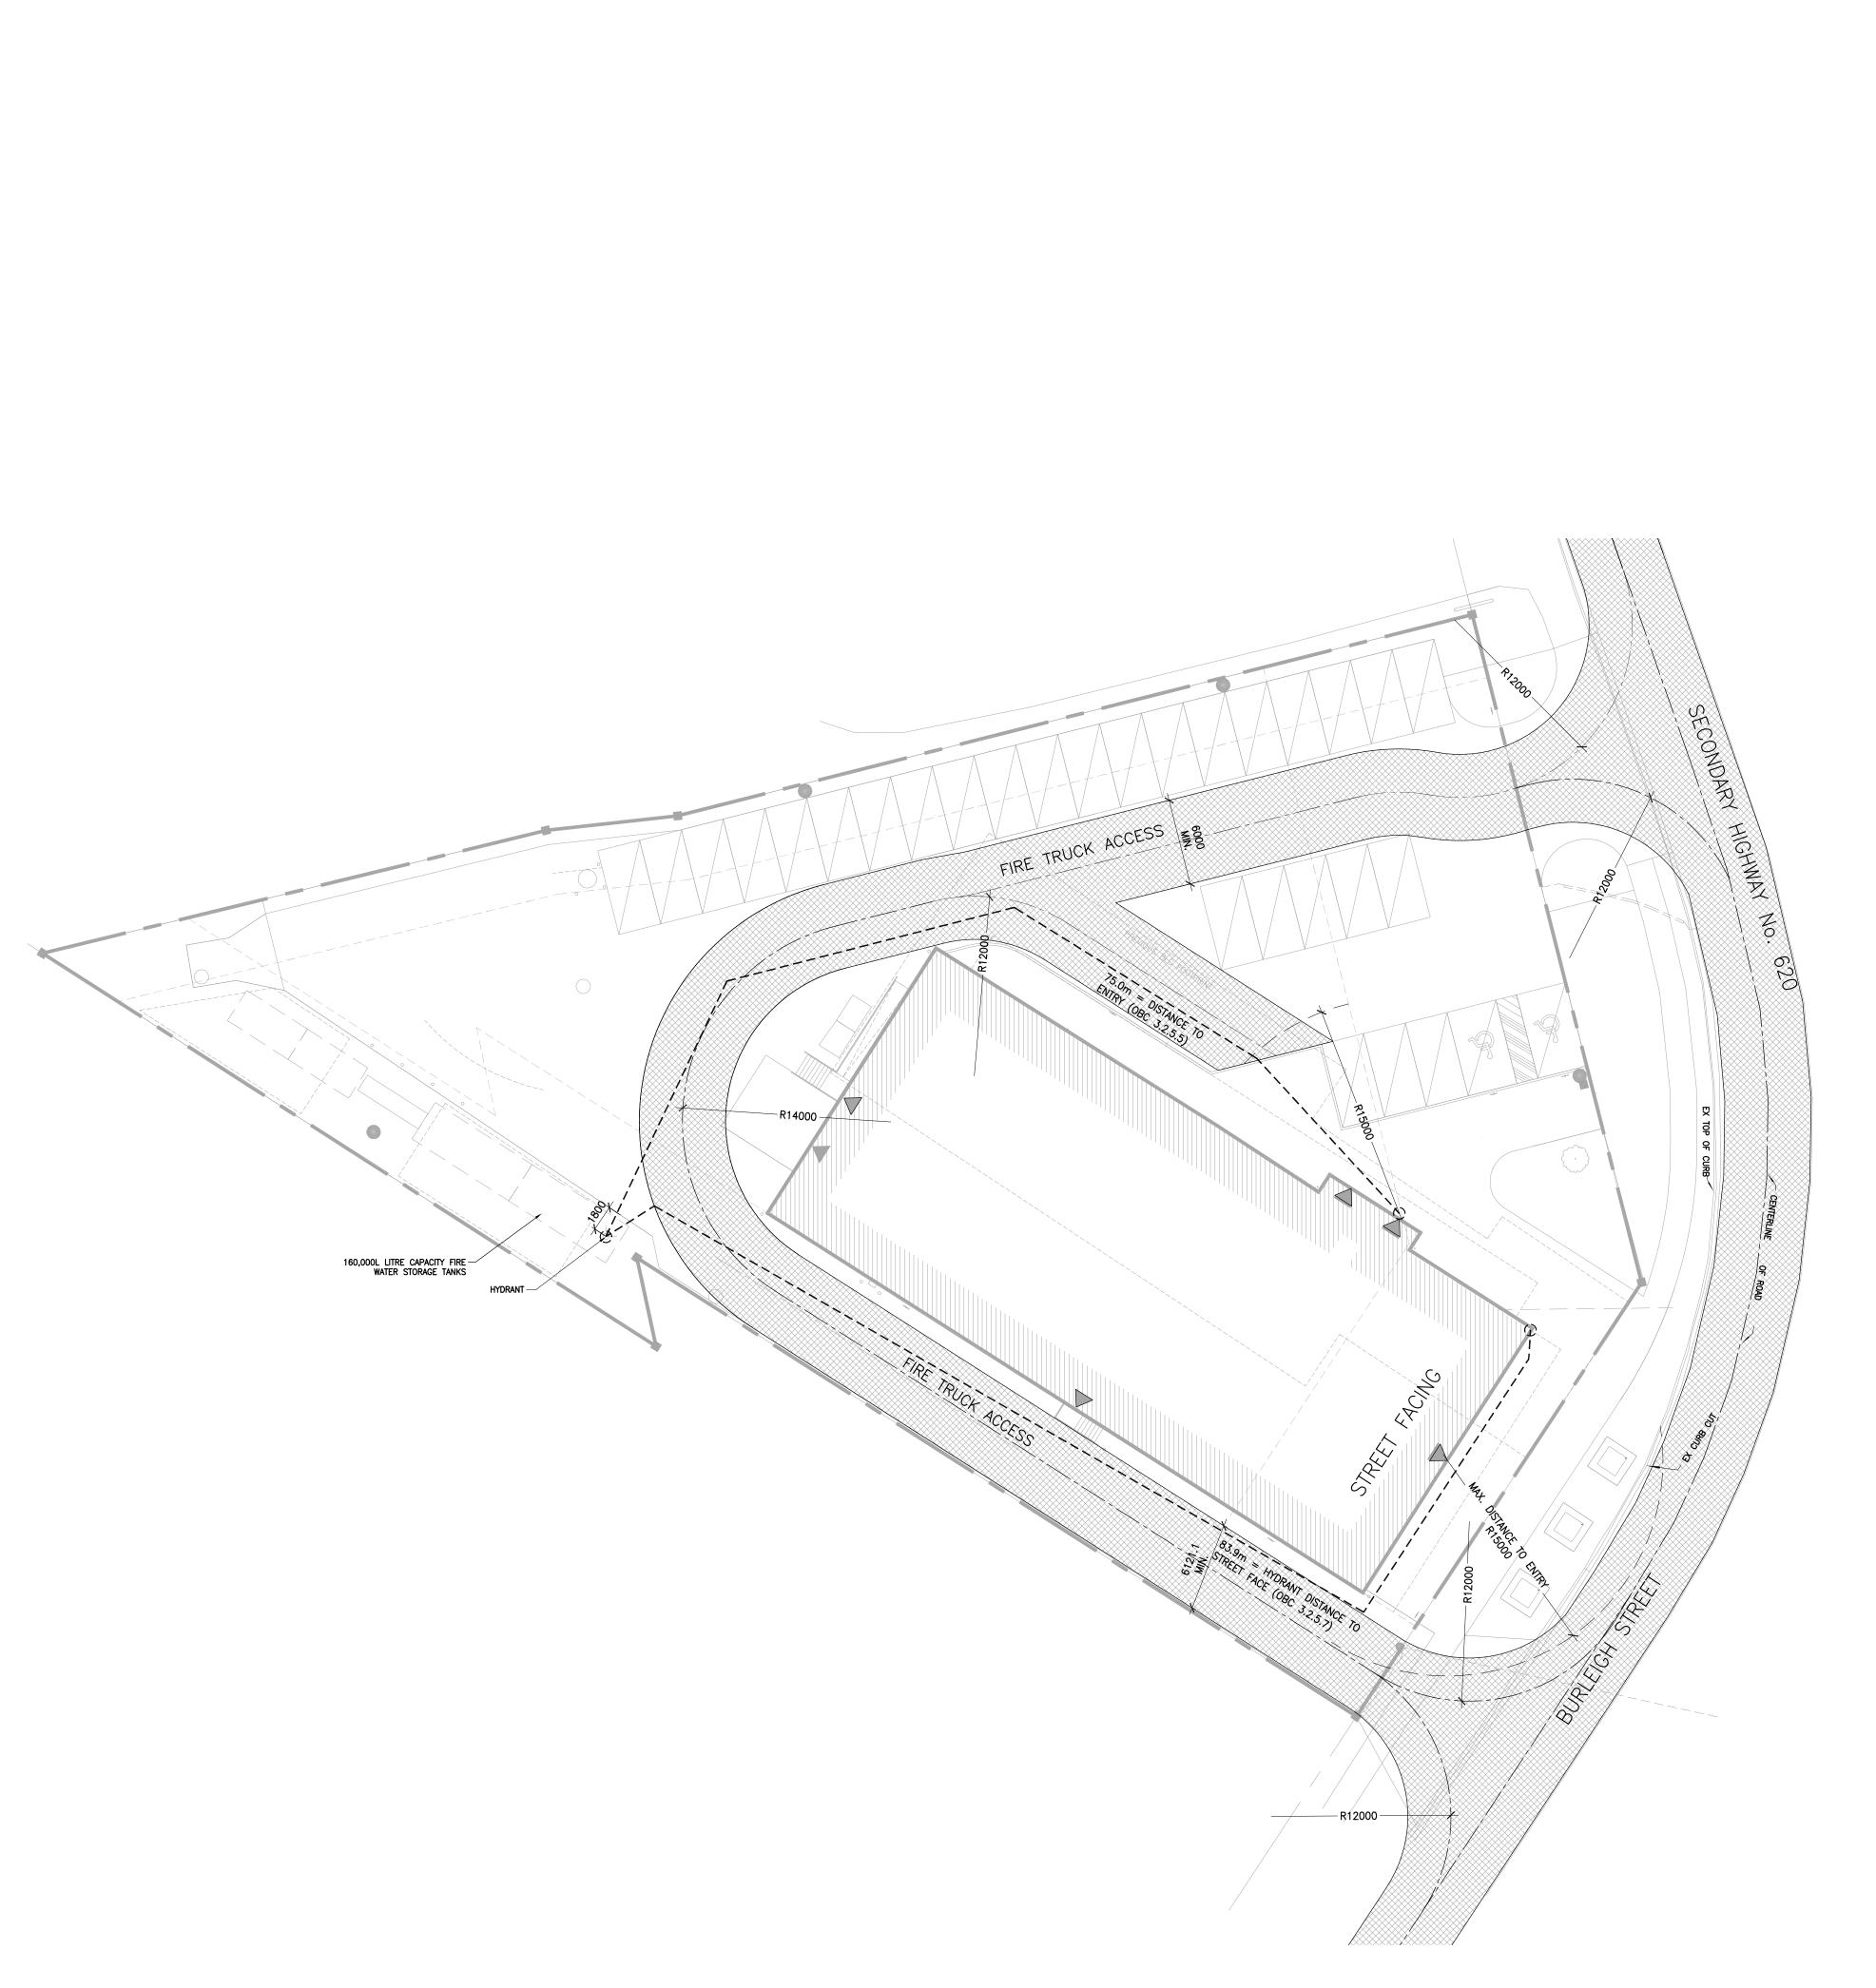

				NT SAFETY AN	27.00200				C REFERENCE
	Name of Practice	MacLennan Jaur	nkalns Miller Archite	us			-		
	Address 1	425 Adelaide St	treet West, Level 6				1		
	Address 2	Toronto, Ontari	0						
	Contact	Andrew Bramm	ı				4		
	Name of Project	Savers Foods					-		
							-		
	Location/Address	132 Burleigh St	reet				,		
	Date	17-Jan-22					Seal & Signature		
3.00	BUILDING CODE	VERSION	O.Reg. 332/12		LAST	AMENDMENT	O.Reg. 191/14		
3.01	PROJECT TYPE		New Construction	on					[A] 1.1.2.
2.02	MAJOR OCCUPA	NCY	OCCUPANCY				LICE		2424/4
3.02	CLASSIFICATION	1	OCCUPANCY				USE		3.1.2.1.(1)
	SUPERIMPOSED) MAJOR	E	Mercantile			Grocery Store		
3.03	OCCUPANCIES		No						3.2.2.7.
3.04	BUILDING AREA	(m*)	DESCRIPTION Building Area			EXISTING 0.00			[A] 1.4.1.2.
			TOTAL			-	1,078.0	\$ 1 1 1 1 1 1 1 1 1 1 1 1 1 1 1 1 1 1 1	-
3.05	GROSS AREA (m	1 ²)	DESCRIPTION			EXISTING	NEV	V TOTAL	[A] 1.4.1.2.
			Ground Level			0.00		.,	•
			TOTAL			0.00	1,274.0		
3.06	MEZZANINE ARE	EA (m²)	DESCRIPTION			EXISTING			3.2.1.1.
			TO T.					-	
3.07	BUILDING HEIGH	HT.	TOTAL 2	STOREYS ABOVE G	RADE	-	10.00	(m) ABOVE GRADE	[A] 1.4.1.2 [®]
			0	STOREYS BELOW G			.0.00	()	3.2.1.1.
3.08	HIGH BUILDING		No						3.2.6
3.09	NUMBER OF STREE FIREFIGHTER ACCE			1 STREET(S)					3.2.2.10. & 3.2.
3.10	BUILDING CLASS	SIFICATION	3.2.2.59.	GROUP E, UP TO 3	STOREYS - FAC	ING 1 STREET	rs		3.2.2.20-83.
	(SIZE AND CONSTRUC RELATIVE TO OCCUP		-	GROUP D ACCESS	ORY (L2)				
3.11	SPRINKLER SYS	ТЕМ	Not Required		PROVIDED:	None			3.2.1.5. &
3 12	STANDFIPE SYS	ТЕМ	Not Required						3.2.2.17.
	FIRE ALARM SYS		Not Required		TY	PE PROVIDED	N/A		3.2.4.
3.14	WATER SERVICE SUPPLY IS ADEC		No			160,000L Wat	ter Storage Tanks Pr	ovided on Site	
3.15	CONSTRUCTION		RESTRICTIONS	Combustible Permit	ted				3.2.2.2.2083.
			ACTUAL	Combination		HEAVY TIME	BER CONSTRUCTION	NO NO	3.2.1.4.
3.16	IMPORTANCE CA	ATEGORY	Norm al			-			4.1.2.1.(3), T4.1.2.1.B.
3.17	SEISMIC HAZARI	D INDEX(I _E F _a S _a (0.	2) 0.18	7 Seismic Design Not I	Required for Tab	le 4.1.8.18. Item	ns 6 to 21		4.1.8.18.(1)
3.18	OCCUPANT LOA	.D	FLOOR LEVEL/AREA		OCCUPANCY	TYPE	BASED ON	OCCUPANT LOAD (PERSONS)	3.1.17.
			L1 - OPEN SHOR (576m/3.7)	PPING AREA	MERCANTILE STOREY	- FIRST	m² per person	156	
			L1 - BAKE & DE	LI (106m/9.3)	KITCHENS		m² per person	12	
			L1 - PRODUCE F		KITCHENS		m² per person m² per person	2	
			L1 - SERVICE (7	<u> </u>	STORAGE		m² per person		
							iii bei beisoii	2	
			L2 - OFFICE	· · · · · · · · · · · · · · · · · · ·	OFFICES		Design of space	4	
			L2 - STORAGE (31m/46)	OFFICES STORAGE				· ·
				31m/46)			Design of space	4	•
			L2 - STORAGE (31m/46)	STORAGE OFFICES		Design of space m² per person Design of space	1	
			L2 - STORAGE (L2 - PRIVATE OFFICE L2 - STAFF	31m/46)	STORAGE		Design of space m² per person	1	
			L2 - STORAGE (L2 - PRIVATE OFFICE L2 - STAFF (EMPLOYEES FROM OTHER	31m/46)	STORAGE OFFICES		Design of space m² per person Design of space	1	
3.19	BARRIER-FREE D	DESIGN	L2 - STORAGE (L2 - PRIVATE OFFICE L2 - STAFF (EMPLOYEES FROM OTHER AREAS)	31m/46)	STORAGE OFFICES		Design of space m² per person Design of space	4 1 3 -	3.8.
	HAZARDOUS SU	BSTANCES	L2 - STORAGE (L2 - PRIVATE OFFICE L2 - STAFF (EMPLOYEES FROMOTHER AREAS) TOTAL	31m/46)	STORAGE OFFICES		Design of space m² per person Design of space m² per person	4 1 3 -	3.3.1.2. & 3.3.1.19.
		BSTANCES	L2 - STORAGE (L2 - PRIVATE OFFICE L2 - STAFF (EMPLOYEES FROMOTHER AREAS) TOTAL Yes		STORAGE OFFICES	RATING (H)	Design of space m² per person Design of space	4 1 3 -	3.3.1.2. & 3.3.1.19. 3.2.2.2083,
3.20	HAZARDOUS SU	BSTANCES	L2 - STORAGE (L2 - PRIVATE OFFICE L2 - STAFF (EMPLOYEES FROM OTHER AREAS) TOTAL YES NO HORIZONTAL AS	SSEMBLY	STORAGE OFFICES	N/A	Design of space m² per person Design of space m² per person SUPPORTING ASSEMBLY (H) N/A	A 1 3 - 182 NONCOMBUSTIBLE IN LIEU OF RATING? N/A	3.3.1.2. & 3.3.1.19. 3.2.2.2083,
3.20	HAZARDOUS SU	BSTANCES	L2 - STORAGE (L2 - PRIVATE OFFICE L2 - STAFF (EMPLOYEES FROMOTHER AREAS) TOTAL YES NO	SSEMBLY	STORAGE OFFICES		Design of space m² per person Design of space m² per person SUPPORTING ASSEMBLY (H)	4 1 3 - 182 NONCOMBUSTIBLE IN LIEU OF RATING?	3.3.1.2. & 3.3.1.19. 3.2.2.2083,
3.20	HAZARDOUS SU	BSTANCES	L2 - STORAGE (L2 - PRIVATE OFFICE L2 - STAFF (EMPLOYEES FROMOTHER AREAS) TOTAL YES NO HORIZONTAL AS FLOORS OVER FLOORS	SSEMBLY	STORAGE OFFICES	N/A 45 min	Design of space m² per person Design of space m² per person SUPPORTING ASSEMBLY (H) N/A 45 min	A 1 3 - 182 NONCOMBUSTIBLE IN LIEU OF RATING? N/A NO	3.3.1.2. & 3.3.1.19. 3.2.2.2083,
3.20	HAZARDOUS SU	BSTANCES RESISTANCE	L2 - STORAGE (L2 - PRIVATE OFFICE L2 - STAFF (EMPLOYEES FROM OTHER AREAS) TOTAL YES NO HORIZONTAL AS FLOORS OVER FLOORS MEZZANINE	SSEMBLY	STORAGE OFFICES LOUNGE	N/A 45 min N/A 45 min REQUIRED	Design of space m² per person Design of space m² per person SUPPORTING ASSEMBLY (H) N/A 45 min N/A CONSTRUCTION	A 1 3 - 182 NONCOMBUSTIBLE IN LIEU OF RATING? N/A NO N/A	3.3.1.2. & 3.3.1.19. 3.2.2.2083,
3.20	HAZARDOUS SU REQUIRED FIRE RATINGS	BSTANCES RESISTANCE	L2 - STORAGE (L2 - PRIVATE OFFICE L2 - STAFF (EMPLOYEES FROMOTHER AREAS) TOTAL YES NO HORIZONTAL AS FLOORS OVER FLOORS MEZZANINE ROOF	SSEMBLY BSMT	STORAGE OFFICES LOUNGE	N/A 45 min N/A 45 min	Design of space m² per person Design of space m² per person SUPPORTING ASSEMBLY (H) N/A 45 min CONSTRUCTION TYPE	A 1 3 - 182 NONCOMBUSTIBLE IN LIEU OF RATING? N/A NO N/A YES	3.3.1.2. & 3.3.1.19. 3.2.2.2083, 3.2.1.4.
3.20	HAZARDOUS SU REQUIRED FIRE RATINGS	BSTANCES RESISTANCE	L2 - STORAGE (L2 - PRIVATE OFFICE L2 - STAFF (EMPLOYEES FROMOTHER AREAS) TOTAL YES NO HORIZONTAL AS FLOORS OVER FLOORS MEZZANINE ROOF	EBF AREA L.D. (m)	STORAGE OFFICES LOUNGE	N/A 45 min N/A 45 min REQUIRED	Design of space m² per person Design of space m² per person SUPPORTING ASSEMBLY (H) N/A 45 min N/A CONSTRUCTION	A 1 3 - 182 NONCOMBUSTIBLE IN LIEU OF RATING? N/A NO N/A YES	3.3.1.2. & 3.3.1.19. 3.2.2.2083, 3.2.1.4.
3.20	HAZARDOUS SU REQUIRED FIRE RATINGS	BSTANCES RESISTANCE	L2 - STORAGE (L2 - PRIVATE OFFICE L2 - STAFF (EMPLOYEES FROM OTHER AREAS) TOTAL YES NO HORIZONTAL AS FLOORS OVER FLOORS MEZZANINE ROOF	EBF AREA L.D. (m) (m²) 178.0 18.50	STORAGE OFFICES LOUNGE L/H OR H/L 2.30	N/A 45 min N/A 45 min REQUIRED FRR (H)	Design of space m² per person Design of space m² per person SUPPORTING ASSEMBLY (H) N/A 45 min CONSTRUCTION TYPE Combustible	A 1 3 - 182 NONCOMBUSTIBLE IN LIEU OF RATING? N/A NO N/A YES CLADDING TYPE	3.3.1.2. & 3.3.1.19. 3.2.2.2083, 3.2.1.4. 3.2.3.
3.20	HAZARDOUS SU REQUIRED FIRE RATINGS	BSTANCES RESISTANCE	L2 - STORAGE (L2 - PRIVATE OFFICE L2 - STAFF (EMPLOYEES FROM OTHER AREAS) TOTAL YES NO HORIZONTAL AS FLOORS OVER FLOORS MEZZANINE ROOF WALL NORTH-WEST A	EBF AREA L.D. (m) (m²) 178.0 18.50	STORAGE OFFICES LOUNGE L/H OR H/L 2.30 1.90	N/A 45 min N/A 45 min REQUIRED FRR (H)	Design of space m² per person Design of space m² per person SUPPORTING ASSEMBLY (H) N/A 45 min CONSTRUCTION TYPE Combustible Permitted Combustible	A 1 3 - 182 NONCOMBUSTIBLE IN LIEU OF RATING? N/A NO N/A YES CLADDING TYPE Combustible Permitte	3.3.1.2. & 3.3.1.19. 3.2.2.2083, 3.2.1.4. 3.2.3.
3.20	HAZARDOUS SU REQUIRED FIRE RATINGS	BSTANCES RESISTANCE	L2 - STORAGE (L2 - PRIVATE OFFICE L2 - STAFF (EMPLOYEES FROM OTHER AREAS) TOTAL YES NO HORIZONTAL AS FLOORS OVER I FLOORS MEZZANINE ROOF WALL NORTH-WEST A	EBF AREA L.D. (m) (m²) 178.0 18.50	L/H OR H/L 2.30 1.90	N/A 45 min N/A 45 min REQUIRED FRR (H)	Design of space m² per person Design of space m² per person SUPPORTING ASSEMBLY (H) N/A 45 min CONSTRUCTION TYPE Combustible Permitted Combustible Permitted Combustible Permitted Combustible Permitted Combustible Permitted Combustible Permitted Combustible	A 1 3 - 182 NONCOMBUSTIBLE IN LIEU OF RATING? N/A NO N/A YES CLADDING TYPE Combustible Permitte Combustible Permitte	3.3.1.2. & 3.3.1.19. 3.2.2.2083, 3.2.1.4. 3.2.1.4. 3.2.3. 4. 4. 4. 4. 4. 4. 4. 4. 4. 4. 4. 4. 4.
3.20	HAZARDOUS SU REQUIRED FIRE RATINGS	BSTANCES RESISTANCE	L2 - STORAGE (L2 - PRIVATE OFFICE L2 - STAFF (EMPLOYEES FROM OTHER AREAS) TOTAL YES NO HORIZONTAL AS FLOORS OVER FLOORS MEZZANINE ROOF WALL NORTH-WEST A NORTH-WEST C NORTH-EAST A	EBF AREA L.D. (m) (m²) 178.0 18.50 19.0 18.50 19.0 19.60	LOUNGE L/H OR H/L 2.30 1.90 1.70 4.90	N/A 45 min N/A 45 min REQUIRED FRR (H) 1.00	Design of space m² per person Design of space m² per person SUPPORTING ASSEMBLY (H) N/A 45 min CONSTRUCTION TYPE Combustible Permitted	A 1 3 - 182 NONCOMBUSTIBLE IN LIEU OF RATING? N/A NO N/A YES CLADDING TYPE Combustible Permitt Combustible Permitt Combustible Permitt Noncombustible Recombustible Recombustible	3.3.1.2. & 3.3.1.19. 3.2.2.2083, 3.2.1.4. 3.2.1.4. 3.2.1.4. 3.2.1.4. 3.2.3. 3.2.3.
3.20	HAZARDOUS SU REQUIRED FIRE RATINGS	BSTANCES RESISTANCE	L2 - STORAGE (L2 - PRIVATE OFFICE L2 - STAFF (EMPLOYEES FROMOTHER AREAS) TOTAL YES NO HORIZONTAL AS FLOORS OVER FLOORS MEZZANINE ROOF WALL NORTH-WEST A NORTH-WEST C NORTH-EAST A SOUTH-EAST A	EBF AREA L.D. (m) (m²) 18.50 19.0 18.50 19.60 19.60 179.0 15.60	L/H OR H/L 2.30 1.70 4.90 2.26	N/A 45 min N/A 45 min REQUIRED FRR (H) 1.00	Design of space m² per person Design of space m² per person SUPPORTING ASSEMBLY (H) N/A 45 min CONSTRUCTION TYPE Combustible Permitted Combustible Permitted Combustible Permitted Combustible Permitted Combustible Permitted Combustible Permitted	A 1 3 3 - 182 NONCOMBUSTIBLE IN LIEU OF RATING? N/A NO N/A YES CLADDING TYPE Combustible Permitt Combustible Permitt Combustible Permitt Noncombustible Rec	3.3.1.2. & 3.3.1.19. 3.2.2.2083, 3.2.1.4. 3.2.1.4. 3.2.1.4. 3.2.1.4. 3.2.3. 3.2.3. 3
3.20	HAZARDOUS SU REQUIRED FIRE RATINGS	BSTANCES RESISTANCE	L2 - STORAGE (L2 - PRIVATE OFFICE L2 - STAFF (EMPLOYEES FROM OTHER AREAS) TOTAL YES NO HORIZONTAL AS FLOORS OVER FLOORS MEZZANINE ROOF WALL NORTH-WEST A NORTH-WEST C NORTH-EAST A	EBF AREA L.D. (m) (m²) 178.0 18.50 19.0 18.50 19.0 19.60	L/H OR H/L 2.30 1.70 4.90 2.26	N/A 45 min N/A 45 min REQUIRED FRR (H) 1.00	Design of space m² per person Design of space m² per person SUPPORTING ASSEMBLY (H) N/A 45 min CONSTRUCTION TYPE Combustible Permitted	A 1 3 - 182 NONCOMBUSTIBLE IN LIEU OF RATING? N/A NO N/A YES CLADDING TYPE Combustible Permitt Combustible Permitt Combustible Permitt Noncombustible Recombustible Recombustible	3.3.1.2. & 3.3.1.19. 3.2.2.2083, 3.2.1.4. 3.2.1.4. 3.2.1.4. 3.2.1.4. 3.2.3. 3.2.3. 3
3.20	HAZARDOUS SU REQUIRED FIRE RATINGS	BSTANCES RESISTANCE	L2 - STORAGE (L2 - PRIVATE OFFICE L2 - STAFF (EMPLOYEES FROMOTHER AREAS) TOTAL YES NO HORIZONTAL AS FLOORS OVER FLOORS MEZZANINE ROOF WALL NORTH-WEST A NORTH-WEST C NORTH-EAST A SOUTH-EAST A	EBF AREA L.D. (m) (m²) 178.0 18.50 19.0 18.50 396.0 19.60 179.0 15.60 35.0 15.60	STORAGE OFFICES LOUNGE L/H OR H/L 2.30 1.90 1.70 4.90 2.26 1.80	N/A 45 min N/A 45 min REQUIRED FRR (H) 1.00	Design of space m² per person Design of space m² per person SUPPORTING ASSEMBLY (H) N/A 45 min CONSTRUCTION TYPE Combustible Permitted	A 1 3 3 - 182 NONCOMBUSTIBLE IN LIEU OF RATING? N/A NO N/A YES CLADDING TYPE Combustible Permitt Combustible Permitt Combustible Permitt Noncombustible Rec	3.3.1.2. & 3.3.1.19. 3.2.2.2083, 3.2.1.4. 3.2.3. 4. 4. 4. 4. 4. 4. 4.
3.20	HAZARDOUS SU REQUIRED FIRE RATINGS	BSTANCES RESISTANCE	L2 - STORAGE (L2 - PRIVATE OFFICE L2 - STAFF (EMPLOYEES FROM OTHER AREAS) TOTAL YES NO HORIZONTAL AS FLOORS OVER FLOORS MEZZANINE ROOF WALL NORTH-WEST A NORTH-WEST A SOUTH-EAST A SOUTH-EAST A	EBF AREA L.D. (m) (m²) 178.0 18.50 19.0 18.50 396.0 19.60 179.0 15.60 35.0 15.60 246.0 7.50	L/H OR H/L 2.30 1.90 4.90 4.90	N/A 45 min N/A 45 min REQUIRED FRR (H) 1.00	Design of space m² per person Design of space m² per person SUPPORTING ASSEMBLY (H) N/A 45 min CONSTRUCTION TYPE Combustible Permitted	A 1 3 NONCOMBUSTIBLE IN LIEU OF RATING? N/A NO N/A YES CLADDING TYPE Combustible Permitt Combustible Permitt Noncombustible Rec Combustible Permitt Combustible Permitt Combustible Permitt Combustible Permitt Combustible Permitt Combustible Permitt	3.3.1.2. & 3.3.1.19. 3.2.2.2083, 3.2.1.4. 3.2.1.4. 3.2.1.4. 3.2.1.4. 3.2.3. 3.2.3. 3
3.20	HAZARDOUS SU REQUIRED FIRE RATINGS	BSTANCES RESISTANCE	L2 - STORAGE (L2 - PRIVATE OFFICE L2 - STAFF (EMPLOYEES FROM OTHER AREAS) TOTAL YES NO HORIZONTAL AS FLOORS OVER I FLOORS MEZZANINE ROOF WALL NORTH-WEST A NORTH-WEST A SOUTH-EAST A SOUTH-EAST A SOUTH-EAST A	EBF AREA L.D. (m) (m²) 178.0 18.50 19.0 18.50 396.0 19.60 179.0 15.60 35.0 15.60 246.0 7.50	STORAGE OFFICES LOUNGE L/H OR H/L 2.30 1.90 1.70 4.90 2.26 1.80 4.90 4.90	N/A 45 min N/A 45 min REQUIRED FRR (H) 1.00 2.00	Design of space m² per person Design of space m² per person SUPPORTING ASSEMBLY (H) N/A 45 min CONSTRUCTION TYPE Combustible Permitted	NONCOMBUSTIBLE IN LIEU OF RATING? N/A NO N/A YES CLADDING TYPE Combustible Permitt Combustible Permitt Combustible Permitt Noncombustible Rec	3.3.1.2. & 3.3.1.19. 3.2.2.2083, 3.2.1.4. 3.2.1.4. 3.2.1.4. 3.2.1.4. 3.2.3. 3.2.3. 3
3.20	HAZARDOUS SU REQUIRED FIRE RATINGS SPATIAL SEPARA PLUMBING FIXTU	BSTANCES RESISTANCE ATION	L2 - STORAGE (L2 - PRIVATE OFFICE L2 - STAFF (EMPLOYEES FROM OTHER AREAS) TOTAL YES NO HORIZONTAL AS FLOORS OVER I FLOORS MEZZANINE ROOF WALL NORTH-WEST A NORTH-WEST A SOUTH-EAST A SOUTH-EAST A SOUTH-WEST B SOUTH-WEST B	EBF AREA L.D. (m) (m²) 178.0 18.50 19.0 15.60 179.0 15.60 246.0 7.50 96.0 7.50 19.00 7.50	STORAGE OFFICES LOUNGE L/H OR H/L 2.30 1.90 1.70 4.90 2.26 1.80 4.90 4.00 2.90	N/A 45 min N/A 45 min REQUIRED FRR (H) 1.00 2.00 2.00 1.00	Design of space m² per person Design of space m² per person SUPPORTING ASSEMBLY (H) N/A 45 min CONSTRUCTION TYPE Combustible Permitted Combustible	A 1 3 - 182 NONCOMBUSTIBLE IN LIEU OF RATING? N/A NO N/A YES CLADDING TYPE Combustible Permitt Combustible Permitt Combustible Permitt Noncombustible Rec Combustible Permitt Noncombustible Rec Combustible Permitt Noncombustible Rec Combustible Permitt Noncombustible Rec Combustible Permitt Combustible Permitt Noncombustible Rec Combustible Permitt	3.3.1.2. & 3.3.1.19. 3.2.2.2083, 3.2.1.4. 3.2.1.4. 3.2.1.4. 3.2.1.4. 3.2.3. 3.2.3. 3
3.21	HAZARDOUS SU REQUIRED FIRE RATINGS SPATIAL SEPARA	BSTANCES RESISTANCE ATION	L2 - STORAGE (L2 - PRIVATE OFFICE L2 - STAFF (EMPLOYEES FROM OTHER AREAS) TOTAL YES NO HORIZONTAL AS FLOORS OVER I FLOORS MEZZANINE ROOF WALL NORTH-WEST A NORTH-WEST A SOUTH-EAST A SOUTH-EAST A SOUTH-WEST A SOUTH-WEST C RATIO: FLOOR	EBF AREA L.D. (m) (m²) 178.0 18.50 19.0 15.60 179.0 15.60 246.0 7.50 96.0 7.50 19.00 7.50	STORAGE OFFICES LOUNGE L/H OR H/L 2.30 1.90 1.70 4.90 4.90 4.90 4.00 2.90 MALE = 50:50 EX OCCUPANT	N/A 45 min N/A 45 min REQUIRED FRR (H) 1.00 2.00 2.00 1.00 CEPT AS NOT	Design of space m² per person Design of space m² per person SUPPORTING ASSEMBLY (H) N/A 45 min N/A 45 min CONSTRUCTION TYPE Combustible Permitted	NONCOMBUSTIBLE IN LIEU OF RATING? N/A NO N/A YES CLADDING TYPE Combustible Permitt Combustible Permitt Combustible Permitt Noncombustible Rec Combustible Permitt Noncombustible Rec Combustible Permitt	3.3.1.2. & 3.3.1.19. 3.2.2.2083, 3.2.1.4. 3.2.1.4. 3.2.1.4. 3.2.1.4. 3.2.1.4. 3.2.3. 3.2.3. 3.21	HAZARDOUS SU REQUIRED FIRE RATINGS SPATIAL SEPARA PLUMBING FIXTU	BSTANCES RESISTANCE ATION	L2 - STORAGE (L2 - PRIVATE OFFICE L2 - STAFF (EMPLOYEES FROM OTHER AREAS) TOTAL YES NO HORIZONTAL AS FLOORS OVER FLOORS MEZZANINE ROOF WALL NORTH-WEST A NORTH-WEST A SOUTH-EAST A SOUTH-EAST A SOUTH-WEST B SOUTH-WEST C RATIO: FLOOR LEVEL/AREA	EBF AREA L.D. (m) (m²) 178.0 18.50 19.0 18.50 396.0 19.60 179.0 15.60 35.0 15.60 246.0 7.50 96.0 7.50 MALE:FEN	STORAGE OFFICES LOUNGE L/H OR H/L 2.30 1.90 1.70 4.90 4.90 4.90 4.00 2.90 MALE = 50.50 EX OCCUPANT LOAD	N/A 45 min N/A 45 min REQUIRED FRR (H) 1.00 2.00 2.00 1.00 CCEPT AS NOT	Design of space m² per person Design of space m² per person SUPPORTING ASSEMBLY (H) N/A 45 min N/A 45 min CONSTRUCTION TYPE Combustible Permitted	A 1 1 3 3 - 182 NONCOMBUSTIBLE IN LIEU OF RATING? N/A NO N/A YES CLADDING TYPE Combustible Permitt Combustible Permitt Combustible Permitt Noncombustible Rec Combustible Permitt Noncombustible Rec Combustible Permitt Noncombustible Rec Combustible Permitt	3.3.1.2. & 3.3.1.19. 3.2.2.2083, 3.2.1.4. 3.2.1.4. 3.2.1.4. 3.2.1.4. 3.2.1.4. 3.2.3. 3.2.3. 3.21	HAZARDOUS SU REQUIRED FIRE RATINGS SPATIAL SEPARA PLUMBING FIXTU	BSTANCES RESISTANCE ATION	L2 - STORAGE (L2 - PRIVATE OFFICE L2 - STAFF (EMPLOYEES FROM OTHER AREAS) TOTAL YES NO HORIZONTAL AS FLOORS OVER FLOORS MEZZANINE ROOF WALL NORTH-WEST A NORTH-WEST A SOUTH-EAST A SOUTH-EAST A SOUTH-WEST B SOUTH-WEST C RATIO: FLOOR LEVEL/AREA	EBF AREA L.D. (m) (m²) 178.0 18.50 19.0 18.50 396.0 19.60 179.0 15.60 35.0 15.60 246.0 7.50 96.0 7.50 MALE:FEN	STORAGE OFFICES LOUNGE L/H OR H/L 2.30 1.90 1.70 4.90 2.26 1.80 4.90 4.00 2.90 MALE = 50:50 EX OCCUPANT LOAD	N/A 45 min N/A 45 min REQUIRED FRR (H) 1.00 2.00 2.00 1.00 CEPT AS NOT	Design of space m² per person Design of space m² per person SUPPORTING ASSEMBLY (H) N/A 45 min CONSTRUCTION TYPE Combustible Permitted	A 1 1 3 3 - 182 NONCOMBUSTIBLE IN LIEU OF RATING? N/A NO N/A YES CLADDING TYPE Combustible Permitt Combustible Permitt Combustible Permitt Noncombustible Rec Combustible Rec Combustible Permitt Noncombustible Rec Noncombustible Rec Noncombustible Rec Noncombustible Permitt Noncombustible Rec Noncombustible Permitt Noncombustible Permitt Noncombustible Permitt Noncombustible Permitt	3.3.1.2. & 3.3.1.19. 3.2.2.2083, 3.2.1.4. 3.2.1.4. 3.2.1.4. 3.2.1.4. 3.2.1.4. 3.2.3. 3.2.3. 3.20 3.21 3.22	HAZARDOUS SU REQUIRED FIRE RATINGS SPATIAL SEPARA PLUMBING FIXTUREQUIREMENTS	BSTANCES RESISTANCE ATION	L2 - STORAGE (L2 - PRIVATE OFFICE L2 - STAFF (EMPLOYEES FROM OTHER AREAS) TOTAL YES NO HORIZONTAL AS FLOORS OVER I FLOORS MEZZANINE ROOF WALL NORTH-WEST A NORTH-WEST A SOUTH-EAST A SOUTH-EAST A SOUTH-WEST C RATIO: FLOOR L1 - PUBLIC (P) L2 - GROUP D S	EBF AREA L.D. (m) (m²) 178.0 18.50 19.0 18.50 396.0 19.60 179.0 15.60 35.0 15.60 246.0 7.50 MALE:FEN + STAFF (S) MERCAN	STORAGE OFFICES LOUNGE L/H OR H/L 2.30 1.90 1.70 4.90 2.26 1.80 4.90 4.00 2.90 MALE = 50:50 EX OCCUPANT LOAD T 174 8	N/A 45 min N/A 45 min REQUIRED FRR (H) 1.00 2.00 2.00 1.00 CEPT AS NOT OBC SENTENCE 3.7.4.8 (2.A) 3.7.4.7 (2)	Design of space m² per person Design of space m² per person SUPPORTING ASSEMBLY (H) N/A 45 min CONSTRUCTION TYPE Combustible Permitted	NONCOMBUSTIBLE IN LIEU OF RATING? N/A NO N/A YES CLADDING TYPE Combustible Permitt Combustible Permitt Combustible Permitt Noncombustible Rec Combustible Permitt	3.3.1.2. & 3.3.1.19. 3.2.2.2083, 3.2.1.4. 3.2.1.4. 3.2.1.4. 3.2.1.4. 3.2.1.4. 3.2.3. 3.2.3. 3.20 3.21 3.22	HAZARDOUS SU REQUIRED FIRE RATINGS SPATIAL SEPARA PLUMBING FIXTU	BSTANCES RESISTANCE ATION	L2 - STORAGE (L2 - PRIVATE OFFICE L2 - STAFF (EMPLOYEES FROM OTHER AREAS) TOTAL YES NO HORIZONTAL AS FLOORS OVER FLOORS MEZZANINE ROOF WALL NORTH-WEST A NORTH-WEST A SOUTH-EAST A SOUTH-EAST A SOUTH-EAST A SOUTH-WEST C RATIO: FLOOR RATIO: FLOOR L2 - GROUP D S COMPLIANCE P.	EBF AREA L.D. (m) (m²) 178.0 18.50 19.0 18.50 396.0 19.60 179.0 15.60 35.0 15.60 246.0 7.50 96.0 7.50 MALE:FEM + STAFF (S) MERCAN TAFF	STORAGE OFFICES LOUNGE L/H OR H/L 2.30 1.90 1.70 4.90 2.26 1.80 4.90 4.00 2.90 MALE = 50:50 EX OCCUPANT LOAD T 174 8	N/A 45 min N/A 45 min REQUIRED FRR (H) 1.00 2.00 2.00 1.00 CEPT AS NOT OBC SENTENCE 3.7.4.8 (2.A) 3.7.4.7 (2)	Design of space m² per person Design of space m² per person SUPPORTING ASSEMBLY (H) N/A 45 min CONSTRUCTION TYPE Combustible Permitted	NONCOMBUSTIBLE IN LIEU OF RATING? N/A NO N/A YES CLADDING TYPE Combustible Permitt Combustible Permitt Combustible Permitt Noncombustible Rec Combustible Permitt	3.3.1.2. & 3.3.1.19. 3.2.2.2083, 3.2.1.4. 3.2.1.4. 3.2.1.4. 3.2.1.4. 3.2.1.4. 3.2.3. 3.2.3. 3.20 3.21 3.22	HAZARDOUS SU REQUIRED FIRE RATINGS SPATIAL SEPARA PLUMBING FIXTUREQUIREMENTS	BSTANCES RESISTANCE ATION	L2 - STORAGE (L2 - PRIVATE OFFICE L2 - STAFF (EMPLOYEES FROM OTHER AREAS) TOTAL YES NO HORIZONTAL AS FLOORS OVER I FLOORS MEZZANINE ROOF WALL NORTH-WEST A NORTH-WEST A SOUTH-EAST A SOUTH-EAST A SOUTH-WEST C RATIO: FLOOR L1 - PUBLIC (P) L2 - GROUP D S	EBF AREA L.D. (m) (m²) 178.0 18.50 19.0 18.50 396.0 19.60 179.0 15.60 35.0 15.60 246.0 7.50 96.0 7.50 MALE:FEM + STAFF (S) MERCAN TAFF	STORAGE OFFICES LOUNGE L/H OR H/L 2.30 1.90 1.70 4.90 2.26 1.80 4.90 4.00 2.90 MALE = 50:50 EX OCCUPANT LOAD T 174 8	N/A 45 min N/A 45 min REQUIRED FRR (H) 1.00 2.00 2.00 1.00 CEPT AS NOT OBC SENTENCE 3.7.4.8 (2.A) 3.7.4.7 (2)	Design of space m² per person Design of space m² per person SUPPORTING ASSEMBLY (H) N/A 45 min CONSTRUCTION TYPE Combustible Permitted	NONCOMBUSTIBLE IN LIEU OF RATING? N/A NO N/A YES CLADDING TYPE Combustible Permitt Combustible Permitt Combustible Permitt Noncombustible Rec Combustible Permitt	3.3.1.2. & 3.3.1.19. 3.2.2.2083, 3.2.1.4. 3.2.1.4. 3.2.1.4. 3.2.1.4. 3.2.1.4. 3.2.3. 3.2.3. 3.20 3.21 3.22	HAZARDOUS SU REQUIRED FIRE RATINGS SPATIAL SEPARA PLUMBING FIXTU REQUIREMENTS ENERGY EFFICIS	BSTANCES RESISTANCE ATION	L2 - STORAGE (L2 - PRIVATE OFFICE L2 - STAFF (EMPLOYEES FROM OTHER AREAS) TOTAL YES NO HORIZONTAL AX FLOORS OVER I FLOORS MEZZANINE ROOF WALL NORTH-WEST A NORTH-WEST A SOUTH-EAST A SOUTH-EAST A SOUTH-WEST B SOUTH-WEST C RATIO: FLOOR LEVEL/AREA L1 - PUBLIC (P) L2 - GROUP D S CUMATIC ZONE SEE 3.4.4.1 (1) FI SEE 3.4.4.1 (1) FI SOUTH-EAST A SOUTH-EAST A SOUTH-EAST A SOUTH-WEST C RATIO: FLOOR LEVEL/AREA L1 - PUBLIC (P) L2 - GROUP D S	EBF AREA L.D. (m) (m²) 178.0 18.50 19.0 18.50 19.0 15.60 396.0 19.60 179.0 15.60 35.0 15.60 246.0 7.50 MALE:FEN + STAFF (S) MERCAN TAFF ATH: PRESCRIF 6 - (BANCI	STORAGE OFFICES LOUNGE L/H OR H/L 2.30 1.90 1.70 4.90 4.90 4.90 4.00 2.26 1.80 4.90 4.90 TIT 174 8 PTIVE - ANSI/AS ROFT)	N/A 45 min N/A 45 min REQUIRED FRR (H) 1.00 1.00 - 2.00 2.00 1.00 CEPT AS NOT OBC SENTENCE 3.7.4.8 (2.A) 3.7.4.7 (2)	Design of space m² per person Design of space m² per person SUPPORTING ASSEMBLY (H) N/A 45 min CONSTRUCTION TYPE Combustible Permitted	NONCOMBUSTIBLE IN LIEU OF RATING? N/A NO N/A YES CLADDING TYPE Combustible Permitt Combustible Permitt Combustible Permitt Noncombustible Rec Combustible Permitt	3.3.1.2. & 3.3.1.19. 3.2.2.2083, 3.2.1.4. 3.2.1.4. 3.2.1.4. 3.2.1.4. 3.2.1.4. 3.2.3. 3.2.3. 3.20 3.21 3.22	HAZARDOUS SU REQUIRED FIRE RATINGS SPATIAL SEPARA PLUMBING FIXTU REQUIREMENTS ENERGY EFFICIS	BSTANCES RESISTANCE ATION	L2 - STORAGE (L2 - PRIVATE OFFICE L2 - STAFF (EMPLOYEES FROM OTHER AREAS) TOTAL YES NO HORIZONTAL AX FLOORS OVER I FLOORS MEZZANINE ROOF WALL NORTH-WEST A NORTH-WEST A SOUTH-EAST A SOUTH-EAST A SOUTH-WEST B SOUTH-WEST C RATIO: FLOOR LEVEL/AREA L1 - PUBLIC (P) L2 - GROUP D S CUMATIC ZONE SEE 3.4.4.1 (1) FI SEE 3.4.4.1 (1) FI SOUTH-EAST A SOUTH-EAST A SOUTH-EAST A SOUTH-WEST C RATIO: FLOOR LEVEL/AREA L1 - PUBLIC (P) L2 - GROUP D S	EBF AREA L.D. (m) (m²) 178.0 18.50 19.0 18.50 396.0 19.60 179.0 15.60 35.0 15.60 246.0 7.50 MALE:FEN ** STAFF (S) MERCAN TAFF ATH: PRESCRIF : 6- (BANCI	STORAGE OFFICES LOUNGE L/H OR H/L 2.30 1.90 1.70 4.90 2.26 1.80 4.90 4.00 2.90 MALE = 50:50 EX OCCUPANT LOAD T 174 8 P TIVE - ANSI/AS ROFT) If Exit Separation pany on Roof	N/A 45 min N/A 45 min REQUIRED FRR (H) 1.00 1.00 - 2.00 2.00 1.00 CEPT AS NOT OBC SENTENCE 3.7.4.8 (2.A) 3.7.4.7 (2) HRAE/IES 90.1	Design of space m² per person Design of space m² per person SUPPORTING ASSEMBLY (H) N/A 45 min CONSTRUCTION TYPE Combustible Permitted	A 1 3 - 182 NONCOMBUSTIBLE IN LIEU OF RATING? N/A NO N/A YES CLADDING TYPE Combustible Permitt Combustible Permitt Combustible Permitt Noncombustible Rec Tombustible Permitt Noncombustible Rec Noncombustible Rec Noncombustible Rec Tombustible Permitt Noncombustible Rec Noncombustible Rec Noncombustible Rec Lombustible Permitt Tixtures PROVIDED 1 Uni.WC + 1 WC 2 WC	3.3.1.2. & 3.3.1.19. 3.2.2.2083, 3.2.1.4. 3.2.1.4. 3.2.1.4. 3.2.1.4. 3.2.1.4. 3.2.3. 3.2.3. 
REV	DESCRIPTION	DATE	BY
1	ISSUED FOR SPA	210618	AB
2	REVISED SPA	210709	AB
3	REVISED SPA	210809	AB
4	ISSUED FOR TENDER	210824	AB
5	ISSUED FOR BUILDING PERMIT	210909	AB
6	REVISED TENDER	220124	AB
7	_	_	_
8	_	-	_
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11	-	-	-
12	_	_	_

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229 BROADWAY, UNIT 1
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TEL 519 941 0330 FAX 519 941 1830


BLACKWELL STRUCTURAL ENGINEERS


134 PETER STREET, SUITE 1301 TORONTO, ONTARIO, M5V 2H2 TEL 416.593.5300 FAX 416.593.4840

SMITH + ANDERSON MECHANICAL AND ELECTRICAL ENGINEERS 1100 - 100 SHEPPARD AVENUE EAST TORONTO, ONTARIO, M2N 6N5 TEL 416.487.8151 -

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PROJECT TITLE NEW SAYERS FOOD STORE BURLEIGH STREET, APSLEY

DRAWING TITLE

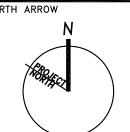OBC MATRIX

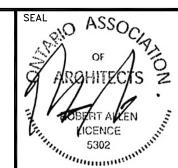SCALE

AS SHOWN


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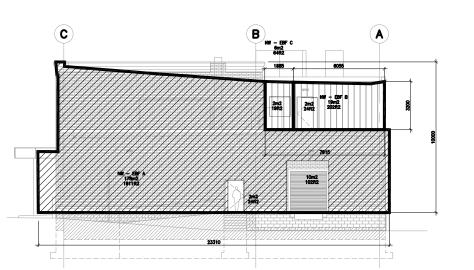
JANUARY 24, 2022

PROJECT NUMBER
2102

DRAWING NUMBER

1 CODE DATA MATRIX



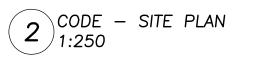

NORTH-WEST FACE A

178m2 = EXPOSED BUILDING FACE 18.5m = LIMITING DISTANCE

2.3 = L/H55% = MAX. UNPROTECT. OPENING (3.2.3.1.C) 6.7% = ACTUAL UNPROTECT. OPENING 1HR = REQ. FRR (3.2.3.7)

NON/C = REQ. CONSTRUCTION TYPE (3.2.3.7)NON/C = REQ. CLADDING TYPE (3.2.3.7)

NORTH-WEST FACE B

19m2 = EXPOSED BUILDING FACE 18.5m = LIMITING DISTANCE

1.9 = L/H100% = MAX. UNPROTECT. OPENING (3.2.3.1.C)

10.5% = ACTUAL UNPROTECT. OPENING


0 HR = REQ. FRR (3.2.3.7)NON/C = REQ. CONSTRUCTION TYPE (3.2.3.7)NON/C = REQ. CLADDING TYPE (3.2.3.7)

NORTH-WEST FACE C

6m2 = EXPOSED BUILDING FACE 18.5m = LIMITING DISTANCE

1.7 = L/H100% = MAX. UNPROTECT. OPENING (3.2.3.1.C) 33% = ACTUAL UNPROTECT. OPENING

0 HR = REQ. FRR (3.2.3.7)NON/C = REQ. CONSTRUCTION TYPE (3.2.3.7) NON/C = REQ. CLADDING TYPE (3.2.3.7)

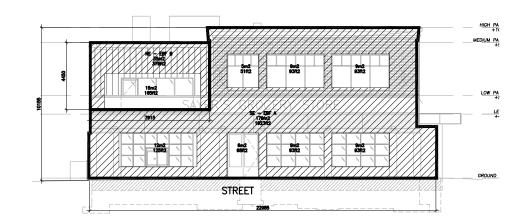

SOUTH-EAST FACE A

= EXPOSED BUILDING FACE

= LIMITING DISTANCE 2.26 = L/H

= MAX. UNPROTECT. OPENING (*3.2.3.10) = ACTUAL UNPROTECT. OPENINĠ = REQ. FRR (3.2.3.7) NON/C = REQ. CONSTRUCTION TYPE (3.2.3.7)


NON/C = REQ. CLADDING TYPE (3.2.3.7)

SOUTH-EAST FACE B


= EXPOSED BUILDING FACE = LIMITING DISTANCE

1.8 = L/H = MAX. UNPROTECT. OPENING (3.2.3.1.C) = ACTUAL UNPROTECT. OPENINĠ


= REQ. FRR (3.2.3.7) NON/C = REQ. CONSTRUCTION TYPE (3.2.3.7) NON/C = REQ. CLADDING TYPE (3.2.3.7)

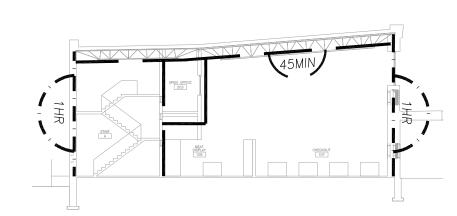

8 BUILDING SECTION - LIFE SAFETY 1:250

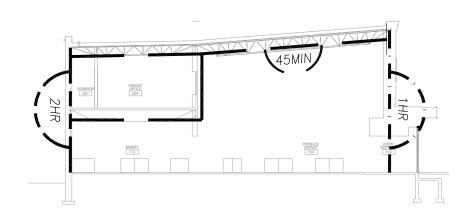

7 BUILDING SECTION - LIFE SAFETY 1:250

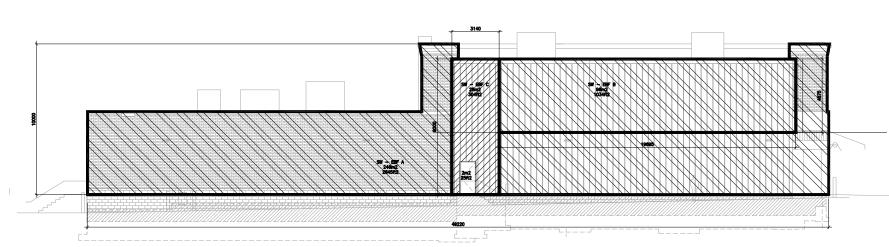

SOUTH-WEST FACE A

246m2 = EXPOSED BUILDING FACE = LIMITING DISTANCE

4.9 = L/H12% = MAX. UNPROTECT. OPENING (3.2.3.1.C)

0% = ACTUAL UNPROTECT. OPENINĠ 2HR = REQ. FRR (H)NON/C = CONSTRUCTION TYPE

= CLADDING TYPE

= EXPOSED BUILDING FACE

7.5m = LIMITING DISTANCE 4.0 = L/H= MAX. UNPROTECT. OPENING (3.2.3.1.C) = ACTUAL UNPROTECT. OPENING

2HR = REQ. FRR (3.2.3.7)NON/C = REQ. CONSTRUCTION TYPE (3.2.3.7) = REQ. CLADDING TYPE (3.2.3.7)

SOUTH-WEST FACE C


SOUTH-WEST FACE B

= EXPOSED BUILDING FACE = LIMITING DISTANCE

2.9 = L/H= MAX. UNPROTECT. OPENING (3.2.3.1.C) 7.1% = ACTUAL UNPROTECT. OPENING

1HR = REQ. FRR (3.2.3.7)

NON/C = REQ. CONSTRUCTION TYPE (3.2.3.7) NON/C = REQ. CLADDING TYPE (3.2.3.7)

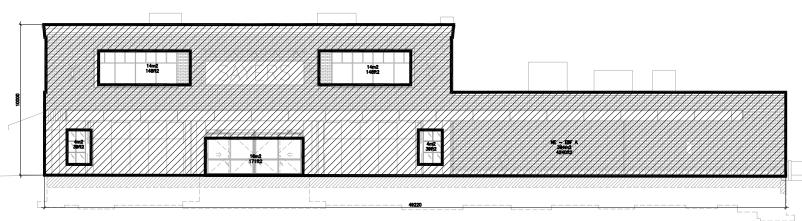

NORTH-EAST FACE A


= EXPOSED BUILDING FACE

= LIMITING DISTANCE 4.9 = L/H


= MAX. UNPROTECT. OPENING (3.2.3.10) = ACTUAL UNPROTECT. OPENING 13% 1HR = REQ. FRR (3.2.3.7)

= REQ. CONSTRUCTION TYPE (3.2.3.7) = REQ. CLADDING TYPE (3.2.3.7)

9 SPATIAL SEPERATION/EXPOSURE ANALYSIS 1:250

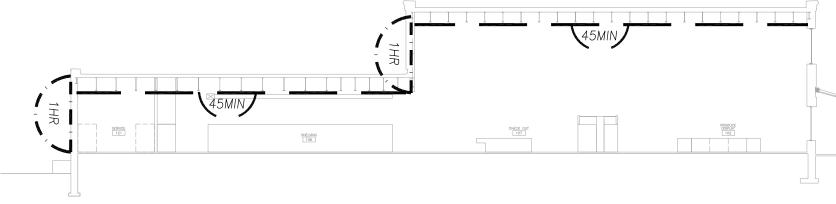

6 BUILDING SECTION - LIFE SAFETY 1:250

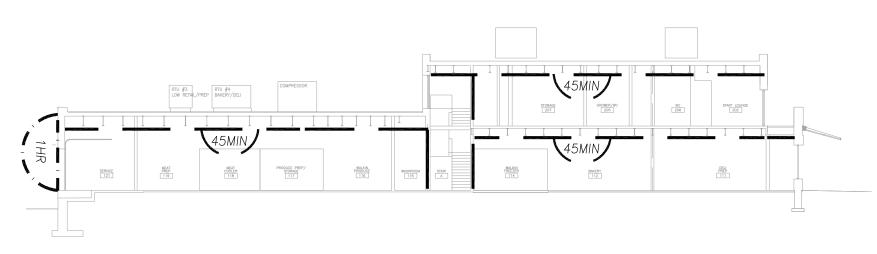

5 BUILDING SECTION - LIFE SAFETY 1:250

FIRE WATER STORAGE TANK SIZE (OBC 3.2.5.7 APPENDIX A = Q = KxVxS):

=K (WATER SUPPLY COEFFICIENT) 7,375 m3 = V (TOTAL BUILDING VOLUME)=S (TOTAL SPATIAL COEFFICIENT)

159,218L = Q (MIN. SUPPLY OF WATER)160,000L =PROPOSED SUPPLY OF WATER

STORAGE TANK CALCULATIONS

OBC - ENERGY EFFICIENCY (SB-10)

= PRESCRIPTIVE (2013 ANSI/ASHRAE/IES 90.1

CLIMATE ZONE = 6 (BANCROFT)

= MAINTAIN SLAB/WALL/FOOTING INSULATION PER FIGURE 5-1


STL CONNECT. = MAX 2% OF EXTERIOR AREA OR THERMAL BREAKS

BUILDING BASES = MAX. UN-INSULATED = 200mm


BUILDING ENVELOP REQUIREMENTS (CLIMATE ZONE 6, (A,B)(I-P)

ELEMENT	TYPE	ASSEMBLY MAX.	U-VALUE	INSULATION MIN. R-VALUE
ROOF	INS. ENTIRELY ABOVE DECK	U-0.029		R-35 ci
WALLS	STEEL FRAMED	U-0.044		R-13 + R-15 ci
WALLS	BELOW GRADE	C-0.050		R-20 ci
SLAB-ON-GRADE	EUNHEATED	F-0.459		R-15 for 48 in.
OPAQUE DOORS	SWINGING	U-0.45		
OPAQUE DOORS	NON-SWINGING	U-0.45		
FENESTRATION	NON-METAL FRAME	U-0.29	(MAX. SHGC 0.4, MIN.	VT/SHGC 1.10)
FENESTRATION	METAL FRAME: FIXED	U-0.38	"	
FENESTRATION	METAL FRAME: OPERABLE	U-0.45	"	
FENESTRATION	METAL FRAME: ENTRANCE DOOR	U-0.69	n	



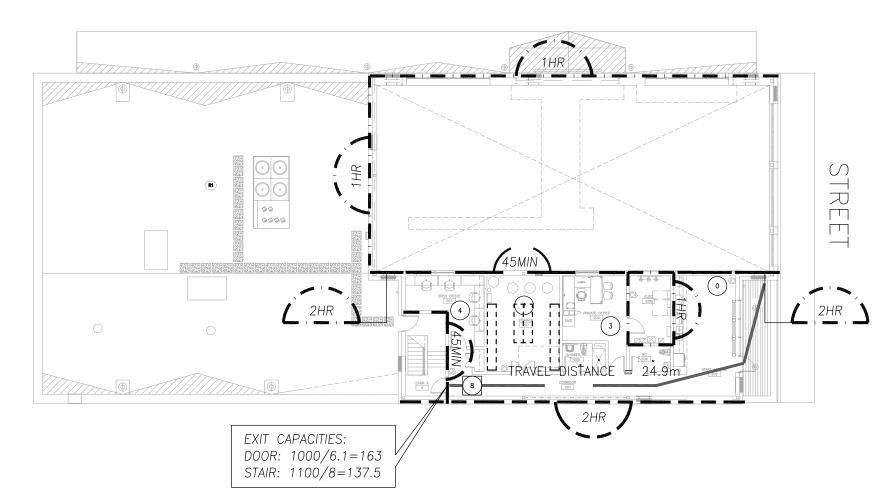

2 LEVEL 2 - LIFE SAFETY PLAN 1:250

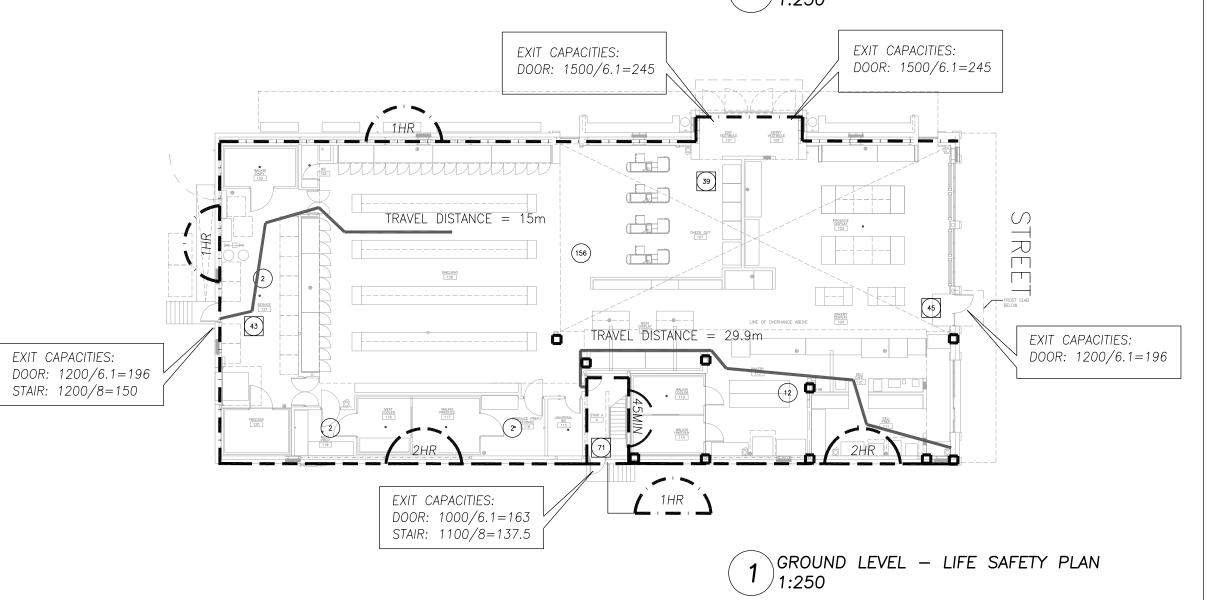

Contractor must check and verify all dimensions on the job, and report any discrepancies to the Architect before proceeding with the work. Do not scale this drawing.

REVISIONS AND ISSUES

DESCRIPTION	DATE	BY
ISSUED FOR SPA	210618	AB
REVISED SPA	210709	AB
REVISED SPA	210809	AB
ISSUED FOR TENDER	210824	AB
ISSUED FOR BUILDING PERMIT	210909	AB
REVISED TENDER	220124	AB
-	-	_
-	_	_
-	_	_
-	_	-
-	-	_
-	-	_
	ISSUED FOR SPA REVISED SPA REVISED SPA ISSUED FOR TENDER ISSUED FOR BUILDING PERMIT	ISSUED FOR SPA 210618 REVISED SPA 210709 REVISED SPA 210809 ISSUED FOR TENDER 210824 ISSUED FOR BUILDING PERMIT 210909

MJMA

maclennan jaunkalns miller architects

425 adelaide street west level 6 toronto ontario m5v 3c1 416 593 6796 www.mjmarchitects.com

TRITON ENGINEERING SERVICES LTD

229 BROADWAY, UNIT 1 ORANGEVILLE, ONTARIO, L9W 1K4 TEL 519 941 0330 FAX 519 941 1830

BLACKWELL STRUCTURAL ENGINEERS


134 PETER STREET, SUITE 1301 TORONTO, ONTARIO, M5V 2H2 TEL 416.593.5300 FAX 416.593.4840


SMITH + ANDERSON MECHANICAL AND ELECTRICAL ENGINEERS

1100 - 100 SHEPPARD AVENUE EAST TORONTO, ONTARIO, M2N 6N5 TEL 416.487.8151 -

SAYERS FOOD LIMITED

132 BURLEIGH STREET t: 705.656.4531 e: sayers@apsley.ca

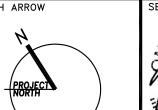

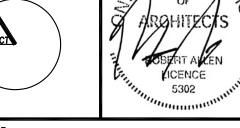

PROJECT TITLE

NEW SAYERS FOOD STORE BURLEIGH STREET, APSLEY

DRAWING TITLE


LIFE SAFETY & CODE

AS SHOWN

JANUARY 24, 2022

PROJECT NUMBER

2102 DRAWING NUMBER

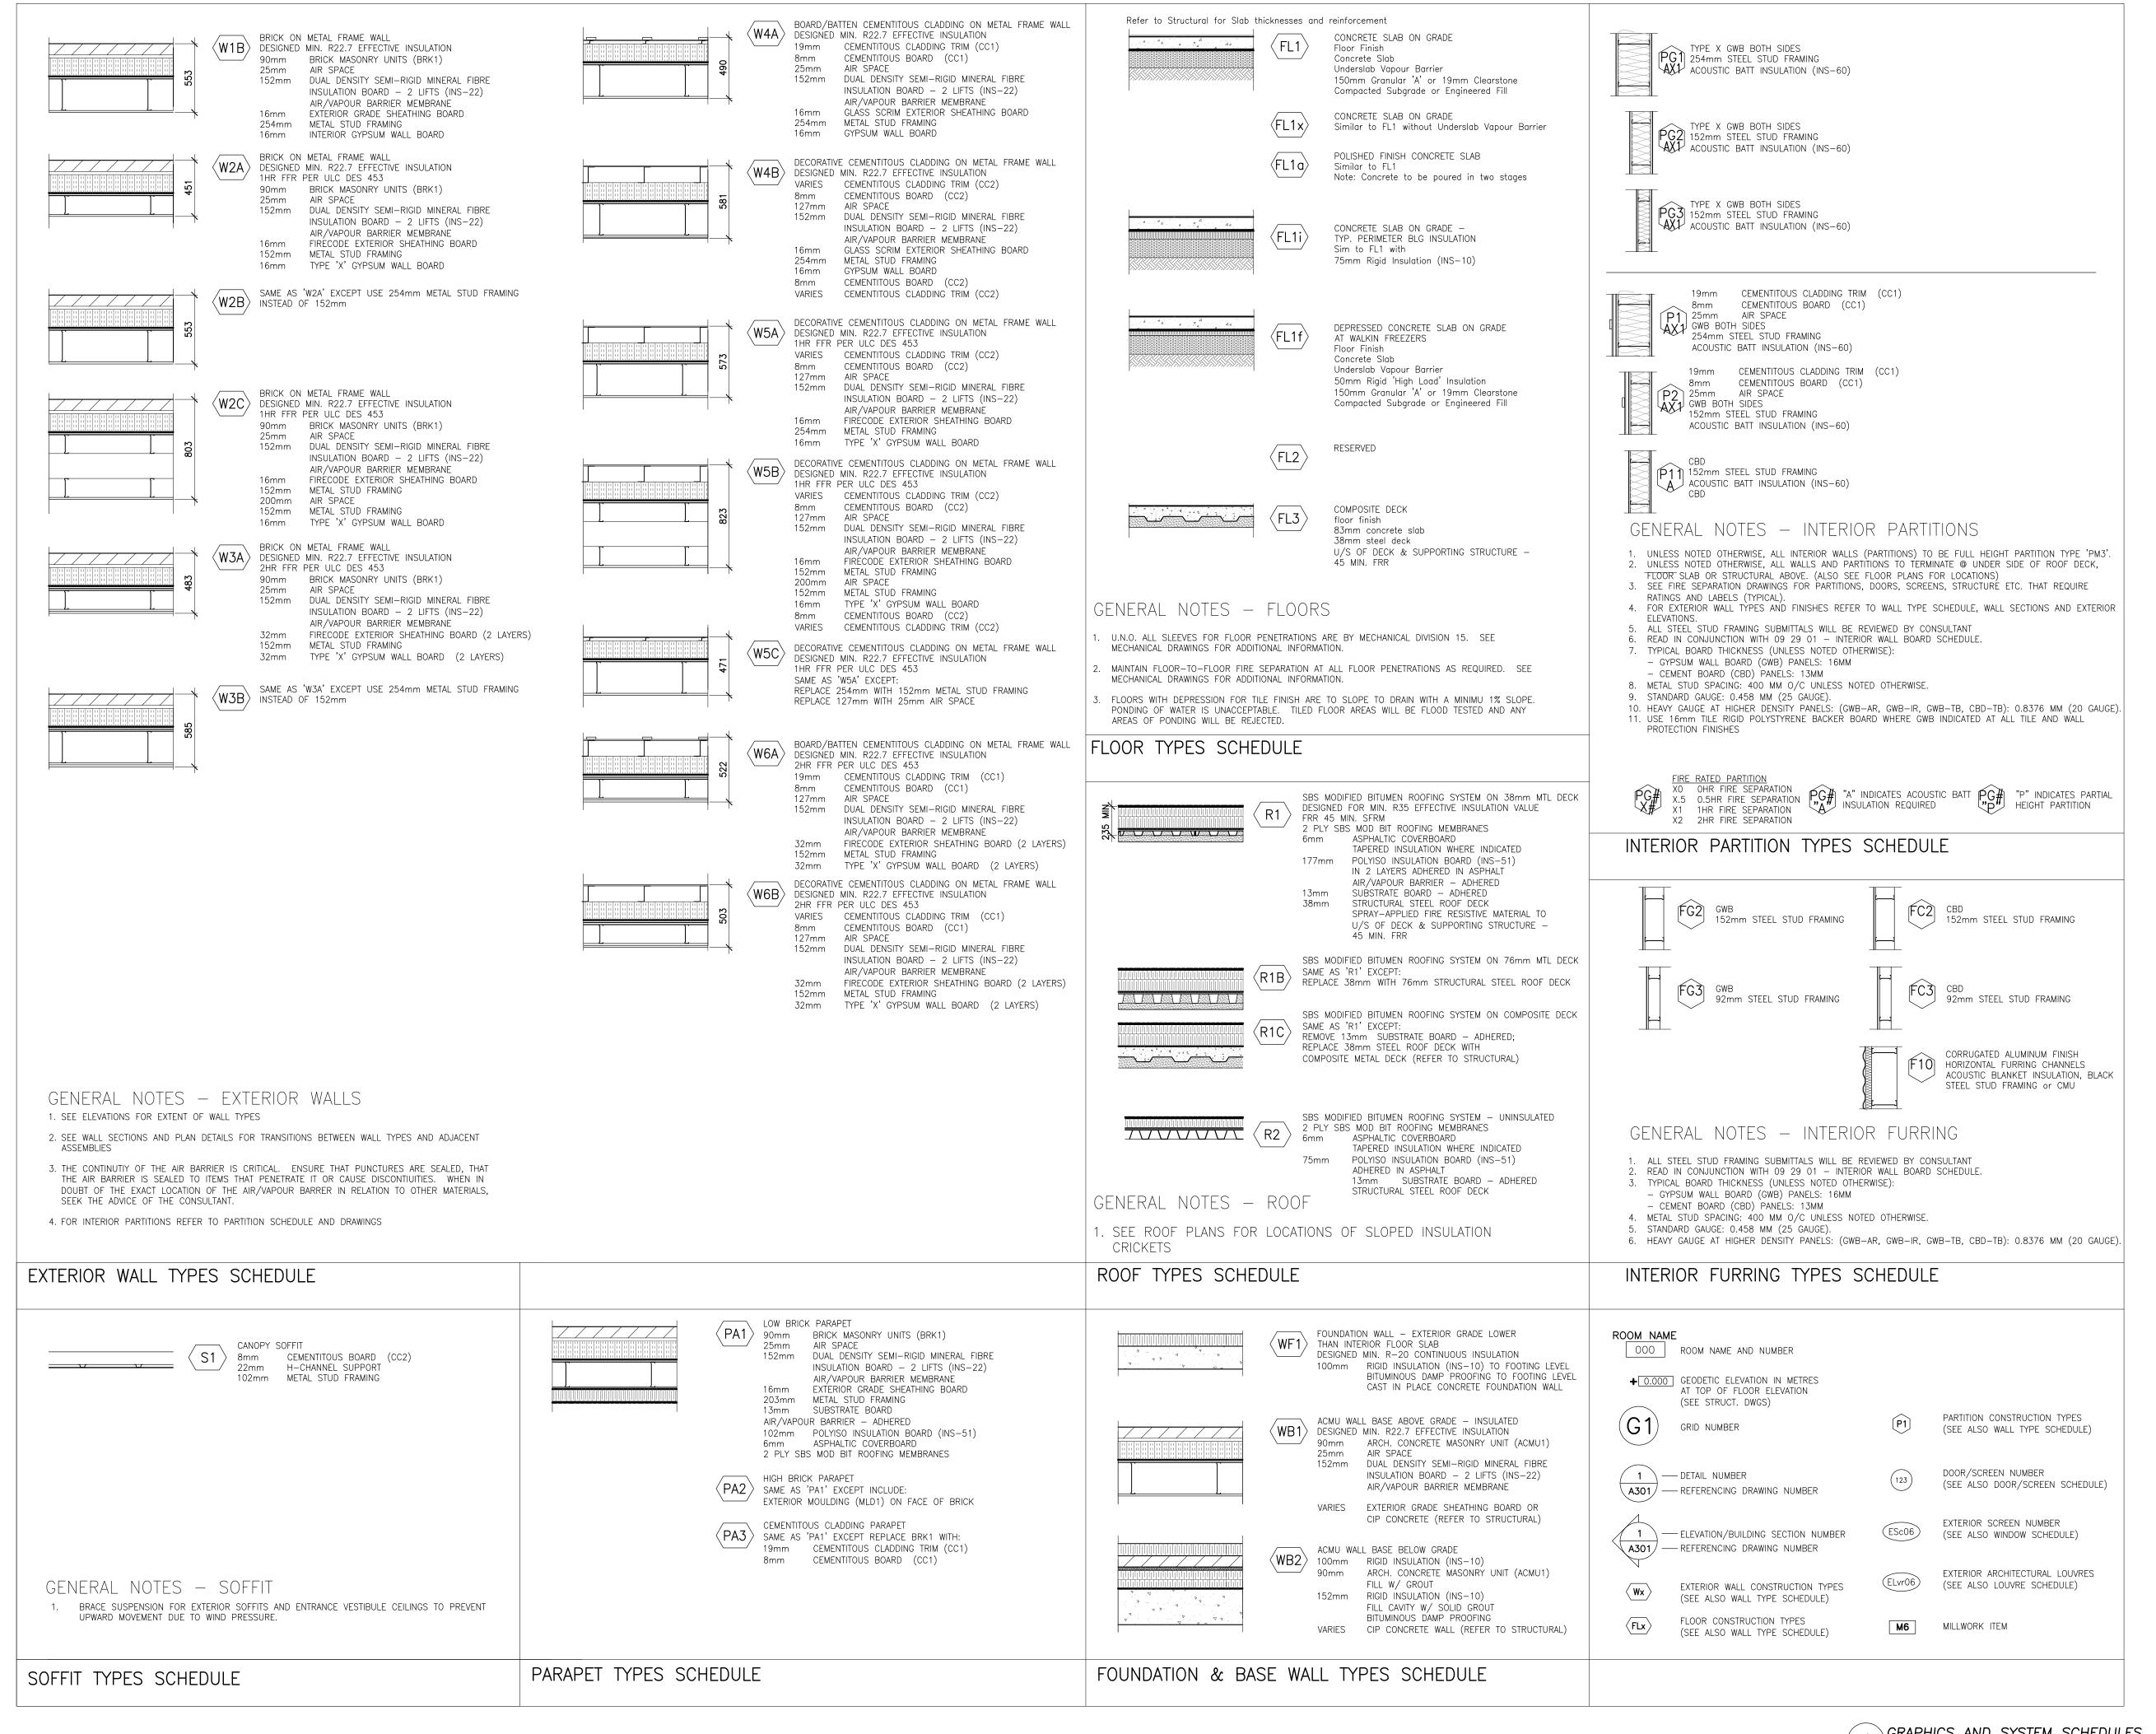

GRAPHICS AND SYSTEM SCHEDULES

Contractor must check and verify all dimensions on the job, and report any discrepancies to the Architect before proceeding with the work. Do not scale this drawing.

REVISIONS AND ISSUES DESCRIPTION DATE ISSUED FOR SPA 210618 REVISED SPA 210709 210809 REVISED SPA ISSUED FOR TENDER 210824 ISSUED FOR BUILDING PERMIT 210909 REVISED TENDER 220124

MJMA

maclennan jaunkalns miller architects

425 adelaide street west level 6 toronto ontario m5v 3c1 416 593 6796 www.mjmarchitects.com

TRITON ENGINEERING SERVICES LTD CIVIL ENGINEERS

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BLACKWELL STRUCTURAL ENGINEERS


134 PETER STREET, SUITE 1301 TORONTO, ONTARIO, M5V 2H2 TEL 416.593.5300 FAX 416.593.4840

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1100 - 100 SHEPPARD AVENUE EAST TORONTO, ONTARIO, M2N 6N5 TEL 416.487.8151

SAYERS FOOD LIMITED

132 BURLEIGH STREET t: 705.656.4531 e: sayers@apsley.ca

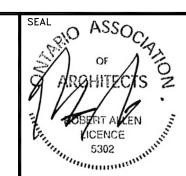

PROJECT TITLE

NEW SAYERS FOOD STORE BURLEIGH STREET, APSLEY

DRAWING TITLE

ASSEMBLIES & FLOOR TYPES

JANUARY 24, 2022

PROJECT NUMBER 2102

DRAWING NUMBER

Sayers G	Store Grocery Store				August 25, 20
Specificatio					January 17, 2021
SECTIONS Specificati	ions Section	SPECIFICATIONS AND SYST		Product(s) Basis of Design	General Locations / Notes / Contacts
Division	03 - Concrete			basis of besign	
03 10 00 03 20 00	Concrete Formwork(Structural) Concrete Reinforcement (Structural)				
03 30 00	Cast-in-Place Concrete (Structural)				
03 35 00	Concrete Floor Finishing Clear floor sealer		CSLR	W.R. Meadows Inc. 'VOCOMP-30'.	Concrete slabs with ro applied finishes.
03 35 03	Non-slip stair inserts Polished Concrete			Sika Canada Inc. 'Florseal WB 25'. Wooster 'Supergrit Type 630A	Steel pan and concrete exit stairs.
03 35 03	Polished Concrete Floor Finish	System	PCFL	Retroplate Canada 'Retroplate'.	Retail space.
		Hardener		W.R. Meadows 'Induroshine'. Retroplate Canada 'Retro-Plate 99'	
		Finish enhancer		W.R. Meadows 'Liqui-hard'. Retroplate Canada 'RetroGuard'	
		Aggregate exposure /		W.R. Meadows 'Bellatrix' Fine aggregate exposure: CFCA Class B. Finish: Natural finish.	Allow for three mock-up areas to determine final grind
		depth of grind		Polish level: Level 2; semi-gloss finish.	and polish.
Division 04 05 00	04 - Masonry Masonry Procedures				
		Coursing design:		Brick masonryunits: 1/2 Running Bond Architectural concrete masonry units: 1/3 Running Bond	
04 05 13	Mortar and Grout for Masonry	Mortar colour:		Uniform grey colour (non-pigmented). Pigmented mortar to match colour of adjacent masonry units / brick.	
04 05 19	Masonry Reinforcement and				
	Connectors	Provide as required		Masonry reinforcing and anchorage Connectors for anchorage of masonry veneer to support assemblies Horizontal reinforcing for masonry block wall and partition assemblies	
04 05 23	Masonry Accessories	Provide as required		Movement (costrol) joint filler Weep vents Cavity drainage material Masonry through wall membrane flashing Cavity firestopping materials Deflection space filler at top of partitions. Preformed movement (control) joint fille Silp-sheet membrane for steel filler bearing	
04 21 00	Brick Masonry Units Brick masonry units		BRK1	Thames Valley Brick and Tile Palmetto Brick 'Riviera' Size: Modular - 92mm x 57mm x 193mm	Tharnes Valley Brick: Sean Costello sean@tharnesvalleybrick.com
04 22 23	Architectural Concrete Masonry Units Architectural concrete masonry unit	Sizes (depth x height x length)	ACMU1	90mm x 190mm x 390mm.	Exterior cavity wall assemblies - base.
		Manufacturer / Product		Shouldice 'Architectural Stone Exacutive Grey Permanon Grup Inc 'Noble Architectural Block' Richvale York Cambridae Series'. Ground Face	
		Texture Profile		Smooth polished face with no bevel for any face exposed to view. Buffed	
	05 - Metals				
05 12 00 05 21 00	Structural Steel (Structural) Steel Joist Framing (Structural)				
05 31 00 05 41 13	Metal Deck (Structural) Load-Bearing Cold-Formed Metal Framing				
	Load-Bearing Cold-Formed Metal Framing				Exterior wall amd sofit assemblies
05 50 00	Metal Fabrications				Material / Primer / Top coat / Notes
	Section includes but is not limited to:	Exterior		Loose steel lintels Metals related to exterior overhead coiling or sectional doors	Steel, galvanized / DTM / HP Acrylic Steel, galvanized / DTM / HP Acrylic
				Bollards Roof Ladders and safety cages	Steel, galvanized / DTM / HP Acrylic Steel, galvanized / DTM / HP Acrylic Steel, galvanized / DTM / HP Acrylic
		Interior		Exit Stairs and Utility Stairs, including rails and guards	Steel / DTM / WB Epory
				Metals required to support coiling metal doors, shutters and grilles Pipe rails Gratings	Steel / DTM / WB Epoxy Steel / DTM / WB Epoxy Steel, galvanized
				Metal support framing for cabinetry, casework, and counters Items indicated as miscellaneous (misc.) metal or steel	Steel / DTM / WB Epoxy (where exposed to view)
		Applied coatings		DTM grade prmer: Sherwin Williams B66W1 or B66W310 DTM Primer PPG Pitt-Tect 90-712 or 90-912 Series DTM Primer.	
05 51 00	Prefabricated Metal Stairs and Ladders			Field applied top coats in accordance with Section 09 91 00	
opport Section		Acceptable Products		FS Industries 'Series FS' or Skyline Group 'Series 7001' Aluminum	Wall-mounted high rocf access ladder
Division	06 - Wood, Plastics, and Composit	es			
06 10 53 06 40 00	Rough Carpentry Architectural Woodwork				
	Section includes but is not limited to:			Standing and running trim. Cabinetry and hardware.	
				Cabinetry and hardware. Plastic laminate countertops. Solid surfacing countertops and fabrications.	
				Wood ceilings panels Factory and site finishing of architectural woodwork.	
		Wood Materials		, and an analysis of the state	
		Oriented strand board Hardwood veneer		19 mm thick / Clear finish Species TBD/ Grade AA / Rift or Quarter cut / Book matched and balanced.	
		Clear transparent finish		Clear finish / soid wood edgebanding •10° sheen conversion vinyl varnish seal and topcoat; AWMAC system #5 with custom filled finish.	
		Plastic and Composite High Pressure Decorative	PLAM1 PLAM2	Pionite Decorative Surfaces / suede finish / Angel White Dupont 'Fenix NTM' / matte finish / Colour TBD Abet Laminati Polaris' / matte finish / Colour TBD	Back of house millwork Feature and Front of house millwork
		Edgebanding		Pionite Decorative Surfaces 'MelCor II'	Solid colour through decorative laminates (edgebanding at exposed and semi-exposed panel edges)
		Solid surfacing sheet / Engineered stone	SSF1	CaesarStone / 20mm / Colour: 406 Clear Skies or 405 Midday or 4043 Primordia	POS at Bistro Café; Kitchen Counter in Staff area
06 40 13	Exterior Architectural Woodwork	Pressure Treated Wood Decking	WDS-PT	2x6 Pressure Treated Deck Boards c/w Semi Transparet Stain MicroPro Siema 2x6 or equivalent	Outdoor roof deck
		Decking			
Division	07 - Thermal & Moisture Protection	1			

SECTIONS	ons Section	SPECIFICATIONS AND SYST		 Product(s)	General Locations / Notes / Contacts
Specification	Prefinished steel flashing		Actonym	Basis of Design Winimum thickness:	General Locations / Notes / Contacts
				0.61 mm (0.0239') (24 gauge), colour T3D.	
07 81 00	Sprayed Fire-Resistive Materials (SFRM)				
+	A: Contractor's option use either type of spr Cementitious Fireproofing (Wet-Mix)	ayod fire resistive materia's speci	fied, but use	only one type throughout the Work.	
	Centertibode Freproofing (vvat-wilx)	Standard density		AD Fire Protection Systems Southwest Firsproofing Type 5GP'. GCP Applied Technologies 'Monokote MK-5'.	
_		Medium density		Isolatek International 'Cafco 300 A/D Fire Protection Systems Inc. 'Southwest Fireproofing Type 5MD'.	
				GCP Applied Technologies 'Z-106 G'. Isolatek International 'Cafco 400'.	
	Mineral-Fibre Freoroofing (Dry-Mix)			AD Fire Protection Systems A/D Type FP'. Isolatek International 'Cafco Blaze-Shield DCF'.	
07 84 00	Joint Firestopping and Smoke Seals			Isolatek International 'Cafco Blaze-Shield II'.	
07 92 00	Joint Sealants Acceptable manufacturers			•BASF	
				●DOWSIL ●Momentive	
				Sika Tremco	
	Exterior sealants	Joints in vertical surfaces		•Sika 'Sikasil WS-290'	
1	Interior sealants	Hcrizontal trafficable joints General		Sika 'Sikaflex 15LM Sika 'Sikaflex 1A'	
	THOTO STANDING	Movement joints in vertical surfaces		◆Sika 'Sikaflex 15LM'	
		Mildew resistant one part silicone sealant		◆Sika 'Sikasil GP'	
	Scredule				
		Exterior			Perimeters of exterior openings Movement and control joints
					 Exterior joints between masonry and insitu concr Exterior joints in horizontal wearing surfaces. Perimeters of louvres.
					Perimeters of nechanical and electrical penetrat
		Interior			Movement and control joints
					 Interior control and expansion joints in floor and surfaces.
					 Perimeters of exterior door and window frames. Exposed interior control joints in gypsum boarc.
1		Interior - mildew resistant			Millwork junctions with walls Perimeter joints of wet fixtures
					Counter/wall junctions at countertops Food preparation areas
	08 - Openings Steel Doors and Frames (HM)				
	Acceptable manufacturers			All Steel Doors 2000 Ltd. Apex industries inc.	
				Artek Door (1985) Ltd. Daybar Industries Ltd.	
				Fleming-Beron Coor Products. Gensteel Doors.	
				M.J. Daley Manufacturing Co. Ltd. Ghanahan's Manufacturing Ltd.	
				Trillium Steel Doors Limited. Wision Hollow Metal Limited.	
+	Steel doors and panels	Exterior and insulated doors		Face sheets fabricated from 1.34 mm (C.053") (16 gauge) stee.	
				Steel stiffered ccre. Longizudinal edges continuously welded the full height of the door, filled and	
				ground smooth with no visible seams. ■Insulation core: Folyisccyanurate.	
+		Irterior and non-insulated		◆Face sheets fabricated from 1.06 mm (C.042") (18 gauge) stee	
1		doors and panels			
	Frames			Honeycomb core. Longitudinal edges mechanically interlocked. 1.34 pm (0.053): (16 gauge) steel.	
	Frames	Exterior and thermally proken frames		Longitudinal edges mechanically interlocked. 1.34 mm (0.053") (16 gauge) steel.	
	Frames	Exterior and thermally proken frames		 Longitudinal edges mechanically interlocked. 	
08 11 13	Finish Fire Rated Glass and Framing	Exterior and thermally proken frames		-conjudinal edges medstarically interlocked -1.34 mm (0.053"; (16 gauge) steel -1.34 mm (0.053"; (16 gauge) steel	
08 11 13	Finish	Exterior and thermally proken frames			Connor Martir Tat .116-312-1059
08 11 13	Fire Rated Glass and Framing Acceptable manuracturer Framing	Exterior and thermally proken frames		Longitudinal edges medstarically interfaced. 1.34 mm (0.053"; (16 gauge) steel. 1.34 mm (0.053"; (16 gauge) steel. Minimum Galvarneal coating designation ZF / 20 (A40). Technical Glass Producs (TGP) TCP "Fireframes Designer Series" fre-rated narrow profile framing.	
08 11 13	Fire Rated Glass and Framing Acceptable manuracturer Framing Fire Rated Framing Fire Rated Glass and Framing Fire Rated Glass and Framing	Exterior and thermally proken frames interior frames		Longitudinal edges medianizativinterlocked 1.34 mm (0.053"; (16 gauge) steel. 1.34 mm (0.053"; (16 gauge) steel. Minimum Galvarneal coating designation ZF'20 (A40). Technical Glass Producs (TGP) TCP "Fireframes Designer Series" fre-rated narrow profile framing Powde" coating to match colour CC1	
08 11 13	Fire Rated Glass and Framing Acceptable manuracturer Framing Framing Fire Rated Glass and Framing Acceptable manuracturer Glass	Exterior and thermally proken frames		Longitudinal edges medstarically interfaced. 1.34 mm (0.053"; (16 gauge) steel. 1.34 mm (0.053"; (16 gauge) steel. Minimum Galvarneal coating designation ZF / 20 (A40). Technical Glass Producs (TGP) TCP "Fireframes Designer Series" fre-rated narrow profile framing.	
08 11 13	Fire Rated Glass and Framing Acceptable manuracturer Framing Framing Firish Glass Rating Steel Traffic Doors	Exterior and thermally proken frames interior frames			Tai: 416-812-1059
	Fire Rated Glass and Framing Acceptable manuracturer Framing Firsh Glass Rating	Exterior and thermally proken frames interior frames		4. Org. United to the second secon	
	Fire Rated Glass and Framing Acceptable manuracturer Framing Framing Firish Glass Rating Steel Traffic Doors	Exterior and thermally proken frames interior frames		4.0 rgiudinal edges medianizativinterlocked 1.34 mm (0.053"; (16 gauge) steel. 4.134 mm (0.053"; (16 gauge) steel. 4.134 mm (0.053"; (16 gauge) steel. 4.134 mm (0.053"; (16 gauge) steel. 5.134 mm (0.053"; (16 gauge) steel. 6.134 mm Galvarneal coating designation ZF (20 (A40)). 7.134 mm Galvarneal coating designation ZF (20 (A40)). 8.134 mm Galvarneal coatin	Tet. 4.18-3.12-′.059 Bruce Nakamura
	Fire Rated Glass and Framing Acceptable manuracturer Framing Framing Firish Glass Rating Steel Traffic Doors	Exterior and thermally proken frames interior frames		4.0 mg/mulinal edges medianizativinterlocked 1.34 mm (0.053"; (16 gauge) steel. 4.134 mm (0.053"; (16 gauge) steel. 4.134 mm (0.053"; (16 gauge) steel. 4.134 mm Galvarneal coating designation ZF / 20 (A40). Technical Glass Products (TGP) TCP*Fireframes Designer Series' fire-rated narrow profile framing Powder coating to match colour CC1 TGP*FireLite' 5 mm (3/16") fire-rated glazing, Standard Grade. 45 minutes Senneca Holdings - Chase Doors, Series: Durulite Retailsr Bumpers: Tear Drop 40 minute 40 minute 41 minute 42 minute 43 minute 44 minute 45 minute 46 minute 47 minute 48 minute 49 minute 49 minute 49 minute 40 minute 41 minute 41 minute 42 minute 43 minute 44 minute 45 minute 45 minute 45 minute 45 minute 46 minute 47 minute 48 minute 48 minute 49 minute 40 minute 40 minute 40 minute 41 minute 42 minute 43 minute 44 minute 44 minute 45 minute 46 minute 47 minute 48 minute	Tel: 418-312-′ 059 Bruce Nakamura
	Fire Rated Glass and Framing Acceptable manuracturer Framing Framing Firish Glass Rating Steel Traffic Doors	Exterior and thermally proken frames interior frames			Tel: 418-312-′ 059 Bruce Nakamura
	Fire Rated Glass and Framing Acceptable manuracturer Framing Framing Firish Glass Rating Steel Traffic Doors	Exterior and thermally proken frames interior frames	WED1	Second	Tel: 418-312-′ 059 Bruce Nakamura
08 13 00	Fire Rated Glass and Framing Acceptable manuracturer Acceptable manuracturer Froming Frosin Glass Rating Steel Traffic Doors Interior traffic doors	Exterior and thermally proken frames interior frames	WED1	1,34 mm (0.053"; (16 gauge) steel. 1,34 mm (0.053"; (16 gauge) steel. 1,34 mm (0.053"; (16 gauge) steel. Minimum Galvarneal coating designation ZF / 20 (A40). Technical Glass Producs (TGP) TCP 'Fireframes Designer Series' fre-rated nervow profile framing Powder coating to match colour CC1 TGP 'FireLite' 5 mm (3/16") fire-rated glazing, Standard Grade. 45 minutes Senneca Holdings - Chase Doors, Series' Durulite Retailsr Senneca Holdings - Chase Doors, Series' Durulite R	Bruce Nakamura brakamura@senneca.com •Front entry door Lepage Villiwork
08 13 00	Fire Rated Glass and Framing Acceptable manuracturer Acceptable manuracturer Froming Frosin Glass Rating Steel Traffic Doors Interior traffic doors	Exterior and thermally proken frames interior frames	WED1	1,34 mm (0.053"; (16 gauge) steel. 1,34 mm (0.053"; (16 gauge) steel. 1,34 mm (0.053"; (16 gauge) steel. Minimum Galvarneal coating designation ZF / 20 (A40). Technical Glass Producs (TGP) TCP 'Fireframes Designer Series' fre-rated nerrow profile framing Powder coating to match colour CC1 TGP 'FireLite' 5 mm (3/16") fire-rated glazing, Standard Grade. 45 minutes Senneca Holdings - Chase Doors, Series' Durulite Retailer Bumpers: Tear Drop Window Package: Standard Single Alumnum Lower Hinge Guard Fastaerers' Steel Jamb Gaskits-Ful Seals Standard 2" Linnar Hinner Sael - 186" x 90 Jennes Lepage Millwork 'Craftsman' Single Door with Right Side - Ight and Rectangular Transom Infill: Door Glass Panel Infill Sidelies: Glass Infill Solder Sael Holder Sales Infill Sidelies: Glass Infill Door and Frame Finish'. Mar ogany - Rawhide, Sacdle, Natural; Charcoal Cannot be the standard of the st	Bruse Nakamura brakamura@senneca.com Front entry door Lepage Villiwork jirr @halburtonlumber.com
08 13 00	Fire Rated Glass and Framing Acceptable manuracturer Acceptable manuracturer Froming Frosin Glass Rating Steel Traffic Doors Interior traffic doors	Exterior and thermally proken frames interior frames	WED1		Bruce Nakamura brakamura@senneca.com •Front entry door Lepage Villiwork
08 13 00 08 14 00	Fire Rated Glass and Framing Acceptable manuracturer Acceptable manuracturer Framing Firsh Glass Rating Steel Traffic Doors Interior traffic doors Wood Doors Wood entry door and sidelight	Exterior and thermally proken frames interior frames	WED1	Longitudinal edges medicalizativinterlocked 1.34 mm (0.053"; (16 gauge) steel. 1.34 mm (0.053"; (16 gauge) steel. Minimum Galvarneal coating designation ZF / 20 (A40). Technical Glass Producs (TGP) TCP 'Fireframes Designer Series' fre-rated nervow profile framing Powder coating to match colour CC1 TGP 'FireLite' 5 mm (3/16") fire-rated glazing, Standard Grade. 45 minutes Senneca Höldings - Chase Doors, Series: Durulite Retailsr Bumpers: Tear Drop Window Package: Standard Single Alumnum Lower Hinge Guard Fasterers: Steel Jamb Gaskets Fül Seelis Standard 2" Linner Hinner Seel 186" y 90 fearness Lepage Millwork 'Craftsman' Single Door with Right Side Light and Redangular Transom Infili: Door Glass Panel Infili Color and Frame Finish: Mar ogany – Rawhide, Sacdle, Natural, Charocal Hardware: Baldvin Collection – Classic Sill Anodzied Brorze, brass or Aluminum or similar	Bruse Nakamura brakamura@senneca.com Front entry door Lepage Villiwork jirr @halburtonlumber.com
08 13 00	Fire Rated Glass and Framing Acceptable manuracturer Acceptable manuracturer Froming Frosin Glass Rating Steel Traffic Doors Interior traffic doors	Exterior and thermally proken frames interior frames	WED1	Series	Bruse Nakamura brakamura@senneca.com Front entry door Lepage Villiwork jirr @halburtonlumber.com
08 13 00 08 14 00	Fire Rated Glass and Framing Acceptable manuracturer Acceptable manuracturer Framing Firsh Glass Rating Steel Traffic Doors Interior traffic doors Wood Doors Wood entry door and sidelight	Exterior and thermally proken frames interior frames	WED1	Surgiudinal edges medianizativinterlocked 1.34 mm (0.053"; (16 gauge) steel. 1.34 mm (0.053"; (16 gauge) steel. Minimum Galvarneal coating designation ZF / 20 (A40). Technical Glass Producs (TGP) TCP 'Fireframes Designer Series' fre-rated nerrow profile framing Powder coating to match colour CC1 TGP 'FireLite' 5 mm (3/16") fire-rated glazing, Standard Grade. Sanneca Holdings - Chase Doors, Series: Durulite Retailer Senneca Holdings - Chase Doors, Series: Durulite Retail	Bruse Nakamura brakamura@senneca.com Front entry door Lepage Villiwork jirr @halburtonlumber.com
08 13 00 08 14 00	Fire Rated Glass and Framing Acceptable manuracturer Acceptable manuracturer Framing Firsh Glass Rating Steel Traffic Doors Interior traffic doors Wood Party door and sidelight Overhead Sectional Doors Automatic Silding Entrance Doors	Exterior and thermally proken frames interior frames Fire-rated steel framing Fire-rated glass		Longitudinal edges medicalizativinterlocked 1.34 mm (0.053"; (16 gauge) steel. 1.34 mm (0.053"; (16 gauge) steel. Minimum Galvarneal coating designation ZF / 20 (A40). Technical Glass Producs (TGP) Top' Fireframes Designer Series' fre-rated narrow profile framing Powder coating to match colour CC1 TGP FireLite' 5 mm (3/16") fire-rated glazing, Standard Grade. 45 minutes Senneca Holdings - Chase Doors, Series: Durulite Retailsr Bumpers: Tear Drop Window Package: Standard Single Alumnum Lower Hinge Guard Fasterers: Steel Jamb Gaskets Fül Seals Standard 2" Linner Hinner Sael 160' y 90 Henrees Lepage Millwork 'Craftsman' Singles: Glass Hall Sidelies: Glass Hall Sidelies: Glass Hall Coor and Frame Finish: Mar ogany – Rawhide, Sacdle, Natural, Charocal Hardware: Baldwin Collection – Classic Sill Anodzied Bronze, brass or Aluminum or similar Refer to Section 11 13 19 - Loading Dock Accessor es Refer to Torwing A700 Overhead motorized insulate: Steel sectional doors w/ acrylic glazing Coverhead motorized insulate: Steel sectional doors w/ acrylic glazing Coverhead motorized insulate: Steel sectional doors w/ acrylic glazing Coverhead motorized insulate: Steel sectional doors w/ acrylic glazing Coverhead motorized insulate: Steel sectional doors w/ acrylic glazing Coverhead motorized insulate: Steel sectional doors w/ acrylic glazing Coverhead motorized insulate: Steel sectional doors w/ acrylic glazing Coverhead motorized insulate: Steel sectional doors w/ acrylic glazing Coverhead motorized insulate: Steel sectional doors w/ acrylic glazing Coverhead motorized insulate: Steel sectional doors w/ acrylic glazing	Bruce Nakamura bnakamura@renneca.com •Front entry door Lepage Millwork jiii @halbuttorlumber.com
08 13 00 08 14 00	Fire Rated Glass and Framing Acceptable manuracturer Acceptable manuracturer Framing Firsh Glass Rating Steel Traffic Doors Interior traffic doors Wood Party door and sidelight Overhead Sectional Doors Automatic Silding Entrance Doors	Exterior and thermally proken frames interior frames Fire-rated steel framing Fire-rated glass		1,34 mm (0.053"; (16 gauge) steel. 1,34 mm (0.053"; (16 gauge) steel. 1,34 mm (0.053"; (16 gauge) steel. Minimum Galvarneal coating designation ZF / 20 (A40). Technical Glass Producs (TGP) TCP 'Fireframes Designer Series' fre-rated nerrow profile framing Powder coating to match colour CC1 TGP 'FireLite' 5 mm (3/16") fire-rated glazing, Standard Grade. 45 minutes Senneca Holdings - Chase Doors, Series: Durulite Retailer Senneca Holdings - Chase Doors, Series Pour Durulite Retailer Senneca Holdings - Chase Doors, Series Pour Durulite Retailer Senneca Holdings - Chase Doors, Series Pour Durulite Retailer Senneca Holdings - Chase Doors, Series Pour Durulite Retailer Senneca Holdings - Chase Doors, Series Pour Durulite Retailer Senneca Holdings - Chase Doors, Series Pour Durulite Retailer Senneca Holdings - Chase Doors, Series Pour Durulite Retailer Senneca Holdings - Chase Doors, Series Pour Durulite Retailer Senneca Holdings - Chase Doors, Series Pour Durulite Retailer Senneca Holdings - Chase Doors, Series Pour Durulite Retailer Senneca	Bruce Nakamura brakamura@senneca.com •Front entry door Lepage Millwork jirr @haliburtonlumber.com https://www.lepagemillwork.com/en-ca/
08 13 00 08 14 00	Finish Fire Rated Glass and Framing Acceptable menuracturer Acceptable menuracturer Framing Firish Glass Reting Steel Traffic Doors Interior traffic doors Interior traffic doors Wood entry door and sidelight Overhead Sectional Doors Automatic Sliding Entrance Doors Automatic Sliding Door	Exterior and thermally proken frames interior frames Fire-rated steel framing Fire-rated glass	SED1	Sense House Hou	Bruce Nakamura brakamura@senneca.com Front entry door Lepage Millwork jiii @halburtonlumber.com https://www.lepagemillwcrk.com/en-ca/ Exterior - Refer to drawing A710. Nick Gaudet ngaude@hortonontarie.com 905-331-7491 x122
08 13 00 08 14 00 08 3313	Fire Rated Glass and Framing Acceptable manuracturer Acceptable manuracturer Framing Firsh Glass Rating Steel Traffic Doors Interior traffic doors Wood Party door and sidelight Overhead Sectional Doors Automatic Sliding Entrance Doors Automatic Sliding Door	Exterior and thermally proken frames interior frames Fire-rated steel framing Fire-rated glass		Segretary Segretary	Bruce Nakamura bnakamura@senneca.com Front entry door Lepage Millwork jirr @naiburtoniumber.com https://www.lepagemillwork.com/en-ca/
08 13 00 08 14 00 08 3313	Finish Fire Rated Glass and Framing Acceptable menuracturer Acceptable menuracturer Framing Firish Glass Reting Steel Traffic Doors Interior traffic doors Interior traffic doors Wood entry door and sidelight Overhead Sectional Doors Automatic Sliding Entrance Doors Automatic Sliding Door	Exterior and thermally proken frames interior frames Fire-rated steel framing Fire-rated glass	SED1	1,34 mm (0.053"; (16 gauge) steel. 1,34 mm (0.053"; (16 gauge) steel. 1,34 mm (0.053"; (16 gauge) steel. Minimum Galvarneal coating designation ZF / 20 (A40). Technical Glass Producs (TGP) TCP 'Fireframes Designer Series' fre-rated nerrow profile framing Powder coating to match colour CC1 TGP 'FireLite' 5 mm (3/16") fire-rated glazing, Standard Grade. 45 minutes Senneca Holdings - Chase Doors, Series' Durulite Retailsr Summum Lower Hinge Guard Fasterers' Steel Jamb Seals Standard 2 Seals Door with Right Side Light and Redangular Transom Infili: Door Glass Panel Infili Sidelies Glass Infili Refer to Section 11 13 19 - Loading Dock Accessor es Refer to Section 11 13 19 - Loading Dock Accessor es Refer to Section 11 13 19 - Loading Dock Accessor es Refer to Torwing A700 Overhead mandrard insulates steel sectional doors w/ Aerylic glazing Horton Automatics, Proslide Series 2021', sliding door system with electric beld drive operator Door goe 316 - SX & SO Optest I - nork 7 motor presence detectors and m/s manual locking Finish': PPG Duranar XI. custom colour. Alumicor 'Them gwill Twy200 Series', capped and Structural Silicone	Bruce Nakamura bnakamura@senneca.com Front entry door Lepage Millwork jiii @halburtonlumber.com https://www.lepagemillwcrk.com/en-ca/ Exterior - Refer to drawing A710. Nick Gaudet ngaude@hortonoritarie.com 905-331-7491 x122
08 13 00 08 14 00 08 3313	Finish Fire Rated Glass and Framing Acceptable menuracturer Acceptable menuracturer Framing Firish Glass Reting Steel Traffic Doors Interior traffic doors Interior traffic doors Wood entry door and sidelight Overhead Sectional Doors Automatic Sliding Entrance Doors Automatic Sliding Door	Exterior and thermally proken frames interior frames Fire-rated steel framing Fire-rated glass	SED1	Longulurial edges medianizativinterlocked	Bruce Nakamura bnakamura@senneca.com Front entry door Lepage Millwork jiii @halburtonlumber.com https://www.lepagemillwcrk.com/en-ca/ Exterior - Refer to drawing A710. Nick Gaudet ngaude@hortonoritarie.com 905-331-7491 x122
08 13 00 08 14 00 08 3313	Fire Rated Glass and Framing Acceptable manuracturer Acceptable manuracturer Framing Firsh Glass Rating Steel Traffic Doors Interior traffic doors Wood entry door and sidelight Overhead Sectional Doors Automatic Sliding Entrance Doors Automatic Sliding Door Automatic Sliding Coors Curtairwal	Exterior and thermally proken frames interior frames Fire-rated steel framing Fire-rated glass	SED1	Service Ser	Front entry door Front entry door Lepage Villwork: jiii @haliburtcniumber.com https://www.lepagemillwcrk.com/en-ca/ -Exterior - Refer to drawing A710. Nikk Gaudet ngosudet @hortonontarie.com g05-331-7491 x122 -Exterior - Refer to drawing A710.

Water based light industrial coating Top coats (2 coats) Benjamin More Corolled Pe-Casalyzed Waterbased Epoxy V34.1 / V34.2 Shenian Williams Pre-Catalyzed Waterbased Epoxy V45.7 k48-150 Series PPG Pitt-Glaze WB1 Interior Pre-Catalyzed Water-Borne Epoxy 16-310 / 18-510. Metal fabrictions Primer coat DTM Rust Inhibit ve Primer Steering Williams B06W1 to B66W31C D*M Primer. Including pipes, ducts, ecupremet and related	SECTIONS		SPECIFICATIONS AND SYSTE			
Services Servic	Specification				Basis of Design	General Locations / Notes / Contacts
Principle Prin		Fluid -Applied Epoxy Flooring		EPFC2	Stonhard 'Storshield FR' with broadcast / Stoneproof ME7' waterproofing Colour: Steel grey	
March of the control of the contro		Base			◆Integral cove base, 6" high	
Migrate of the designed in service and the company of the compan	09 91 00				Painting of Interior and exterior paintable surfaces.	
Converted baseling February Colors Februar					Metarial and equipment furnished prime and finish painted.	
### PRPC_Late Print could Prin					High Perfromance Acrylic (HP Acrylic):	
### PRPC_Late Print could Prin		Interior Paint Systems				
## Comman Nove And Wider come (a Method and Comman And Wider Comma		HIPAC Latex:	Primer coat		As recommended by top coat manufacturer or as indicated below.	◆Public areas
Wider based by the designed control Top coats (2 could) Top coats (2 could) William Processor (2 could) William Processor (2 could) William Processor (2 could) Primer coat Primer c			Top coats (2 coats)		 Sherwin Williams Duration Interior Acrylic Latex A9x-1200 Series. 	
Top code (2 code) Media file schools Primar code Top code (2 code)			Primer coat		As recommended by top coat manufacturer or as indicated below.	Back of house areas, food prep areas, washroom
Pinner Code Code		sadrai nosen ille innerina cognid	Top coats (2 coats)		Sherwin Williams Pre-Catalyzed Waterbased Epoxy K45 / K46-150 Series. PPG Pitt-Glaze WB1 Interior Pre-Catalyzed Water-Borne Epoxy 16-310 /	
Prince Control Prince		Metal fabrictions	Primer coat			Steel doors and frames and miscellaneous items
##PACL Labs Printed Miscolareous Metals and Architecture Metals and Architecture Metals sugices by Chouse ##PACL Labs Printed Miscolareous Metals and Architecture Metals sugices by Chouse ##PACL Labs Top cods (2 cods) ##PACL Labs Printed Class Printed Clas						including pipes, ducts, equipment and related brace and supports). Includes factory primed and galvani
Architectural Media's supplied by Division Top codes (2 code) Top codes (2 code) Primar code			Top coats (2 coats)			
Top codes (2 codes)			Primer coat			
Dressed Limber Penner coal Penner penner Penner pe			Top costs (2 costs)			- Defects Section 05 50 00 for locations
Primer P			Top coats (2 coats)			The left is decided by 50 to 101 localities
Color Colo		Dressed lumber	Primer coat		PPG Dulux Grpper #63000 HIPAC Latex	
Fig. Colour screedule Fig. Fig. Provided Fig.		Guncum hoard				
Colour schedule Colour schedule FT 1 Beniarin Moore. Chardity Lace #212-170 FT 3 FD 180 Division 10 - Specialities Division 10 - Specialities Shower acceve base and backwalls Shower acceve base and backwalls Shower acceve base and backwalls FT 3 Wall and Door Protection Wall and Janior Accessories Accessories Accessories Accessories Accessories Accessories FT 3 FT 3			Top coats (2 coats)		HIPAC Latex	
FTS TEC		Colour schedule		FT1	Benjam in Mcore: Chantilly Lace #2121-70	
Shower allower base and backwalls Shower and single Threshold SlimLine Base Shower Base and Backwalls Shower B					TBD TBD	
Shower alcove base and backwalls Shower alcove base Shower						
# OWall 8 Backwals and Single Throchold SlimLine 3apo Size 34 DoB/WAT 58 H Solar Viville	10 21 00	Pre-manufactured shower enclosure				
Well and Door Protection Wall and door prote		Shower alcove base and backwalls			QWall 5 Backwals and Single Threshold SlimLine Base Size: 34"Dx60"Wx76 %" H Drain Location: Right	
Accessories Accessori	10 26 23	Wall and Door Protection Wal and door protection	Panel	WP1		Altro: Chris Johnson
*Claribles steel corners *Cap strips *Altrotile naskers 10 28 00 Washroom and Janitor Accessories					Colour: White Continuous joint strips Start + edge trim	cjohnson@altro.com
Schedule Sch					Stainlass steel corners Cap strips	
Grab Bars GRB1 Beborick 38mm Delimeter Straight Grab Bar 8 (10mm (Horzontal)	10 28 00	Washroom and Jani:or Accessories				
GRB2 eBobrick Samm Claimater 20 Polagree Grab Bar, 782/mm x 782/mm x 782/mm		Schedule	Cost Do	GDD4	-Robrick 38mm Diameter Straight Crab Day 610mm (Users and	
Hand Dryer			GISD BAIS		Bobrick 38mm Diameter 90 Degree Grab Bar, 762mm x 762mm Finish: Type 304 stainless steel with "NAAMM Brushed No.4" finish with	
### Pinish Sprayed nickel Mirror MR1 #Bobrick B-165 2436, 610mm x 910mm			Hand Dryer	FCD1	■Dyson Airblade V	
Sosp Dissenser SD •TBD Tollet Paper Holder TPH •Bobrick':\textumbo-Roll Surface-Mounted Tollet Tissue Dispenser B-2890' 10 73 13 Retractable Exterior Awning Exterior awning Exterior awning Exterior awning Exterior awning FC1 Rollec 'Addia Extreme X3M' •Fabric Flame Retardant Fabric FRESIST Division 11 - Equipment Loading Dock Leveler and Accessories •Serco - Reter to Drawing A730						
Tollet Paper Holder TPH						
Profit P						
Exterior awring FC1 Robits Padria Extreme X3M' Lester Awrings: 705-742-5405 Pabric Flame Retardant Fabric FIRESIST https://festeramrings.com/contact/ Division 11 - Equipment Loading Dock Leveler and Accessories Serco - Retart to Drawing A730	10 73 13	Retractable Exterior Awning	Toller Haper Holder	IEH	Propriet Amiliph-Koil Chilace-Moulited Tollet HISSUE Dispenser B-2890.	
11 13 19 Loading Dock Leveler and Accessories •Serco - Refer to Drawing A730		Exterior awning		FC1		
Division 12 - Furnishings					Serco - Refer to Drawing A730	
	Division	2 - Eurojobie se				
12 48 13 Entrance Floor Mat		Entrance Floor Mat			Materia Mark Mak VIII	Fater Visible de
Entrance Ficor Mat •Matsinc: 'Grate Mat XT' •Entry Vestibules •Aluminum body, carbonundrum insert (charccal)	\sqcup	Entrance Ficor Mat				●Entry Vestibules

		Specifications Matrix	F Septembe
		Construct typical wall assembly installation showing all applicable details.	
07 46 46	Cemer	ntitious Cladding	
		Construct minimum 10 m2 (100 ft2) area of each typical wall assembly installation showing all applicable details.	
07 62 00	Metal	lashing	
		Provide on-site mock-up of the following:	
		Coping flashing. Roof edge fashing.	
		Counter flashing.	
		Fascia flashing. Special flashing conditions	
		*Special liashing conditions	
09 31 00	Tiling	Provide grouted mock-up: 1220 mm x 1220 mm (48" x 48") sample panels of each tile type and	
		colour, texture, size, and pattern of tile and grout.	
		Install each product and colour mock-up for acceptance by Consultant. Accepted	
		mock-up shall form basis of standard of workmanship for remainder of work. Mock-up shall consist	
		of floor/wall/base corner intersection including cove base inside and outside corners, with 300 mm (12") of finish product on each face.	
09 65 13	Prema	nufactured Bases	
		Premanufactured base mock-up shall include at least one inside corner, one	
		outside corner plus 3 m (10'-0") of straight run.	
09 65 18	Slin R	esistive Vinyl SheetFlooring	
V3 U3 10	p /	Provide mock-up of sufficient size to indicate adhesion, joint welding, edge treatment, and coved	
		base.	
09 91 00	Paintii		
09 91 00	Fairiui	Provide full finished mock-up installation of each paint colour, for indicated surfaces and mock-up	
		size, showing colour and finish selected by Consultant, under lighting conditions matching final area lighting, for acceptance by Consultant. Locate at Place of the Work as part of finished installation if accepted.	
	Exteri	or Improvement	
	Concr	ete Reinforcement	
	Concr	Submit engineered shop drawings for reinforcement	
	Coot is	Place Concrete	
	Cast-II	n-Place Concrete Submit certified mix designs for each type of concrete to be used, stating the specific	
		location, using structural element for which the mix applies and 305 mm (12") x 305 mm (12") sample of specified finish.	
	Metal	Fabrication	
	Wictal	Submit engineered shop drawings of all exterior metal work, including, bollard, sign post, handrail	
		at cip concrete steps and ramp, and chain link fence. Provide in shop drawings plans, sections and	
		large scale details. Indicate components and methods of assembly, materials and their characteristics, fastenings, metal finishes, welds, and their structural characteristics relative to their	
		purpose, and other fabrication information required. Indicate site connections and methods.	
	Site Fi		
	Site F	purpose, and other fabrication information required. Indicate site connections and methods. Imishing Submit engineered shop drawings and product data sheets of bench, movable planter & bench,	
	Site F	purpose, and other fabrication information required. Indicate site connections and methods. Indicate site connections and methods. Indicate site connections and methods.	
	Site Fo	purpose, and other fabrication information required. Indicate site connections and methods. Imishing Submit engineered shop drawings and product data sheets of bench, movable planter & bench, and tactile place.	
		purpose, and other fabrication information required. Indicate site connections and methods. Imishing Submit engineered shop drawings and product data sheets of bench, movable planter & bench, and tactile place. I Product data sheets:	
		purpose, and other fabrication information required. Indicate site connections and methods. Imishing Submit engineered shop drawings and product data sheets of bench, movable planter & bench, and tactile place.	
		purpose, and other fabrication information required. Indicate site connections and methods. Imishing Submit engineered shop drawings and product data sheets of bench, movable planter & bench, and tactile place. I Product data sheets: Submit data describing planting mix components and certificates indicating that the materials meet specification requirements for review a minimum of 45 business days prior to planned installation of planting mix.	
		purpose, and other fabrication information required. Indicate site connections and methods. Imishing Submit engineered shop drawings and product data sheets of bench, movable planter & bench, and tactile place. I Product data sheets: Submit data describing planting mix components and certificates indicating that the materials meet specification requirements for review a minimum of 45 business days prior to planned installation of planting mix. Samples:	
		purpose, and other fabrication information required. Indicate site connections and methods. Imishing Submit engineered shop drawings and product data sheets of bench, movable planter & bench, and tactile place. I Product data sheets: Submit data describing planting mix components and certificates indicating that the materials meet specification requirements for review a minimum of 45 business days prior to planned installation of planting mix. Samples: Submit samples of planting mix components for approval a minimum of 45	
		purpose, and other fabrication information required. Indicate site connections and methods. Imishing Submit engineered shop drawings and product data sheets of bench, movable planter & bench, and tactile place. I Product data sheets: Submit data describing planting mix components and certificates indicating that the materials meet specification requirements for review a minimum of 45 business days prior to planned installation of planting mix. Samples: Submit samples of planting mix components for approval a minimum of 45 business days prior to planned installation of planting mix with clear label on samples with relevant identifying characteristics including but not limited to the type of material, percentange of each	
		purpose, and other fabrication information required. Indicate site connections and methods. Imishing Submit engineered shop drawings and product data sheets of bench, movable planter & bench, and tactile place. I Product data sheets: Submit data describing planting mix components and certificates indicating that the materials meet specification requirements for review a minimum of 45 business days prior to planned installation of planting mix. Samples: Submit samples of planting mix components for approval a minimum of 45 business days prior to planned installation of planting mix with clear label on samples with relevant identifying characteristics including but not limited to the type of material, percentange of each component materials, source and stockpile location, and manufacturer contact information.	
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		purpose, and other fabrication information required. Indicate site connections and methods. Imishing Submit engineered shop drawings and product data sheets of bench, movable planter & bench, and tactile place. I Product data sheets: Submit data describing planting mix components and certificates indicating that the materials meet specification requirements for review a minimum of 45 business days prior to planned installation of planting mix. Samples: Submit samples of planting mix components for approval a minimum of 45 business days prior to planting mix emples of planting mix components for approval a minimum of 45 business days prior to planned installation of planting mix with clear label on samples with relevant identifying characteristics including but not limited to the type of material, percentange of each component materials, source and stockpile location, and manufacturer contact information. Samples to be submitted for review and acceptance at the same time as test reports.	
		purpose, and other fabrication information required. Indicate site connections and methods. Imishing Submit engineered shop drawings and product data sheets of bench, movable planter & bench, and tactile place. I Product data sheets: Submit data describing planting mix components and certificates indicating that the materials meet specification requirements for review a minimum of 45 business days prior to planned installation of planting mix. Samples: Submit samples of planting mix components for approval a minimum of 45 business days prior to planned installation of planting mix with clear label on samples with relevant identifying characteristics including but not limited to the type of material, percentange of each component materials, source and stockpile location, and manufacturer contact information. Samples to be submitted for review and acceptance at the same time as test reports.	

The manufacture of the processors of the process	Grocery St	ore			Specifications Matrix	P Augus
Bitanica Congreting Bitanica Congreting Proper Position of C		. Castian	SPECIFICATIONS AND SYSTE		Denducation	Constall agations / Nation / Contrate
There is a second to the content are the one past expectation Committee C	specifications			Acronym	Basis of Design Dampproofing coating; for ambient and substrate temperatures below 5°C: Primer: Penetrating asphall primer, to CGSB 37-GP-9Ma-1983. Dampproofing coating; for ambient and substrate temperatures above 5°C:	
There are warriant for the characters and the segretories (a) 1 Compared Cody (c) 1 Cody	07 21 00	Thermal Insulation				
Thermal multium for sail and self-dispretations and control body in the control body i					ADow 'Shrofnam SM'	- Dalam and a making and businessed and institution
Contract of the contract of			Rigid APS insulation board	INS-10		Below grade vertical and nonzontal applications
Part of properties of the properties		Thermal insulati	Semi-rigid dual density mineral-fibre insulation board	INS-22	Rockwool 'Cavityrock'	Cavity wall assemblies. Rain screen assemblie
Married from Account or Place Married from Account or Place MAPP			Rigid polyisocyanurate insulation board Flat and tapered	INS-52	Refer to Section 07 52 16	●Roofing assemblies
### Server Adjusted Facement on Place Spring from manufation		Th	Mineral-fibre Acoustic Fire Batt	INS-60	•Refer to Section 09 29 00	Gypsum board partitions.
Missackern Every Name residence Surge Name Surge			(AFB)			
Cartelle Clays For Section Country Spring princing the barrier law of the Country Spring princing the barrier law of the Country Control Section Country Control Section Country Spring princing the barrier dissertation in when beautiful and country in the Country Control Section Country Developed cryptor in granted the Country Control Section Country Developed Cou		nsulation				
### At Electric Systems A Electric Systems A					Carlisle Spray Foam Insulation 'SealTite One'. Demilice Inc. 'Heatlot Soya HFO'Delardam SOYA HFO'. Elastochem Specialty Chemicals Inc. 'Insulhane Extreme'. Soprema 'Sogra SFF 202'. Thermal barrier that meets the requirements of classification B when tested in conformance with CANULC-S124, "Test for the Evaluation of Protective.	
AP Section Systems A Section Systems A Section Systems A Section Systems A Section S	07 26 16	Below-Grade Vapour Barrier Underslab vapour barrier			Minimum 0.38 mm (15 mils). Stego Industries 'Stego Wrap Vapor Barrier'.	•Interior concrete slabs on grade
Administrative System Vagour purmable seathir between Providence Sporation Set and Low Tomorrountaria Ar Sheld Vagour purmable seathir between SPA And Control of Set and Low Tomorrountaria Ar Sheld SPA And Control of Set and Low Tomorrountaria Ar Sheld Providence Section Set and Low Tomorrountaria Ar Sheld SPA Manufacing with Cease-addition Adult Cease-additional Control of Set And Low Tomorrountaria Ar Sheld Adult Cease-additional Control of Set And Low Tomorrountaria Ar Sheld Control Control of Set Act Control Set And Restrictional Medical Control Control Control of Set Act Control Control Control of Set Act Control Set Set And Control of Set Act Control Control Control of Set Act Control Control Control of Set Act Control of Set Act Control Set Set Set Act Control Control of Set Act Control Control Control of Set Act Control of Set Act Control Set	07 27 00	Air Barrier Systems			W.R. Meadows 'PERMINATOR'.	
P4 44 0 P59 Moulding with CustererBloos Coeffing		Adhesive Air/Vapour Barrier		AVB	Henry Company 'Blueskin SA' and 'Blueskin SA LT Soprema 'Sopraseal Stick 1100 T'.	Exterior assemblies
### Commendations Cladeling Paraget exterior moutding ### Commendations Cladeling ### Paraget exterior moutding ### Commendations Cladeling ##					SRP AirOutshield Wall.	Exterior assemblies - directly behind cladding
Parapet existor modeling ALCI Commendation Classifier Board and Battern commentations classifier Commendations Classifier Board and Battern commentations classifier Board and Battern commentations classifier Board Annual Parapet Commentations Classifier Board Repeated Parapet Commentations Classifier Commentat		EPS Moulding with Cementitious				
Board and Batten commentitious cadding		Parapet exterior moulding		MLD1	Profile: BAN-012 / Size: 7 ½ x 24 ½ C-Mold - Reinforcing Mesh & Cementitious Exterior Coating	
#Panel Size 4:87 716* thick typ. #Solf Panel Size 4:87 716* thick typ. #Custom custs to suit panelling design and profiles #Primed for field coartinum #Primed for field c					2 Board Size: Maximum Panel Sizes: 120'148' 3 Board Thickness: 0.312' (Bmm) 4 Finish: Cedar Mill 5 Colour: Colour Later Chosen By Consultant – From Non Standard 'Dream Colour Collection'. Accessories: 6 Exterior Base at Grade: 10'mm high Royal Board – 9760 SurEdge 7 Battens: Hardie Trim Batten Board – Rustic 19mm thick x 64mm Wilde; maximum 12'-0'lengths 8 Outside Corner: 54 10'mmWx25mm Thick Hardie Trim Boards 9 Perimeter and Window Trim: 54' 10'mm x 25mm Thick Hardie Trim Boards 10. Flashing: Provide aluminum flashing at al hortzontal window trims 11. Trim Fasteners: Hardie plat taps for Concealed Fastening 12. Colour: To match Hardie Panel Vertical Siding 13. REFER TO HARDI TRIM MANUAL FOR TYPICAL TRIM, FLASHINS AND INSTALLATION DETAILS	
Of 52 16 Styren-Butadiene-Styrene (SBS) Modified Bituminous Membrane Roofing SBS Modified Bituminous SBS Modified Bituminous Part		Cementitious cladding with custom frim		CC2	Panel Size: 4'x8' 7/16' thick typ. Soffit Panel Size: 4'x10' 7/16' thick Custom cuts to suit panelling design and profiles	https://www.iameshardie.ca/products/ha boards
O7 52 16 Styrene-Butadiene-Styrene (SBS) Modified Bituminous Membrane Roofing SBS Modified Bitumin roofing system Extended warranty SBS Modified Bitumin roofing system Extended warranty Acceptable manufacturers Acceptable manufacturers Acceptable manufacturers Acceptable manufacturers Acceptable application methods Acceptable application applied SEBS (base and cap sheets) or asphait applied base/hot-applied base/hot-applied SEBS (base and cap sheets) or asphait applied base/hot-applied base/hot-applied SEBS (base and cap sheets) or asphait applied base/hot-applied base/hot-applied SEBS (base and cap sheets) or asphait applied base/hot-applied base/hot-applied seBBS (base and cap sheets) or asphait applied base/hot-applied base/hot-applied seBBS (base and cap sheets) or asphait applied base/hot-applied base/hot-applied seBBS (base and cap sheets) or asphait applied base/hot-applied seBBS (base and cap sheets) or asphait applied base/hot-applied seBBS (base and cap sheets) or asphait applied base/hot-applied		Trims				https://miratecextira.com/extira-exterior-panels https://monaghanlumber.com/wp-
Modified Bituminous Membrane Roofing SBS Modified Bitumen roofing system Extended warranty Acceptable manufacturers Acceptable manufacturers Membrane installation Acceptable application methods Acceptable application methods Acceptable application methods Materials Materials Foof membrane base sheet Roof membrane cap sheet SBS-modified asphalt membrane sheet with reinforced elastomeric bitumen. CCSB 37.56Type C, Grade 1, composite reinforced. SBS-modified asphalt membrane sheet with reinforced elastomeric bitumen. SBS-modified asphalt membrane sheet with reinforced elastomeric bitumen. Substrate board / Parapet sheathing board Air and Vapour Barrier Acceptable applied base of board with reinforced dasphalt delaction reinforced. SBS-modified asphalt membrane sheet with reinforced elastomeric bitumen. SBS-modified asphalt membrane sheet with reinforce						content/uploads/2016/10/Special-Order-Moulding
Membrane Roofing SBS Modified Bitumen roofing system Extended warranty Acceptable manufacturers Acceptable manufacturers Acceptable manufacturers Acceptable manufacturers Nembrane installation Acceptable application methods BBS applied cap sheet. Hot-applied SEBS (base and cap sheets) or asphalt applied base/hot-applied SEBS applied ap sheet. Hot-applied SEBS (base and cap sheets) or asphalt applied base/heat-welded (brrch) applied SEBS (base and cap sheets) or asphalt applied base/heat-welded (brrch) applied sheetweepplied SEBS (base and cap sheets) or asphalt applied base/heat-welded (brrch) applied sheetweepplied SEBS (base and cap sheets) or asphalt applied base/heat-welded (brrch) applied sheetweepplied SEBS (base and cap sheets) or asphalt applied base/heat-welded (brrch) applied sheetweepplied SEBS (base and cap sheets) or asphalt applied base/heat-welded (brrch) applied sheetweepplied SEBS (base and cap sheets) or asphalt applied base/heat-welded (brrch) applied saberies welded (brrch) app						- 100 EX
Extended warranty Acceptable manufacturers Acceptable manufacturers No dollar limit. Henry Company. Johns Manwille. Siplast. Soprema. Fremco. Acceptable application methods Acceptable application methods Acceptable application methods Acceptable application methods SEBS applied cap sheet. Hot-applied SEBS (base and cap sheets) or asphalt applied base/hot-applied SEBS (base and cap sheets) or asphalt applied base/heat-welded (broh applied ablewive applied base sheetheat-welded correctly applied dasheve applied base sheetheat-welded cap sheet. Acceptable applied applied applied applied base sheetheat-welded cap sheet. Hot-applied applied ablewive applied base sheetheat-welded cap sheet. SBS-modified asphalt membrane sheet with reinforced elastomeric blumen. CGSB 37.56Type C, Grade 3, composite reinforced. SSBS-modified asphalt membrane sheet with reinforced elastomeric blumen. CGSB 37.56Type C, Grade 1, composite reinforced. SUbstrate board / Parapet sheathing board Air and Vapour Barrier Air and Vapour Barrier Feelf-adhering sheet minimum of 0.8 mm (30-mil) thick, polyethylene film Isministed to layer of rubberized asphalt adhesive, cold-applied, with slig-resisting superbacking.	- 1	Membrane Roofing				
Qality					•20 year total system warranty including labour materials and installation	
Henry Company, Johns Manville. Siplast. Soprema. Tremco. Hot-applied SEBS (base and cap sheets) or asphalt applied base/hot-applied SEBS applied cap sheet. Hot-applied SEBS (base and cap sheets) or asphalt applied base/hot-applied SEBS applied cap sheet. Hot-applied SEBS (base and cap sheets) or asphalt applied base/heat-welded (brch) applied sheetweepfeld (brch) applied sheetweepfeld (brch) applied sheetweepfeld cap sheet. Hot-applied sheetweepfeld base sheetheat-welded cap sheet. Hot-applied sheetweepfeld base sheetheat-welded cap sheet. Hot-applied sheetweepfeld base sheetheat-welded cap sheet. SBS-modified asphalt membrane sheet with reinforced elastomeric blumen. SBS-modified asphalt membrane sheet with reinforced elastomeric blumen. CGSB 37.56Type C, Grade 3, composite reinforced. SBS-modified asphalt membrane sheet with reinforced elastomeric blumen. CGSB 37.56Type C, Grade 1, composite reinforced. SUbstrate board / Parapet sheathing board CGC Securock Brand - Coated Glass-Mat Roof Board CGCSB 37.56Type C, Grade 1, composite reinforced. Substrate board / Parapet sheathing board CGC Securock Brand - Coated Glass-Mat Roof Board CGCSB 37.56Type C, Grade 1, composite reinforced. Self-adhering sheet minimum of 0.8 mm (30-mil) thick, polyethylene film Isministed to layer of rubberized asphalt adhesive, cold-applied, with slignershisting surface and release appear backing.		Environmentally			quality.	
Acceptable application methods Acceptable application methods BESS applied acp sheet. Hot-applied SEBS (base and cap sheets) or asphalt applied base/heat- applied SEBS (base and cap sheets) or asphalt applied base/heat- welded (trch) applied cap sheet. Cold-applied adhesive applied base sheetheat-welded cap sheet. Hot-applied same sheetheat-welded cap sheet. Sold-applied adhesive applied base sheetheat-welded cap sheet. SBS-modified asphalt membrane sheet with reinforced elastometic blumen. COSB 37.56Type C, Grade 3, composite reinforced. SBS-modified asphalt membrane sheet with reinforced elastometic blumen. COSB 37.56Type C, Grade 3, composite reinforced. SBS-modified asphalt membrane sheet with reinforced elastometic blumen, protected by coloured granule. COSB 37.56Type C, Grade 1, composite reinforced. Substrate board / Parapet sheathing board COSG Securock Brand - Coaked Glass-Mat Roof Board Georgia Pacific DensDeck Prime Roof Board with Enrinc Technology Self-adhering sheet: minimum of 0.8 mm (30-mi) thick, polyethylene film laminated to layer of rubberized asphalt adhesive; cold-applied, with slig- resisting surface and release paper backing		Acceptable manufacturers			Henry Company. Johns Marwille. Siplast. Soprema.	
methods aspiled applied ap sheet. *Hot-applied SEBS (base and cap sheets) or asphalt applied base/heat-welded (brich) applied sease hasheeve applied base sheetheat-welded cap sheet. *Cold-applied applied cap sheet. *Cold-applied sheetweetheat-welded cap sheet. *Heat-welded have sheetheat-welded cap sheet. *SBS-modified asphalt membrane sheet with reinforced elastomeric blumen. *COSB 37.55Type C, Grade 3, composite reinforced. *SBS-modified asphalt membrane sheet with reinforced elastomeric blumen. *COSB 37.55Type C, Grade 3, composite reinforced. *SBS-modified asphalt membrane sheet with reinforced elastomeric blumen, but sheet with reinforced elastomeric blumen, but sheet with reinforced elastomeric blumen, protected by coloured granule. *COSB 37.55Type C, Grade 1, composite reinforced. *SBS-modified asphalt membrane sheet with reinforced with reinforced. *SBS-modified asphalt membrane sheet with reinforced. *SBS-modified asphalt membrane sheet with reinforced with reinforced. *SBS-modified asphalt membrane sheet with reinfo		Membrane installation	Accentable acclients		Holannijed SERS (base and can should as suphall smalled baseling).	
SBS-modified asphalt membrane sheet with reinforced elastomeric blumen.		March 1			applied SEBS applied cap sheet. *Hot-applied SEBS (base and cap sheets) or asphalt applied base/heat-welded (forch) applied cap sheet. *Cold-applied adhesive applied base sheetheat-welded cap sheet.	
CSB 37 56Type C, Grade 3, composite reinforced. SBS-modifies pathal tremetrane esheet with reinforced elastomaric bitumen, protected by coloured granule. CSBS 37.56Type C, Grade 1, composite reinforced. Substrate board / Parapet sheathing board Air and Vspour Barrier Self-adhering sheet: minimum of 0.8 mm (30-mil) thick, polyethylene film Isministed foliayer of rubberized asphalt actiestive; cold-applied, with stip-resisting surface and release paper backing.		materials	Roof membrane base sheet			
Parapet sheathing board Georgia Pacific 'DensDeck Prime Roof Board with Eonic Technology' Air and Vapour Barrier Self-adhering sheet: minimum of 0.8 mm (30-mil) thick, polyethylene film Isminated to layer of rubberized asphalt adreshve; cold-applied, with slignessisting surface and release paper backing			Roof membrane cap sheet		CGSB 37.56Type C, Grade 3, composite reinforced. SBS-modified asphalt membrane sheet with reinforced elastomeric bitumen, protected by coloured granule.	
Air and Vapour Barrier Self-adhering sheet: minimum of 0.8 mm (30-mil) thick, polyethylene film laminated to layer of rubberized asphalt adhesive; cold-applied, with signessisting surface and release paper backing			Substrate board /		CGC Securock Brand - Coaled Glass-Mat Roof Board Georgia Pacific 'DensDeck Prime Roof Board with Fonic Technology'	
Isminated to layer of rubberized asphalt adhealve; cold-applied, with sig- resisting surface and release paper backing					Self-adhering sheet: minimum of 0.8 mm (30-mil) thick, polyethylene film	
◆CAN/ULC S704-11 Type 2 and Class 2, HCFC free, 138 kPa (20 psi)				INS-51	Isminated to layer of rubberized asphalt adhesive; cold-applied, with slip- resisting surface and release paper backing. *Rigid polyisocyanurate insulation board, inorganic felt faced. *CANULC S704-11 Type 2 and Class 2, HCFC free, 138 kPa (20 psi)	
minimum compressive strength. Asphalticcover board •Mutt-ply, semi-rigid asphaltic roofing substate board Pre-cast concrete pavers •Armitec 'Natural Small Diamend'					Multi-ply, semi-rigid asphaltic roofing substrate board	

SECTIONS Specificati	ons Section	SPECIFICATIONS AND SYSTI		Product(s)	General Locations / Notes / Contacts
	Sliding service window		SW1	Basis of Design Horton Automatics, 'Series 8300'.	●Exterio* - Refer to drawing A710.
				Door type: XO Manual pull, thumb lock.	
00 71 00	Einich Jarduras			Finish: PPG Duranar XL, custom colour. Cosh elleuranes.	
08 71 00 08 80 00	Finish Hardware Glass and Glazing		IGU	Cash allowance	Refer to Drawing A710.
	Insulating glass unit		IGU	Double glazed, sealed insulating units: Warm edge, harmetically sealed, CAN/CGSB 12.8-97, minimum 12 mm (1/2") air space, 90% argon/10% air filled, desiccant filled warm edge spacer.	
				Low 'E' coating: VITRO 'Solarban 60'.	
				Warm edge spacer, stainless steel. Preico 'R-Max' Ferzi 'Chromatech Ultra'	
	Glass types			Annealed glass	
				Heat treated (tempered of heat strengthened) glass Laminated glass	
B	00. 5: :: 1			PVB, not less that 0.76 mm (0.030") thick, clear.	
09 22 00	09 - Firishes Metal Supports for Gypsum Board				
		nd cement board partitions, interio	rceilings, sha	aftwalls, and interior assemblies as indicated.	
09 29 00	Gypsum and Cemert Board Schedule	ntorio a cuello		- language and an airbeat are as one has and an airbeau and an airbeau. Turn a V	
		nterior walls		 Impact resistant gypsum board, moisture and mould resistant, Type X, 16mm thick. CertainTeed 'Air-Renew Extreme Impact Resistant Board'. 	
				CGC "Sheetrock Brand Panels Mold Tough VHI Firecode X" Georgia-Padic "DensArmer Plus Impact-Resistant Panel". National Gyssum "High-Impact XP". Lafarce "Proceta HIR 300 Type X with Mold Defense".	
		Interior ceilings		Abuse resistant gypsum board, moisture and mould resistant, Type X,	
				16mm thick. •CertainTeed 'Air-Renew Extreme Abuse Resistant Board'.	
				Goc 'Sheetrock Brand Panels Mold Tough AR'. Georgia-Padific 'DensArmor Plus Abuse-Resistant Panel'. National Gypsum 'High-Abuse XP'. Latrace 'Proxecta AR 100 Type X with Mold Defense'.	
		Tile backer board, interior		Glass scrimmed, Type X, 16nm thick.	
		walls and ceilings		CertainTeed 'GlasRoc Diamondback Tile Backer'.	
		Exterior grade sheathing		Georgia-Padfic 'Dens-Shield Tile Backer. Fibreglass mat faced, Type X, 16mm thick.	
		Exterior grave snearing		CertainTeed 'GlasRoc Sheathing'.	
				CGC 'Securock Glass-Mat Sheathing' Georgia-Padfic 'Dens-Glass Gold' Lafarge : Weather Defense Platinum Sheathing'.	
		Acoustic insulation	INS-60	Mineral-fibre acoustic fire bats	
				Johns Manville 'MinWool Sound Attenuation Fire Batts'. Owens-Corring 'SAFB'. Rockwool 'AFB'.	
		Seamless drywall vents		Vintage Grilles Pattern: Santa Fe or Herringbone.	http://canamould.com/wp/wordpress/wp- content/uploads/2019/*2/CANAGRILLE-brochure-1.pd
09 31 00	Tiling Schedule	Floor tile	71.04		
			TL01	State: 300mmx300mm Solor: TBD - Black #66T29NR or Grey #36T27NR or Carbon #36T28NR	Public washrooms Centura Tile: Elizabeth Livingston
					elivingston@centura.ca 416-434-8626
			TL02	Daltile or American Olean – Mosaic Colour Body Porcelain Size:1" Hexagon	Front door mat
				Colour:BlackA33 / Ice White A25 Custom hanc laid pattern	Daltile: Warren Booth warren.booth@daltile.com
		Wall and ceiling tile			905-738-2099
		vvaii aru ceiling tile	TL10	Centura Tile '\itra' Size:100mm/400mm 9016 Subway Tile Colour: Bright White Matte and Gloss mix(60%Matte / 30%Gloss) Pattern: Vertical, 1/3 OffsetBond	Washroom and Showe rareas Kitchen prep areas
				Corner Trim: Schluter JOLLY, Brushed Anodized Aluminum, Satin Clear	
			TL11	Centura Tile 'Concave' Size 1"x6" (12"x12"sheets)	Bistro Area feature tile ceiling and wall
				Size:3" x 4" x6" Colour: Pottery White Mosaic BHTH01036 (TL11a) and/or Celadon Green Mosaics BHTH06096 (TL11b);	
			TL12	Centura Tile 'Flain Colours' Size: 3" x 6"	Staff Kitchen backsplash
				Colour: White Ice IN08136M, matte	
		Thinset mortar! bond coat - Walls and Floors Thinset mortar! bond coat -		Laticrete 254 Platinum Mapei Ultraflex LFT Laticrete 254 Platinum	
		Ceilings Epoxy grout		Mapei Ultralite S2 Laticrete SpectraLock PRO	
				Kerapoxy CQ	
09 51 23	Acoustical Tile Ceilings Acoustical Tiles		ACT1	•Rockfon Sonar Square Lay-in, (TBD), white.	•Staff admin area
	Standard suspension system.			24" x 48" standard imperial sizes. Armstrong 'Prelude XL 15/16" Exposed Tee System'.	
09 62 90	Tactile Warning Surface Indicators			The state of the s	
	Tactile Warning Surface Indicator (TWSI) - Polymer			Detectable Warning Surface Tile: •Kinesik 'Eon Tile'.	●Exit Stairs
	,,,,,,,			Surface mount tactile warning surfacing tiles with integral domes.	
09 65 13	Premanufactured Bases				
	Rubber base			Tarkett 'Millwork Wall Finishing System', wall base. Profile: 'Mandalay' Line (A DN 76 pp. (31), 64 pp. (3.4/20) Line (A DN 76 pp. (31), 64 pp. (3.4/20) Line (A DN 76 pp. (31), 64 pp. (3.4/20) Line (A DN 76 pp. (31), 64 pp. (3.4/20) Line (A DN 76 pp. (31), 64 pp. (3.4/20) Line (A DN 76 pp. (31), 64 pp. (3.4/20) Line (A DN 76 pp. (31), 64 pp. (3.4/20) Line (A DN 76 pp. (31), 64 pp. (3.4/20) Line (A DN 76 pp. (31), 64 pp. (31), 64 pp. (3.4/20) Line (A DN 76 pp. (31), 64 pp. (31), 64 pp. (3.4/20) Line (A DN 76 pp. (31), 64	
				Height: 115 mm (4 1/2"), 76 mm (3"), 64 mm (2 1/2"). Thickness: 9.5 mm (3/8"). Colours to labraciding.	
09 65 13	Slip Resistive Vinyl Sheet Flooring			Colour: to later selection.	
	Slip Resistive Vinyl Flooring		SFT-01	Altro Safety Flooring 'Stronghold 30' with integral cove base. Colour: Dolphin K3010	Kitchen, Dishwashing, Prep areas
				Heat welded seams	Altro: Chris Johnson cjohnson@altro.com
09 65 60	Resilient Flooring				416-428-3964
	Resilient Flooring		RFL1	Centura 'Roppe Northern Tinber' vinyl wood plank, glue down Size: 4" x 36"	Kitcher and staff areas
				Colour: 272 Limed Beige Oak	Centura Tile: Elizabeth Livingston elivingston@centura.ca
			+		416-434-8626
09.67.03	Fluid Applied Floor Coatings				
09 67 00	Fluid Applied Floor Coatings Fluid -Applied Epoxy Flooring		EPFC1	Stonhard 'Stonekote GS4' Colour: TBD	Back of house areas, exit stairs, under pedimat

Saye	rs Grocery Store		Specifications Matrix	Page 1 of September 29, 202
-	ers Grocery Store fications Matrix - Supp		ry	September 29, 2021
03 - 3	Submittals			
.:	5 Engineered Subr 04 05 00		ry Procedures	
	04 03 00	IVILISOTI	Submit engineered shop drawings for the following:	
			Masonry reinforcement Mesonry tips and connectors	
			Masonry ties and connectors	
	05 41 13	Load-E	Searing Cold-Formed Metal Framing Submit engineered shop drawings, including design, connections and restraint of wall and soffit assemblies. Field review requirements to be supplemented to include the following:	
			Checking that mill test reports are properly correlated to materials.	
			Sampling fabrication and erection procedures for general conformity to requirements of the Contract Decumpants.	
			Contract Documents. • Checking fabricated members against specified member shapes.	
			Sample checking of screwed and bolted joints.	
		+	Sample checking that tolerances are not exceeded during fit-up or erection. General review of field cutting and alterations required by other sections.	
			Include necessary shop details and erection diagrams. Indicate member sizes, locations thicknesses exclusive of coating, coatings and materials. Include connection details for	
			attaching framing to itself and for attachment to the structure. Show splice details where permitted. Indicate dimensions, openings, requirements of related work and critical installation procedures. Show temporary bracing required for erection purposes.	
			Indicate design loads and design calculations, including horizontal and vertical reactions at connections to building structure for all load cases.	
	05 50 00	Metal I	Fabrications	
			Submit engineered shop crawings including plans, sections and large scale details. Indicate components and methods of assembly, materials and their characteristics, fastenings, metal finishes, welds, and their structural characteristics relative to their purpose, and other fabrication information required. Indicate site connections and methods.	
	08 42 29	Autom	atic Sliding Entrance Doors Indicate fastening system for anchorage of door frame to opening, and structural design for each door type and size.	
	09 22 00	Metal 9	Supports for Gypsum Board	
			Submit engineered shop drawings for ceiling assemblies.	
-	6 Mock Ups	-		
	03 35 03	Polish	ed Concrete	
			Provide 3050 mm \times 3050 mm (10' \times 10') mock-up at the Place of the Work as part of final installation for approval, location to be directed by Consultant. Allow for three mock-up areas to determine aggregate exposure classification and polish level	
	04 21 00	Brick F	Wasonry Units	
			Provide complete in-situ mock-up wall assembly, in location designated by the Consultant, prior to the commencement of fabrication and installation of such components.	
	04 22 23	Archit	ectural Concrete Masonry Units	
	04 22 23	Archite	Provide complete in-situ mock-up wall assembly, in location designated by the Consultant, prior to the commencement of fabrication and installation of such components.	
	06 40 00	Archite	ectural Woodwork Provide mock-ups for the following, sizes and locations as directed by the Consultant	
			Solid surfacing countertops and fabrications. Wood ceilings panels. Factory and site finishing of architectural woodwork.	
	06 40 13	Exterio	or Architectural Woodwork	
	00 40 13		Provide mock-ups for Kiosk area.	
	07 27 00	Air Da	rrier Sustame	
	07 27 00	All Da	mer Systems Construct minimum 10 m2 (100 ft2) area of each typical wall assembly installation for each type of Product.	

Sayers Grocery Store	Specifications Matrix	Page 3 o September 29, 2
	Unit Paving	
	Product data sheets: Submit product data sheets for each paver type and colour	
	Shop drawings: Submit shop drawings including bedding, bonding, jointing and setting details, and the	
	dimensions and identifying number of each piece of stone with indication of sizes, thicknesses, dimensions, layout, finishes, compressive strength, joint and setting mix designs, jointing	
	clearances, clearanced between pavers and the adjacent building element. Samples - paver:	
	Submit 6 full size samples of each paver type and colour to show texture, finish, and range of colour to be supplied.	
	Samples - setting bed and joint fill material: Submit samples of setting bed and joint filler material.	
	Design Calculations:	
	.1 Submit design calculations for paving assembly as prepared by qualified professional engineer registered in the Place of the Work.	
	.2 Submit design calculations complete with references to codes and standards used in such calculations, supporting the proposed design represented by the submittal.	
	Prepare calculations in a clear and comprehensive manner.	
	.3 Upon completion of the parts of the Work covered by the design calculations, the professional engineer responsible for the preparation of the design calculations	
	and for undertaking the periodic field reviews described above, shall prepare a letter of general conformity for those parts of the Work, certifying that they have	
	been provided in accordance with the requirements both of the Contract	
	Documents and of the authorities having jurisdiction over the Place of the Work. Test data:	
	.1 Provide test certificates of tests carried out by an independent testing laboratory verifying that stone meets the specifications, for each colour of stone. If certificates	
	are not available, retain an independent inspection and testing company to carry out the tests, minimum of 3 specimens for each test unless otherwise specified in	
	ASTM. Submit test certificates to Consultant at least 8 weeks before commencing	
	stone installation .2 Provide certificate signed by manufacturer that the stone materials to be	
	supplied comply with specified performance characteristics and physical	

REVISIONS	AND ISSUES		
REV	DESCRIPTION	DATE	ВҮ
1	ISSUED FOR SPA	210618	AB
2	REVISED SPA	210709	AB
3	REVISED SPA	210809	AB
4	ISSUED FOR TENDER	210824	AB
5	ISSUED FOR BUILDING PERMIT	210909	AB
6	REVISED TENDER	220124	AB
7	-	-	
8	-	_	_
9	-	-	_
10	-	-	_
11	-	-	_
12	-	_	

MJMA

maclennan jaunkalns miller architects 425 adelaide street west level 6 toronto ontario m5v 3c1 416 593 6796 www.mjmarchitects.com

TRITON ENGINEERING SERVICES LTD CIVIL ENGINEERS


229 BROADWAY, UNIT 1 ORANGEVILLE, ONTARIO, L9W 1K4 TEL 519 941 0330 FAX 519 941 1830

BLACKWELL STRUCTURAL ENGINEERS 134 PETER STREET, SUITE 1301 TORONTO, ONTARIO, M5V 2H2 TEL 416.593.5300 FAX 416.593.4840

SMITH + ANDERSON MECHANICAL AND ELECTRICAL ENGINEERS 1100 — 100 SHEPPARD AVENUE EAST TORONTO, ONTARIO, M2N 6N5 TEL 416.487.8151 —

SAYERS FOOD LIMITED

132 BURLEIGH STREET t: 705.656.4531 e: sayers@apsley.ca

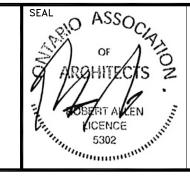

PROJECT TITLE

NEW SAYERS FOOD STORE BURLEIGH STREET, APSLEY

OUTLINE SPECIFICATION

SCALE

NTS

DATE

JANUARY 24, 2022

PROJECT NUMBER 2102
DRAWING NUMBER

Sayers Grocery Specifications Matrix		ary	September 2
03 - Submittals			
03 - Submittais			
.5 Engineered			
04 0	05 00 Maso	nry Procedures	
		Submit engineered shop drawings for the following: •Masonry reinforcement	
		Masonry ties and connectors	
05.4	l1 13 Load-	Bearing Cold-Formed Metal Framing	
		Submit engineered shop drawings, including design, connections and restraint of wall and soffit	
		assemblies. Field review requirements to be supplemented to include the following:	
		Checking that mill test reports are properly correlated to materials.	
		Sampling fabrication and erection procedures for general conformity to requirements of the	
		Contract Documents. • Checking fabricated members against specified member shapes.	
		Sample checking of screwed and bolted joints.	
		Sample checking that tolerances are not exceeded during fit-up or erection. Constal to story of field putting and alterations required by other positions.	
		General review of field cutting and alterations required by other sections.	
		Include necessary shop details and erection diagrams. Indicate member sizes,	
		locations thicknesses exclusive of coating, coatings and materials. Include connection details for	
		attaching framing to itself and for attachment to the structure. Show splice details where permitted. Indicate dimensions, openings, requirements of related work and critical installation procedures.	
		Show temporary bracing required for erection purposes.	
		Indicate design loads and design calculations, including horizontal and vertical	
		reactions at connections to building structure for all load cases.	
05.5	50 00 Metal	Fabrications	
-	1110111	Submit engineered shop drawings including plans, sections and large scale details. Indicate	
		components and methods of assembly, materials and their characteristics, fastenings, metal	
		finishes, welds, and their structural characteristics relative to their purpose, and other fabrication information required. Indicate site connections and methods.	
		information required. Indicate site confections and methods.	
08 4	12 29 Autor	natic Sliding Entrance Doors	
		Indicate fastening system for anchorage of door frame to opening, and structural	
		design for each door type and size.	
09 2	22 00 Metal	Supports for Gypsum Board	
		Submit engineered shop drawings for ceiling assemblies.	
.6 Mock Ups			
	35 03 Polish	ned Concrete	
		Provide 3050 mm x 3050 mm (10' x 10') mock-up at the Place of the Work as part of final	
		installation for approval, location to be directed by Consultant. Allow for three mock-up areas to determine aggregate exposure classification and polish level	
04 2	21 00 Brick	Masonry Units Provide complete in-situ mock-up wall assembly, in location designated by the	
		Consultant, prior to the commencement of fabrication and installation of such components.	
04.3	22 23 Archi	tectural Concrete Masonry Units	
V4 2	- 20 AIGIII	Provide complete in-situ mock-up wall assembly, in location designated by the	
		Consultant, prior to the commencement of fabrication and installation of such components.	
06 4	0 00 Archi	ectural Woodwork	
		Provide mock-ups for the following, sizes and locations as directed by the Consultant Solid surfacing countertops and fabrications.	
		Wood ceilings panels.	
		Factory and site finishing of architectural woodwork.	
06.4	l0 13 Exteri	or Architectural Woodwork	
304	LACCI	Provide mock-ups for Kiosk area.	
	7 00 5:- 5	The state of the s	
07 2	27 00 Air Ba	arrier Systems Construct minimum 10 m2 (100 ft2) area of each typical wall assembly installation	
		for each type of Product.	
		To Cault () De di i Todadi.	

Sayers Grocery Store	Specifications Matrix	Page 3 o September 29, 2
	Unit Paving	
	Product data sheets:	
	Submit product data sheets for each paver type and colour	
	Shop drawings:	
	Submit shop drawings including bedding, bonding, jointing and setting details, and the	
	dimensions and identifying number of each piece of stone with indication of sizes, thicknesses,	
	dimensions, layout, finishes, compressive strength, joint and setting mix designs, jointing	
	clearances, clearanced between pavers and the adjacent building element.	
	Samples - paver:	
1 1	Submit 6 full size samples of each paver type and colour to show texture, finish, and range of	
	colour to be supplied.	
	Samples - setting bed and joint fill material:	
	Submit samples of setting bed and joint filler material.	
	Design Calculations:	
	.1 Submit design calculations for paving assembly as prepared by qualified	
	professional engineer registered in the Place of the Work.	
	.2 Submit design calculations complete with references to codes and standards used	
	in such calculations, supporting the proposed design represented by the submittal.	
	Prepare calculations in a clear and comprehensive manner.	
	.3 Upon completion of the parts of the Work covered by the design calculations, the	
	professional engineer responsible for the preparation of the design calculations	
	and for undertaking the periodic field reviews described above, shall prepare a	
	letter of general conformity for those parts of the Work, certifying that they have	
	been provided in accordance with the requirements both of the Contract	
	Documents and of the authorities having jurisdiction over the Place of the Work.	
	Test data:	
	.1 Provide test certificates of tests carried out by an independent testing laboratory	
	verifying that stone meets the specifications, for each colour of stone. If certificates	
	are not available, retain an independent inspection and testing company to carry	
	out the tests, minimum of 3 specimens for each test unless otherwise specified in	
	ASTM. Submit test certificates to Consultant at least 8 weeks before commencing	
	stone installation	
	.2 Provide certificate signed by manufacturer that the stone materials to be	
	supplied comply with specified performance characteristics and physical	

Construct hybical wall assembly installation showing all applicable details. O7 49.46 Cementitious Cladding Control of C	Sayers Grocery Store	Specifications Matrix	Pag September 2
Construct minimum 10 m2 (100 k2) area of each typical wall assembly installation showing all applicable details showing all applicable details. Provide on all are mock-up of the following Frovide on all are mock-up of the following Food edge stahing, Control feathing, Food edge stahing, Control feathing, Food edge stahing, Food edg		Construct typical wall assembly installation showing all applicable details.	
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showing all applicable details. Provide Flashing Flashing Florid dep stahing Florid stahing	07 46 46		
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Contret fashing. Counter fashing. Forcide grouted mockup: 1220 mm x 1220 mm (48" x 48") sample panels of each tile type and counter fashing. Forcide grouted mockup: 1220 mm x 1220 mm (48" x 48") sample panels of each tile type and counterture, size, and pattern of tile and grout. Install each product and colour mock-up for acceptance by Consultant. Accepted mock-up shall form bass of standard of vorbmarship for remainder of work. Mockup shall consist on (12") of finish product on each fine. (12") of finish product on each fine. On 65 13 Premandactured Bases Bases Premandactured Bases Bases Premandactured Bases Base	07 62 00		
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Samples to be submitted for review and acceptance at the same time as test reports.			
· ·		Samples to be submitted for review and acceptance	
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Submit written laboratory test results for approval within 20 business days of approval of planting			
mix components.		mix components.	

REVISIONS AND ISSUES DESCRIPTION DATE BY ISSUED FOR SPA 210618 REVISED SPA 210709 REVISED SPA 210809 ISSUED FOR TENDER 210824 ISSUED FOR BUILDING PERMIT 210909 REVISED TENDER 220124 _ _ _ -_

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425 adelaide street west level 6
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134 PETER STREET, SUITE 1301
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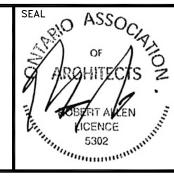
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NORTH AR



PROJECT TITLE

NEW SAYERS FOOD STORE BURLEIGH STREET, APSLEY

DRAWING TITLE

SUBMITTALS
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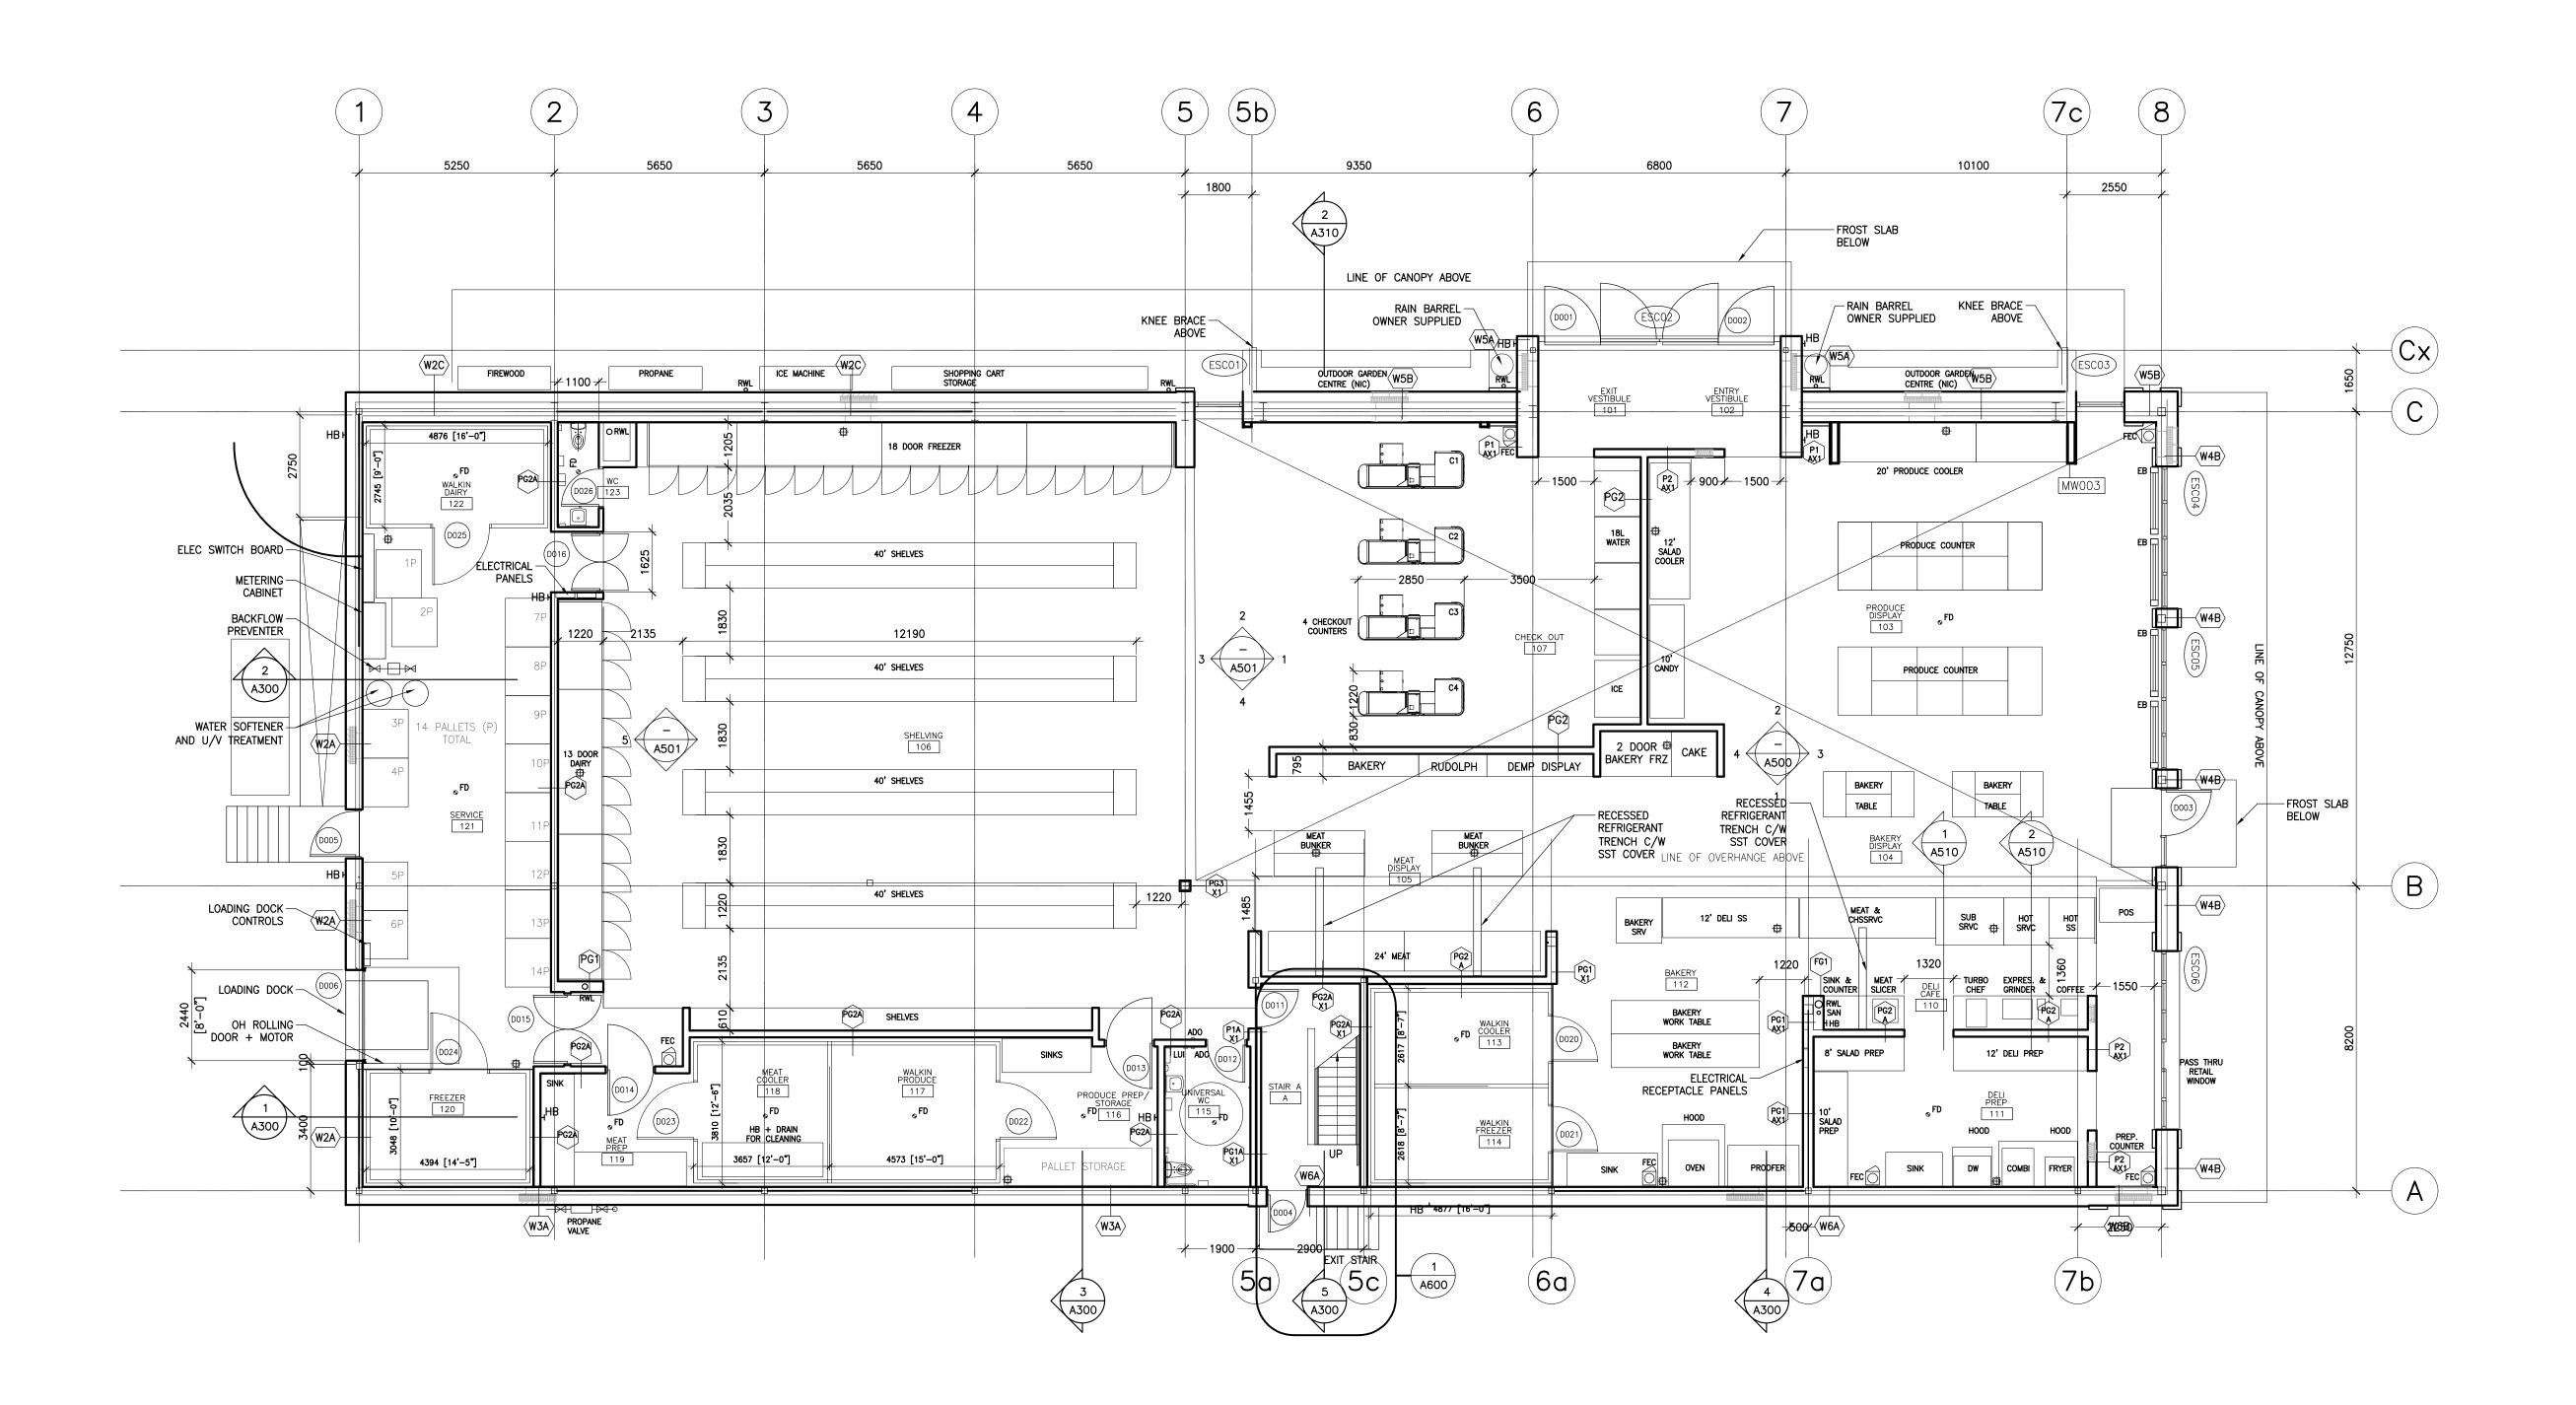
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JANUARY 24, 2022

PROJECT NUMBER
2102

DRAWING NUMBER

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REV	DESCRIPTION	DATE	B,
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2	REVISED SPA	210709	AE
3	REVISED SPA	210809	AE
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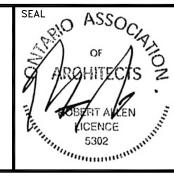
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DRAWING TITLE


GROUND LEVEL FLOOR PLAN

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JANUARY 24, 2022

PROJECT NUMBER
2102

DRAWING NUMBER

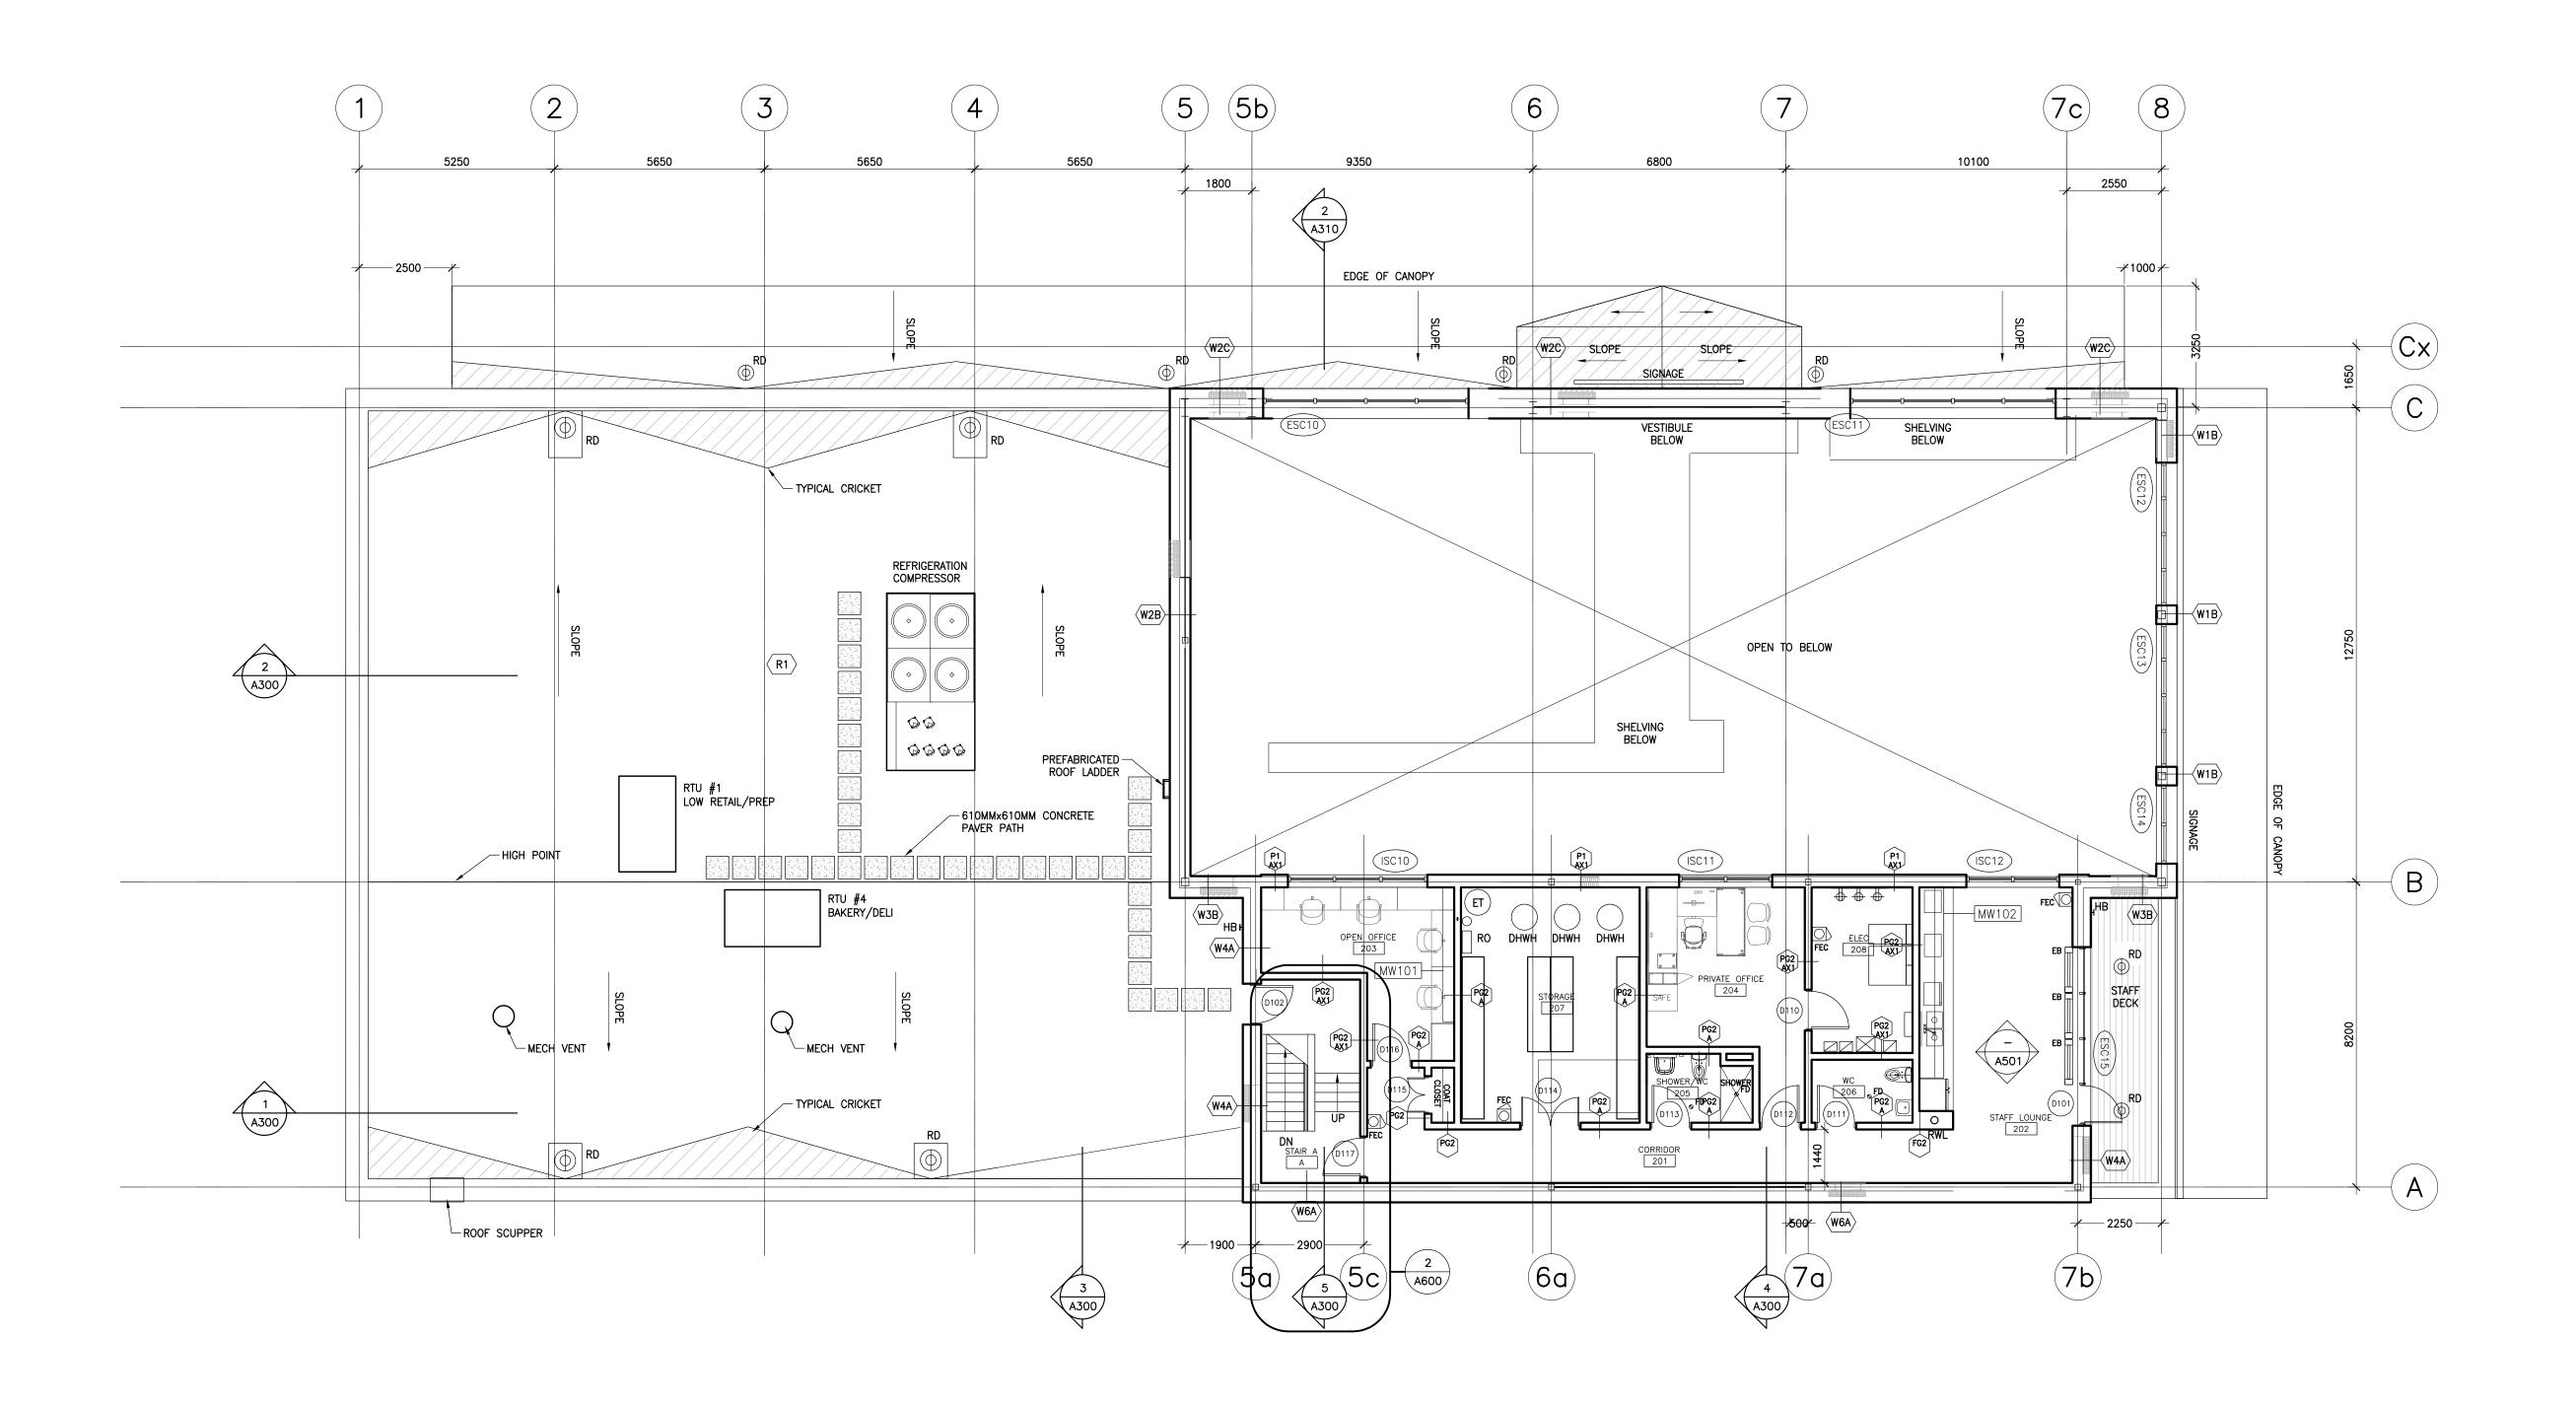

REV	DESCRIPTION	DATE	В
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2	REVISED SPA	210709	Al
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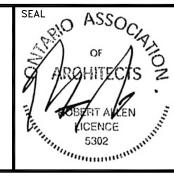
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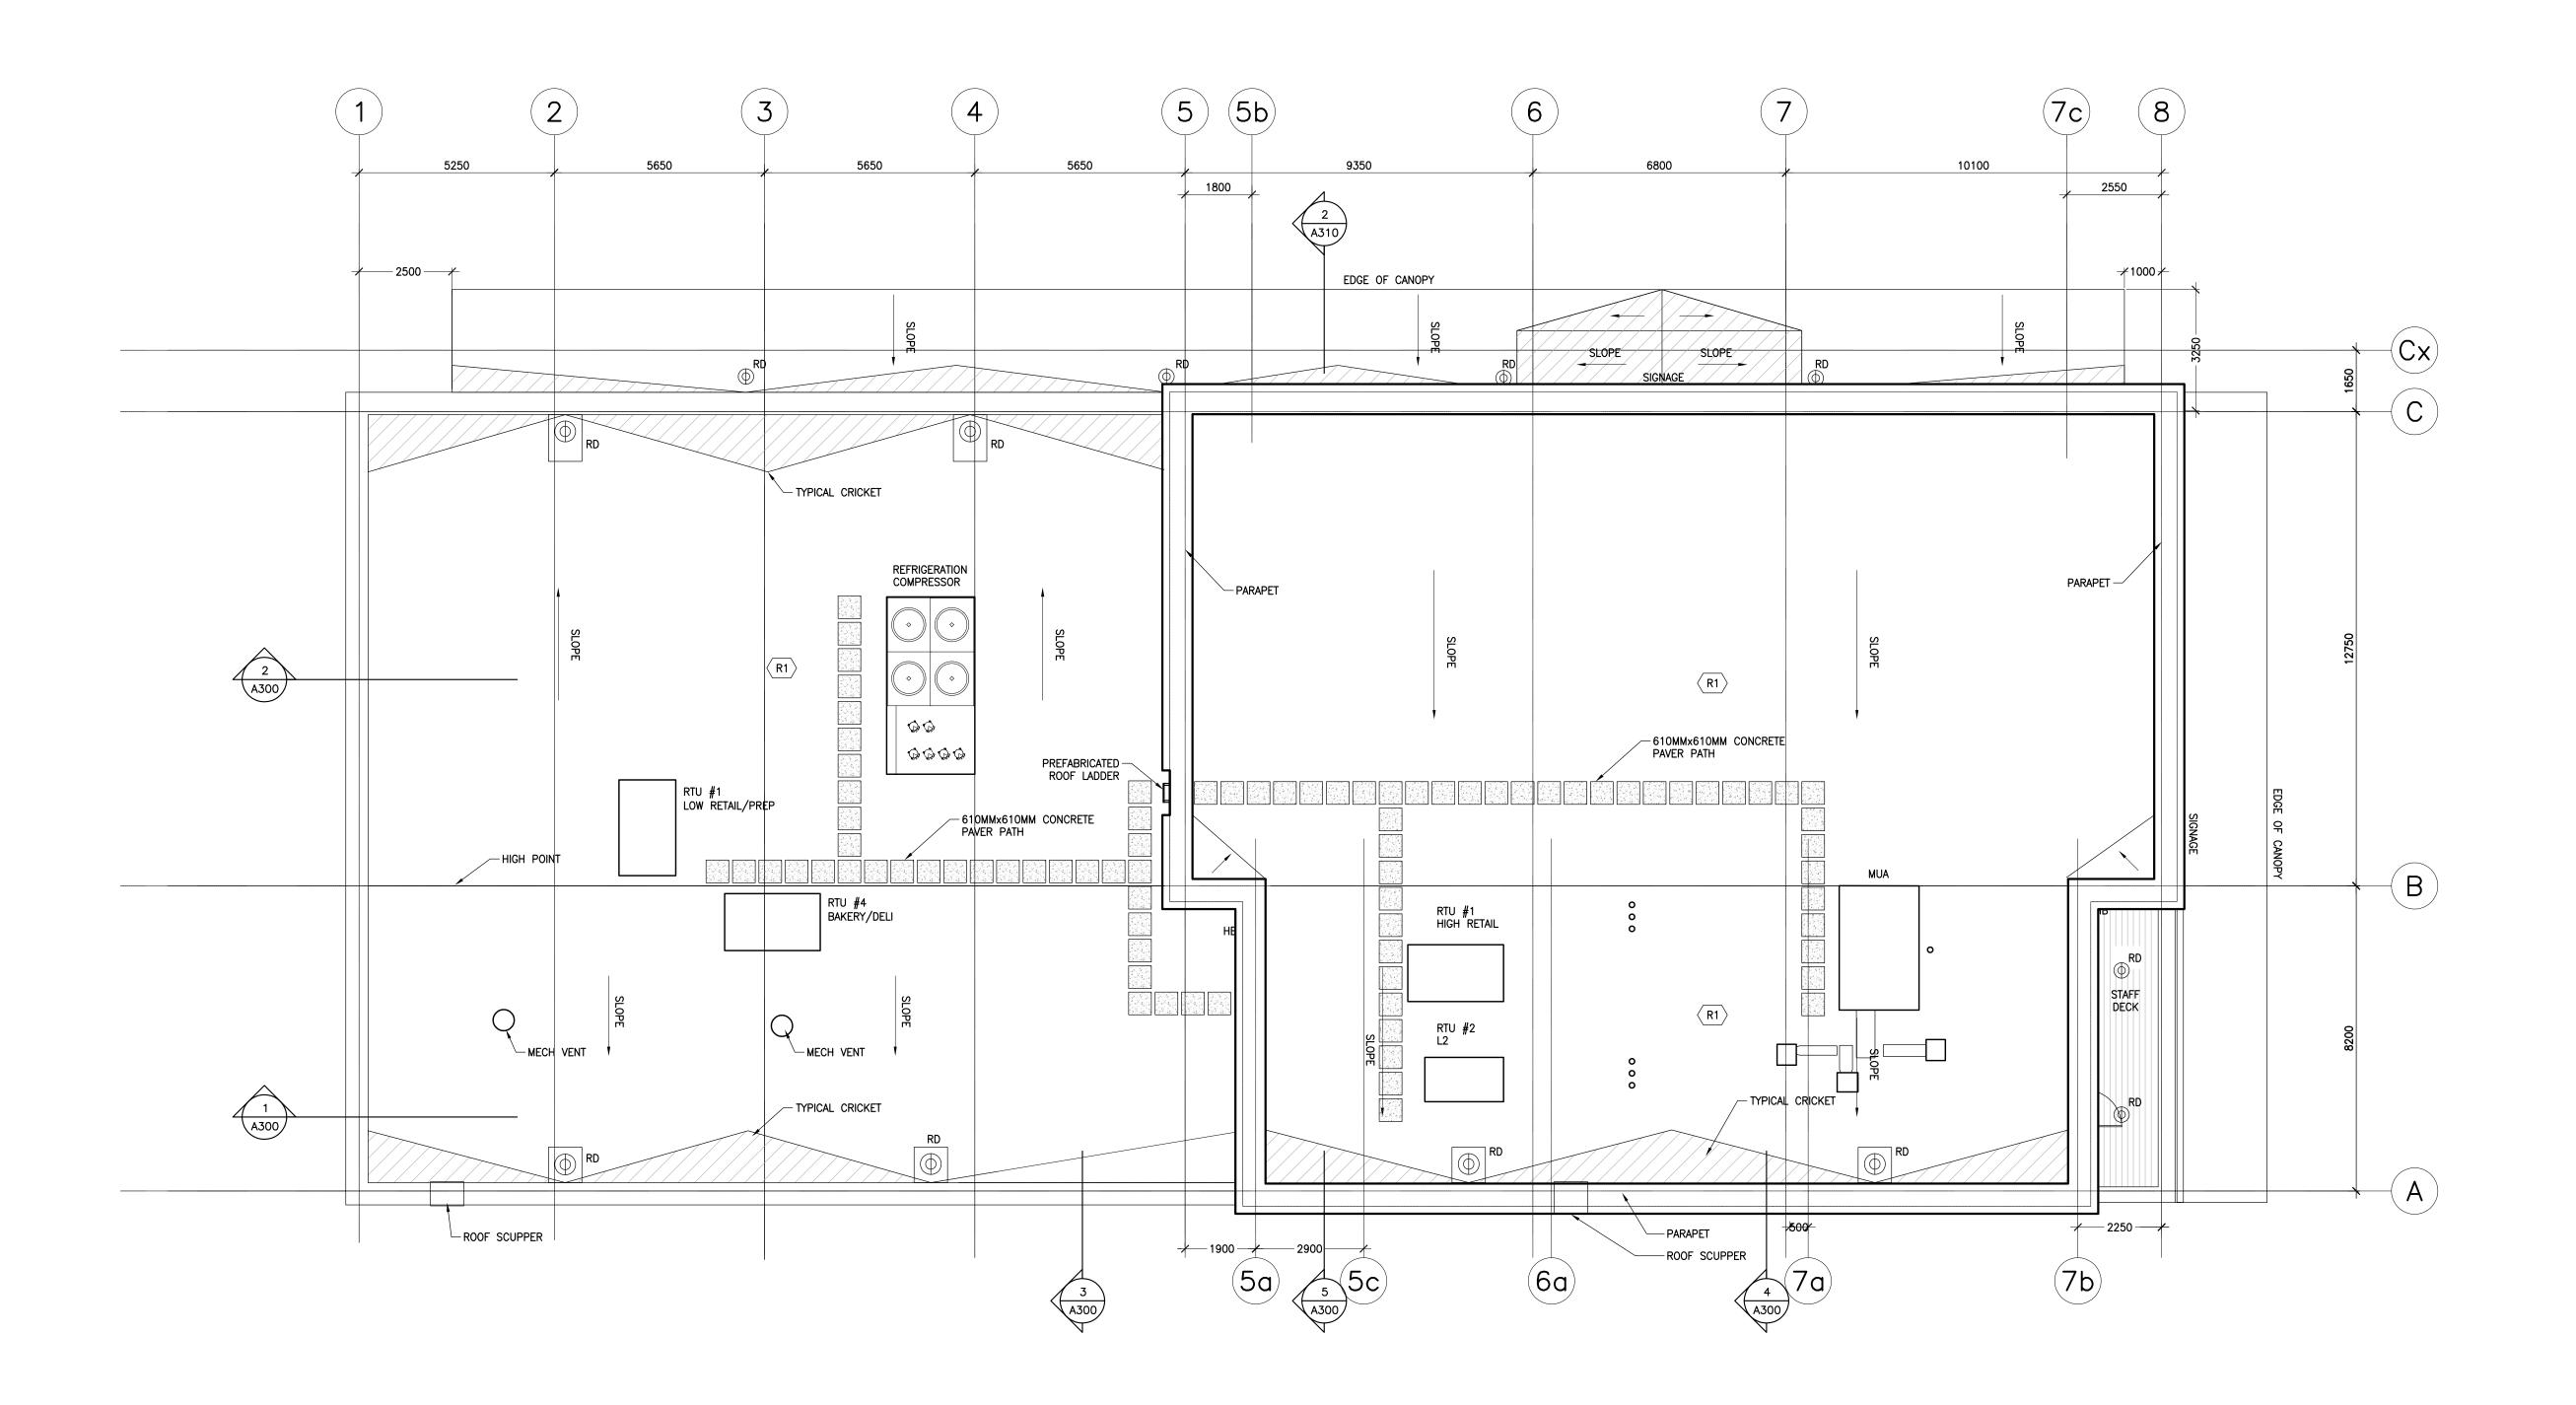
LEVEL 2
FLOOR PLAN

1:100

JANUARY 24, 2022

PROJECT NUMBER 2102

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REV	DESCRIPTION	DATE	B,
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ORANGEVILLE, ONTARIO, L9W 1K4
TEL 519 941 0330 FAX 519 941 1830

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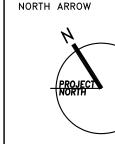
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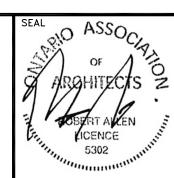
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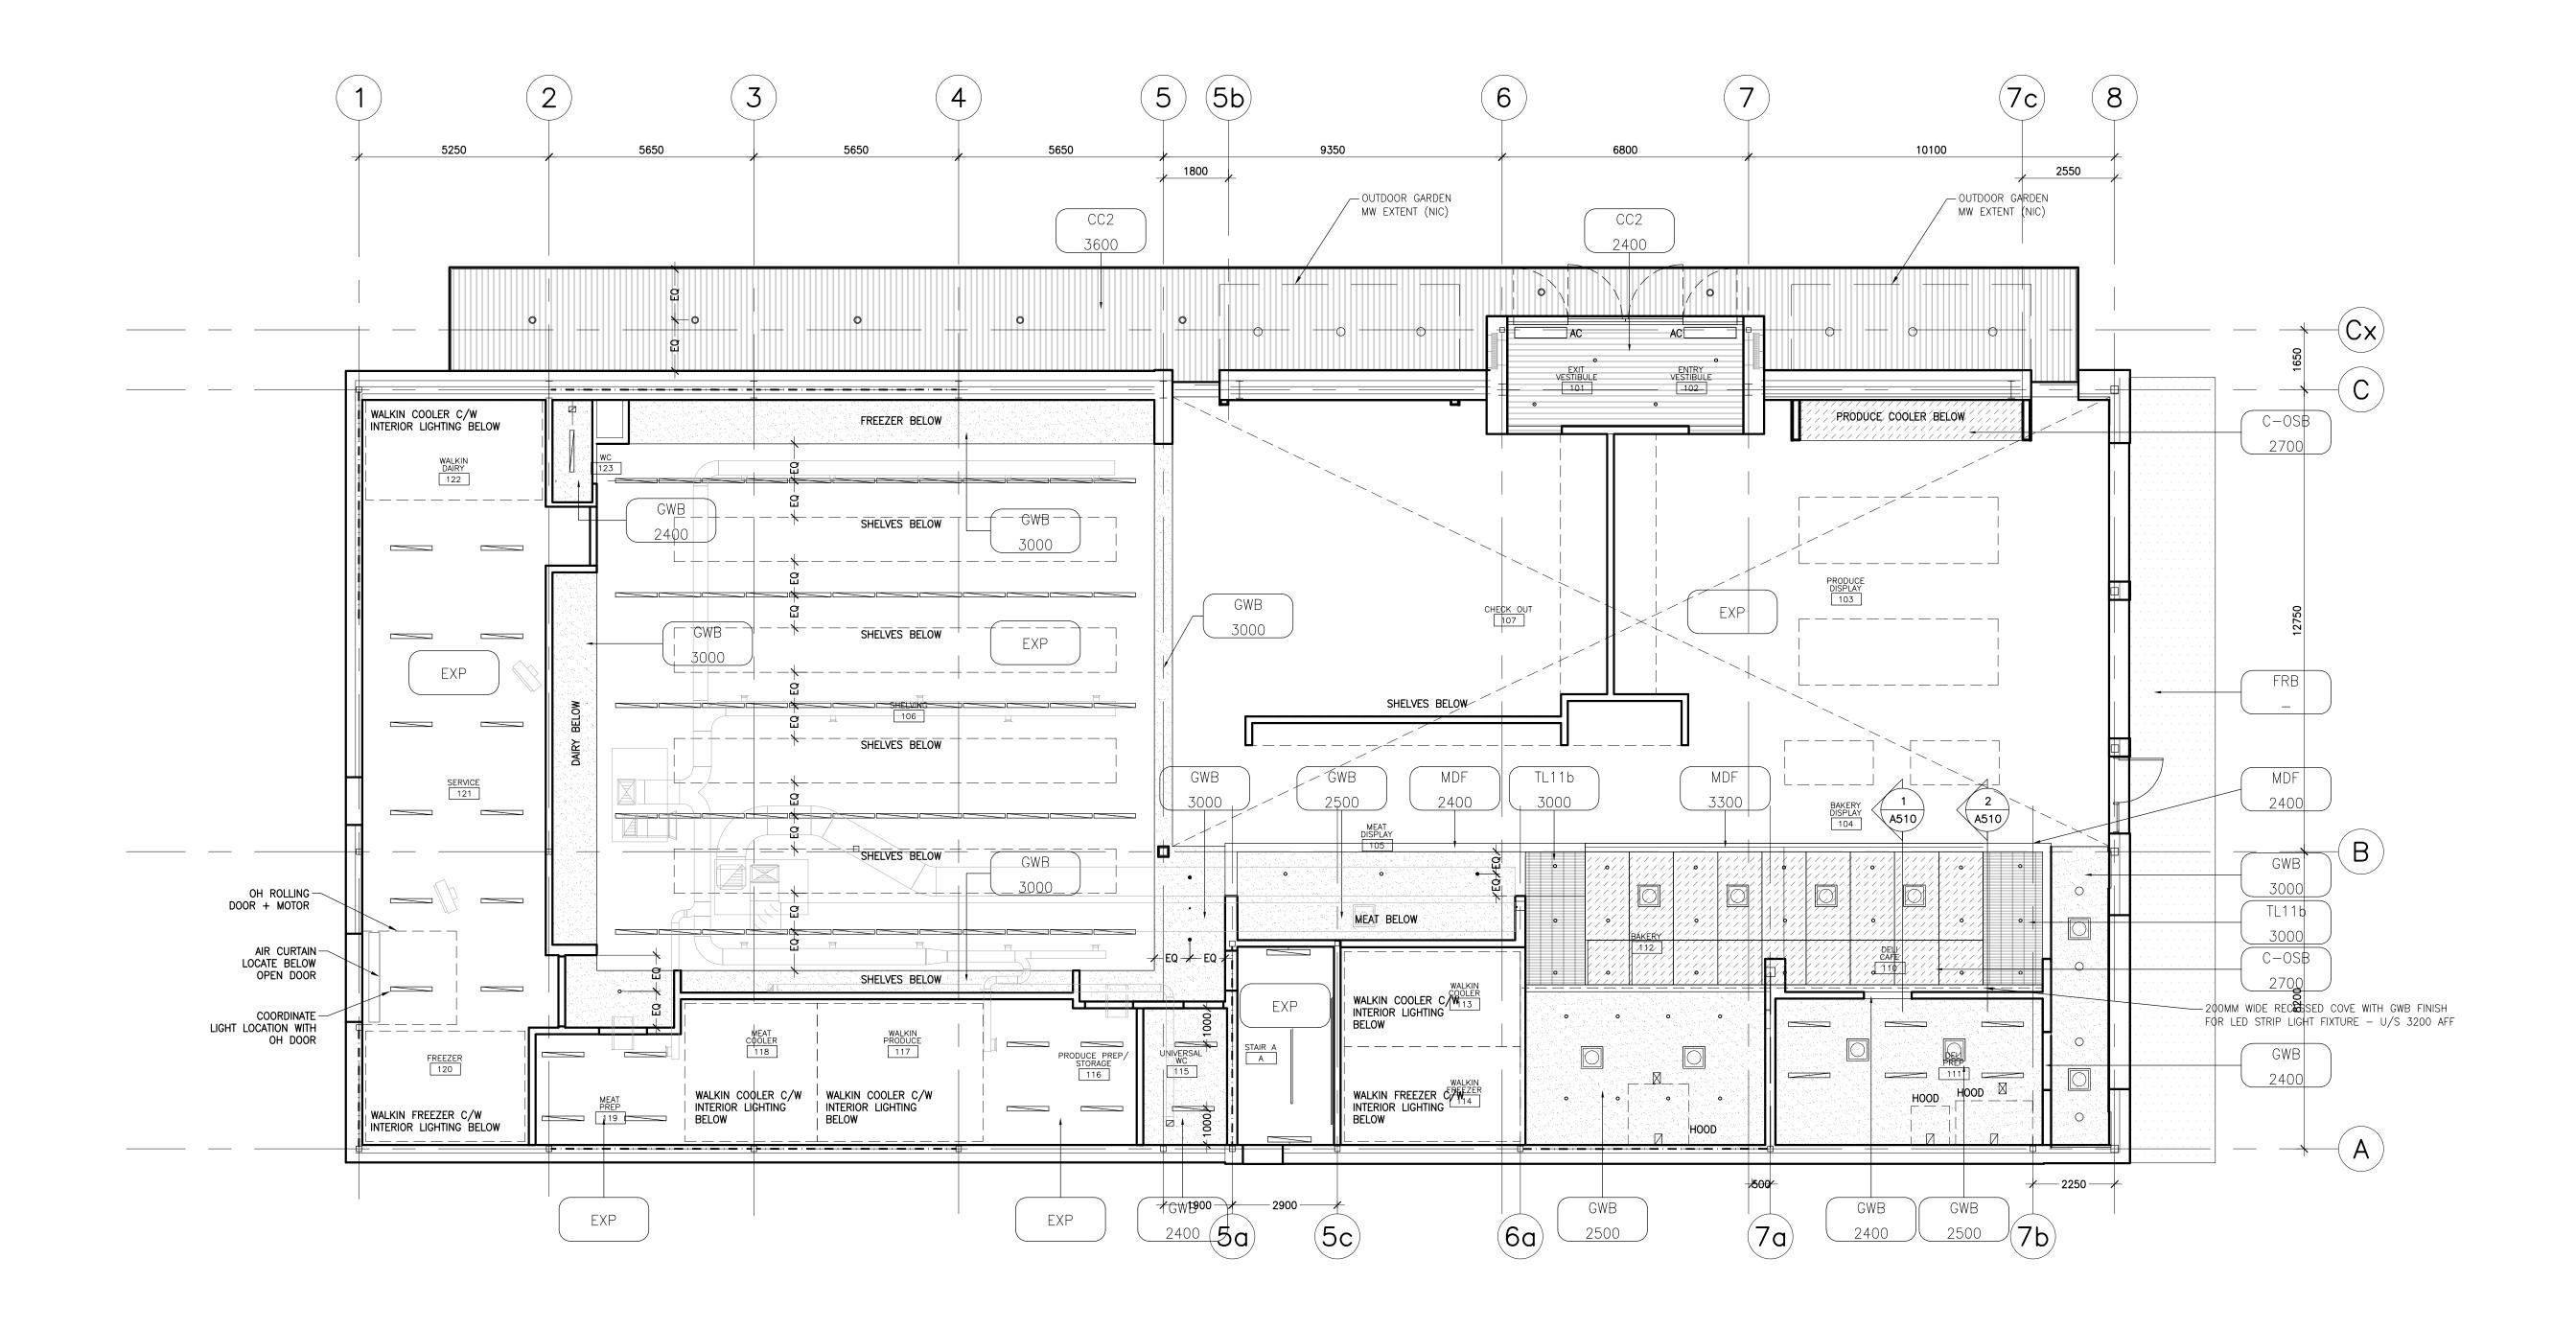
ROOF PLAN

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JANUARY 24, 2022

PROJECT NUMBER 2102

DRAWING NUMBER



REVISIONS	AND ISSUES		
REV	DESCRIPTION	DATE	BY
1	ISSUED FOR SPA	210618	AB
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229 BROADWAY, UNIT 1

ORANGEVILLE, ONTARIO, L9W 1K4 TEL 519 941 0330 FAX 519 941 1830

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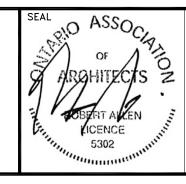
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PROJECT TITLE

NEW SAYERS FOOD STORE BURLEIGH STREET, APSLEY

DRAWING TITLE

GROUND LEVEL
REFLECTED CEILING PLANS


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JANUARY 24, 2022

PROJECT NUMBER 2102

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REVISIONS AND ISSUES			
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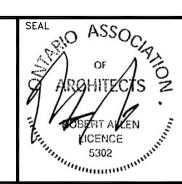
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PROJECT TITLE

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BURLEIGH STREET, APSLEY

DRAWING TITLE

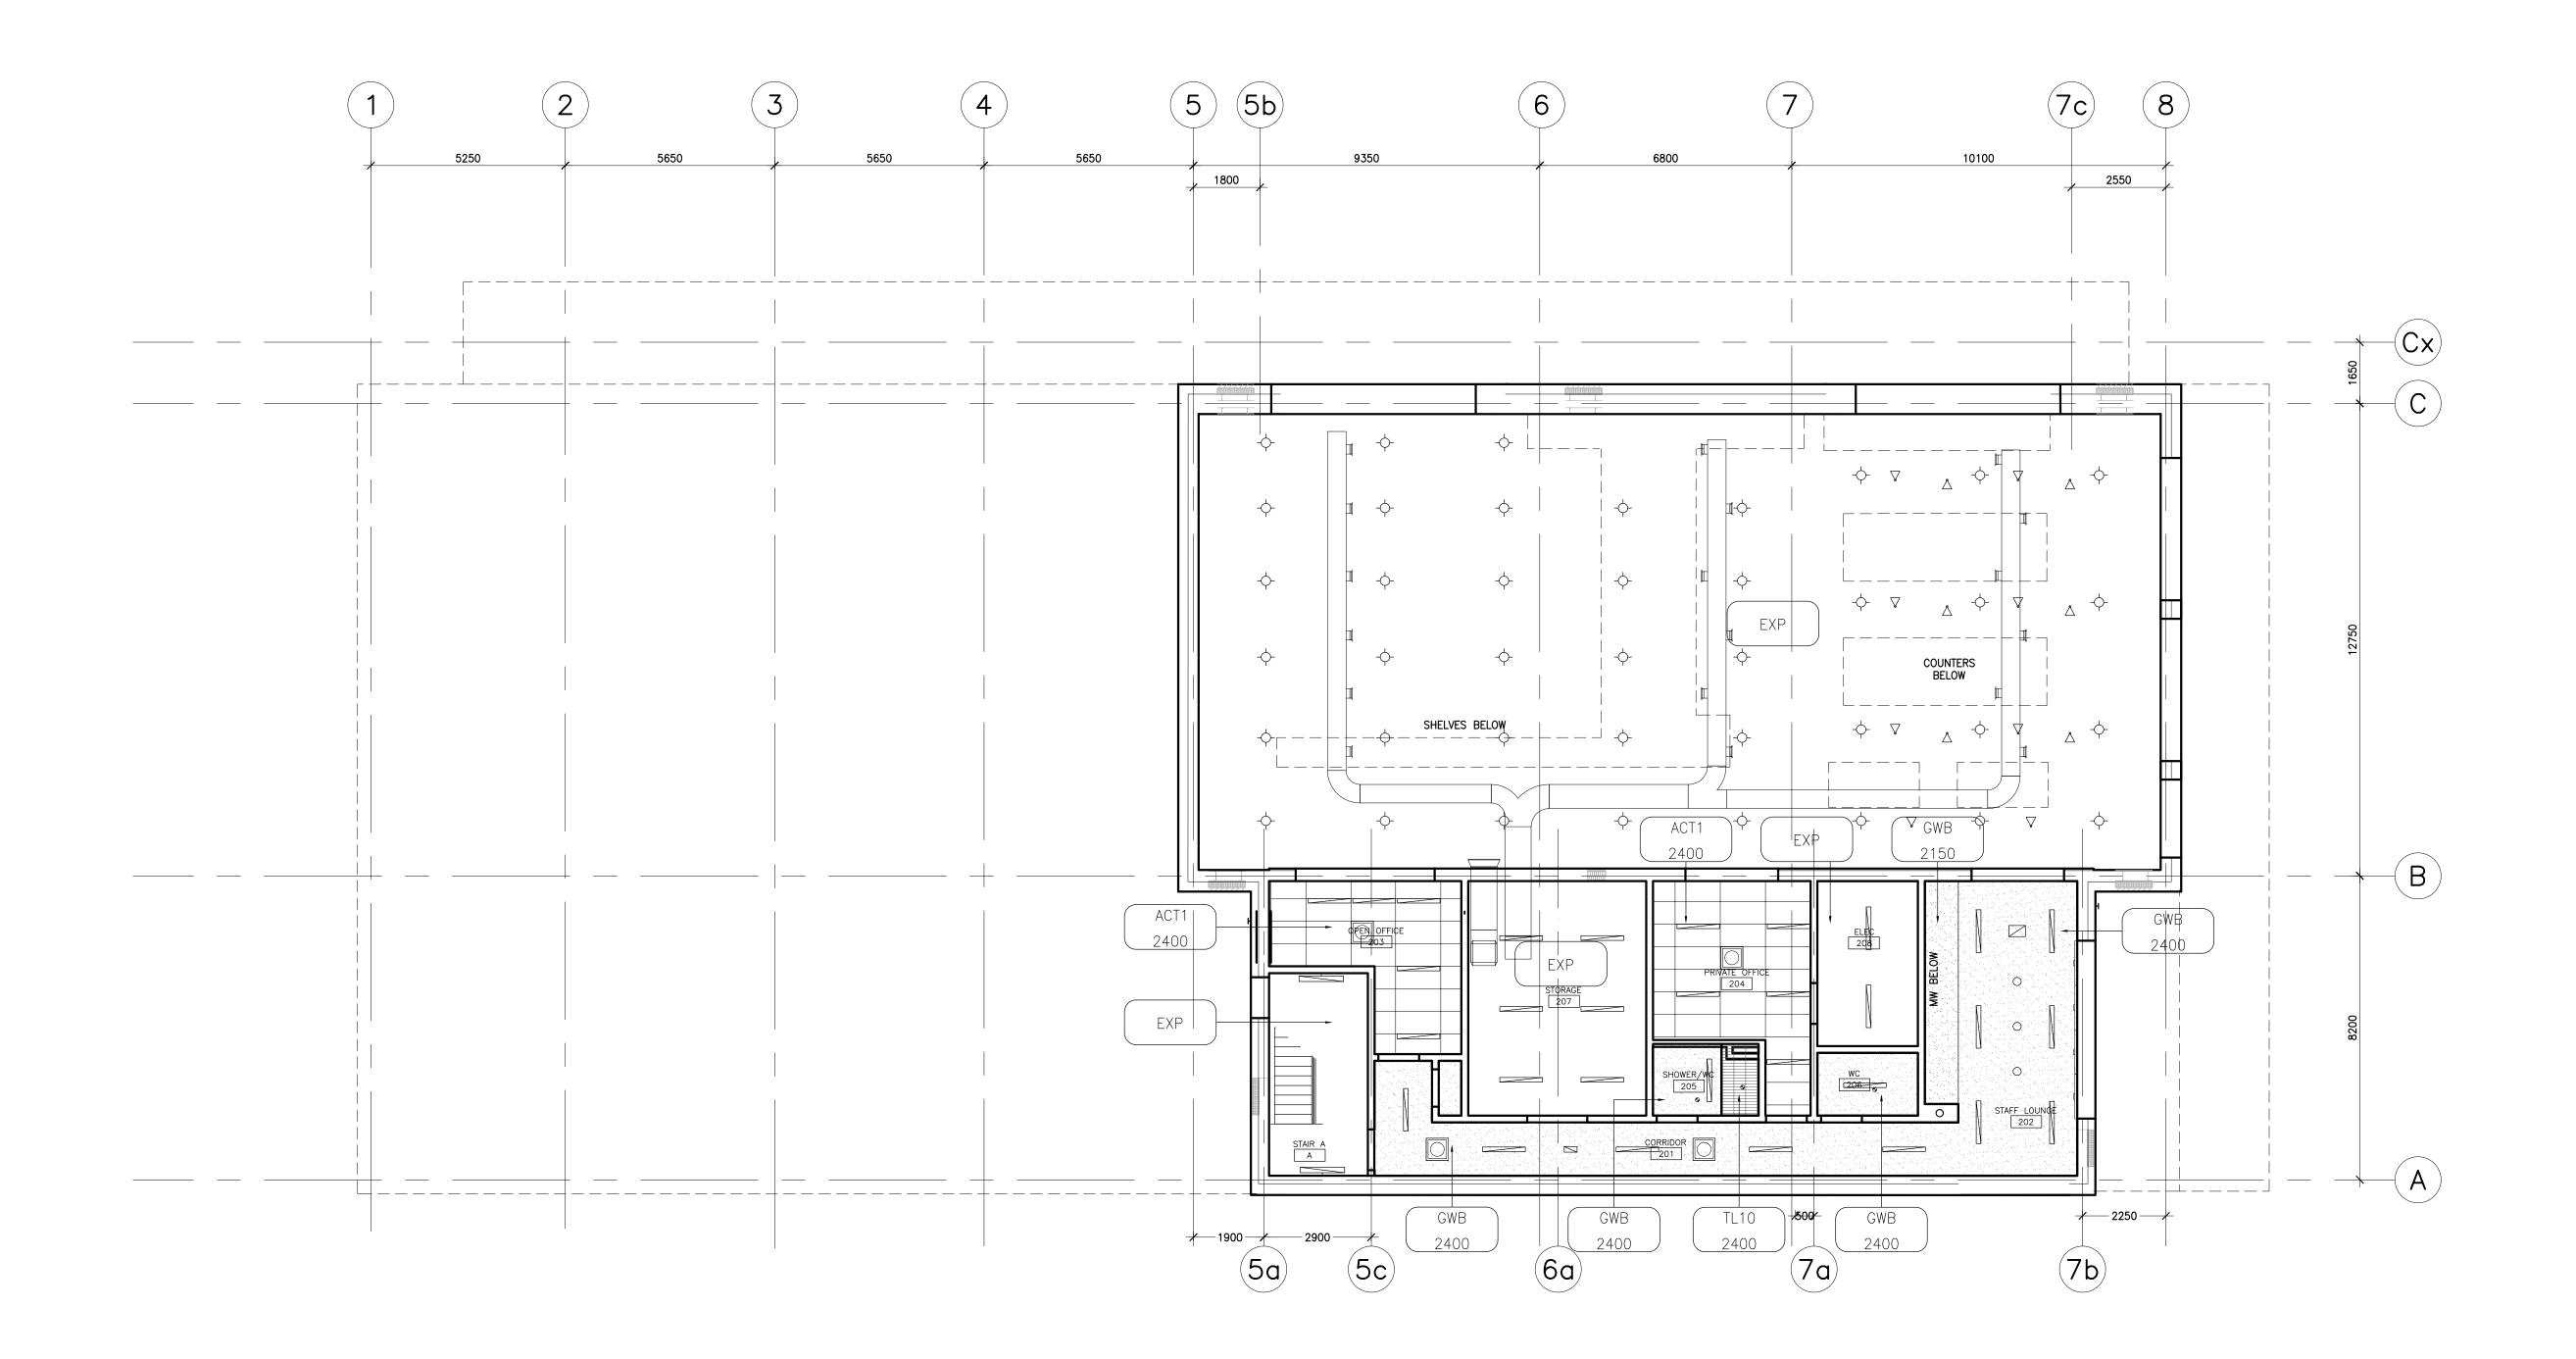LEVEL 2 REFLECTED CEILING PLAN


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PROJECT NUMBER 2102

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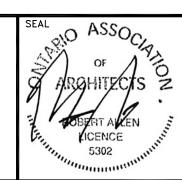
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PROJECT TITLE

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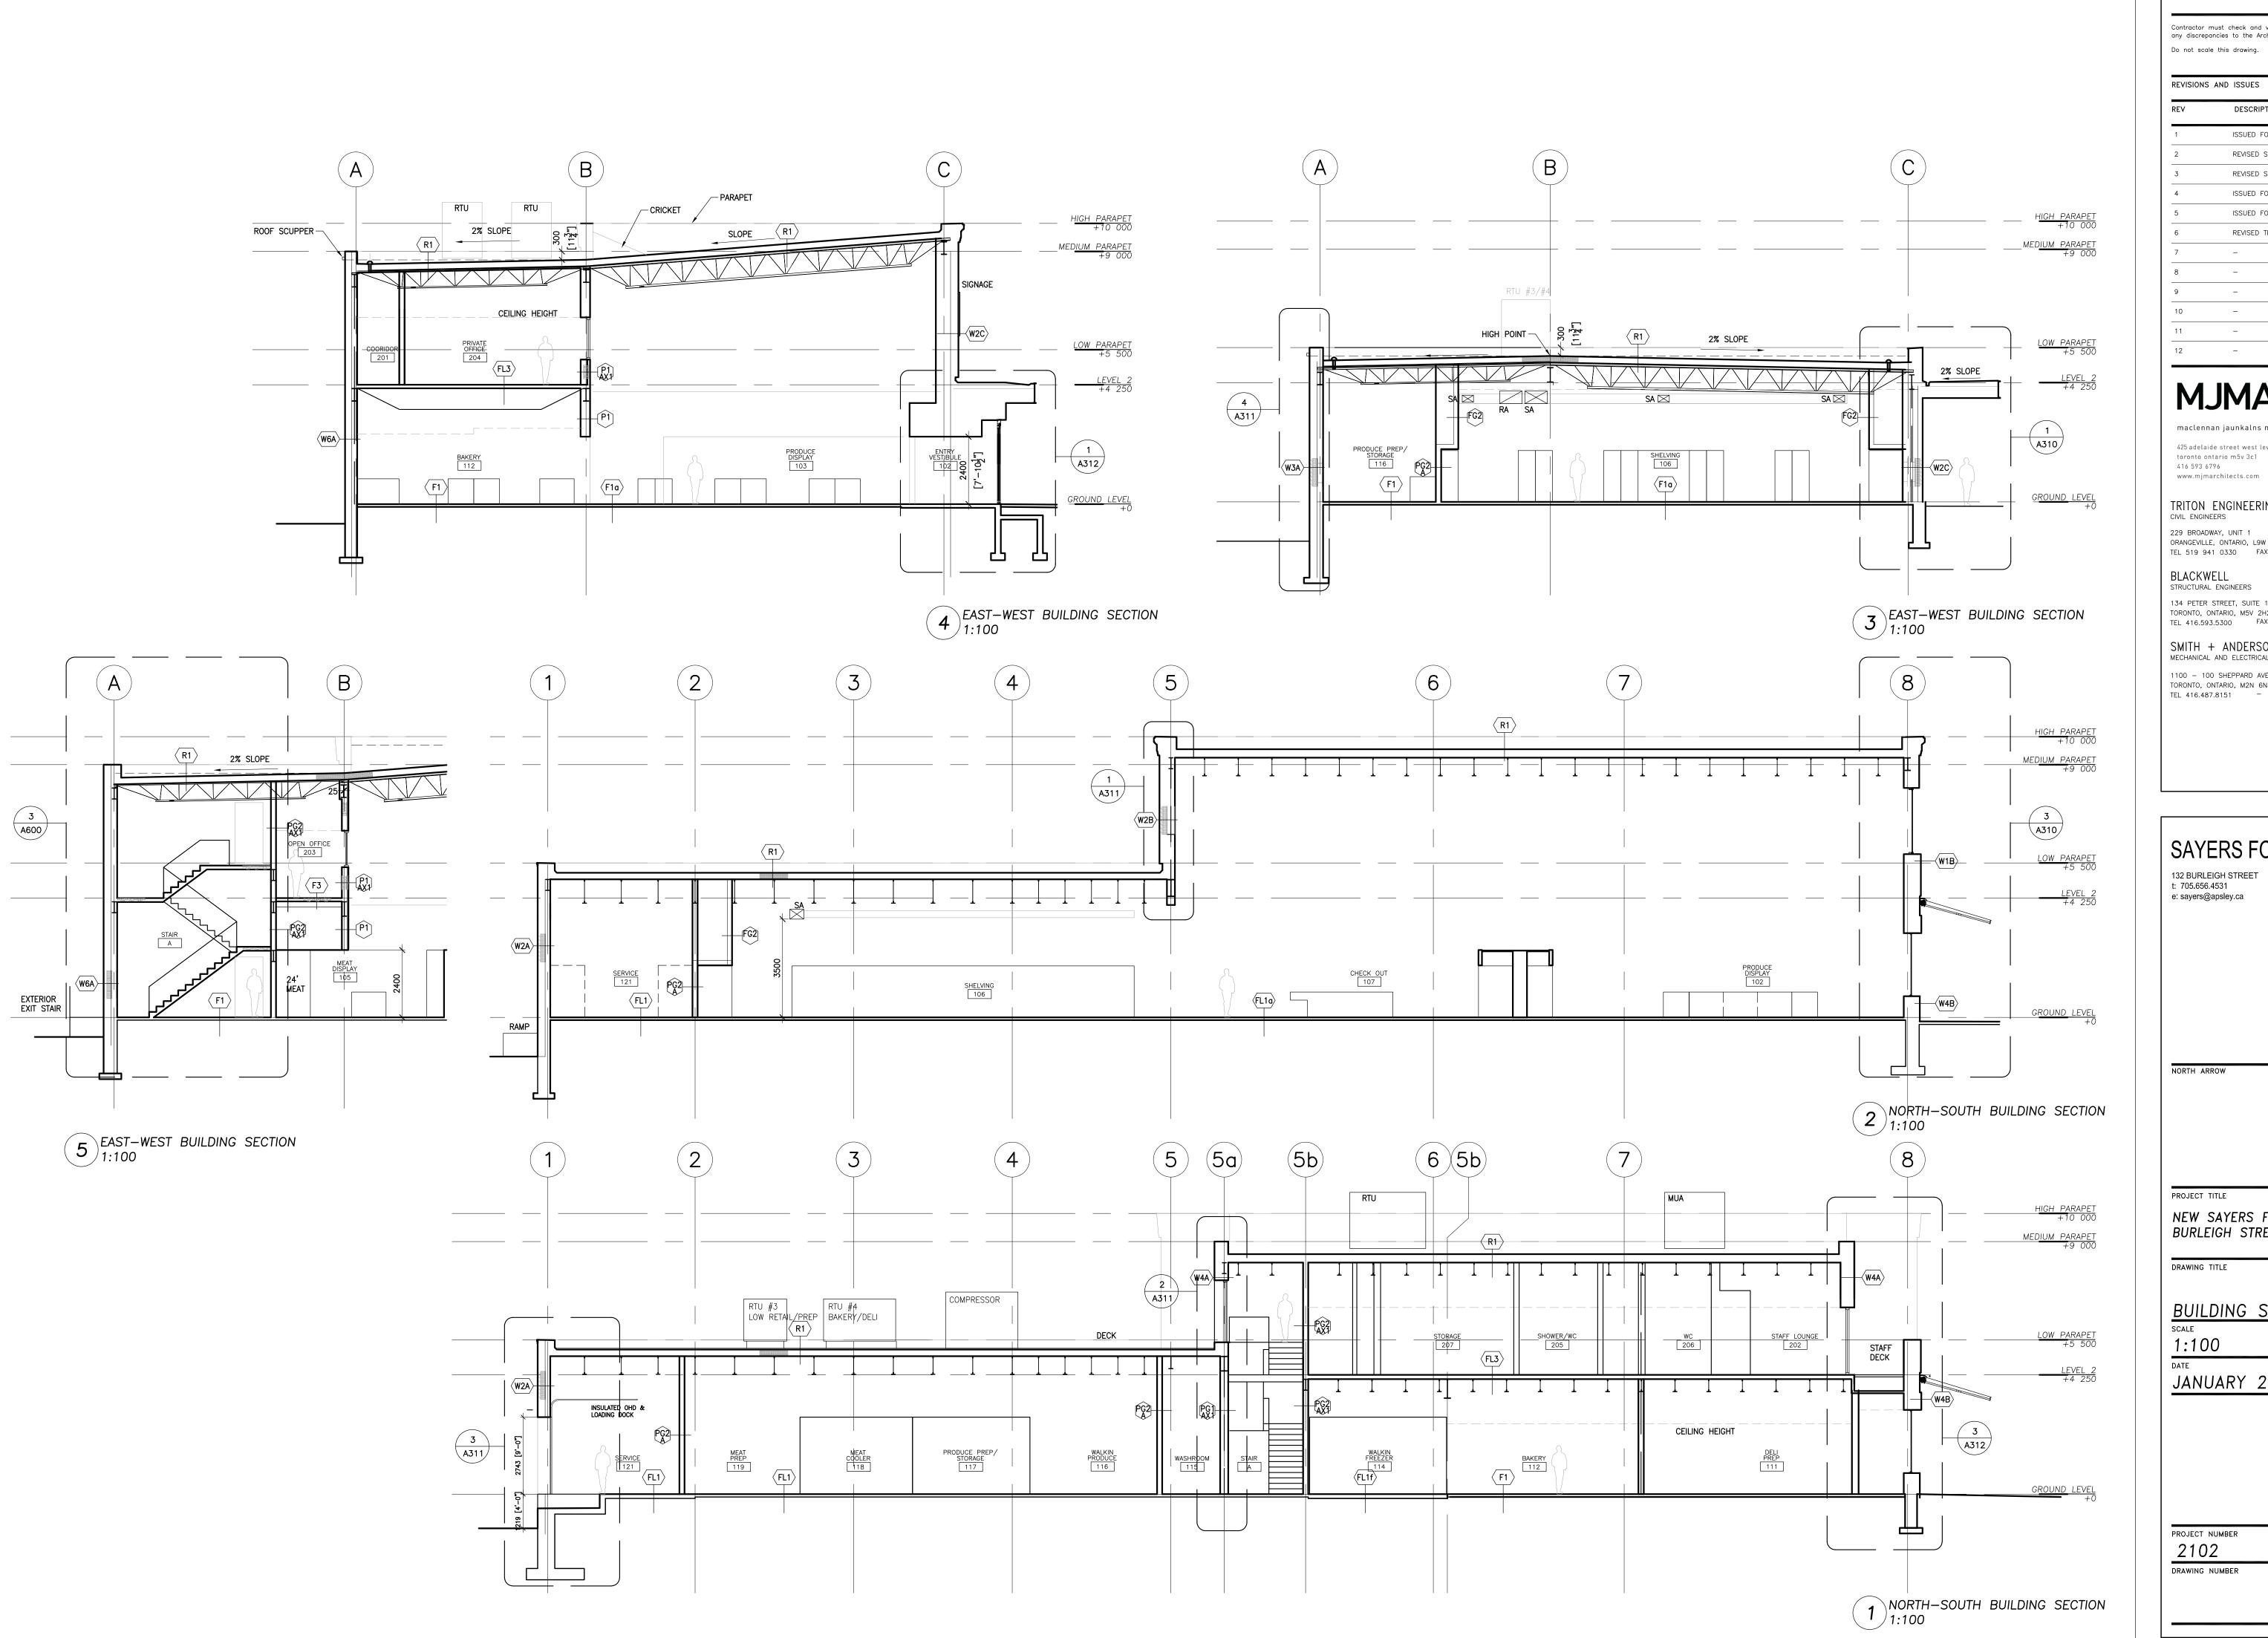
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JANUARY 24, 2022

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REVISIONS	AND ISSUES		
REV	DESCRIPTION	DATE	BY
1	ISSUED FOR SPA	210618	AB
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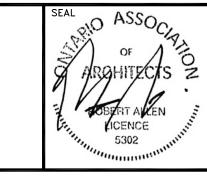
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PROJECT TITLE

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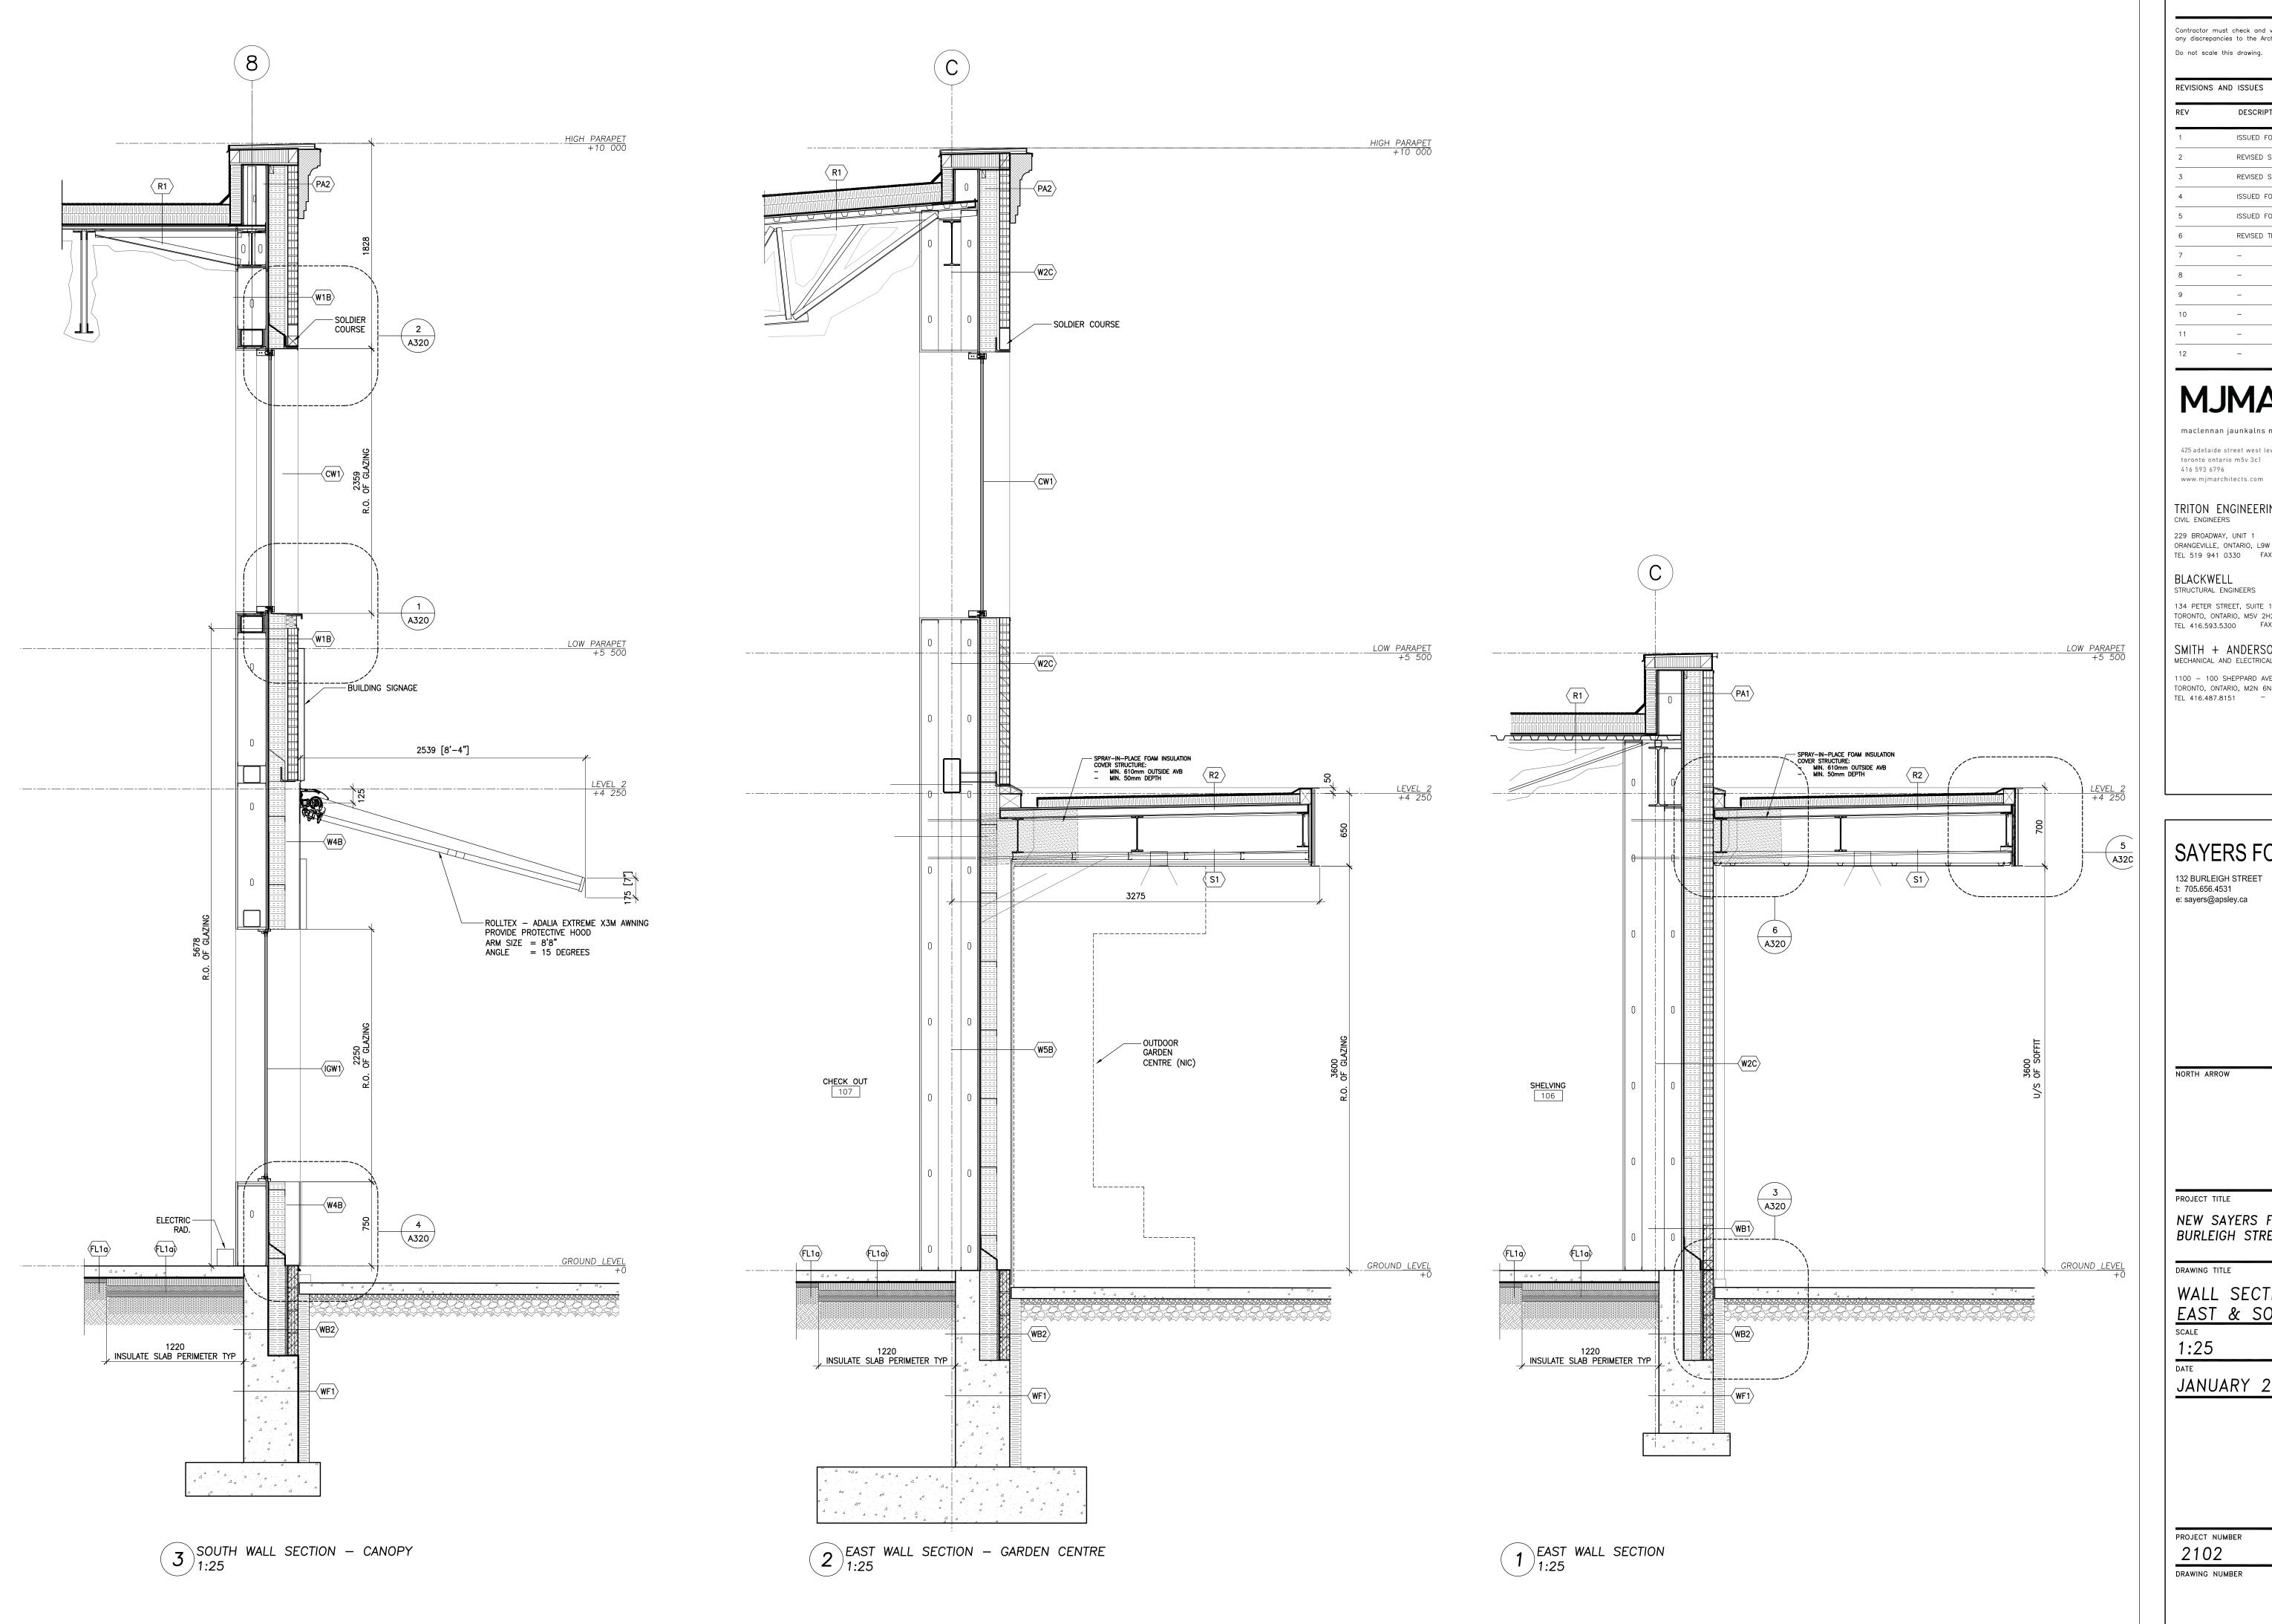
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BUILDING SECTIONS
SCALE
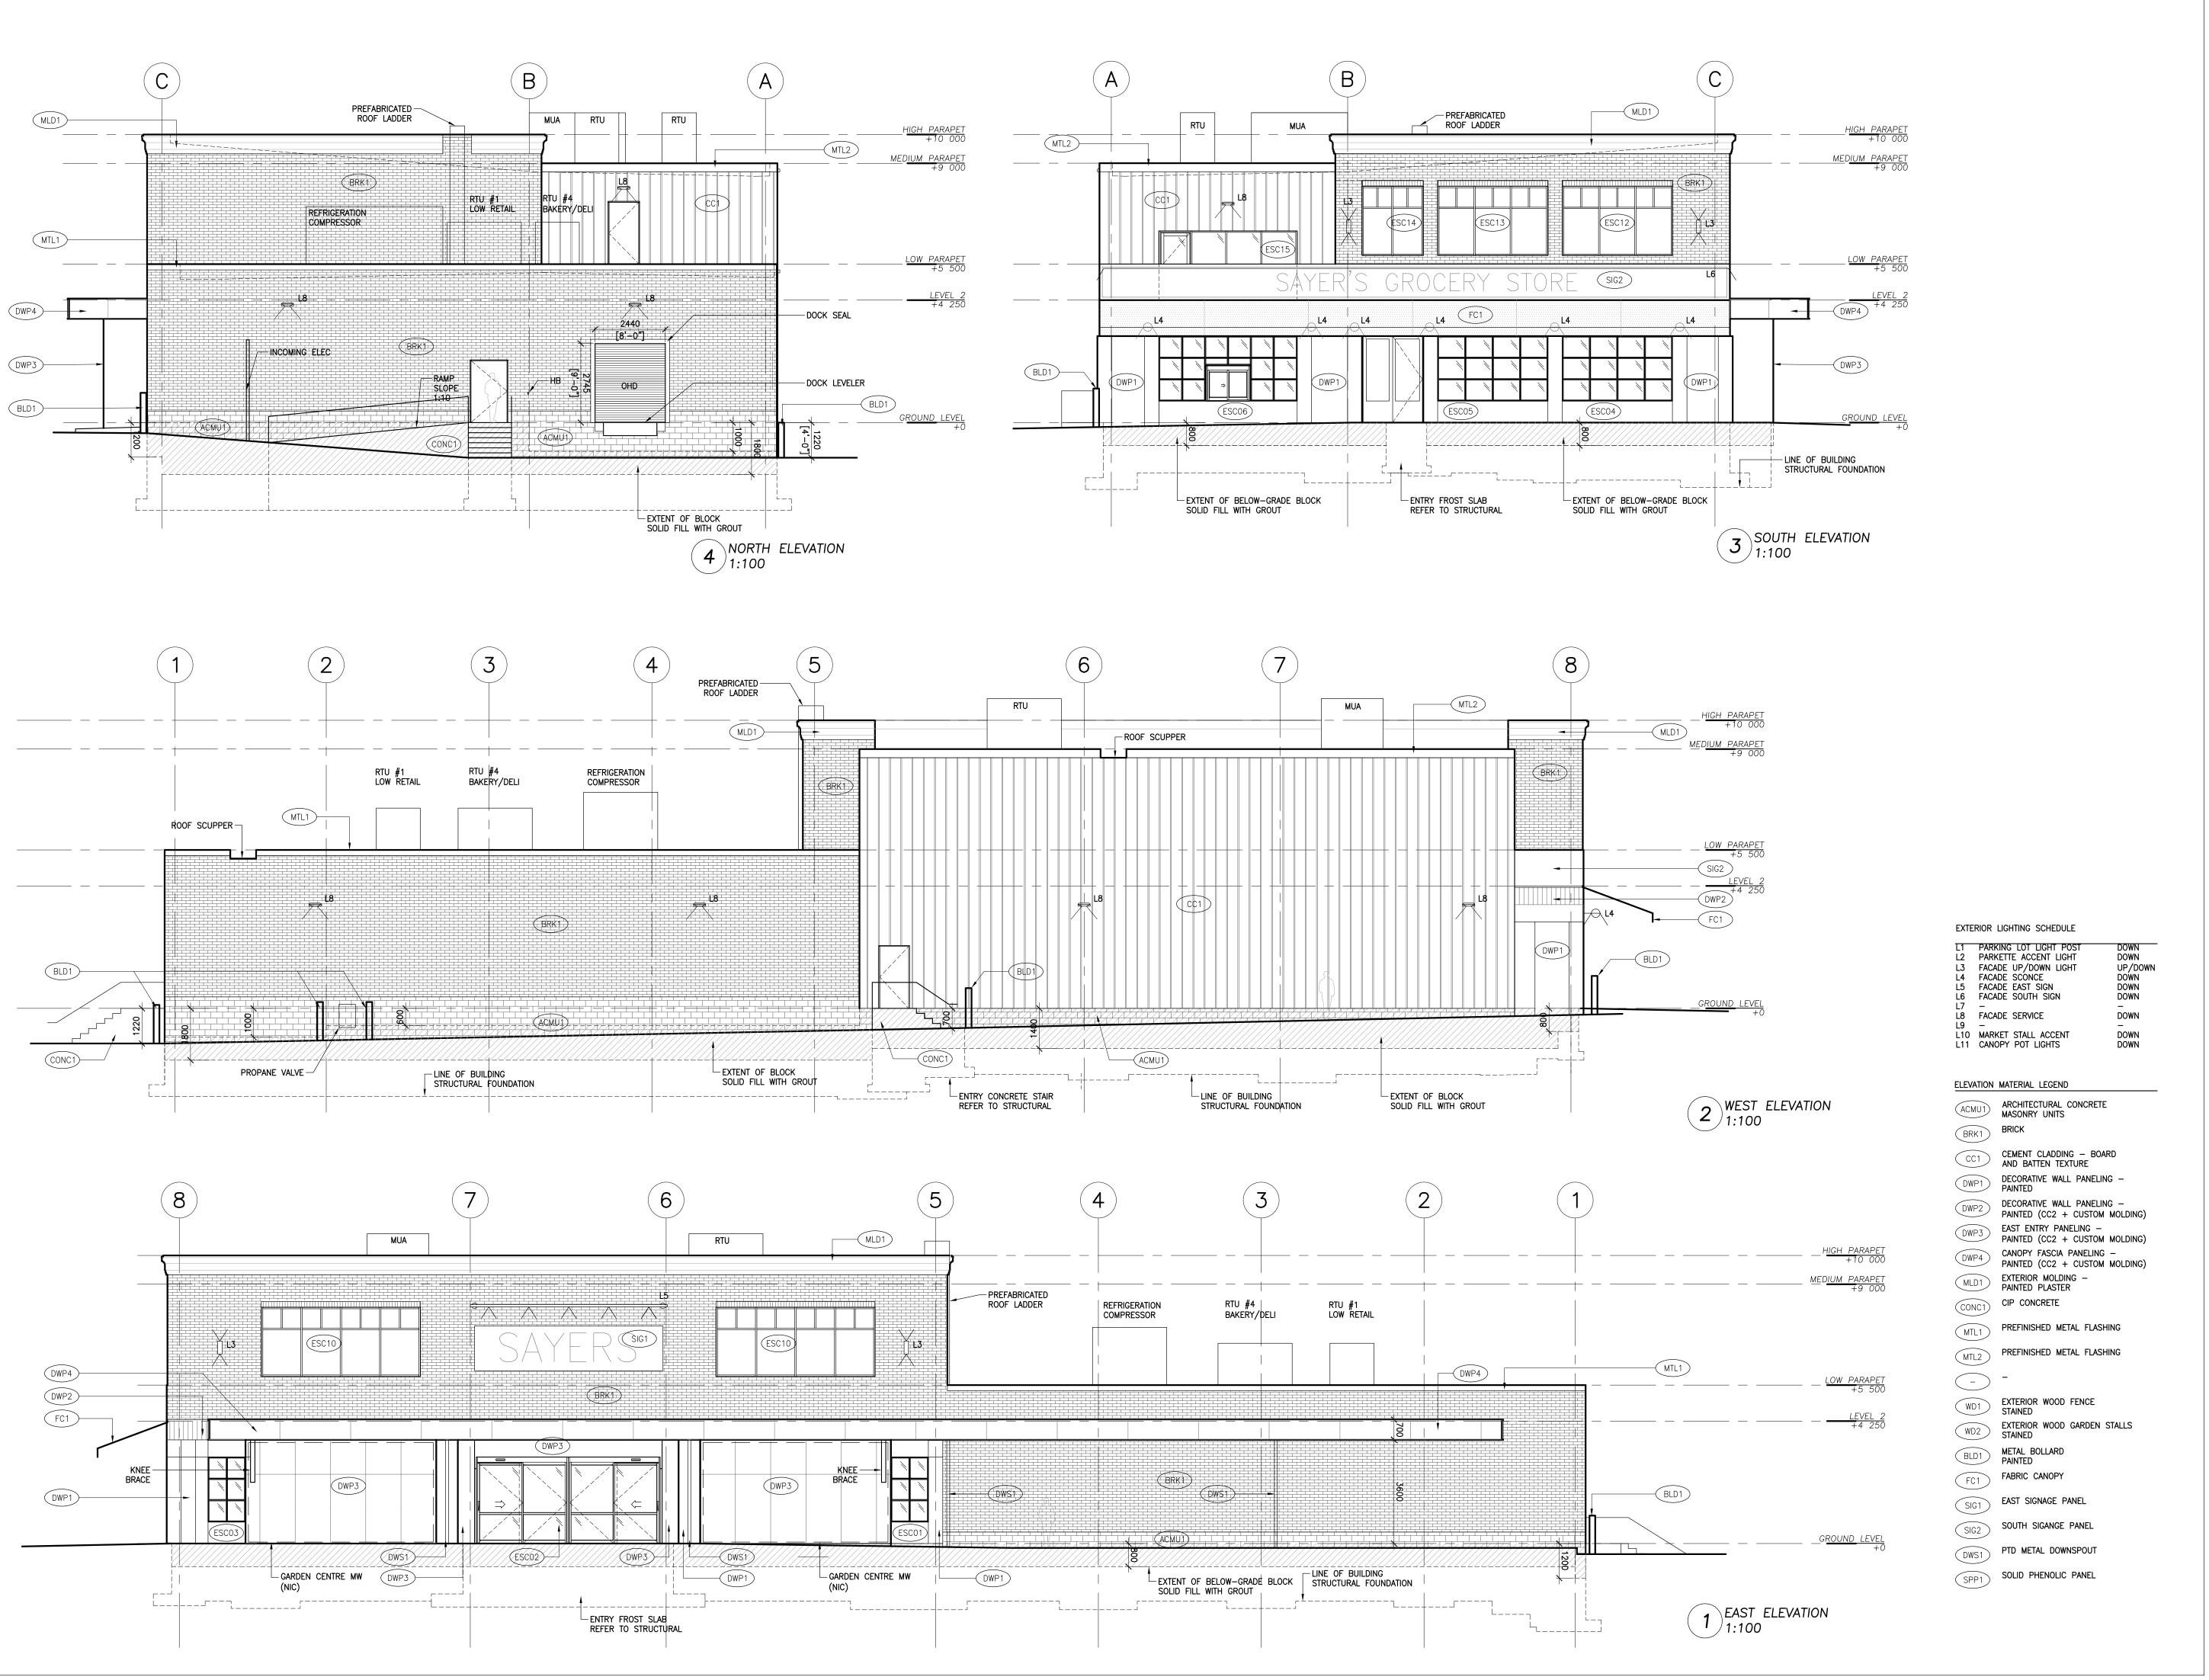
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JANUARY 24, 2022

PROJECT NUMBER 2102 DRAWING NUMBER



REV	DESCRIPTION	DATE	В
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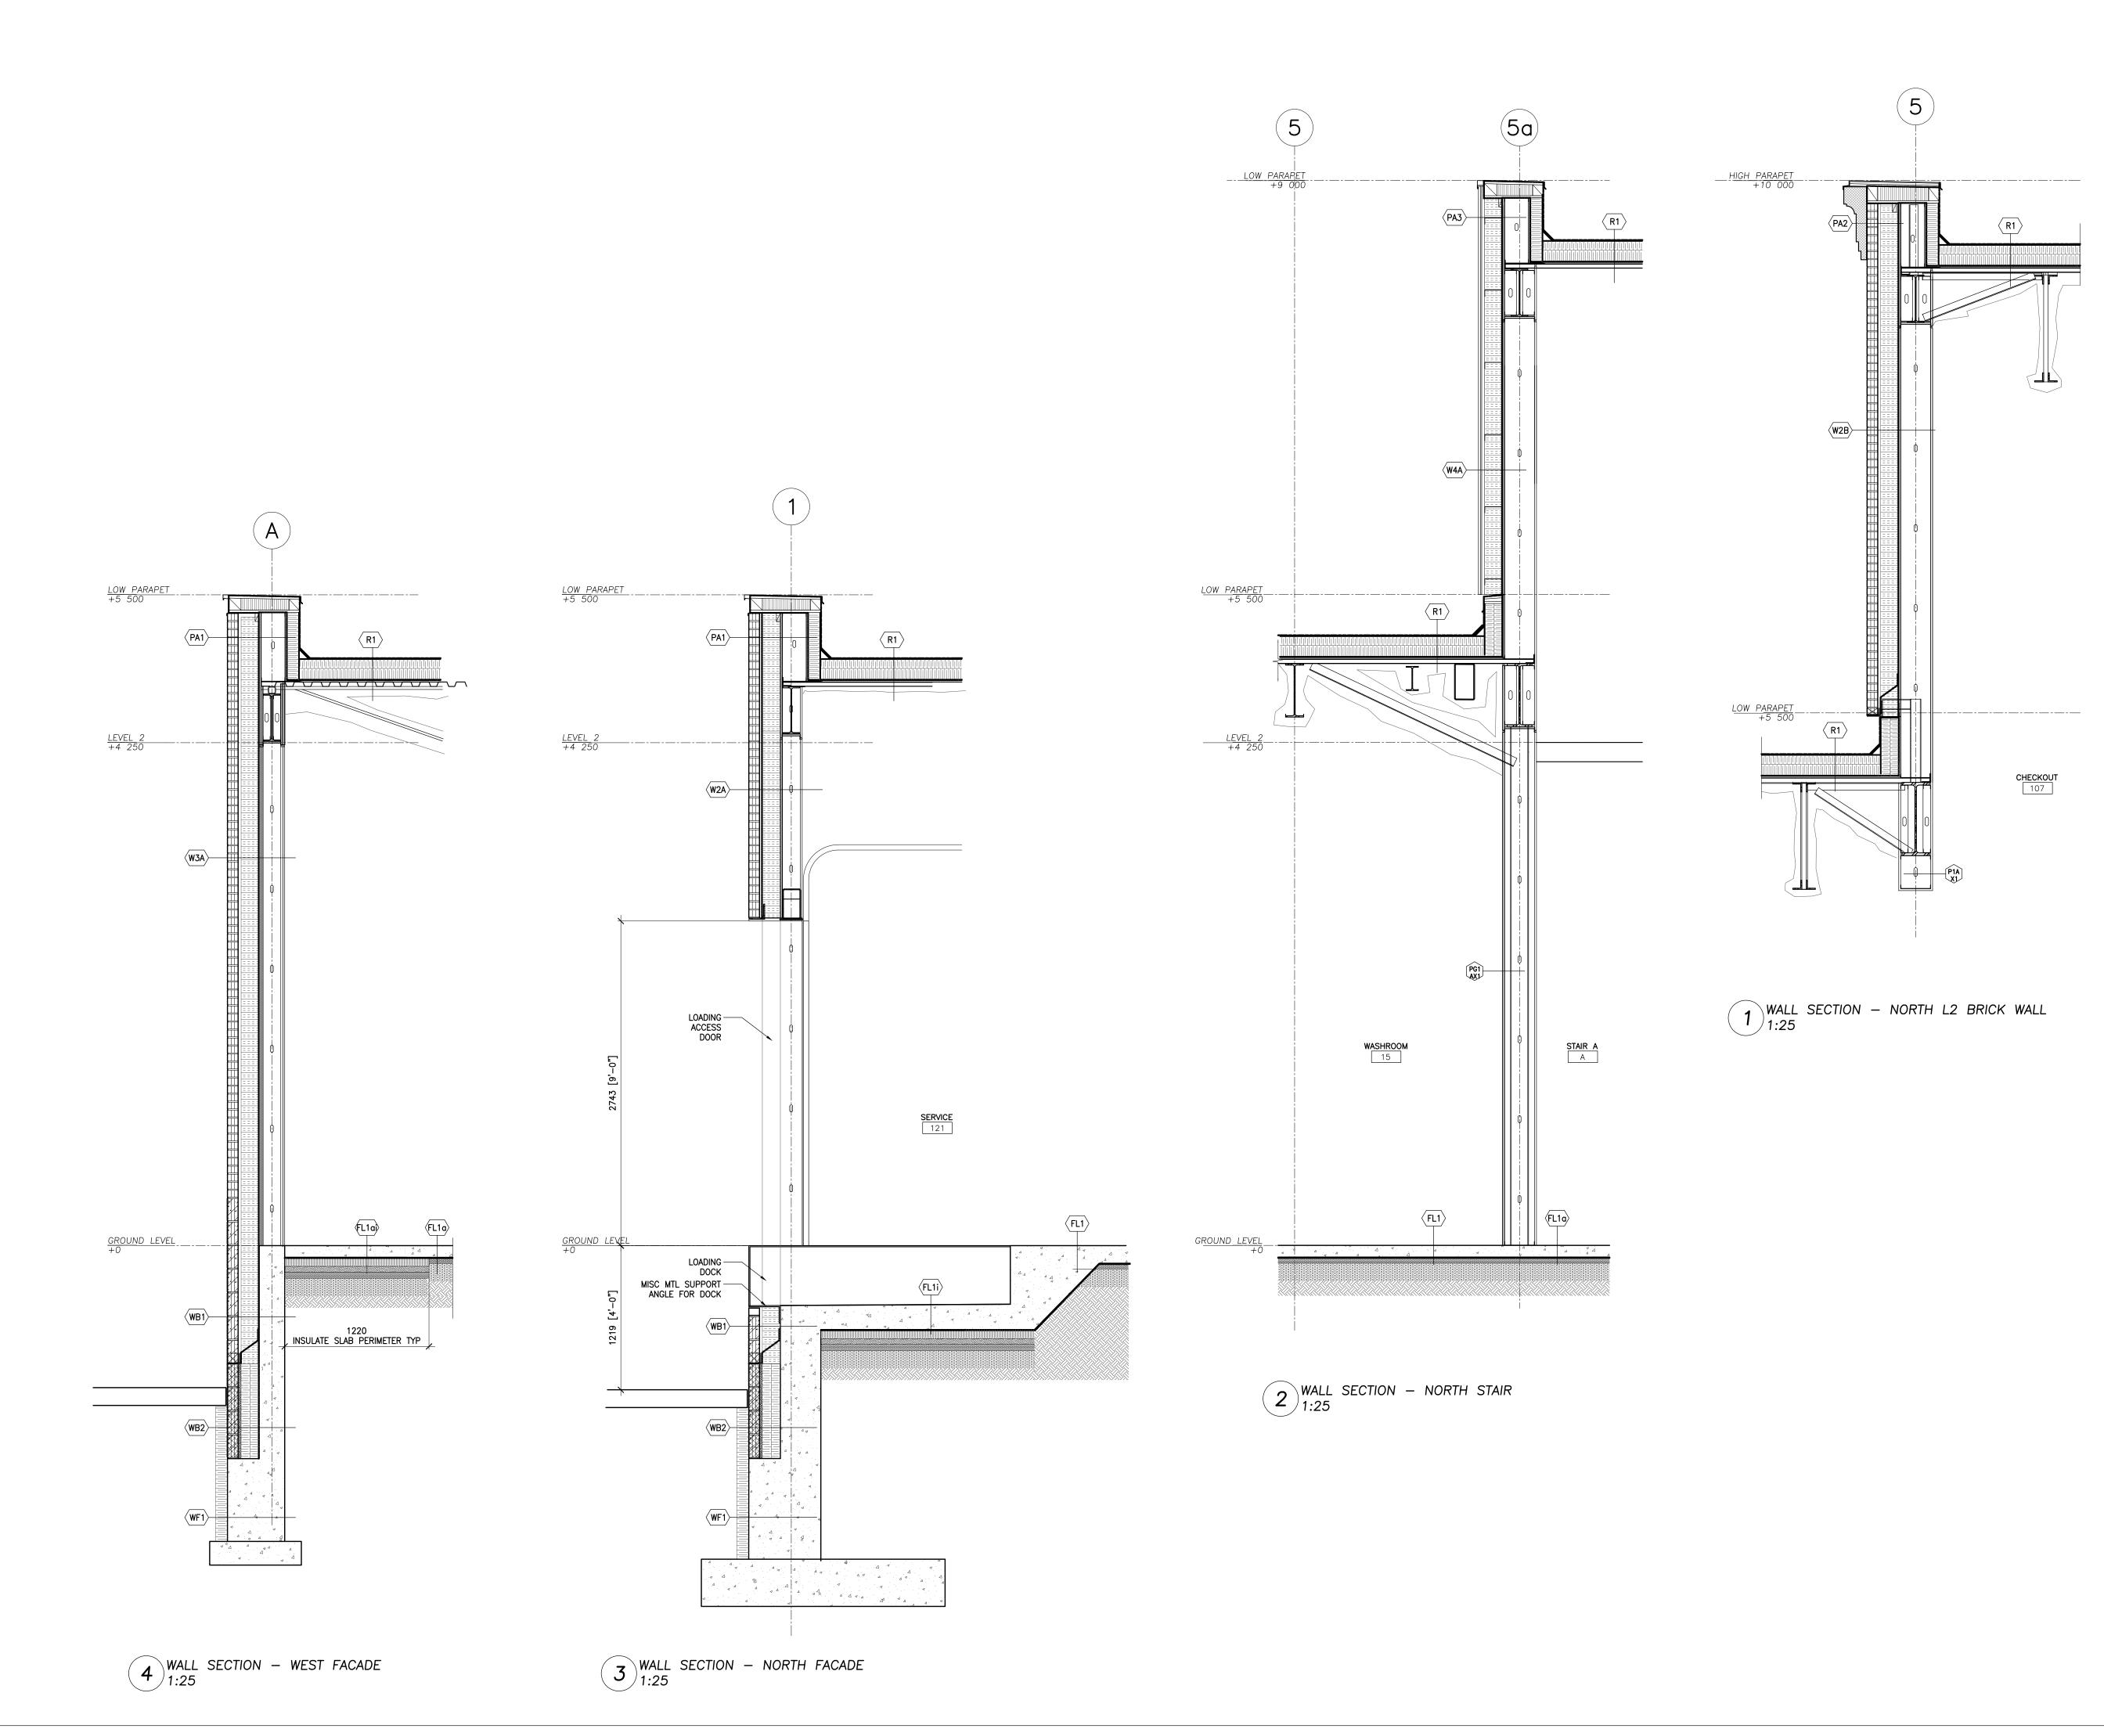
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WALL SECTIONS EAST & SOUTH FACADES
SCALE

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JANUARY 24, 2022

PROJECT NUMBER 2102 DRAWING NUMBER



REVISIONS AND ISSUES			
REV	DESCRIPTION	DATE	BY
1	ISSUED FOR SPA	210618	AB
2	REVISED SPA	210709	AB
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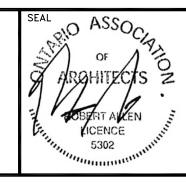
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PROJECT TITLE

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DRAWING TITLE


WALL SECTIONS
NORTH & WEST FACADES

SCALE
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DATE

JANUARY 24, 2022

PROJECT NUMBER 2102

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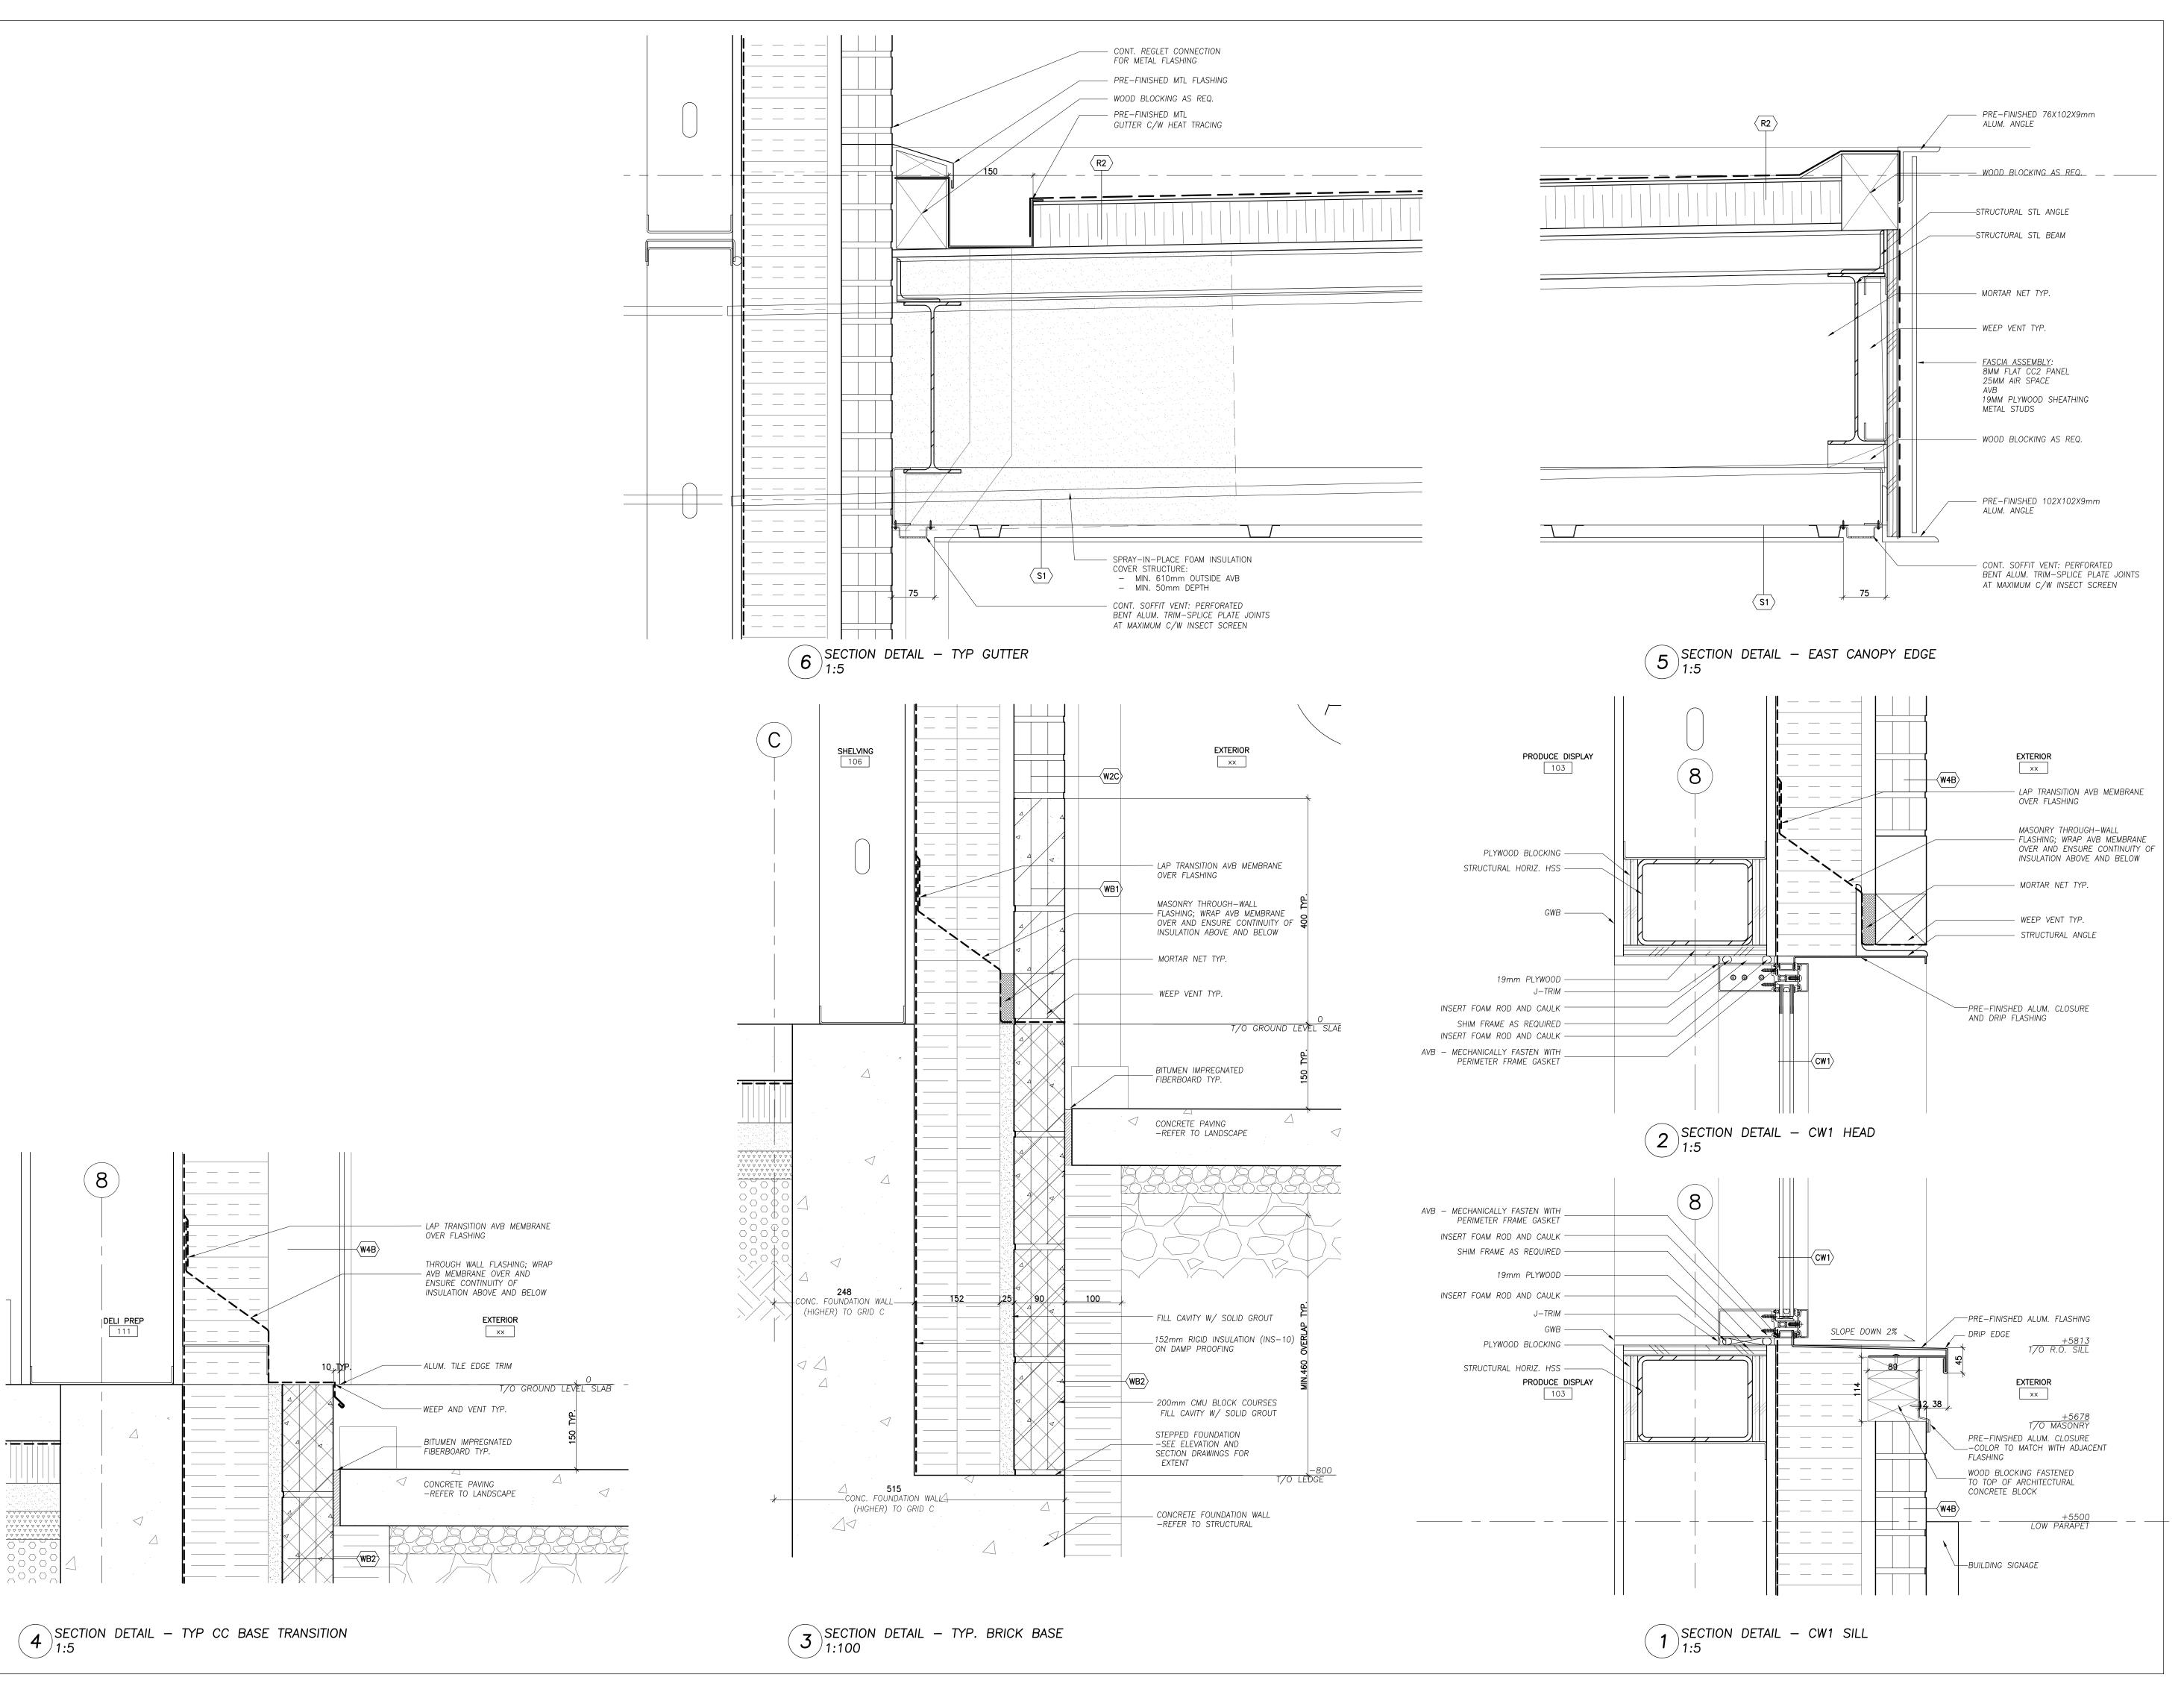
PROJECT TITLE

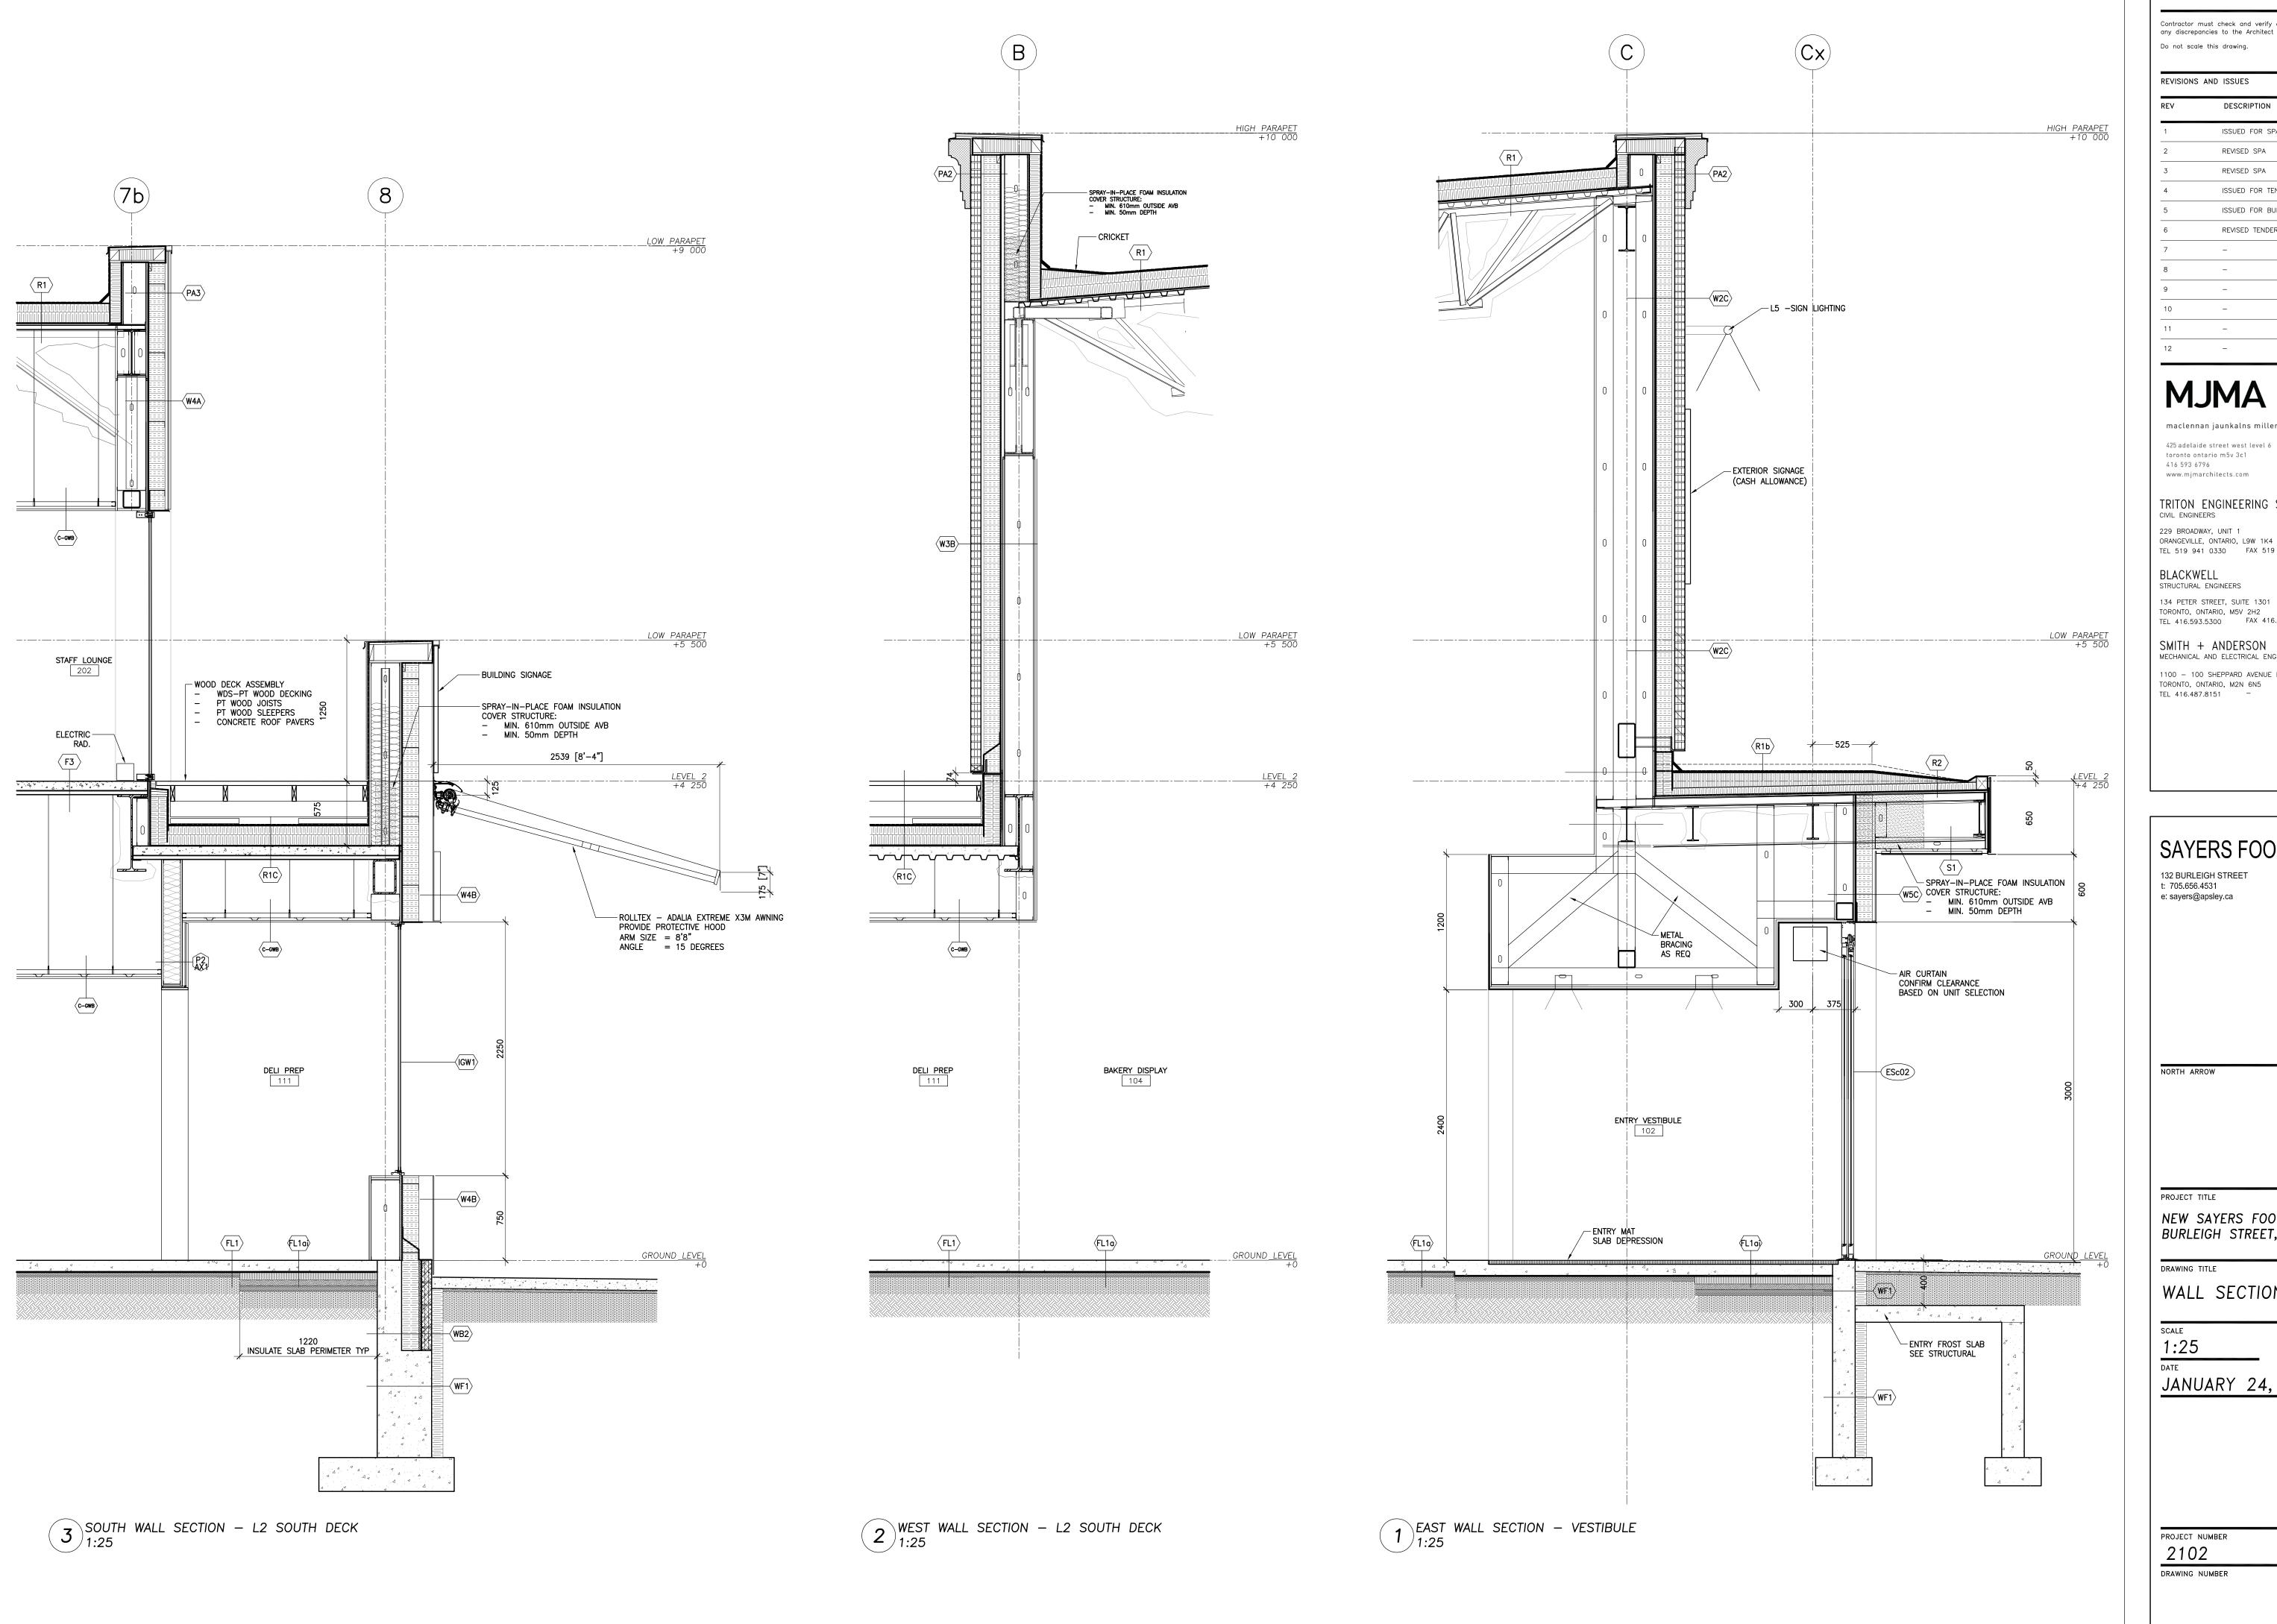NEW SAYERS FOOD STORE BURLEIGH STREET, APSLEY

WALL SECTIONS

JANUARY 24, 2022

PROJECT NUMBER 2102



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BLACKWELL STRUCTURAL ENGINEERS

134 PETER STREET, SUITE 1301 TORONTO, ONTARIO, M5V 2H2
TEL 416.593.5300 FAX 416.593.4840

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PROJECT TITLE

NEW SAYERS FOOD STORE BURLEIGH STREET, APSLEY


DRAWING TITLE

SECTION DETAIL


JANUARY 24, 2022


PROJECT NUMBER 2102


DRAWING NUMBER

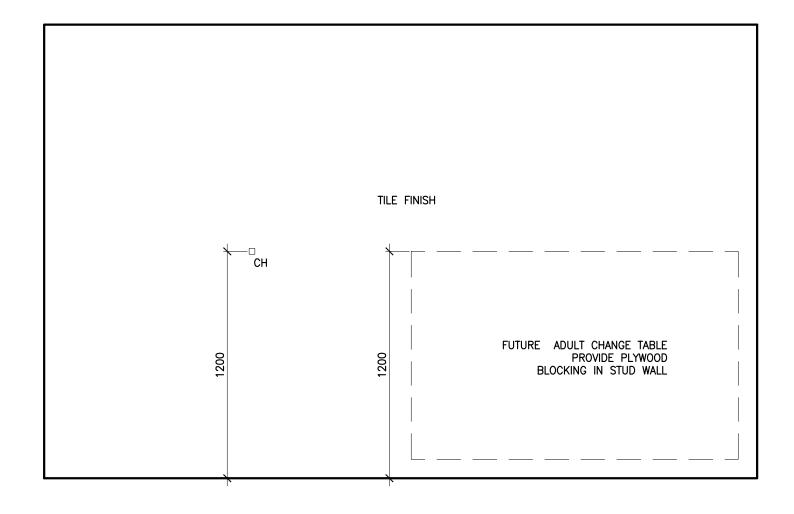

5 INT. ELEVATION - UNI. WC SOUTH

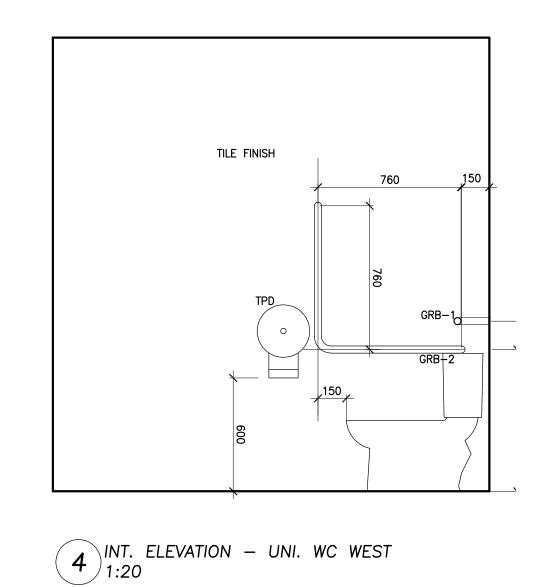


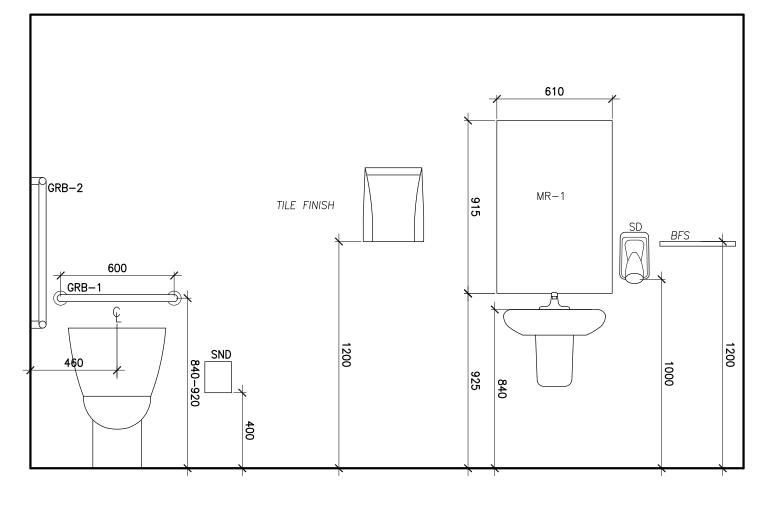


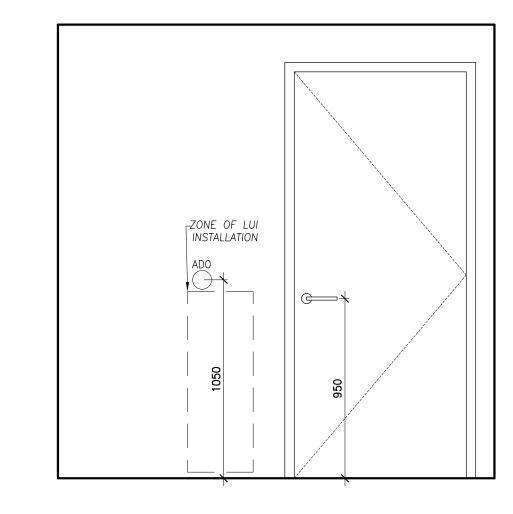

3 INT. ELEVATION - UNI. WC NORTH

2 INT. ELEVATION - UNI. WC EAST 1:20

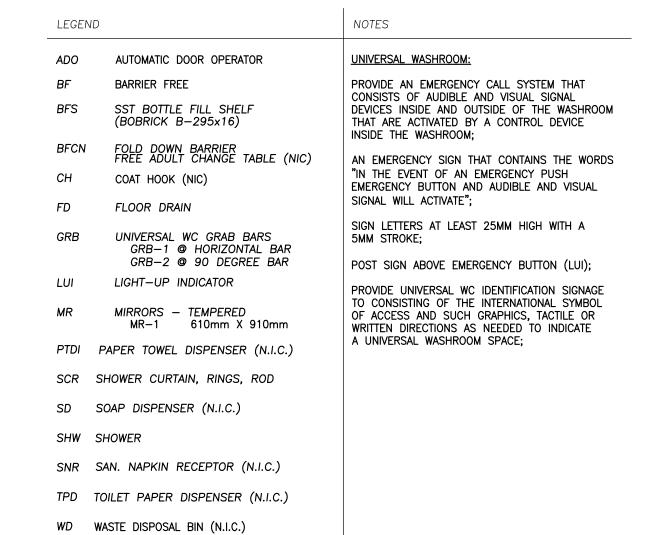

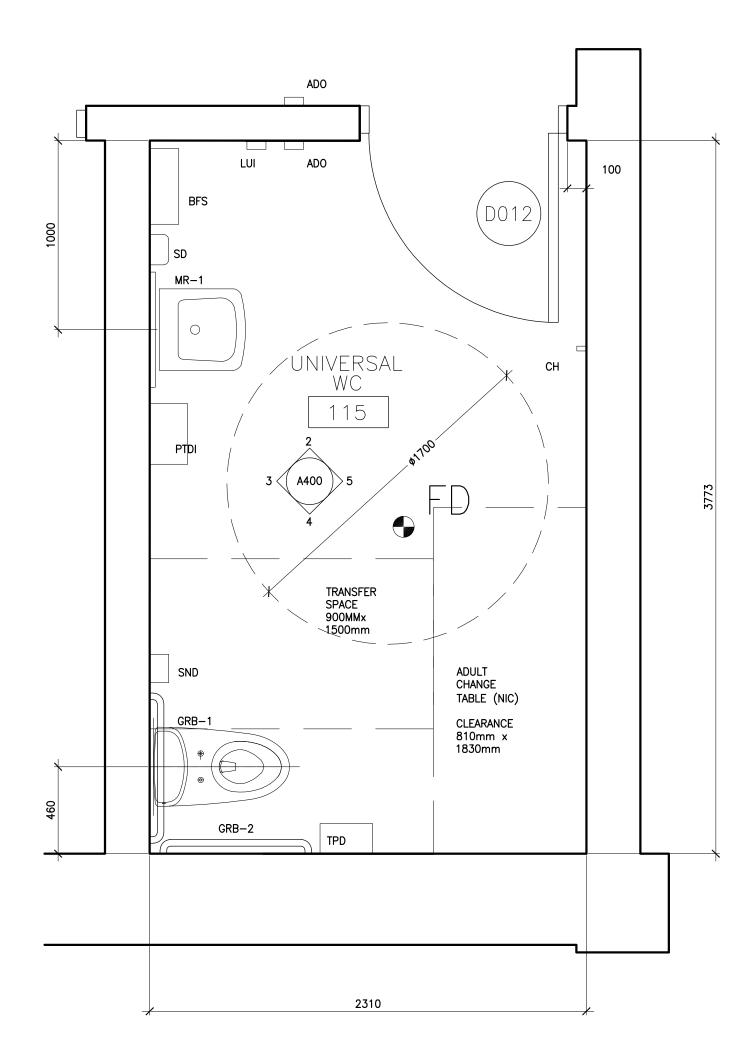

1 PLAN CALLOUT - UNIVERSAL WC 1:20

Contractor must check and verify all dimensions on the job, and report any discrepancies to the Architect before proceeding with the work. Do not scale this drawing.

REV	DESCRIPTION	DATE	В
1	ISSUED FOR SPA	210618	ΑĒ
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7	-	_	-
8	-	-	_
9	-	_	_
10	-	-	_
11	-	-	-
12	_	_	_

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maclennan jaunkalns miller architects

425 adelaide street west level 6 toronto ontario m5v 3c1 416 593 6796 www.mjmarchitects.com

TRITON ENGINEERING SERVICES LTD CIVIL ENGINEERS

229 BROADWAY, UNIT 1
ORANGEVILLE, ONTARIO, L9W 1K4
TEL 519 941 0330 FAX 519 941 1830

BLACKWELL STRUCTURAL ENGINEERS

134 PETER STREET, SUITE 1301 TORONTO, ONTARIO, M5V 2H2
TEL 416.593.5300 FAX 416.593.4840


SMITH + ANDERSON MECHANICAL AND ELECTRICAL ENGINEERS

1100 — 100 SHEPPARD AVENUE EAST TORONTO, ONTARIO, M2N 6N5 TEL 416.487.8151 -

SAYERS FOOD LIMITED

132 BURLEIGH STREET t: 705.656.4531 e: sayers@apsley.ca



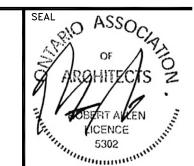

PROJECT TITLE

NEW SAYERS FOOD STORE BURLEIGH STREET, APSLEY

DRAWING TITLE

UNIVERSAL WC ENLARGED PLAN

1:100

JANUARY 24, 2022

PROJECT NUMBER 2102

DRAWING NUMBER

#79 - REFRIGERATION SYSTEM 1. CONTRACTOR TO SUPPLY AND INSTALL REFRIGERATION SYSTEM TO SERVICE ALL DISPLAY & WALKIN COOLERS/FREEZERS 2. REFER TO OXFORD ENERGY SOLUTIONS INC. DESCRIPTION BELOW FOR BASIS OF DESIGN FOR SYSTEM 3. SUPPLY - CONTACT BEN KUNGL AT OXFORD ENERGY SOLUTIONS INC. EMAIL: BEN@OXFORDENERGY.CA PHONE: 519-532-6373 4. ACCEPTABLE INSTALLERS: OXFORD ENERGY SOLUTIONS INC (SEE ABOVE) RITE-TEMP REFRIGERATION (519-631-8550) HILL VALLEY ENERGY (terry@hillvalleyenergy.com) Heat Loads: PLease refer to excel spread sheet for load profile and circuits. this system currently has 28 refrigeration circuits in the control sequence. Total load profile = approx 200,000 @20 deg F SST, 60,000 @ -10 deg F SST, total system Oxford Refrigeration LPP model 300/70. Complete packaged outdoor unit. Sized based on above mentioned loads. Condenser sized for full store at heat of rejection approximately 320,000 btu/hr based on a 15 degree T/D. Complete Oxford Sensori Platform with Gatemanager interface included. Secure access with firewall and trend logs. Lo and Medium Temp comprised of Copeland ZB scroll compressors with oil management and OPTIONAL Oxford Vapour Drive compressor, magnetic drive, oil free compressor. 208/3 phase with 24vac control system. Boil out suction accumulator with sub-cooling loop, changeable suction and liquid line filters. Isolation valves, floating head pressure control, dual relief valves on receiver. Sub cooled loop and receiver on condenser. R-513a/POE oil, HFO, LOW GWP refrigerant. CSA approved. No disconnect in panel. Primary med temp compressor vfd driven. Condenser fans vfd driven.

-Customer responsible for proper installation, piping practices, start up and commissioning with the assistance of Oxford tech.

-Equipment comes pre-programmed/set up based on layout of store provided. -System receiver is exempt from TSSA registration.

Store layout and distribution of local and remote case controls to be determined.

System is PRE-programmed, PRE-charged with 100lbs of refrigerant and all I/O is

Low temperature compressor vfd driven

Spare can of POE oil shipped loose.

All EXV controls shown as separate below for all circuits.

Power monitor in cabinet.

PRE-checked.

-all terms and conditions listed at www.oxfordenergy.ca -Oxford Energy will not be held responsible for any delays of equipment affected by events that are beyond the control of Oxford Energy Solutions Inc.

-Oxford Energy will not be held accountable for any issues resulting in loss of product or damage to product. The accountability of the food stuff in storage is the sole responsibility of the facility

-Oxford listed equipment has a free 2nd year compressor warranty when trained personnel submits start up report on compressors. This can be done electronically. -3rd year warranty on compressors is available upon discussion and is an extra charge that is not included in this estimate.

-All installation, permits, structural, engineering, etc all the responsibility of the customer. -Unloading equipment at site is responsibility of customer. -Location of internal 15" HMI screen to be discussed and connected to Internet system. -All cases/fixtures supplied by Arneg. This estimate only covers the equipment listed in it. -All low temperature display cases will have high temp interlock relay installed by Arneg for

automatic shut off of all door anti sweat heaters to be controlled via automation system. If case is being re-used then electrical of case will be re-done with EXV kit and relays. -All power for evaporator fans and defrost heaters to be supplied from the facility power distribution and controlled via low voltage signals to each case. Each case has the isolation relays for evaporator fans and defrost heaters in the case.

Evaperators listed for all walk in coolers/freezers on excel sheet. All evaporators will have ECM fan motors, insulated drain pans, electric defrost where

Evaperator Ref Plus LSA/E series with insulated drain pans, ECM motors and electric defrost heaters where applicable.


Listing of evaporator models on excel sheet and quantity. 4 walk in cooler evaporators, 2 walk in freezer evaporators. 1 cut room evap. 7 evaporators in total. Shipped directly to site.


230vac single phase Oxford Refrigeration stand alone Sensori Circuit control with VEV integrated driver. Room and evaporator coil sensors and all transducers and cables required.

220/120/24vac/dc voltages


Includes EXV sized as per Excel sheet.

CSA approved.

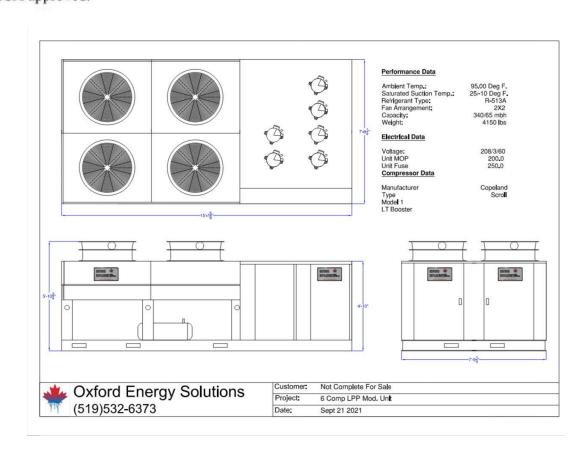

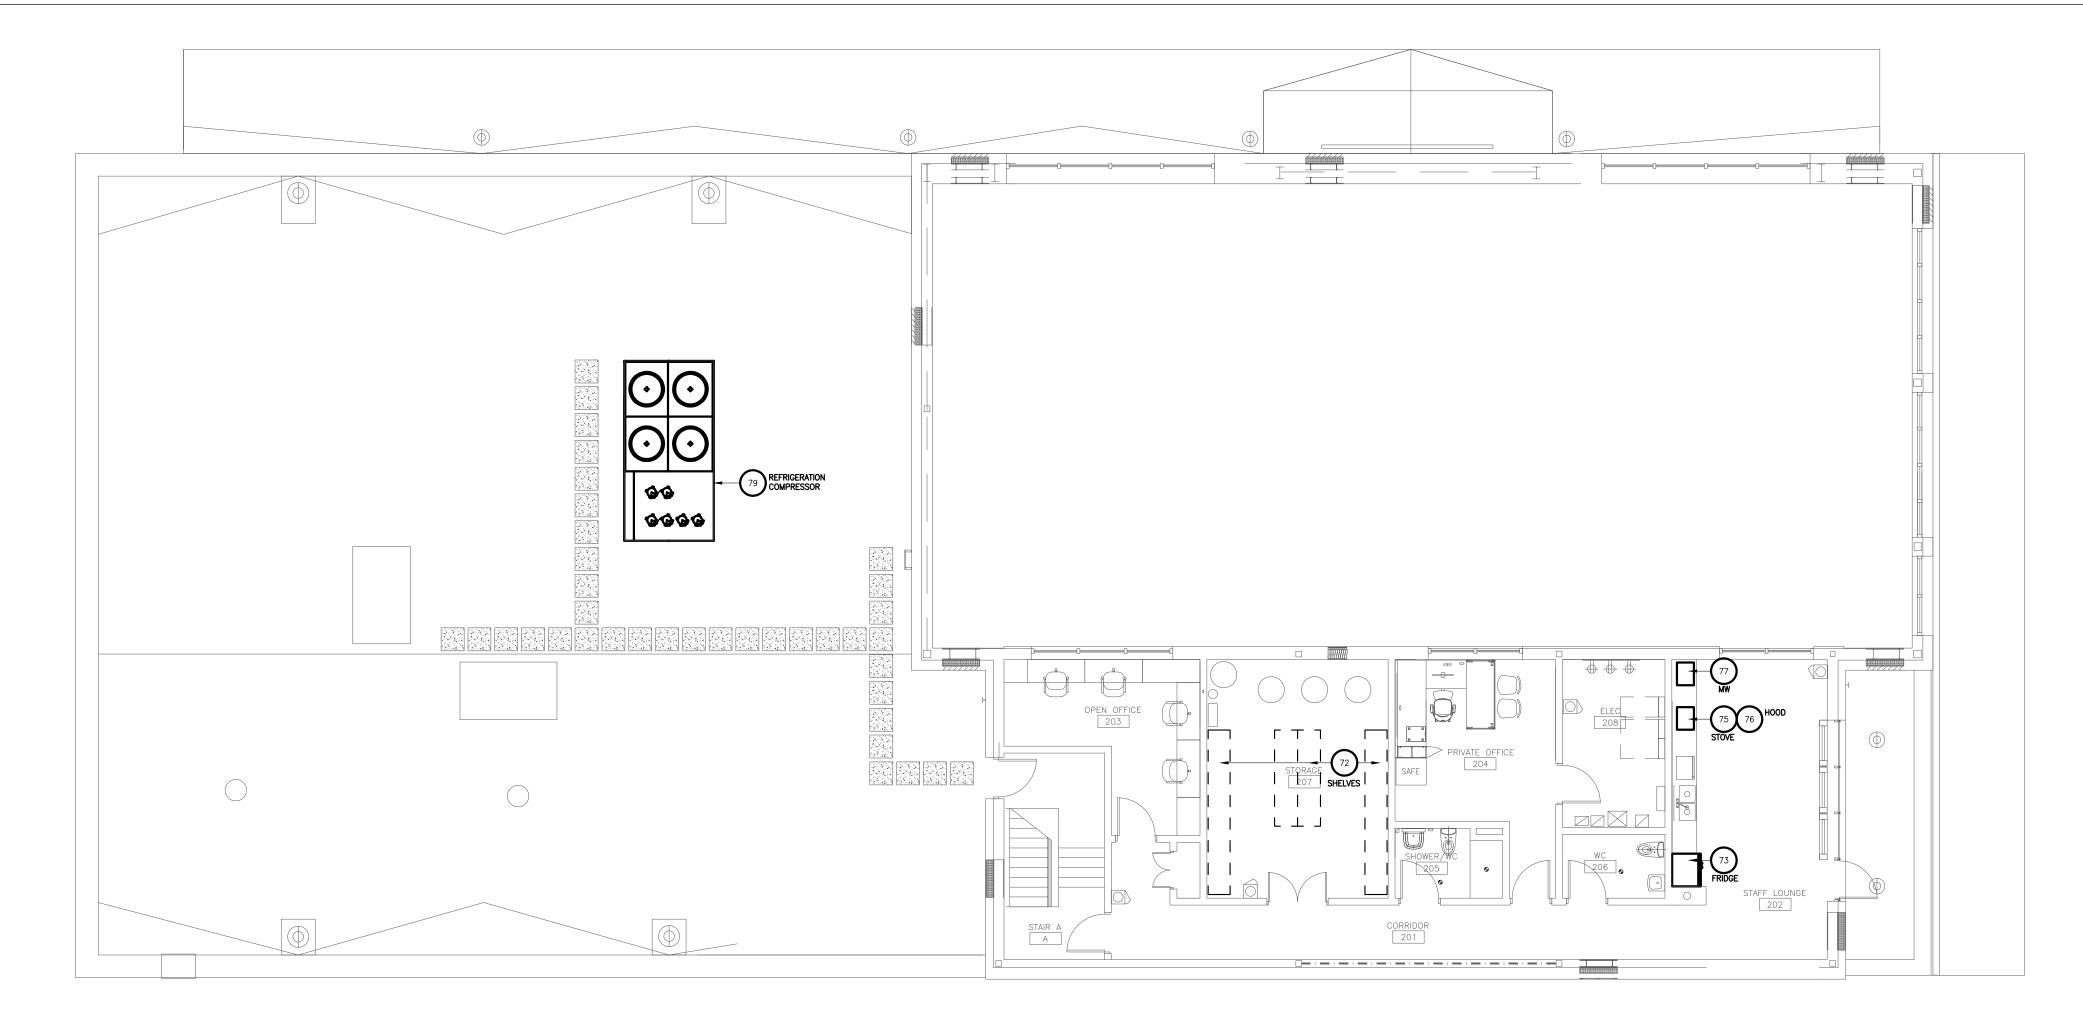

3 LEVEL 2 EQUIPMENT PLAN 1:100

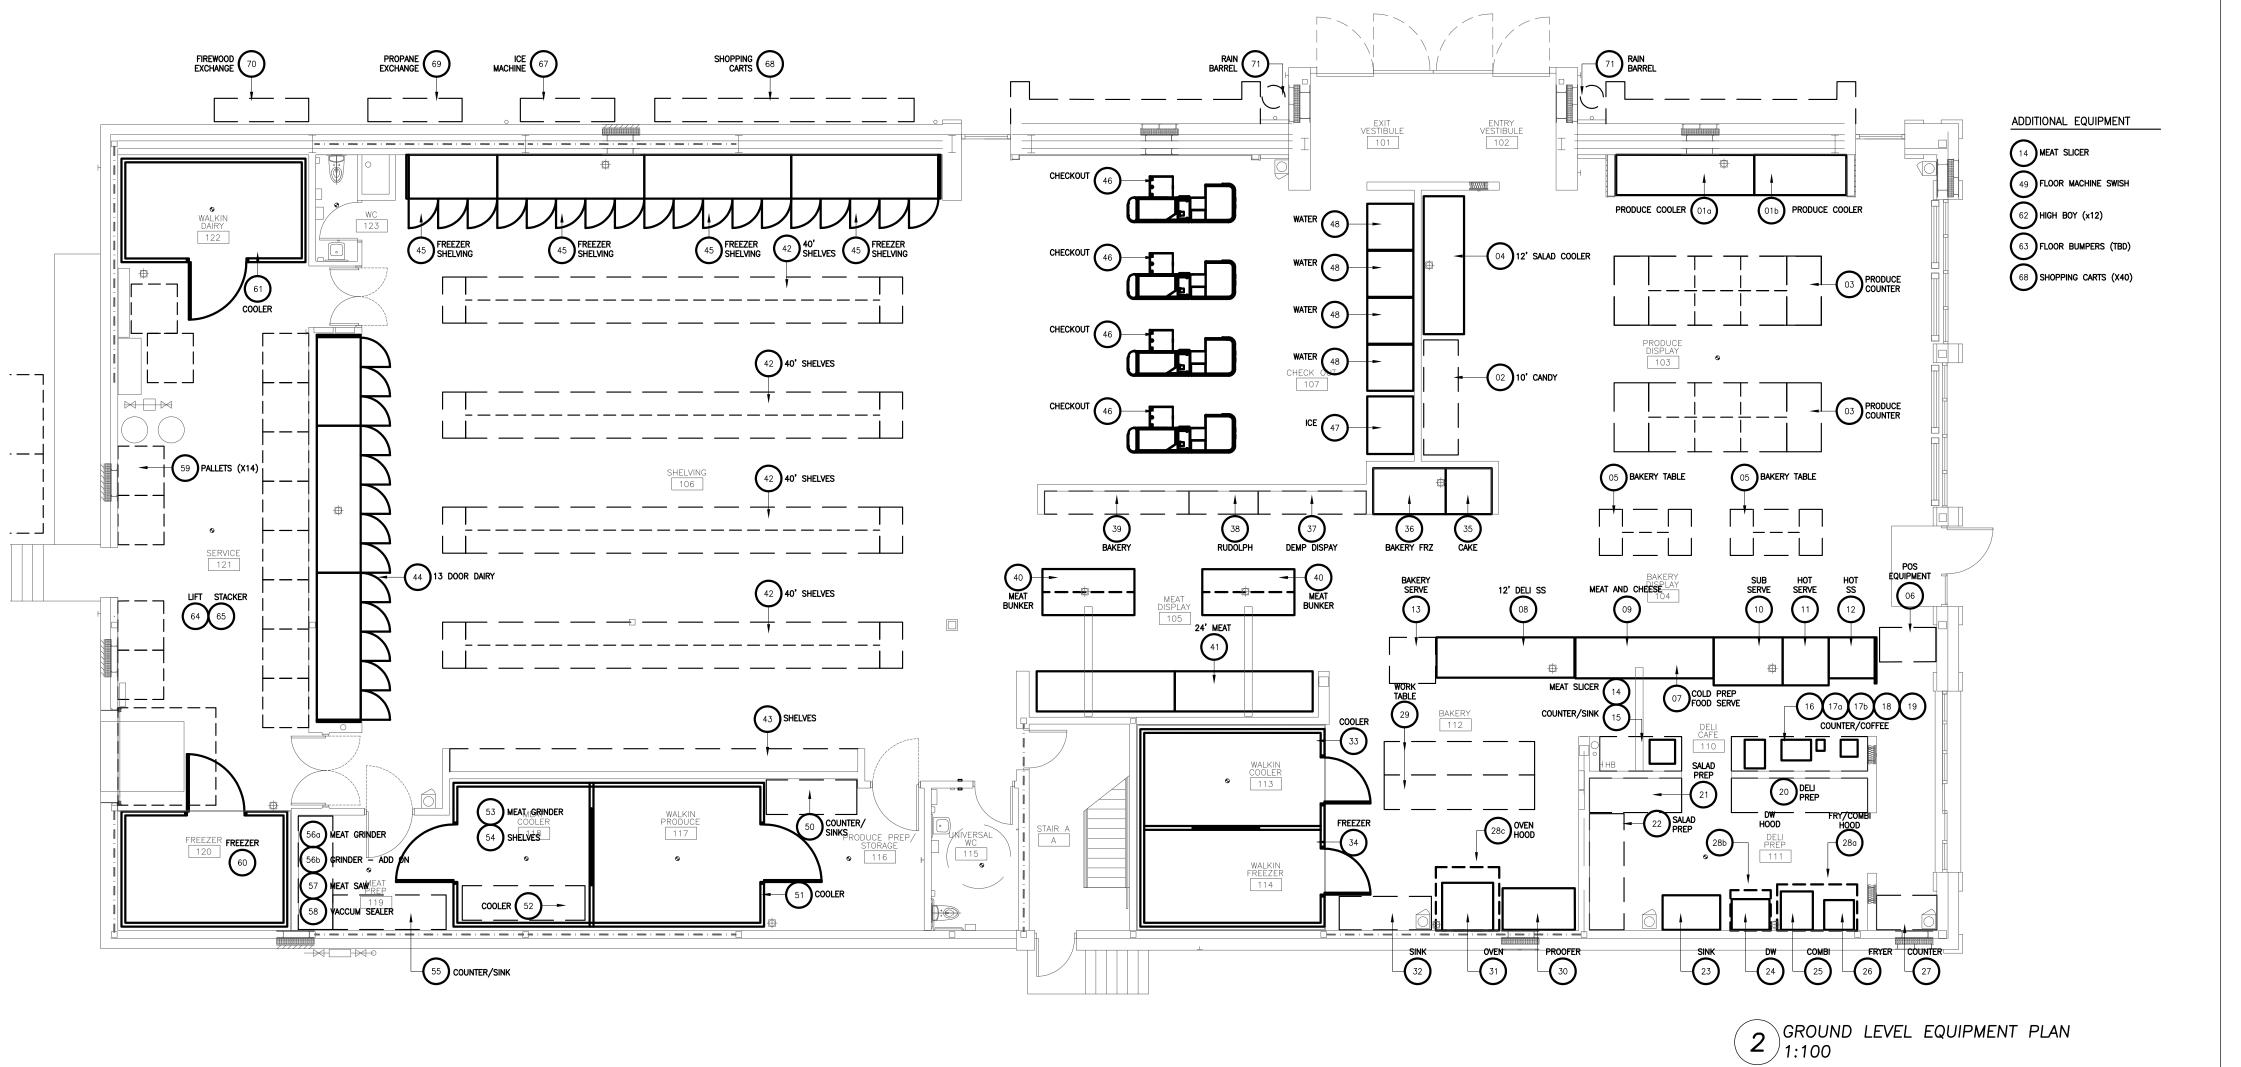

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12	_	_	_

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BLACKWELL

STRUCTURAL ENGINEERS


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PROJECT TITLE

NEW SAYERS FOOD STORE BURLEIGH STREET, APSLEY

DRAWING TITLE

EQUIPMENT FLOOR PLANS

1:100

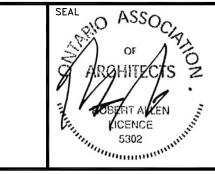JANUARY 24, 2022

PROJECT NUMBER 2102

DRAWING NUMBER

A450

REFRIGERATION SYSTEM

					GENERAL					MECHANICAL								ELECTRICA	AL		
ITEM NO. QTY				BRAND		DIMENSIONS (WxDxH)	SPEC COMMENTS	COLD WATER (mm)	HOT WATER (mm)	FI_TERED H2O		GAS		CONNECTION		VOLTS	CYCLE	PHASE	AMPS		W ELECTRICAL REMARKS
01a 1	103 -	- PRODUCE DISPLAY 12	2' PRODUCE COOLER	Arneg	LISBONA VF04_LS LS3 TA56 105-162 HF B25 2019-10-24	365/mmx 106/mm x 1892mm	DWNER SUPPLIED - CONTRACTOR INSTALLED; L2' UNIT, GANG TOGETHER WITH 8' UNIT	NA	NA	NA	1 1/2" ABS	NA	NA.	Harcwired	Floor Supplied	120v	60hz	1	3 Fans (0.57) + LED Lights 1E (0.24 + 2E 0.48)	4A	No Night Curtain No Electric Defrost Black Interior
001 1	103 -	- PRODUCE DISPLAY 8'	PRODUCE COOLER	Arneg	LISBONA	2438mmx 1067mm x 1892mm	OWNER SUPPLIED - CONTRACTOR INSTALLED:	NA	NA	NA .	1 1/2" ABS	NA	NA.	Harcwired	Floor Supplied	120v	60hz	1	2 Fans (0.38) + LED Lights 1E (0.16) + N	NA -	No Night Curtain
					VF04_LS LS3 TA56 105-162 HF B25 2019-10-24		3' UNIT, GANG TOGETHER WITH 12' UNIT												2E 0.32)		No Electric Defrost Black Interior
02 1	103 -	- PRODUCE DISPLAY 10	0' CANDY	Cayuga			DWNER SUPPLIED;	NA	NA	NA	NA	NA	Nc Mech Req	NA	NA	NA .	NA	NA	NA NA	NA N	IA No Elec. Req.
03 2	103 -	- PRODUCE DISPLAY PR	RODUCE COUNTER	Cayuga			DWNER SUPPLIED;	NA	NA	NA	NA	NA	Nc Mech Req	NA	NA	NA .	NA	NA	NA	NA N	No Elec. Req.
04 1	103 -	- PRODUCE DISPLAY 12	2' SALAD COOLER	Arneg	LISBONA PL05-2_LS ISB TA76 105-191 LF MF FF B16 2016-06-14	3657mmx 1067mm x 2089mm	DWNER SUPPLIED - CONTRACTOR INSTALLED;	NA	NA	NA	1 1/2" ABS	NA	NA.	Harcwired	floor Supplied	120v	60hz	1	3 Fans (0.57) + LED Canopy = 1 + LED 5 rows Shelves	NA N	No Electric Defrost Black Interior
																			1.25 TOTAL = 2.82 A		
05 2	104 -	- BAKERY DISPLAY BA	AKERY TABLE	Cayuga			DWNER SUPPLIED;	NA	NA	NA	NA		Nc Mech Req	NA	NA		NA	NA	NA I	NA N	IA No Elec. Req.
05	101	DAKEDA DISDIAN	00 501 1101 151 15				DWNER SUPPLIED - CONTRACTOR INSTALLED;														
06	104 -	- BAKERY DISPLAY PO	OS EQUIPMENT	Howe			DWINER SUPPLIED - CONTRACTOR INSTALLED,	NA .	NA	NA .	NA		INA	NA	IIA		NA	INA	NA	NA IN	
07	Reser	rved						NA	NA	NA .	NA	NA	Nc Mech Req	NA	NA	NA .	NA	NA	NA .	NA N	IA No Elec. Req.
08 1	110 -	- DELI CAFÉ 12	2' DELI SELF SERVE	Arneg		3657mmx 1067mm x 1524mm	OWNER SUPPLIED - CONTRACTOR INSTALLED:	NA	NA	NA NA	1 1/2" ABS	NA	NA.	Harcwired	Floor Supplied	120v	60hz	1	3 Fans (0.57) +	NA N	No Electric Defrost
					PV03-1 LS LSB TB35 105-136 LF MF BL6 2014-05-30														LED Canopy = 1 + LED 3 rows Shelves .75 TOTAL = 2.32 A		Black Interior
09 1	110 -	- DELI CAFÉ M	1EAT & CHEESE	Arneg	GLASGOW 2 V	3658mm x 1083mm x 1372mm	DWNER SUPPLIED - CONTRACTOR INSTALLED;	NA	NA	NA NA	1 1/2" ABS	NA	NA.	Harcwired	floor Supplied	120v	60hz	1	12 Fans (1.2) + LED Canopy = 1 + LED 2 rows Shelves	NA NA	IA Provide Separate hardwired connection to GFI Plug Supplied
																			.5 TOTAL = 2.7 A		with Case (for scales);
10 1	110 -	- DELI CAFÉ SU	UB SERV	Arneg	KOBE 2 FROID/COLD	1829mmx 1270mm x 1372mm	OWNER SUPPLIED - CONTRACTOR INSTALLED;	NA	NA	NA	1 1/2" ABS (x2)	NA	NA.	Harcwired	Floor Supplied	120v	60hz		3 Fans (0.48) + LED Canopy = .24+ LED 1 rows	NA N	IA NA
																			Shelves .12 TOTAL = 0.3 A		
11 1	110 -	- DELI CAFÉ H	OT SRVC	Arneg	GLASGOW 2 HOT/CHAUD	1219mm x 1083mm x 1372mm	OWNER SUPPLIED - CONTRACTOR INSTALLED:	NA	NA	NA	No Drain	NA	NA.	Harcwired	Floor Supplied	120v	60hz		2 Fans (0.20) + LED Canopy = .2 TOTAL = 0.4A	NA N	Provide Separate hardwired connection to GFI Plug Supplied with Case (for scales);
12	110	- DELI CAFÉ H	OT SS	Arneg	GLASGOW 2 HOT/CHAUD	1219mm v 1092mm v 1272	DWNER SUPPLIED - CONTRACTOR INSTALLED:	NA NA	NA	NA NA	No Drain	NA.	NA	Harcwired	Floor Supplied	120v	60hz		Hot Plate = 10.6A 2 Fans (0.20) +	NA NA	
	110-	H				X 2003HHI X 13/2MM	CONTINUE OR INSTALLED;				with			eu					LED Canopy = .2 TOTAL = 0.4A	In.	connection to GFI Plug Supplied with Case (for scales);
13 1	110 -	- DELI CAFÉ BA	AKERY SERVE				OWNER SUPPLIED;	NA	NA	NA	NA	NA	Nc Mech Req	NA	NA	NA	NA		Hot Plate = 10.6A	NA N	No Elec. Req.
14 2	110 -	- DELI CAFÉ M	MEAT SLICER		HS9-1 MEAT SLICER	673mm x 635mm x 788mm	OWNER SUPPLIED;	NA	NA	NA	NA	NA .	NA.	Nema 5-15R	6' Cord	120v	60hz	1	5.6A 1	1/2 HP 67	572w -
					MEAT SLICER		Note: Inc. Removable Knife Op:ion														
15 1	110 -	- DELI CAFÉ M	1EAT SLICER COUNTER/SINK	GBS			DWNER SUPPLIED;							-			-	-			
16 1	110 -	- DELI CAFÉ TI	URBO CHEF	Hendrix	Turbochef - Bullet	538mm x761mm x 585mm	DWNER SUPPLIED; Note: Ventless	NA	NA	NA	NA	NA	Nct to be used for Fatty Pro:iens - ie. nohood req.	Nema 6-30P	6' Cord	208/240vac	60hz	1	30A	NA 3	.5 kW -
			5001550			700		. /2"													
17a 1	110 -	- DELI CAFÉ ES	SPRESSO MACHINE	Simonelli	Simonelli Aopia Life 2-Group Full-Size	788mm x546mm x508mm	DWNER SUPPLIED; nc. RWV ko chute 01 (03080201) - The Coffee Cnock Drawer Compay	1/2"	NA	No .	Yes · 1" min.	NA	Inc. Dedicated Cold Water Line with Shutoff value & 3/8" compression fitting; Inc.BWT in-line water softener	Nema 6-20R	Below Counter	220v	60hz	1	20A		
17h 1	110-	- DELI CAFÉ GO	offee Grinder	Simonelli	MDJ On Denand	216mm x292mm x610mm	DWNER SUPPLIED;	NA	NA	N/A	NΔ	NΔ	NA	Nema 5-15R		115V	60hz	1		N/A S	75W -
176 1	110-	- DELI CAPE	orree Grinder	Simonelli	MD) On Denand	21011111 X29211111 X 610111111	DWNER SUPPLIED,	NA .	NA	NA .	NA	NA	INF.	Melia 2-13v			00112		i I	I/A	
18 1	110 -	- DELI CAFÉ CO	OFFEE MAKER	Bunn	Axiom DVA2S.A32a_c AXIOM-DV APS	229mm x554mm x 654mm	DWNER SUPPLIED;	1/4"		-		-	Supplied with 1/4" male flare fitting	Harcwired	-	120v	60hz	1	12.5A -	1	475W -
19 1	110 -	- DELI CAFÉ ES	SPRESSO COUNTER	GBS			DWNER SUPPLIED;			-	-	•	-	-	-			-			
20 1	111 -	- DELI PREP. 12	2' DELI PREP	GBS			DWNER SUPPLIED;			-				-			-	-			
21 1	111 -	- DELI PREP. 8'	SALAD PREP	GBS			DWNER SUPPLIED;			-				-	-			-			
22 1	111 -	- DELI PREP. 10	O' SALAD PREP	GBS			DWNER SUPPLIED;						-	-			-	-			
				-																	
23 1	111 -	- DELI PREP. SI	INK	GBS			DWNER SUPPLIED - CONTRACTOR INSTALLED;	-	-	-				-	-	-	-	-			
24 1	111 -	- DELI PREP. DI	ISHWASHER	HOBART	AM16VLT-EAS	1000mm x 813mm x1718mm	OWNER SUPPLIED - CONTRACTOR INSTALLED:	3/4" female garden hose	3/4" female garden	3/4" female garden	5/8' Barb Fitting with	NA	-1	Harcwired	E1 -12 11/16" AFF	E1 -208-240	60hz	3	E1 - 50 -	21 2	Refer to Spec Sheet For E1, E2,
							Note: No Vent Hood, Review OH and Opening Clearances		hose (6' length) 11-15/16" AFF	hose (6' length)	hose (6' length) 34 13/16" AFF				E1 - 14 11/16" AFF	E2-208-240 E3 -208-240			E2 - 50 E3 - 60		E3 Designations
25 1	111 -	- DELI PREP.	ОМВІ	Rational	iCombi Pro 1-0half size E/G	851mm x1016mm x 775mm	DWNER SUPPLIED - CONTRACTOR INSTALLED;	3/4" hose	NA	NA	2" CD	NA	-1	Harcwired	65mm AFF	208/240 VAC	60hz	3	60A Breaker -	- 1	8.9 Kw Electric - Not Gas Option
26 1	111 -	- DELI PREP. FF	RYER	HOBART	2TR45AF-1	787mm x 765mm x 1200mm	DWNER SUPPLIED - CONTRACTOR INSTALLED;	NA	NA	NA NA	NA	Propane	1 1/4" NPT Common Gas Connection - 283mm AFF	Harcwired	-	120v	60hz	1 phase	6A	1/3 HP -	-
													20311111 ATT								
27 1	111 -	- DELI PREP.	OUNTER	GBS			DWNER SUPPLIED;	-		-			•			•		-			-
28a 1	111 -		XHAUST HOOD OMBI + FRYER	GAYLORD	PBW-14 MAKE-UP AIR PLENUM BOX	5'-8" 1727mm x 1727mm x 762mm	OWNER SUPPLIED - CONTRACTOR INSTALLED;	NA	NA	NA	NA	NA	REFER TO MECHANICAL DRAWINGS	Harcwired			-		-		-
201		DELLOS	VIIAIICTUC	CAVIOSS	ANSUL-FIRE SUPRESSION-SYSTEM	ri cii	DUMPED CUERCIES	la la	l l	l Nu		200	DESCRIPTION OF THE PROPERTY OF	Harden C.							
28b 1	111 -		XHAUST HOOD VEN	GAYLORD	EL-ND-XGS-DCA-300-66 PBW-12 MAKE-UP AIR PLENUM BOX ANSUL-FIRE SUPRESSION-SYSTEM	5'-6" 1676mmx 1676mm x 762mm	DWNER SUPPLIED - CONTRACTOR INSTALLED;	NA .	NA	NA	NA	NA	REFER TO MECHANICAL DRAWINGS	Harcwired		-		-			
																			<u> </u>		
28c 1	111 -		XHAUST HOOD ISHWASHER	GAYLORD		3'-6" 1067mmx 1067mm x 762mm	DWNER SUPPLIED - CONTRACTOR INSTALLED;	NA	NA	NA	NA	NA	REFER TO MECHANICAL DRAWINGS	Harcwired	-	-	-	-	-	-	-
29	112	- BAKERY BA	AKERY WORK TABLE	GBS			DWNER SUPPLIED;			-	-					-					
2	112-	B)	WORK TABLE				THE SOUTH LED,														
30 1	112 -	- BAKERY PF	ROOFER	HOBART	RPW2S-40.5" D-FL	1918mm x 1102mm x 2527mm	OWNER SUPPLIED - CONTRACTOR INSTALLED;		NA	NA NA	1/2' FNPT	NA .		Harcwired	85" AFF	240v	60hz	3 phase	NA NA	NA -	-
							94" High Options; nc. REFR5A Remote Refriguration,	85" AFF			5" AFF										
31 1	112 -	- BAKERY 0'	VEN	DOYON	JA20	1353mmx 1264mm x 1854mm	OWNER SUPPLIED - CONTRACTOR INSTALLED;	1/4 NPT	NA	YES	NA	NA	Inc. Water Filter (PL240)	Harcwired	-	208v	60hz	1 phase	130A	- 2	7kW -
							Note: Electric Oven														
32 1	112 -	- BAKERY CO	OUNTER/SINK	GBS			DWNER SUPPLIED - CONTRACTOR INSTALLED;	-	•					-			-	-			
33 1	113 -	- WALKIN COOLER CO	OOLER	COOL MASTER	4" COOLER PANELS	2168mm x 4877mm x 2743mm	OWNER SUPPLIED - CONTRACTOR INSTALLED;	NA	NA	NA		NA		-			-	-	-	-	-
34 1	114 -	- WALKIN FREEZER FF	KEEZEŘ	COOL MASTER	4" FREEZER PANELS	2168mm x 4877mm x 2743mm	OWNER SUPPLIED - CONTRACTOR INSTALLED;	NA	NA	NA .		NA		-	-	-	-	-	-		-
35	105	- MEAT DISPLAY CA	AKE	Arneg	PV03-8	1219mm v 1067mm v 1 270	OWNER SUPPLIED - CONTRACTOR INSTALLED:	NΔ	NΔ	NA NA	1 1 /D" ADS	NΔ	N4	Harmwined	Floor Supplied	120v	60hz	1	1 Fans (0.19) ±	NA NA	No Fleetrie Doft
	105 -	DISPLAT		Arneg		(confirm reight)	- STALL SOLF ELED - CONTRACTOR INSTALLED;				1 1/2" ABS			Harcwired	Floor Supplied		V0114		1 Fans (0.19) + LED Canopy = .17 + LED rows 3 Shelves .24	N	IA No Electric Defrost Black Interior
36 1	105 -	- MEAT DISPLAY 2	DOOR BAKERY FREEZER	HUSSMANN	RLTM	1575mm x 1162mm x 2261mm	OWNER SUPPLIED - CONTRACTOR INSTALLED;	NA	NA	NA	1 1/2" ABS	NA	NA .	Harcwired		120v Typical;	60hz	1/	TOTAL = 0.5A 2 Fans =1.2A;		
																208v Electric Defrost Heate			Door Heat = 1.4A; Frame Heat = 0.96A; LED Lighting = 0.36A;		
																			Drain Heat = 0.63A; Defrost Heat = 6.72A;		
37 1	105 -	- MEAT DISPLAY DI	EMP. DISPLAY	Cayuga			DWNER SUPPLIED;						-1				-,				
30	100	MEAT DISPLAN	IIDOLORI	Caylura			OWNER SURPLED:														
38 1	105 -	- MEAT DISPLAY RI	UDOLOPH	Cayuga			DWNER SUPPLIED;														
39 1	105 -	- MEAT DISPLAY BA	AKERY SHELVING	Cayuga			DWNER SUPPLIED;	-					-	*	-		*	l	·	1	-
39 1	105 -	- MEAT DISPLAY BA	AKERY SHELVING	Cayuga			OWNER SUPPLIED;														

REVISIONS AND ISSUES

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12	-	_	_

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425 adelaide street west level 6 toronto ontario m5v 3c1 416 593 6796 www.mjmarchitects.com

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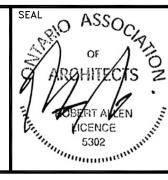
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134 PETER STREET, SUITE 1301 TORONTO, ONTARIO, M5V 2H2 TEL 416.593.5300 FAX 416.593.4840

SMITH + ANDERSON MECHANICAL AND ELECTRICAL ENGINEERS 1100 - 100 SHEPPARD AVENUE EAST TORONTO, ONTARIO, M2N 6N5 TEL 416.487.8151 -

SAYERS FOOD LIMITED

132 BURLEIGH STREET t: 705.656.4531 e: sayers@apsley.ca



PROJECT TITLE

NEW SAYERS FOOD STORE BURLEIGH STREET, APSLEY

DRAWING TITLE

EQUIPMENT SCHEDULE

SCALE

NTS

DATE

JANUARY 24, 2022

PROJECT NUMBER
2102

DRAWING NUMBER

			GENERAL					MECHANICAL								ELECTRICA				
EM NO. QTY LOCATION 2 105 - MEAT DISPLAY	DESCRIPTION MEAT BUNKER	BRAND Arneg	BASIS OF DESIGN LAVAL G2 S/C	DIMENSIONS (WxDxH) 2545mm x 1048mm x 935mm	SPEC COMMENTS OWNER SUPPLIED - CONTRACTOR INSTALLED	COLD WATER (mm)	HOT WATER (mm)	FILTERED H2O	DRAIN NA	GAS NA	Mech Notes NA	CONNECTION Hardwired	AFF(mm) Floor Supplied	VOLTS 330V	CYCLE 60hz	PHASE 1	AMPS 8.08A	HP NA		CTRICAL REMARKS
1 2 105 · MEAT DISPLAY	24' MEAT SHELF	Arneg	LISBONA VF06_LS LSB TD76 105-191 HF 816 2016-06-14	3657mm x 1067mm x 2089mn	n OWNER SUPPLIED - CONTRACTOR INSTALLED 12' UNIT, GANG TOGETHER TWO UNITS	; NA	NA	NA	1 1/2" ABS	NA	NA	Hardwired	Floor Supplied	120v	60hz		Fans = 1.52A Canopy = 0.5A	NA		icated Circuit Defrost
2 4 106 · SHELVING	40' SHELVING	ETALEX			OWNER SUPPLIED - CONTRACTOR INSTALLED	-	-		-	-	-					-	Shelf = 1.25A		- Prov	vide Floor Outlet
100 - SHEEVING	43 SHELVING	LIALLA			PROV DE FLOOR MONUMENT ELECTRICAL CONNECTIONS;															nections
1 106 - SHELVING	SHELVES	ETAEX			OWNER SUPPLIED - CONTRACTOR INSTALLED	: -	-	-	-	-						-	•	-		
1a 2 106 - SHELVING	5 DOOR DAIRY SHELVING	HUSSMANN	RМТМ	3896mm x 1162mm x 2261mn	OWNER SUPPLIED - CONTRACTOR INSTALLED; GANG TOGETHER TWO 5 DOOR AND ONE 3	NA	NA	NA	1 1/2" ABS	NA	NA	Hardwired	Floor Supplied	120v	60hz		5 Fans = 2.5A Door Heat = NA Frame Heat = 0.37;	-		
1 106 - SHELVING	3 DOOR DAIRY SHELVING	HUSSMANN	RMTM	2350mm x 1162mm x 2261mn	DOOR UNITS n OWNER SUPPLIED - CONTRACTOR INSTALLED;	NA	NA	NA	1 1/2" ABS	NA	NA	Hardwired	Floor Supplied	120v	60hz	1	LED Lighting = 0.84A; 3 Fans = 0.9A	-		
					GANG TOGETHER TWO 5 DOOR AND ONE 3 DOOR UNITS											1	Door Heat = NA Frame Heat = 0.22; LED Lighting = 0.53A;			
5 4 106 - SHELVING	5 DOOR FREEZER SHELVING	HUSSMANN	RLTM	3896mm x 1162mm x 2261mn	OWNER SUPPLIED - CONTRACTOR INSTALLED;	NA	NA	NA	1 1/2" ABS	NA	NA	Hardwired	Floor Supplied	120v Typical; 208v Electric Defrost Heater	60hz	3	5 Fans =7.5A; Door Heat = 3.4A; Frame Heat = 2.4A;	-		
5 4 107 - CHECKOUT	CHECKOUT	PAN OSTON	1-M-120	2867mm x 1235mm x 1105mn	OWNER SUPPLIED AND INSTALLED;	NA	NA	NA	NA	NA		-	-	120	-		LED Lighting = 0.84A; Drain Heat = 2.57A; 2.5A			
					CONTRACTOR PROVIDE ROUGH-INS															
7 1 107 - CHECKOUT	ICE MACHINE	HYLAND ICE	MODEL 65		OWNER SUPPLIED	NA	NA	NA	NA	NA	NA	Nema 5-15p	6' Long Cord	115V	60hz	1 phase	15A	NA	NA Ded	icated Circuit
3 4 107 - CHECKOUT	18L WATER	ROCKY RIDGE	47"-1/2" MODEL	1207mm x 1207mm x 1702mn	n OWNER SUPPLIED	NA	NA	NA	NA	NA	NA	NA	NA	NA NA	NA	NA	NA	NA	NA -	
, The checkes i	DE WATER	NOCKT NIDGE	77 YZ MODEL	120/1111 (120/1111) 1/02/111	OWNER SETT CLED		110			IVC	NO.	NA.	No.		NO.	NO.		IVO	NA -	
A - STAIR A	FLOOR MACHINE SWISH				OWNER SUPPLIED	-	-	-	-	-						-		-		
1 116 - PRODUCE PREP/STORAGE	COUNTER/SINKS	GBS			OWNER SUPPLIED - CONTRACTOR INSTALL SINK;	-	-	-	-	-	-		-	-	-		-	-		
1 117 - WALKIN PRODUCE	E COOLER	COOL MASTER	4" COOLER PANELS	3810mm x 4573mm x 2743m m	n OWNER SUPPLIED - CONTRACTOR	NA	NA	NA	1"	NA	Coordinate location of drain with			OUTDOOR COMPRESSOR	60hz		OUTDOOR COMPRESSOR	OUTDOOR		
			- OUTDOOR COMPRESSOR (ASHS9512ZNAFG1); - INTERIOR COILS; - LIGHT;		ING FALLED;						based on condensate requirements			(ASHS9512ZNAFG1) = 230V - INTERIOR COILS = 115V - LIGHT = 115V			(ASHS95127NAFG1) = 20A - INTERIOR COILS = 15A - LIGHT = 15A	COMPRESSOR (ASHS9512ZNAFG1) = 1 1./2 HP		
1 118 - MEAT COOLER	COOLER	COOL MASTER	4" COOLER PANELS - OUTDOOR COMPRESSOR (ASHS9512ZNAFG1);	3810mm x 3657mm x 2743m m	n OWNER SUPPLIED - CONTRACTOR INSTALLED;	NA	NA	NA	1"	NA	Coordinate location of drain with based on condensate requirements		-	OUTDOOR COMPRESSOR (ASHS9512ZNAFG1) = 230V	60hz		OUTDOOR COMPRESSOR (ASHS9512ZNAFG1) = 20A	OUTDOOR COMPRESSOR		
			- OUTDOOR COMPRESSOR (ASHS9512ZNAFG1); - INTERIOR COILS; - LIGHT;		,									- INTERIOR COILS = 115V - LIGHT = 115V			- INTERIOR COILS = 15A - LIGHT = 15A	(ASHS9512ZNAFG1) = 1 1./2 HP		
1 118 - MEAT COOLER	MEAT GRINDER	HOBART	4146-19	2216mm x 676mm x 1219mm	OWNER SUPPLIED	NA	NA	NA	NA	NA	NA	Hardwired	•	200v	60hz	3 phase	13.29A	5hp	2.66kW -	
1 118 - MEAT COOLER	SHELVES	GBS			OWNER SUPPLIED															
116 HVIEAT COOLER																				
1 119 - MEAT PREP	COUNTER/SINKS	GBS			OWNER SUPPLIED - CONTRACTOR INSTALL SINK;					-		-			-	-				
a 1 119 - MEAT PREP	MEAT GRINDER	HOBART	MG2032-1 Prime Mixe ⁻ Grinder	686mm x 1448mm x 1270mm	OWNER SUPPLIED	NA	NA .	NA	NA	NA .	NA	L15-30	8' Long Cord	208v	60hz	3 phase	30A	7.5 hp - Grind 1 hp - Mix	-	
b 1 119 - MEAT PREP	MEAT GRINDER - TENDERIZER	HOBART	403-1	510mm x 267mm x 486mm	OWNER SUPPLIED	NA	NA	NA	NA	NA	NA	Nema 5-15p	6' Long Cord	115v	60hz	1 phase	4A	1/2 hp	46CW	
	ADD-ON		Tenderizer																	
1 119 - MEAT PREP	MEAT BONE SAW, ELECTRIC	HOBART	6801-22 MEAT BONE SAW	400mm x 445mm x 610mm	OWNER SUPPLIED	-						L15-20p	6' Long Cord	208-240v	60hz	3 phase	7.25	3hp	1.595kW -	
3 1 119 - MEAT PREP	VACCUM SEALER	HOBART			OWNER SUPPLIED															
15 121 - SERVICE	PALLETS RACKING	GBS			OWNER SUPPLIED	-		-:						-					-	
1 120 - FREEZER	FREEZER	COOL MASTER	4" FREEZER PANELS	2049mm v 4204mm v 2742 mm	n OWNER SUPPLIED - CONTRACTOR INSTALLED	- NA	NA.	NA.		NA										
) IZO-FREEZER	FACEZER	COOL MASTER	4 FREEZERFANELS	304611111 X 433411111 X 2743111	II OWNER SUPPLIED - CONTRACTOR INSTALLED	, IVA	INA	INA		IVA										
1 121 - WALKIN DAIRY	COOLER	COOL MASTER	4" COOLER PANELS	2745mm x 4876mm x 2743m m	n OWNER SUPPLIED - CONTRACTOR INSTALLED	; NA	NA	NA		NA			-	-	-	-				
12 000 - MISC INTERIOR	HIGH BOYS	TBD			OWNER SUPPLIED					-										
TBD 000 - MISC INTERIOR	FLOOR BUMPERS	Arneg or Hill Phoenix			OWNER SUPPLIED - CONTRACTOR INSTALLED	: -	<u> </u>	-		-				-		-				
1 000 - MISC INTERIOR	LIFT	Prentice			OWNER SUPPLIED														-	
1 000 - MISC INTERIOR	STACKER	ТВО			OWNER SUPPLIED											-				
Reserved			*					-												
1 000 - EXTERIOR	ICE MACHINE	HYLAND ICE	Model 100	2388mm x 902mm x 3012mm	100 ft2 Canacity	NA .	NA .	NA	NA	NA .	NA .	Nema 5, 15n	6' Long Cord	115V	60hz	1 phase	15A	NA	NA 5	erior, Dedicated Circuit
2 COOPEXIERIOR	THE THINCE	monto ict		2003MH 2002MH x 3012MM	100 ft2 Capacity OWNER SUPPLIED							ηcria 2-12β	Cong Colu		55112	1 phase			Exte	on, oculcated Circuit
40 000 - EXTERIOR	SHOPPING CARTS	ТВО			OWNER SUPPLIED					-		-			-	-				
1 000 - EXTERIOR	PROPANE EXCHANGE	TBD			OWNER SUPPLIED					•									-	
1 000 - EXTERIOR	FIREWOOD EXCHANGE	TBD			OWNER SUPPLIED															
2 000 - EXTERIOR	RAIN BARRELS	TBD			OWNER SUPPLIED					-										
TBD 207 - STORAGE	STORAGE SHELVES	GBD			OWNER SUPPLIED							-								
John Steinfeld																				
1 202 - STAFF LOUNGE	RESIDENTIAL FRIDGE	VKING	RVRF3361 - 36"	914mm x 750mm x 1765mm	OWNER SUPPLIED SS Finish	1/4"	NA	YES	NA	NA NA	min. psi =30 max psi = 100	Nema 5-15p		120V	60hz	1 phase	15A or 20A	NA		
Reserved																				
1 203 - STAFF LOUNGE	STOVE - STANDARD ELECTRIC	FrigidAire	CFEH3054U S/W	36-5/8"X29-7/8"X29 3/16"	OWNER SUPPLIED															
	RANGE/OVEN																			
1 203 - STAFF LOUNGE	STOVE - HOOD	Broan	BCS324SSC		OWNER SUPPLIED - CONTRACTOR INSTALL;															
1 204 - STAFF LOUNGE	MICROWAVE	Viking	RVM320	610mm x 489mm x 339mm	OWNER SUPPLIED	NA	NA	NA	NA	NA	NA	Nema 5-15p	-	120v	60hz	1 phase	13A	NA	1.5kW -	
												- 13p								
1 000 - EXTERIOR	SHOPPING CART CORREL				OWNER SUPPLIED															
4 0 4	Pofiles		TPD		OWNER SUPPLIES															
1 Roof-top	Refrigeration Condenser		TBD		OWNER SUPPLIED - CONTRACTOR INSTALLED;															

REVISIONS AND ISSUES DESCRIPTION DATE BY ISSUED FOR SPA 210618 REVISED SPA 210709 REVISED SPA 210809 ISSUED FOR TENDER 210824 ISSUED FOR BUILDING PERMIT 210909 REVISED TENDER 220124 _ _ _ -_

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425 adelaide street west level 6 toronto ontario m5v 3c1 416 593 6796 www.mjmarchitects.com

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TEL 519 941 0330 FAX 519 941 1830

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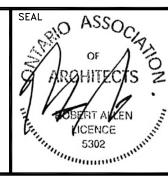
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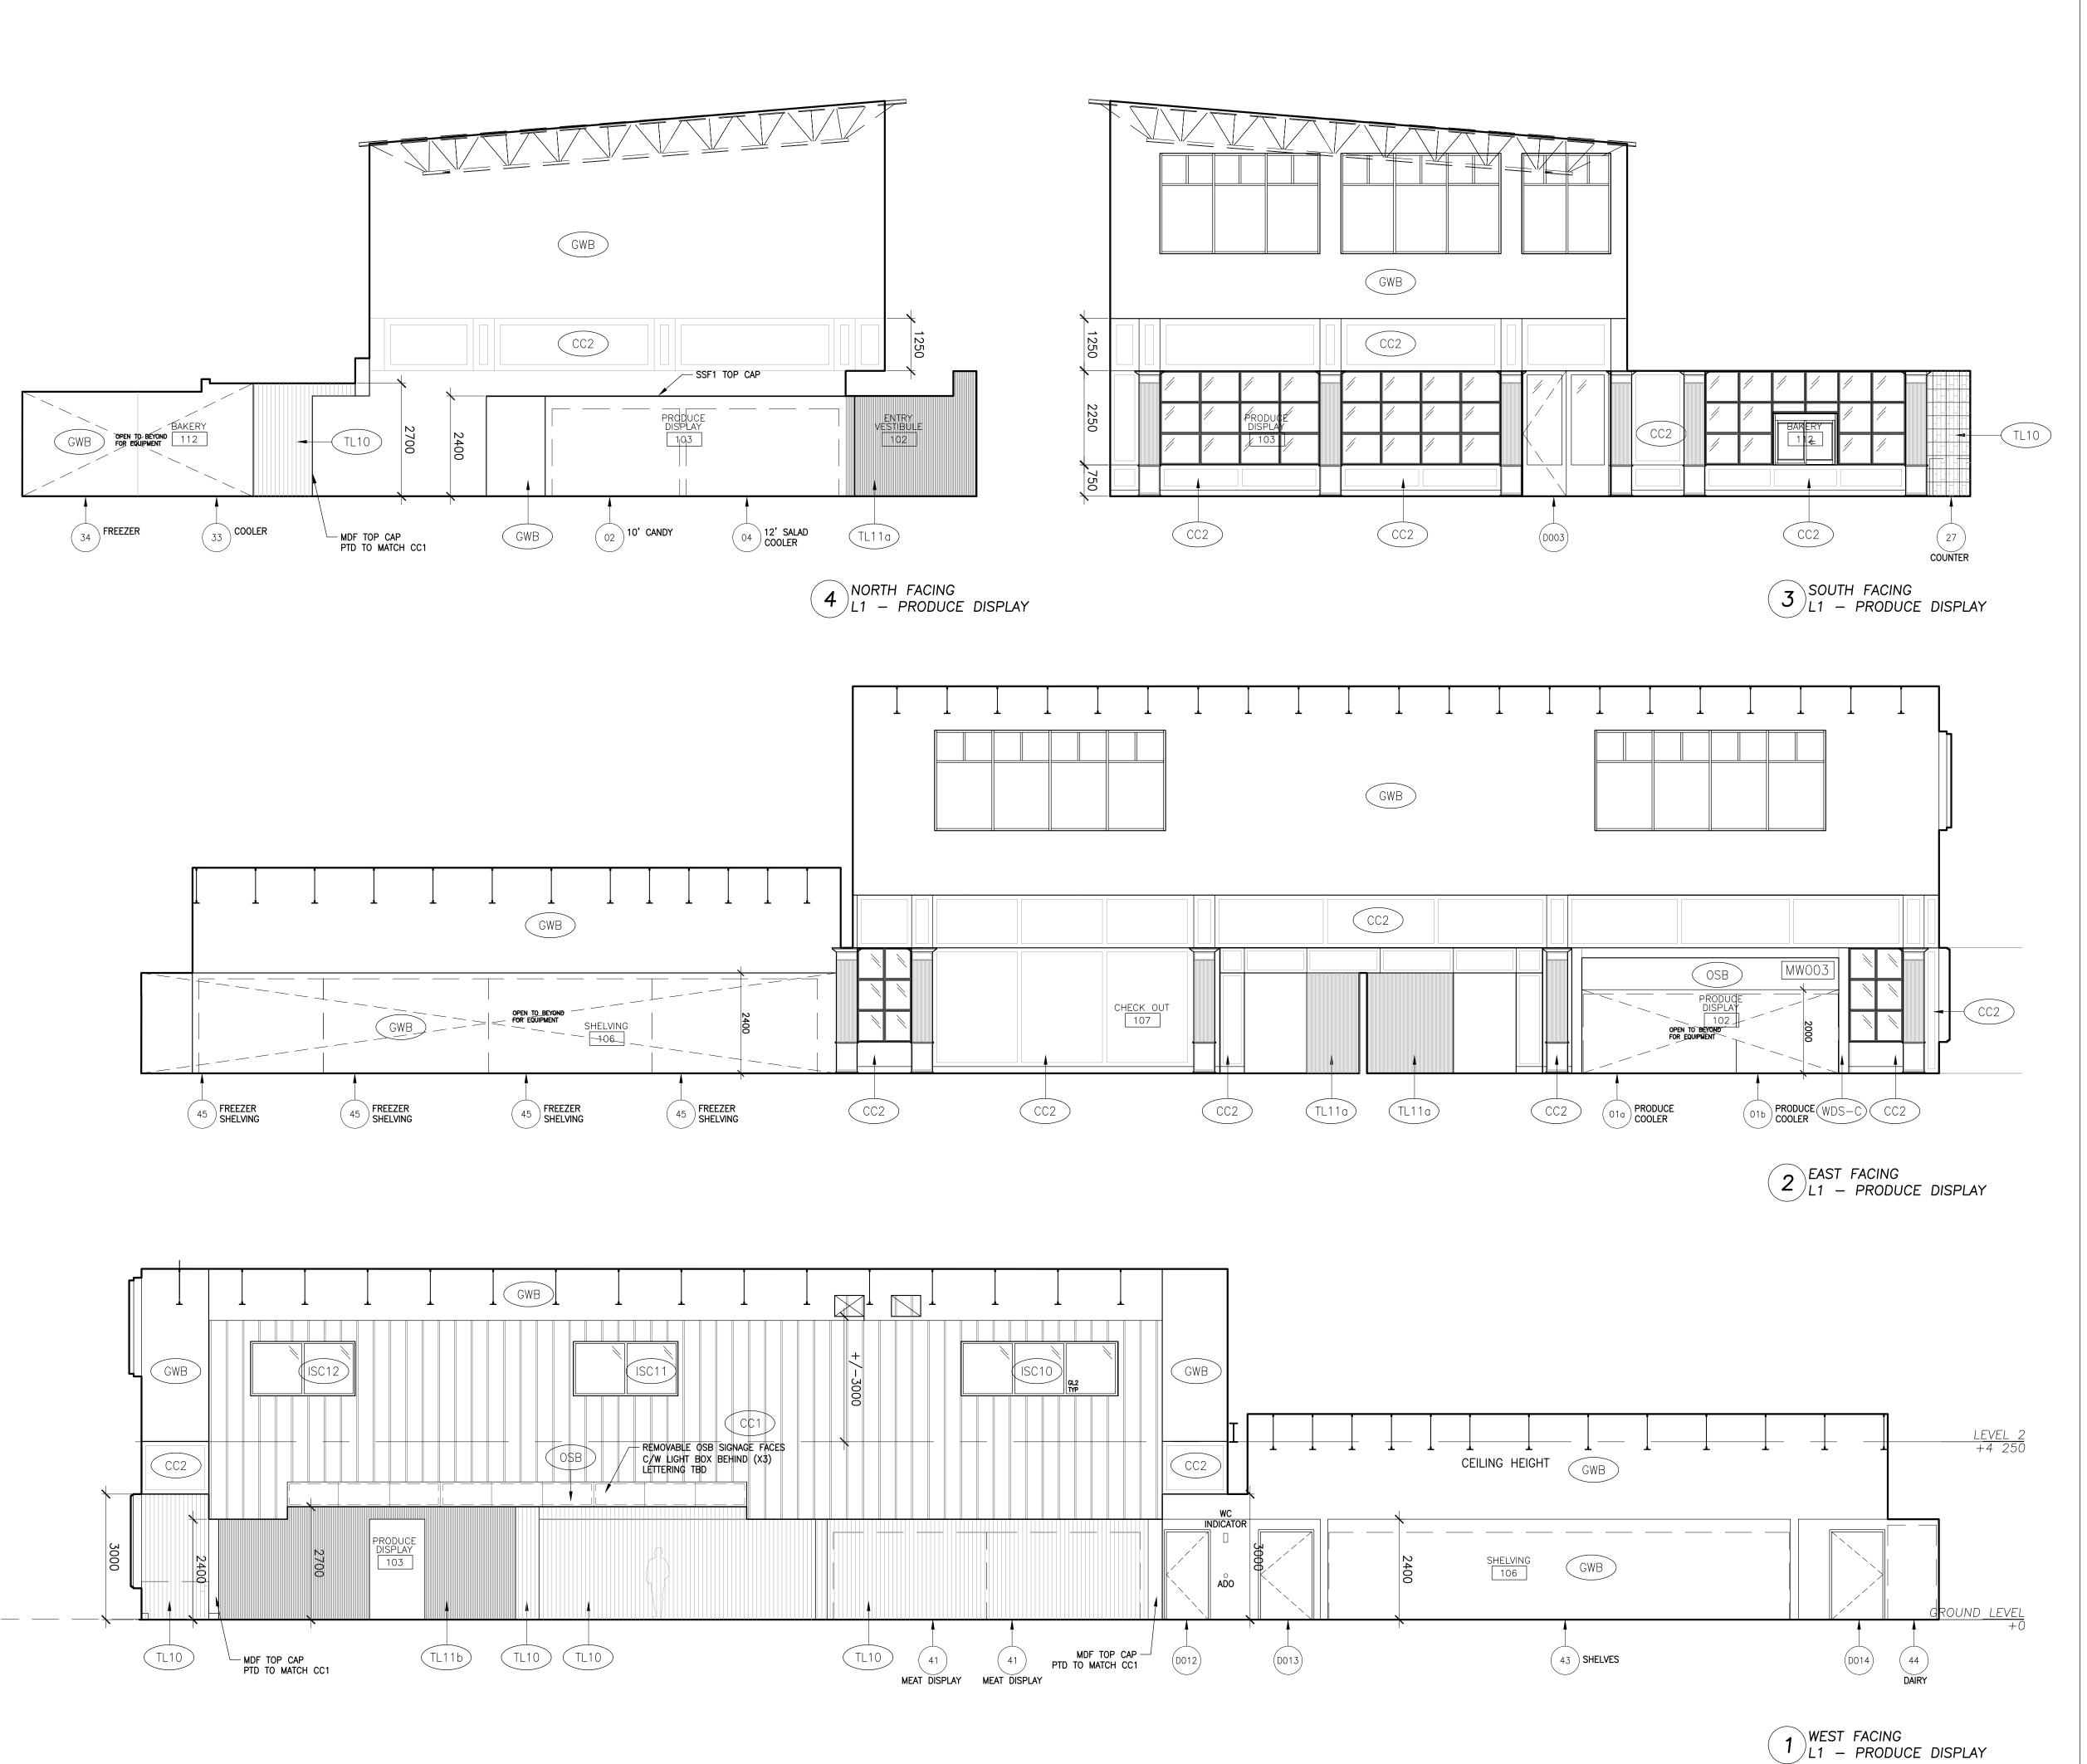
NEW SAYERS FOOD STORE BURLEIGH STREET, APSLEY

DRAWING TITLE

EQUIPMENT SCHEDULE
SCALE
NTS
DATE

JANUARY 24, 2022

PROJECT NUMBER 2102
DRAWING NUMBER



REV	DESCRIPTION	DATE	E
1	ISSUED FOR SPA	210618	A
2	REVISED SPA	210709	A
3	REVISED SPA	210809	Δ
4	ISSUED FOR TENDER	210824	Δ
5	ISSUED FOR BUILDING PERMIT	210909	Α
6	REVISED TENDER	220124	Δ
7	-	-	_
8	_	_	_

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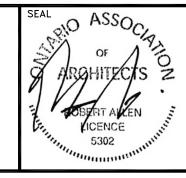
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NORTH ARR



PROJECT TITLE

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DRAWING TITLE


INTERIOR ELEVATIONS

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JANUARY 24, 2022

PROJECT NUMBER

2102
DRAWING NUMBER

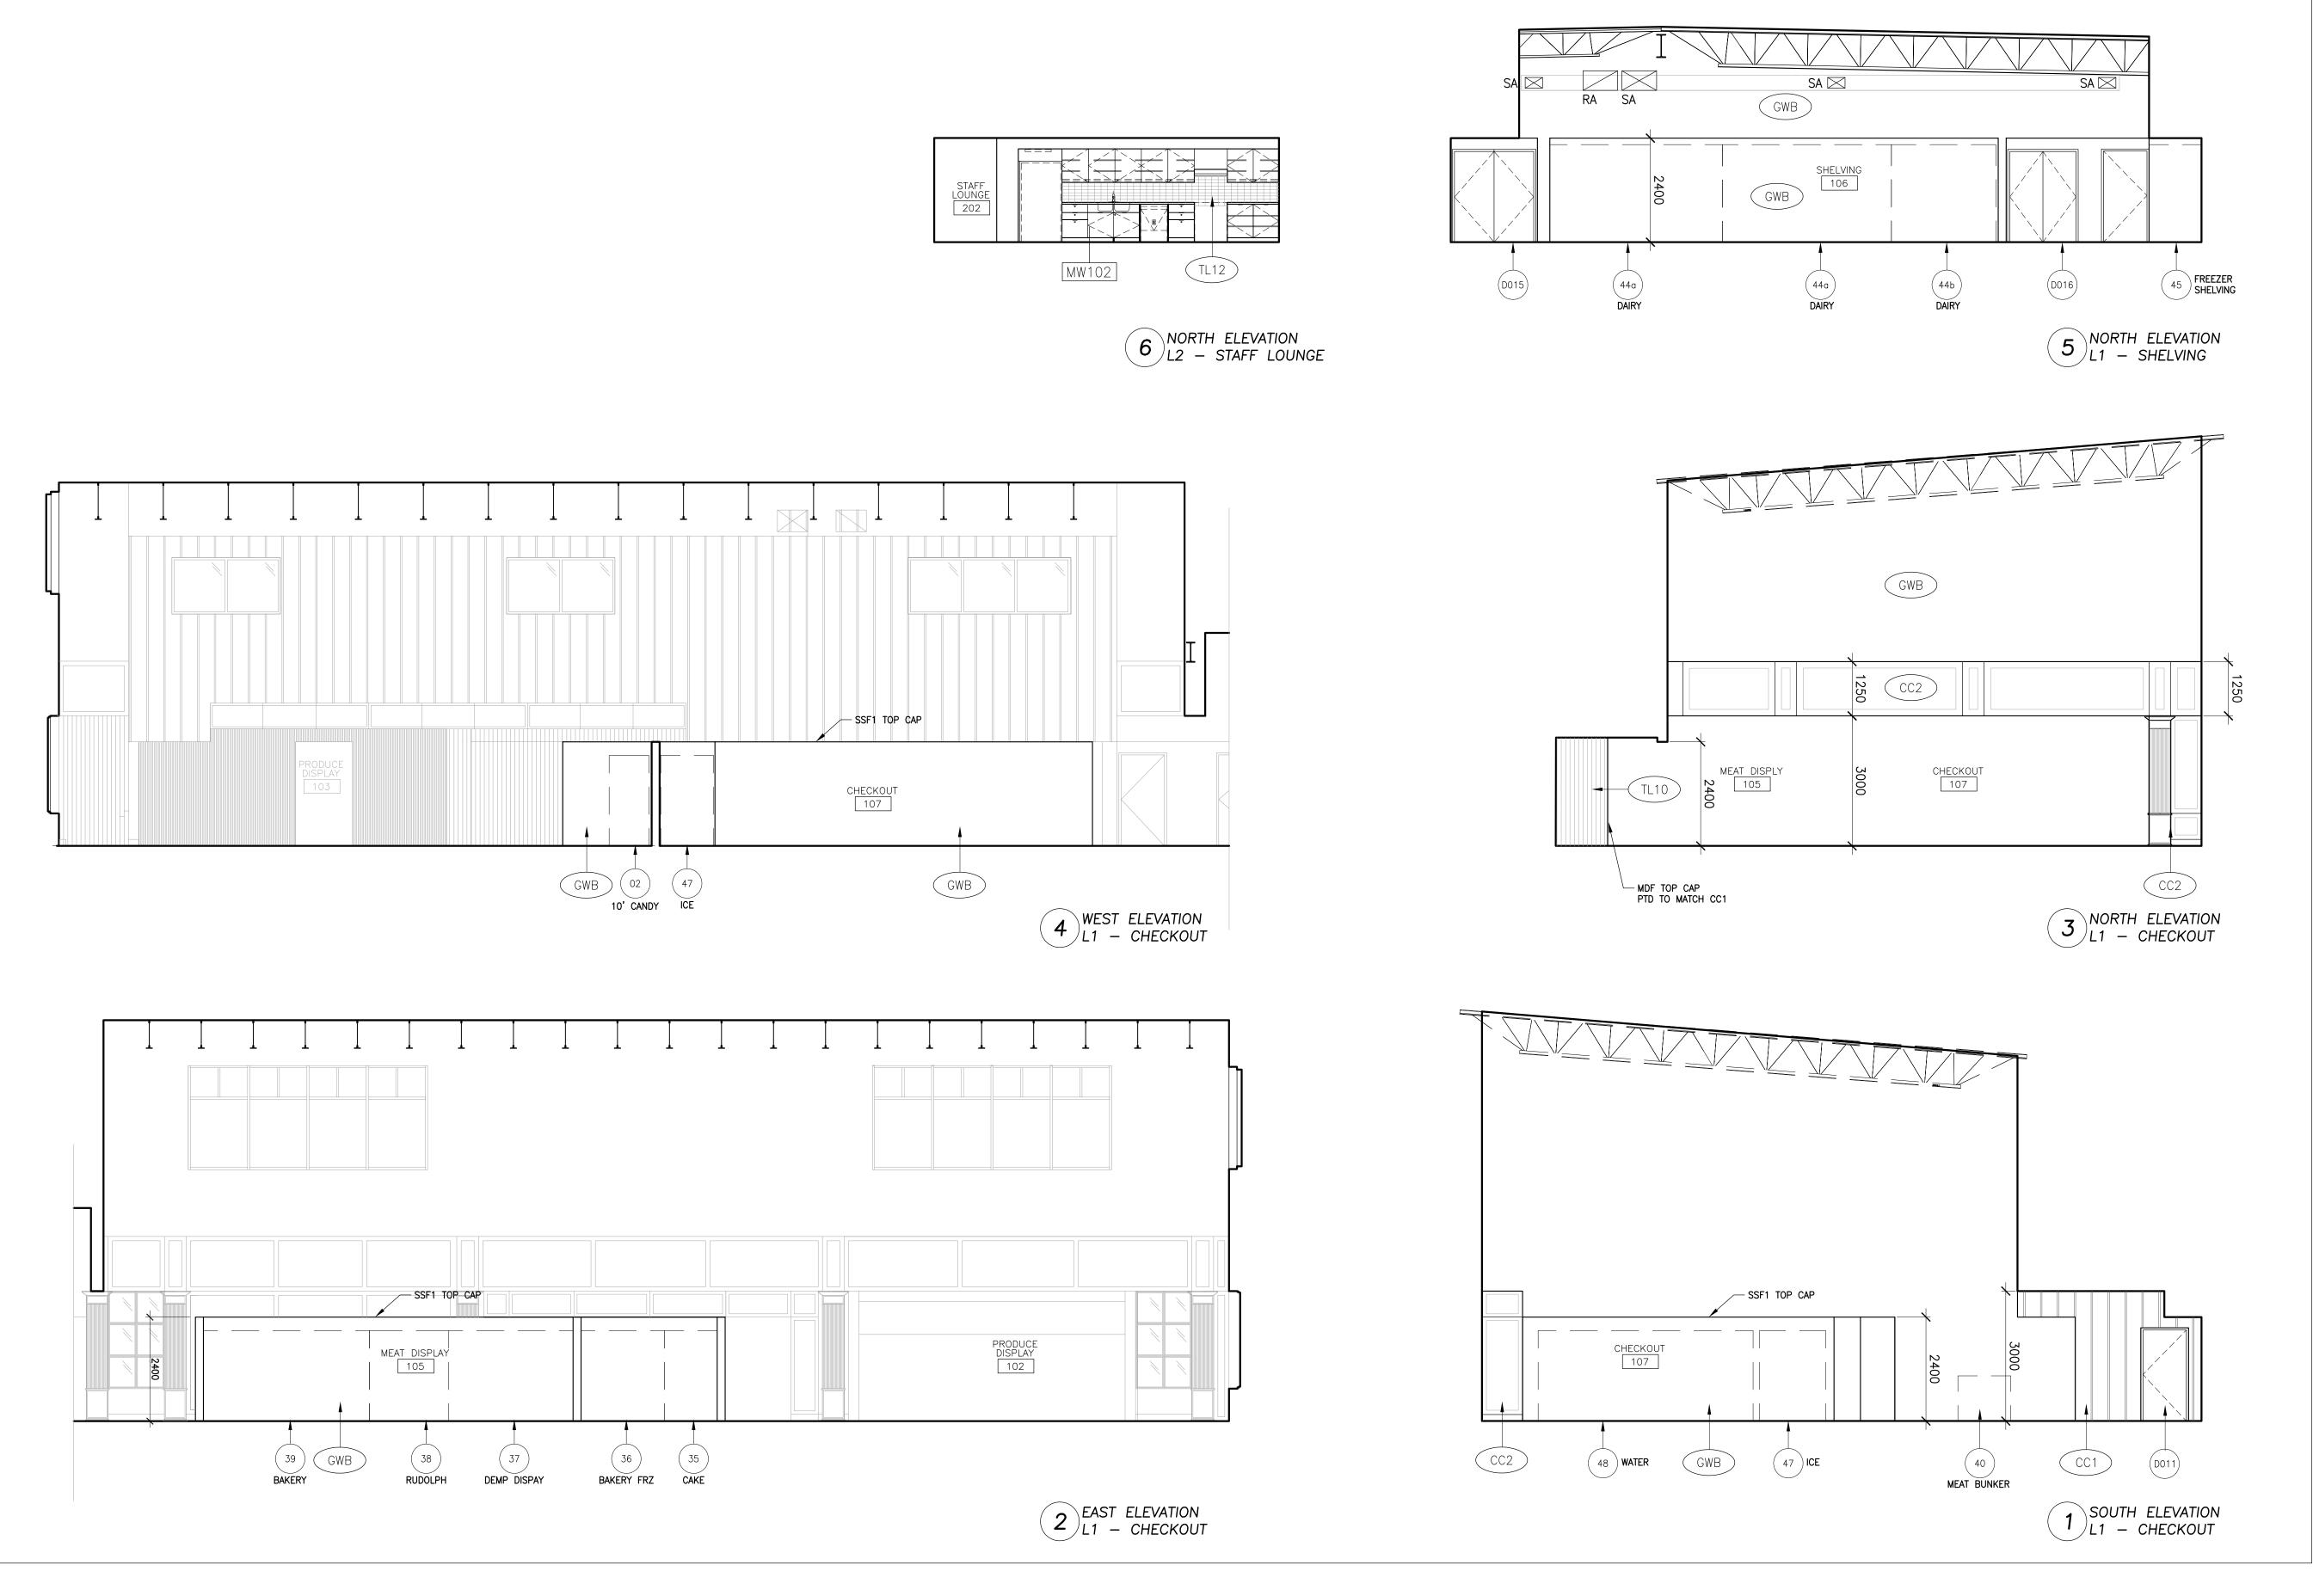

REV	DESCRIPTION	DATE	B,
1	ISSUED FOR SPA	210618	AE
2	REVISED SPA	210709	AE
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4	ISSUED FOR TENDER	210824	AE
5	ISSUED FOR BUILDING PERMIT	210909	AE
6	REVISED TENDER	220124	AE
7	_	_	_
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9	_	_	-
10	-	-	-
11	_	_	_

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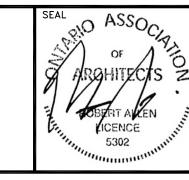
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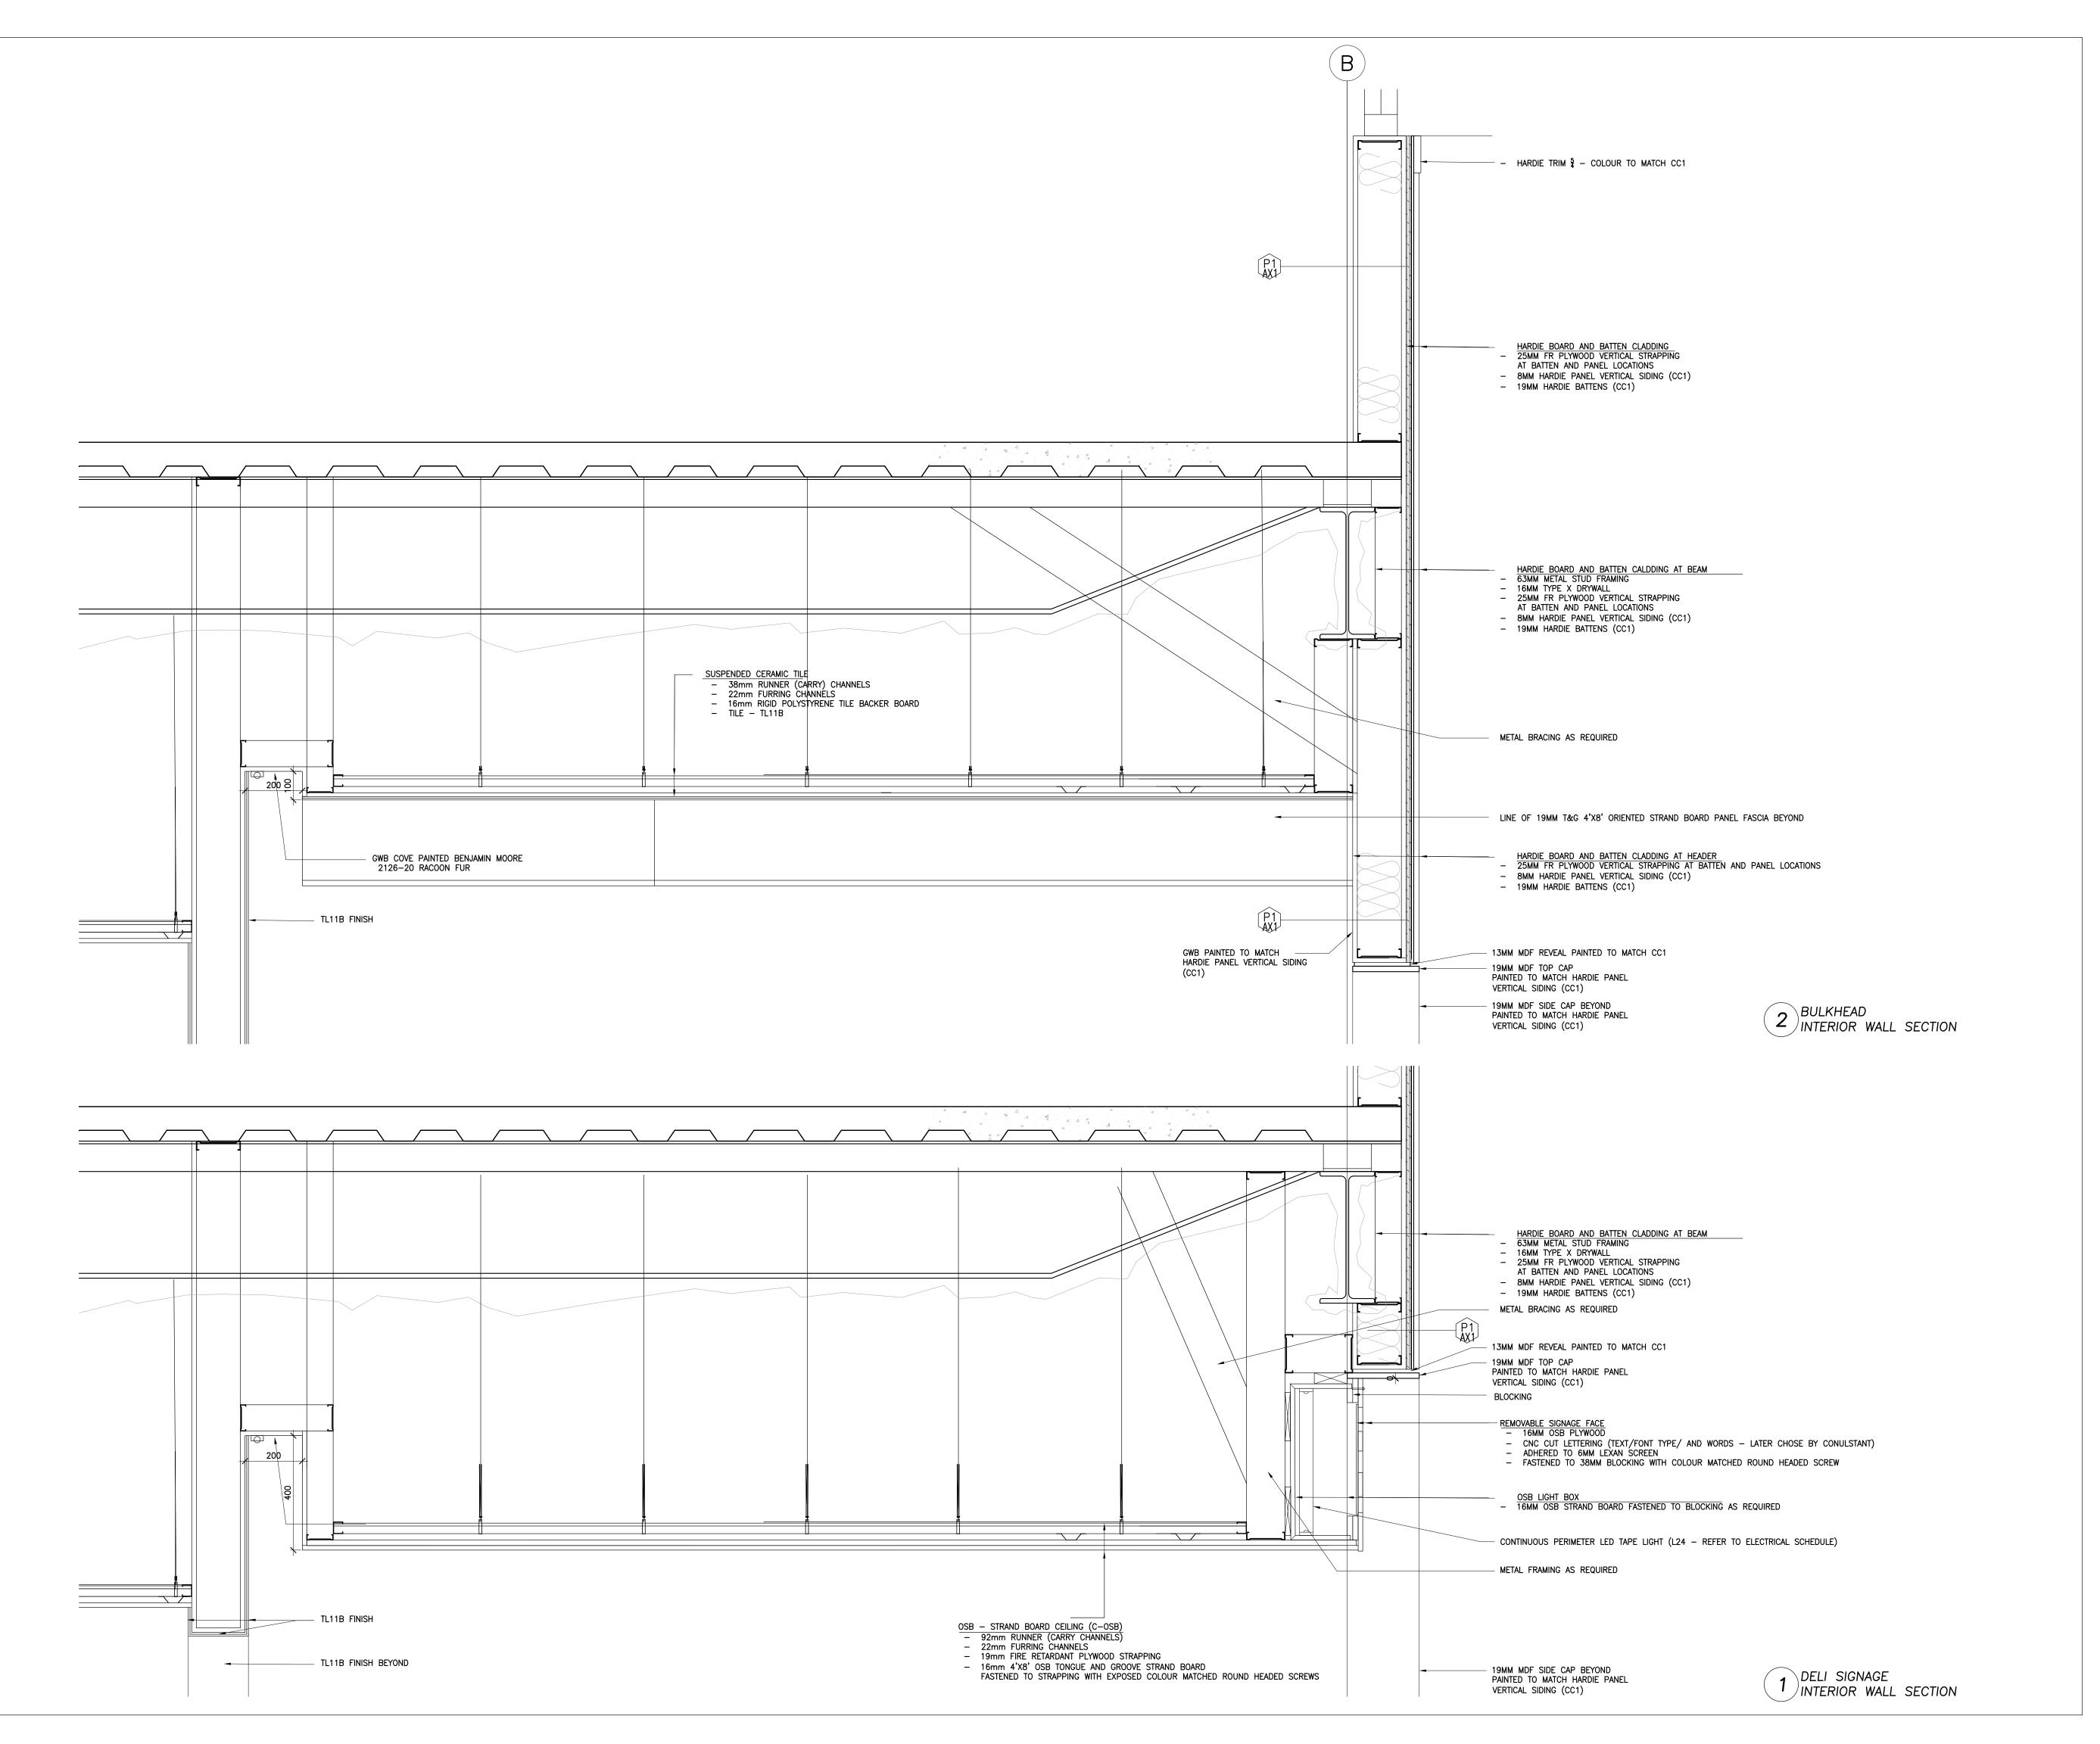
INTERIOR ELEVATIONS
SCALE

1:100

JANUARY 24, 2022

PROJECT NUMBER

2102 DRAWING NUMBER



REV	DESCRIPTION	DATE	В
1	ISSUED FOR SPA	210618	А
2	REVISED SPA	210709	А
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5	ISSUED FOR BUILDING PERMIT	210909	Д
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229 BROADWAY, UNIT 1
ORANGEVILLE, ONTARIO, L9W 1K4
TEL 519 941 0330 FAX 519 941 1830

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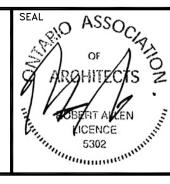
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PROJECT TITLE

NEW SAYERS FOOD STORE BURLEIGH STREET, APSLEY

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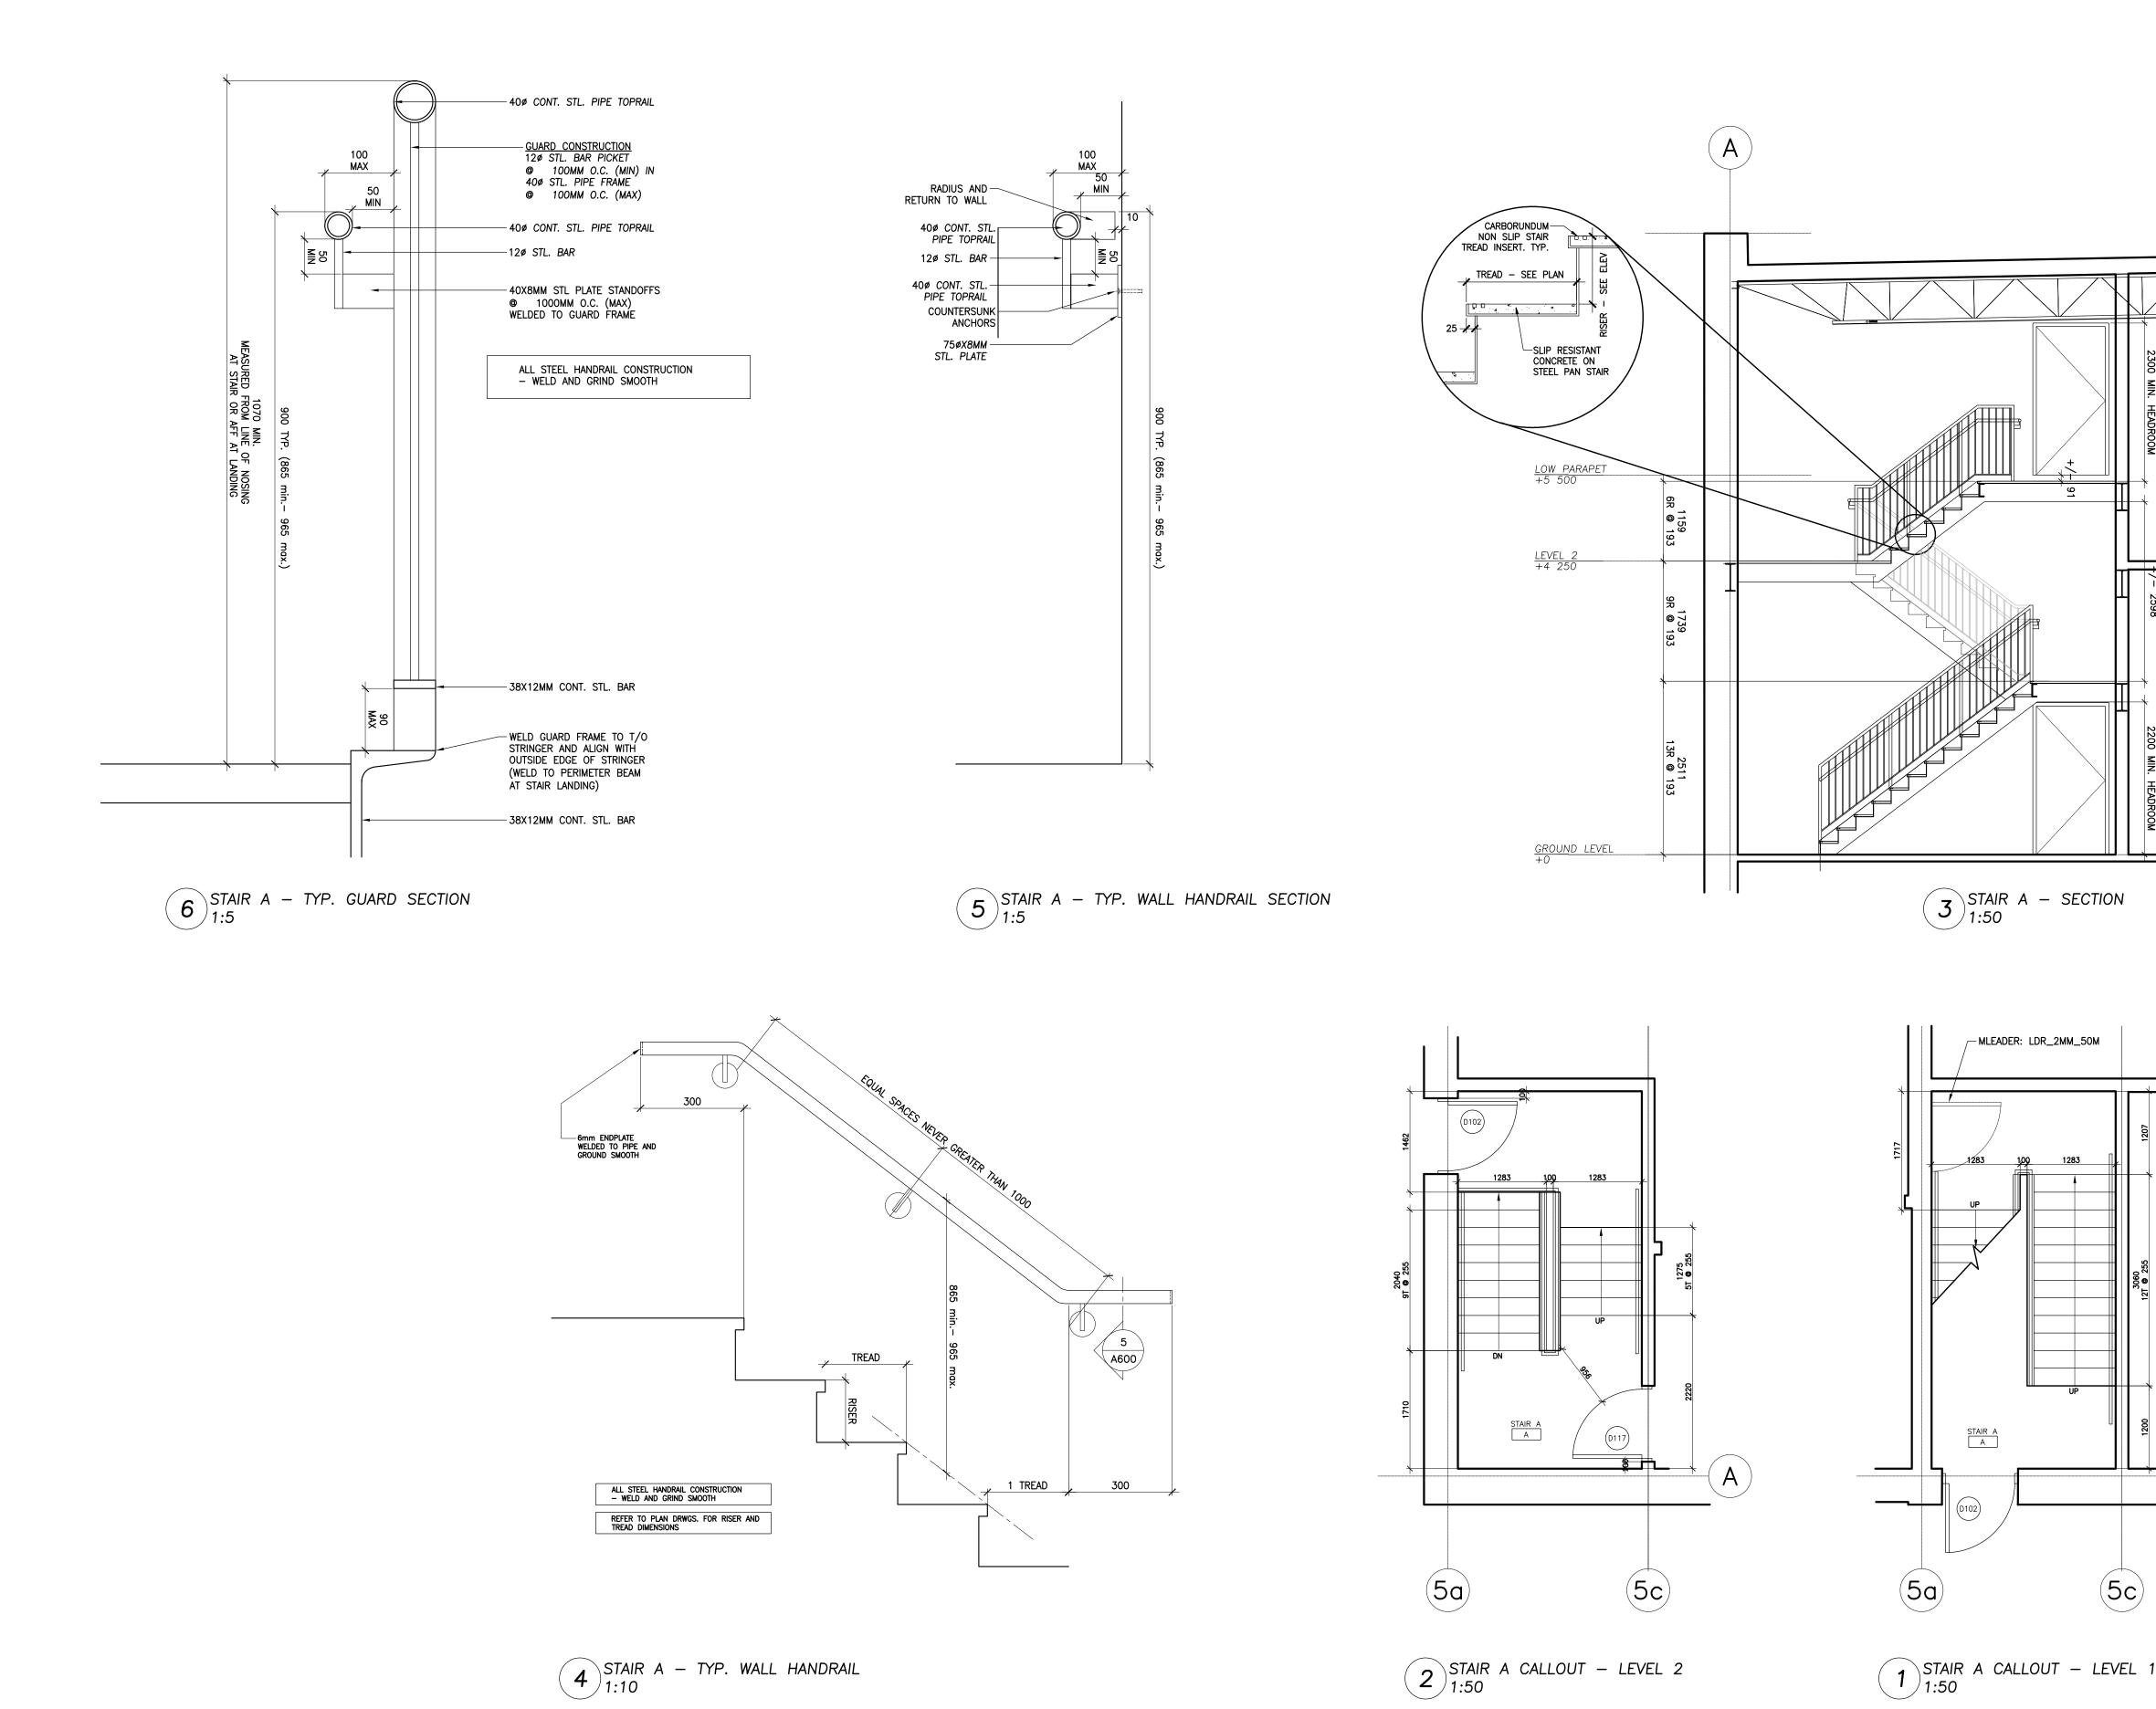
DELI AND BAKERY
INTERIOR WALL SECTIONS

1:10

JANUARY 24, 2022

PROJECT NUMBER 2102

DRAWING NUMBER



REV	DESCRIPTION	DATE	B,
1	ISSUED FOR SPA	210618	AE
2	REVISED SPA	210709	AE
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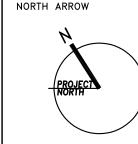
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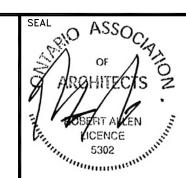
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PROJECT TITLE

NEW SAYERS FOOD STORE BURLEIGH STREET, APSLEY

DRAWING TITLE

STAIR DRAWINGS

SCALE
AS NOTED

DATE

JANUARY 24, 2022

PROJECT NUMBER 2102 DRAWING NUMBER

D006 - LOADING DOCK LEVELER, SEAL, ACCESSORIES, DOOR

Loading Dock Specifications - Sayer's Grocery Store in Aspley, Ontario

Serco Hydraulic Dock Leveler

Item: Model: Serco Model HL830 Hydraulic Dock Leveler Featuring: Nominal size 6' wide x 8' long

30,000 lbs. capacity per ANSI MH 14.1 1992

Pour in pan style dock leveler

20" long, high tensile steel lip plate 5/8" thick

Power in/Power out lip control Regenerative hydraulic system

4 ½" diameter main cylinder, 2 ½" diameter lip cylinder

Safety tread deck plate 1/4" thick Full range telescoping toe guards Hinged maintenance post Below dock control

Fall Safe

Grease fittings on hinge tube

Minimum lip crown set at 4" above dock

15 degree leading edge lip bevel Clean frame subframe designed to minimize pit floor obstructions and

enhance pit clean-up operations VB42011F Laminated rubber bumpers per unit

10 year structural warranty, 5 year hydraulic warranty

Serco Dock Seal <u>Item:</u> Model:

Serco Model S-600 Fixed header dock seal Featuring:

Head pad 120" wide x 12" face x 12" projection

Side pad 108" long x 12" face x 12" backboard x 12" projection Designed to suit door opening 8' wide x 9' high and dock height 48"

Base fabric: 40 oz.

40 oz. Wear pleats with 4" exposure

Full length 4" wide yellow guide stripe on vertical pads

One year warranty

Serco Loading Light <u>Item:</u> Featuring: 62" flexible arm extension

2" diameter LED light

Serco Wheel Chock <u>Item:</u> Featuring:

Heavy Duty molded rubber Chock

15' of galvanized chain Steel wall-mount bracket

Serco Overhead Door

Items: Model: Garaga G-5000


Door size 8'0" wide x 9'0" high Features:


Foam Injected R-16 rating 3" track and hardware Weatherseal package


Continuous angle One window per door


Option: Electric operator c/w chain hoist

						DOOR				JAMB	F	RAME			FIRE			5445			
EVEL	ROOM#	ROOM NAME	DOOR#	WIDTH	HEIGHT	TYPE	MAT'L	FIN.	GLZING	TYPE		MAT'L	FIN.		FIRE RAT'G	HINGE	LOCK	PANIC HARDWARE	CLOSER	STOP	REMARKS
1	101	EXIT VESTIBULE	D001	3188	2600	SED1	ALUM	_	TG	_	SEE S	SCREEN	SCH'D	YES	NO	Y	Υ	Υ	_	_	AUTOMATIC SLIDING DOOR W/ BREAKOUT PANELS REFER TO ESCO2 ON A710 - SCREEN SCHEDULE
1	102	ENTRY VESTIBULE	D002	3188	2600	SED1	ALUM	_	TG	_	SEE S	SCREEN	SCH'D	YES	NO	Y	Υ	Υ	-	-	AUTOMATIC SLIDING DOOR W/ BREAKOUT PANELS REFER TO ESCO2 ON A710 - SCREEN SCHEDULE
1	104	BAKERY DISPLAY	D003	2000	3000	D-03	WD	_	TG	_	_	_	_	-	NO	Y	Υ	Y	Υ	Υ	REFER TO WED1 IN OUTLINE SPEC.
1	А	STAIR A	D004	1000	2150	D-01	НМ	PT	_	_	F-01	НМІ	PT	YES	NO	Y	Υ	Y	Υ	Y	-
1	121	SERVICE	D005	1220	2150	D-01	НМІ	PT	_	_	F-01	НМІ	PT	YES	NO	Y	Υ	Y	Υ	Υ	-
1	122	SERVICE - DOCK	D006	2440	2743	_	_	-	_	_	_	_	_	_	_	_	Υ	_	_	_	REFER TO DOO6 — LOADING DOCK LEVELER, SEAL, ACCESSORIES, DOO SPECIFICATION AND DETAILS
2	202	STAFF LOUNGE	D101	1000	2350	D-01		PT	TG	_	SEE S	SCREEN	SCH'D	YES	NO	Υ	Υ	_	Υ	_	REFER TO SCREEN SCHEDULE - THERMAPORTE 7700
2	А	STAIR A	D102	1000	2150	D-01	НМІ	PT	_	_	F-01	НМІ	PTD	YES	NO	Υ	Υ	_	Υ	1	-
INIT	EDIC	DR DOOR S	`СП[- חווו	E																
HNI	LINIC	IN DOON S	OTIL																		
-\/_1	BOOM//	DOOM NAME				DOOR				JAMB	F	RAME		INCLI	FIRE	LUNCE	1.001	PANIC	دا ۱۹۵۲	CTOD	DEMARKS
EVEL	ROOM#	ROOM NAME	DOOR#	WIDTH	HEIGHT	TYPE	MAT'L	FIN.	GLZING	TYPE	TYPE	MAT'L	FIN.	INSUL	RAT'G	HINGE	LUCK	HARDWARE	CLOSER	STOP	REMARKS
1	А	STAIR A	D011	1000	2150	D-01	НМ	PT	NO	1	F1	НМ	PT	NO	1HR	Υ	-	Y	Υ	ı	_
1	115	UNIVERSAL WC	D012	1000	2150	D-01	НМ	PT	NO	_	F1	НМ	PT	NO	NO	Y	Υ	-	Υ	_	INC. ADO (X2) SYSTEM
1	116	PRODUCE PREP/STOR.	D013	1220	2150	D-04	_	-	YES	_	_	_	_	_	-	_	-	-	_	-	INTERIOR TRAFFIC DOOR
1	119	MEAT PREP	D014	1220	2150	D-04	_	-	YES	-	_	-		_	_	_	_	-	_		INTERIOR TRAFFIC DOOR
1	121	SERVICE	D015	1600	2150	D-05	_	ı	YES	-	_	_	1	_	_	_	_	-	_		INTERIOR TRAFFIC DOOR - NOTE 1625mm RO
1	121	SERVICE	D016	1830	2150	D-05	_	ı	YES	-	-	_	1	_	_	_	-	-	_	-	INTERIOR TRAFFIC DOOR
1	113	WALKIN COOLER	D020	1220	2150	_	_	-	_	_	_	_	_	_	_	-	-	-	-	-	PROVIDED BY COOLER/FREEZER SUPPLIER
1	114	WALKIN FREEZER	D021	1220	2150	_	-	-	-	-	-	_	-	_	_	-	-	_	-	-	PROVIDED BY COOLER/FREEZER SUPPLIER
1	117	WALKIN PRODUCE	D022	1524	2150	_	_	-	_	-	_	_	_	_	_	_	_	-	_	ı	PROVIDED BY COOLER/FREEZER SUPPLIER
1	118	MEAT COOLER	D023	1524	2150	_	_	-	_	_	_	_	_	_	_	_	_	_	-	-	PROVIDED BY COOLER/FREEZER SUPPLIER
1	120	FREEZER	D024	1524	2150	_	-	-	_	_	_	_	_	-	_	_	_	-	_	-	PROVIDED BY COOLER/FREEZER SUPPLIER
1	122	WALKIN DAIRY	D025	1524	2150	_	_	_	_	_	_	_	_	-	_	_	-	_	_	-	PROVIDED BY COOLER/FREEZER SUPPLIER
1	123	WC	D026	1000	2150	D-01	НМ	PT	NO	_	F1	НМ	PT	NO	NO	Y	Υ	-	Υ	-	-
2	208	ELEC	D110	1000	2150	D-01	НМ	PT	NO	_	F1	НМ	PT	-	1HR	Υ	Υ	_	Υ	_	-
2	206	WC	D111	1000	2150	D-01	НМ	PT	NO	_	F1	НМ	PT	_	_	Y	Υ	_	Υ	_	-
2	204	PRIVATE OFFICE	D112	1000	2150	D-01	НМ	PT	NO	_	F1	НМ	PT	-	_	Y	Υ	_	Υ	-	-
2	205	SHOWER/WC	D113	1000	2150	D-01	НМ	PT	NO	_	F1	НМ	PT	_	_	Υ	Υ	_	Υ	_	-
2	207	STORAGE	D114	2000	2150	D-02	НМ	PT	NO	_	F2	НМ	PT	_	_	Y	Υ	_	Υ	Y	-
2	201	CORRIDOR	D115	900	2150	D-02	НМ	PT	NO	_	F2	НМ	PT	_	_	Y	Υ	_	Υ	_	-
2	203	OPEN OFFICE	D116	1000	2150	D-01	НМ	PT	NO	_	F1	НМ	PT	-	_	Υ	Υ	_	Υ	Υ	-
2	А	STAIR A	D117	1000	2150	D-01	НМ	PT	NO	_	F1	НМ	PT	-	1HR	Υ	Υ	_	Υ	-	-
DOOR LI ALUM ANOD CL HM NSUL	ALUMIN ANODIZ CLEAR	ZED TO FINISH WI W METAL SF	- })	NOT APF PAINT TEMPERE WOOD VI SOLID P STAINLES	ED GLASS ENEER HENOLIC		HARDV AR CH S/W H/W	C	GEND: DAMS RI ONTINUO TANDARD EAVY WE	US HING WEIGHT	BUTT I		CL DL ML PP RIM	MC MC PU		LL					***REFER TO A700 FOR ALUMINUM SCREENS AND GLAZING CVR CONCEALED VERTICAL ROD EXIT DEVICE CONC CONCEALED DOOR CLOSER REGU SURFACE DOOR CLOSER COHS CONCEALED OVERHEAD STOP

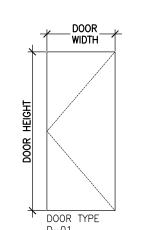


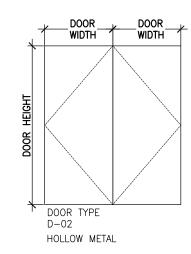

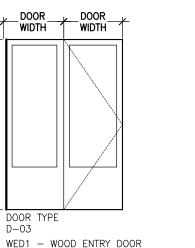

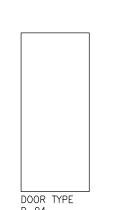


INTERIOR TRAFFIC DOOR

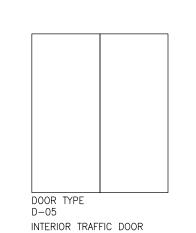

01 DOOR TYPE (N.T.S)

HOLLOW METAL

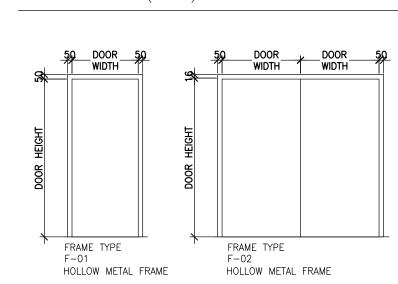

02 FRAME TYPES (N.T.S)

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12	-	-	_

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maclennan jaunkalns miller architects

425 adelaide street west level 6 toronto ontario m5v 3c1 416 593 6796 www.mjmarchitects.com

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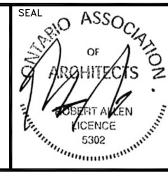
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SAYERS FOOD LIMITED

132 BURLEIGH STREET t: 705.656.4531 e: sayers@apsley.ca



PROJECT TITLE

NEW SAYERS FOOD STORE BURLEIGH STREET, APSLEY


DRAWING TITLE

DOOR SCHEDULE AND DETAILS

NTS

JANUARY 24, 2022

PROJECT NUMBER 2102 DRAWING NUMBER

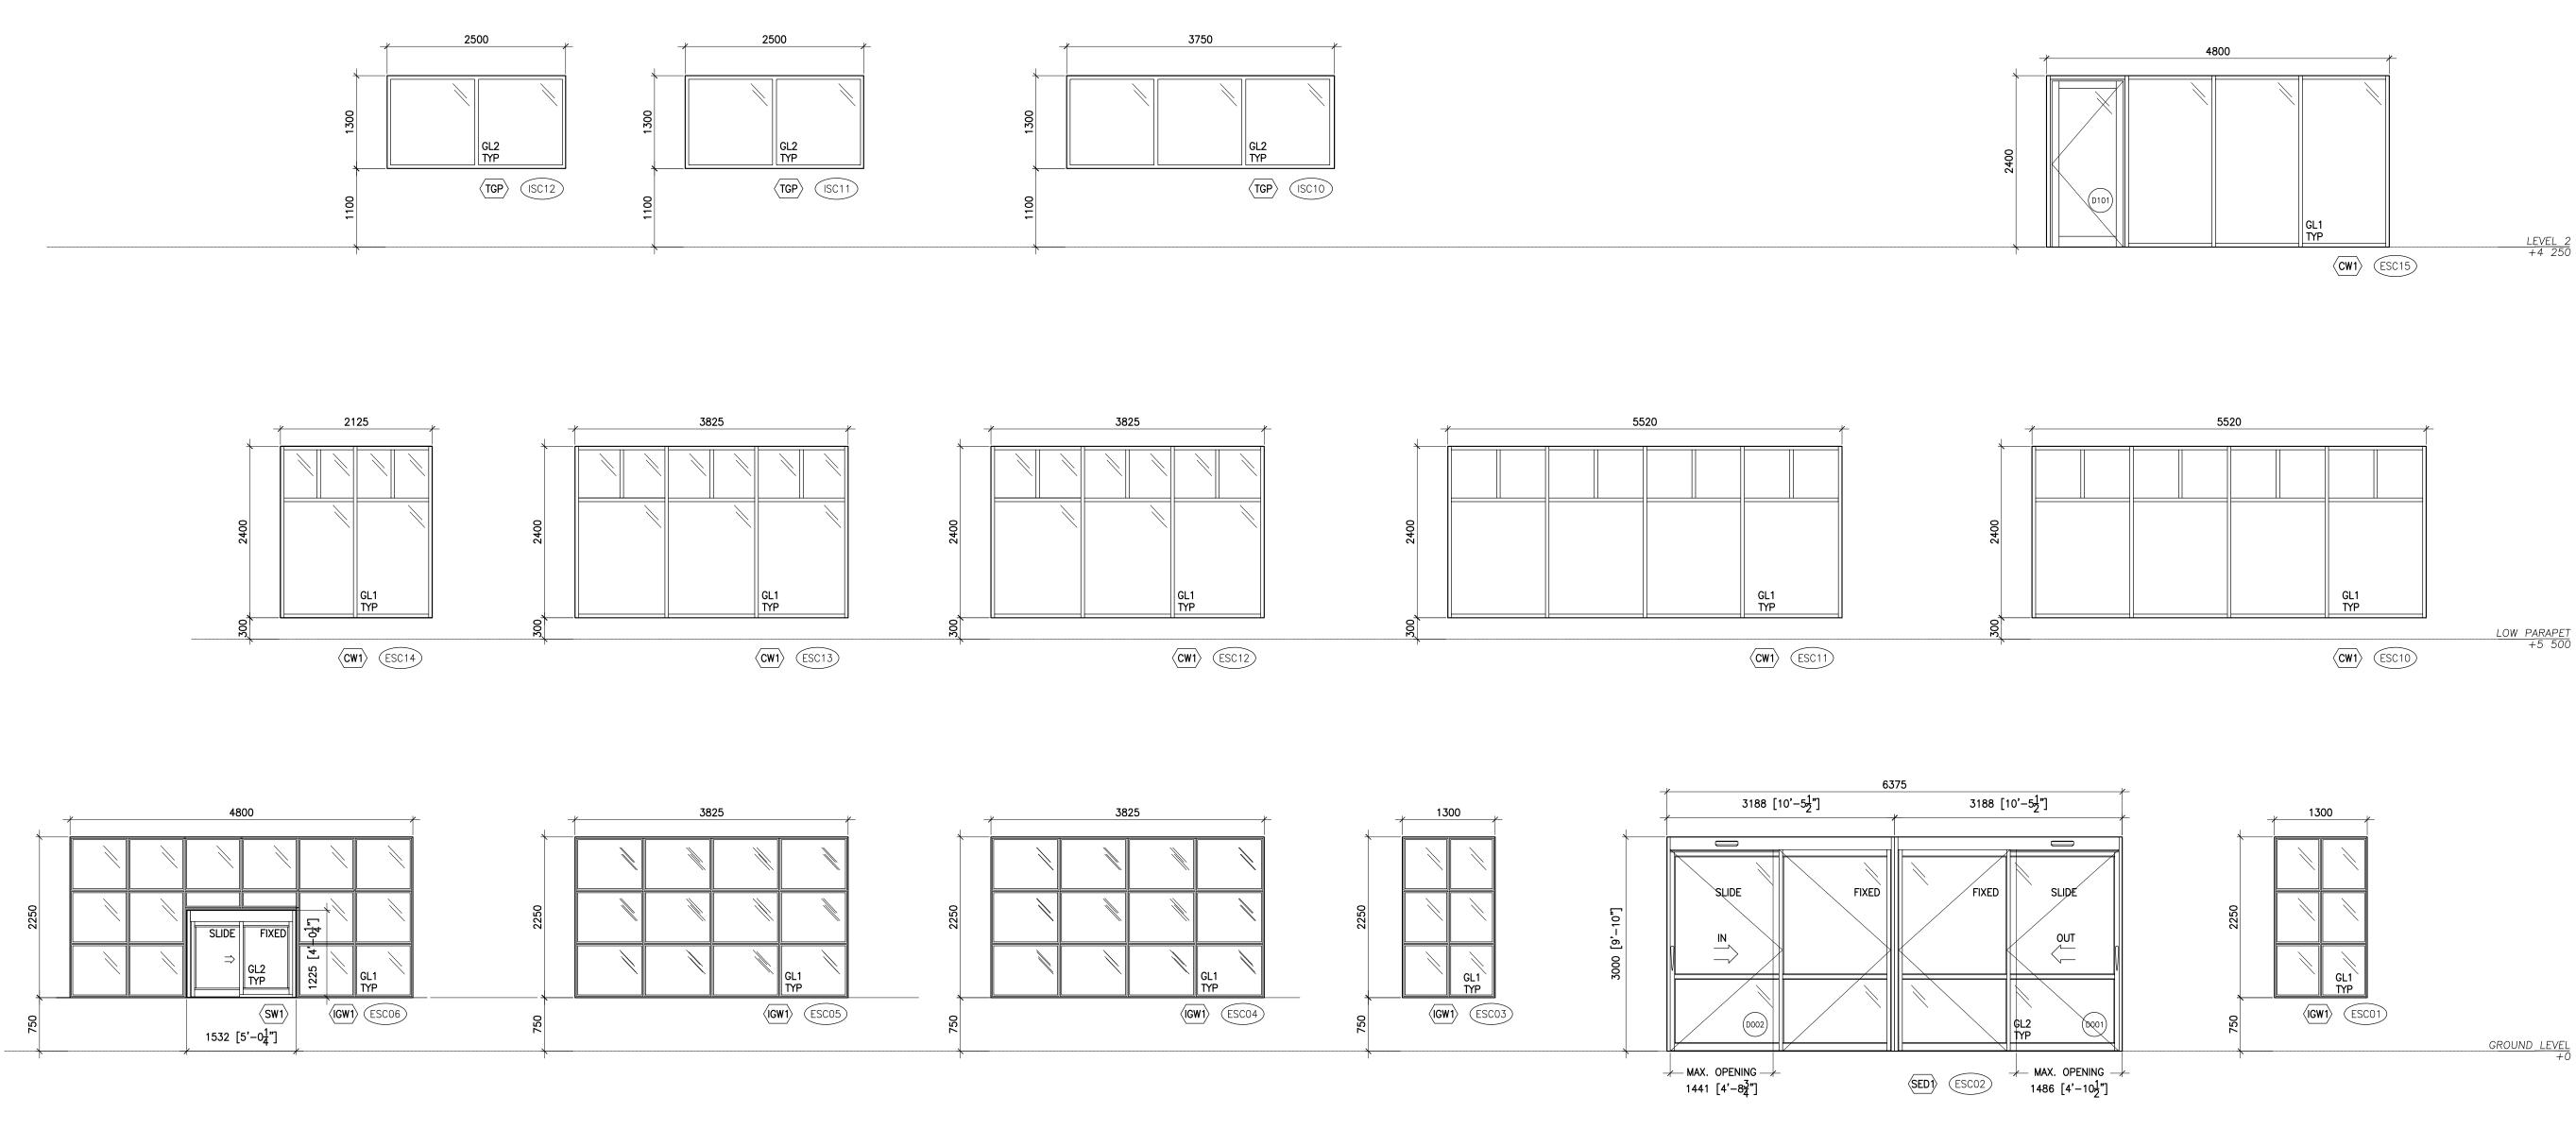

GLAZING SCHEDULE LOW E COATING
TYPE SURFACE Esc-Frit TYPE Esc-Frit SURFACE

DOUBLE \$2
SILVER GLASS TYPE OUTER INNER GLAZING NOTE TYPICAL EXTERIOR IGU, ARGON-FILLED, DESSICANT-FILLED WARM-EDGE SPACER BAR. GL2 FIRE—RATED CERAMIC GALZING SEE OUTLINE SPEC

FRAME TYPE IGW1 INTERIOR GLAZED WINDOW

ALUMICOR SHADOWLINE 970 — THERMALLY BROKEN 19mmx133mm PREPAINTED ALUM. SECTIONS GLASS: GL1 COLOUR: CUSTOM (TBD) CW1 CURTAIN WALL ALUMICOR THERMAWALL TW2200 — THERMALLY BROKEN 50.8mmx101.8mm PREPAINTED ALUM. BACK SECTIONS PERIMETER MULLIONS AT TOP AND BOTTOM: 19mm CAPPED PERIMETER MULLIONS AT JAMBS: 19mm CAPPED INTERMEDIATE VERTICAL MULLIONS: 19mm CAPPED GLASS: GL1 COLOUR: CUSTOM (TBD)

SED1 AUTOMATIC SLIDING ENTRANCE DOORS HORTON AUTOMATICS — PROSLIDE SERIES 2021
SLIDING DOOR SYSTEM WITH ELECTRIC BELT DRIVE OPERATOR
DOOR TYPE: 310 — SX & SO
OPTEXT I—ONEXT MOTION/PRESENCE DETECTORS AND
M/S MANUAL LOCKING
PREPAINTED COLOUR = CUSTOM (TBD) GLAZING SCHEDULE LEGEND

GLAZING NOTES:

CURTAINWALL NOTES:

GLASS TYPE: LOW'E' COATING: FT FULLY TEMPERED DS DOUBLE SILVER

FRIT TYPE: LAMINATED INTERLAYER: FR1 SOLID OPAQUE FRIT PVB POLYVINYL BUTYRAL

GLASS THICKNESS: 6mm MINIMUM AND AS REQUIRED TO SUIT DESIGN REQUIREMENT.
 LAMINATED GLASS: GLASS LAYERS MINIMUM 3mm THICK UNLESS OTHERWISE INDICATED.
 DESIGNED FOR GUARD LOADS WHERE REQUIRED. INDICATE LOCATIONS ON SHOP DRAWING.

PROVIDE REINFORCING IN ALUM SECTION AS NECESSARY TO MAINTAIN SECTIONS AS SHOWN. REFER TO PROJECT MANUAL.
 SEE PROJECT MANUAL AND DOOR SCHEDULE FOR GLAZED ALUM DOORS.
 DIMENSIONS INDICATED ARE NOMINAL ALL DIMENSIONS TO BE SITE VERIFIED.
 ALL FRAMES TO RECEIVE DURANAR XL PTD FINISH UNLESS OTHERWISE NOTED.

SW1 SLIDING SERVICE WINDOW HORTON AUTOMATICS — SERIES 8900
DOOR TYPE = X-0
HEADER = 64mm LOW-PROFILE
OPERATOR = RECESSED MANUAL PULL
LOCK = THUMB LOCK
PREPAINTED COLOUR = CUSTOM (TBD)

TGP FIRE RATED GLASS AND FRAMING FIRE-RATED METAL FRAME AND GLAZING (45MIN. WALL FFR) Contractor must check and verify all dimensions on the job, and report any discrepancies to the Architect before proceeding with the work. Do not scale this drawing.

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12	_	_	

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maclennan jaunkalns miller architects

425 adelaide street west level 6 toronto ontario m5v 3c1 416 593 6796 www.mjmarchitects.com

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229 BROADWAY, UNIT 1
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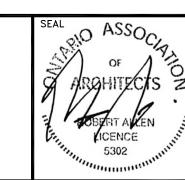
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134 PETER STREET, SUITE 1301
TORONTO, ONTARIO, M5V 2H2
TEL 416.593.5300 FAX 416.593.4840

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PROJECT TITLE

NEW SAYERS FOOD STORE BURLEIGH STREET, APSLEY

DRAWING TITLE


EXTERIOR & INTERIOR SCREEN SCHEDULES

SCALE 1:50

DATE JANUARY 24, 2022

PROJECT NUMBER 2102

DRAWING NUMBER

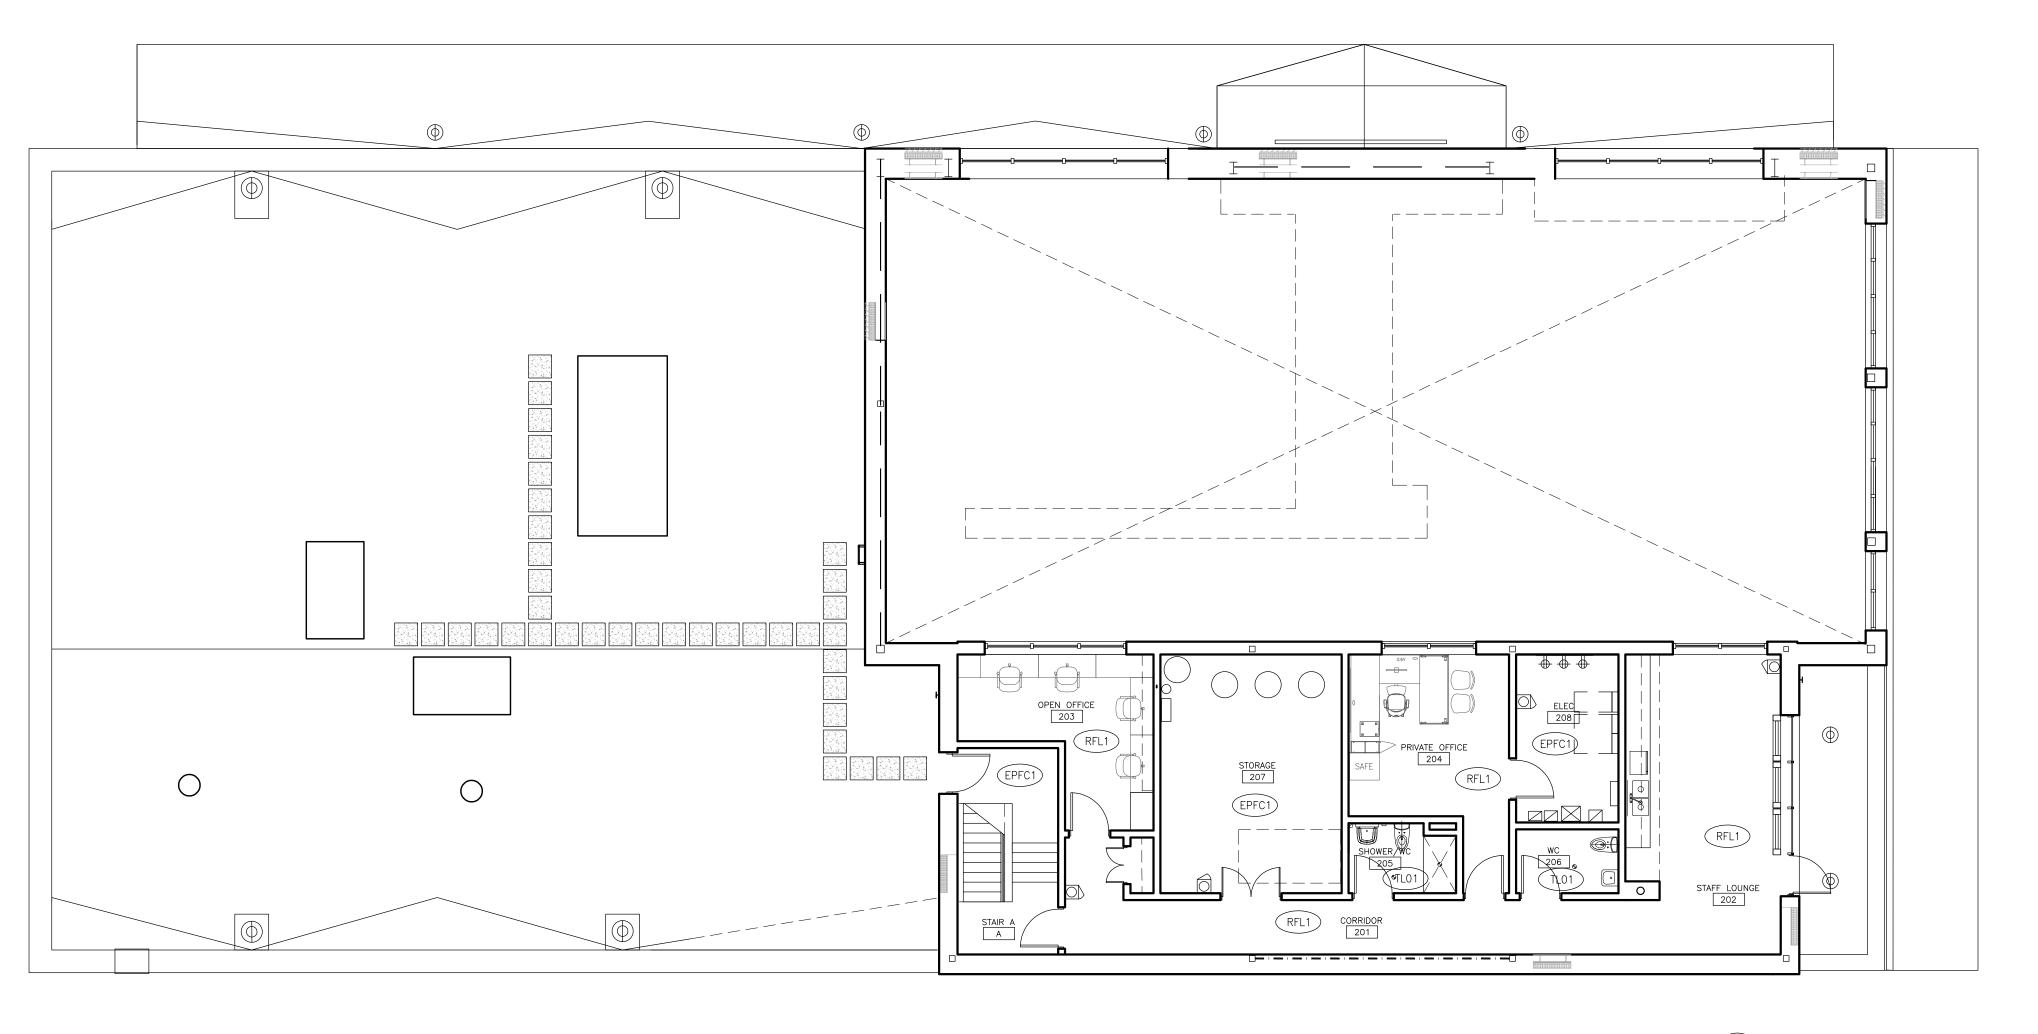

4 LEVEL 2 FINISH PLAN 1:100

PCFL


SFT-01

BAKERY 112

WALKIN COOLER 113

EPFC2

PCFL

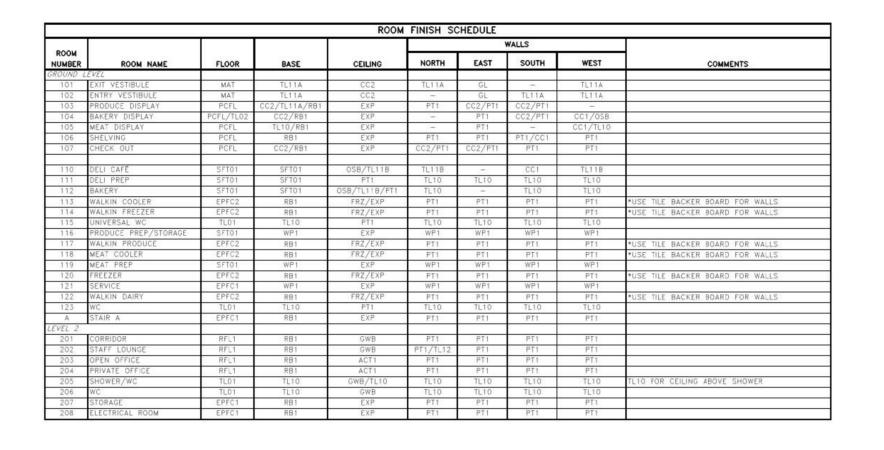

GROUND LEVEL FINISH PLAN 1:100

1 ROOF FINISH SCHEDULE

FINISH NOTES *USE TILE BACKER BOARD TYP. FOR ALL WALL SURFACES DIRECTLY ADJACENT TO INSULATED COOLERS/FREEZERS

INTERIOR FINISHES LEGEND

PCFL POLISHED CONCRETE FLOOR

COSB WOOD CEILING PANEL (OSB)

CC1 CEMENT CLADDING - BOARD AND BATTEN TEXTURE

CC2 DECORATIVE WALL PANELING

TL01 FLOOR TILE 300mm X 300mm

TL02 FLOOR TILE - CUSTOM PATTERN 25mm HEX

TL10 WALL & CEILING TILE 100mm X 400mm

TL11A WALL & CEILING TILE - WHITE 1"X6"

TL11B WALL & CEILING TILE - GREEN 1"X6" TL12 BACKSLASH TILE 3"x6"

ACOUSTIC CEILING TILE 2'X4'

SFT-01 SAFETY FLOORING

RFL1 RESILIENT FLOOR

RB1 RUBBER BASE

EPFC1 EPOXY FLOOR COATING

EPFC2 EPOXY FLOOR COATING

PT1 PAINT (WHITE)

PT2 PAINT (CHARCOAL)

PT3 PAINT (TBD)

WP1 WALL PROTECTION PANEL

MAT ENTRANCE FLOOR MAT

any discrepancies to the Architect before proceeding with the work. Do not scale this drawing.

> REVISIONS AND ISSUES DESCRIPTION DATE ISSUED FOR SPA 210618 REVISED SPA 210709 REVISED SPA 210809 ISSUED FOR TENDER 210824 ISSUED FOR BUILDING PERMIT 210909 REVISED TENDER 220124 _ _ _

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maclennan jaunkalns miller architects

425 adelaide street west level 6 toronto ontario m5v 3c1 416 593 6796 www.mjmarchitects.com

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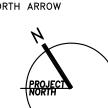
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PROJECT TITLE NEW SAYERS FOOD STORE BURLEIGH STREET, APSLEY


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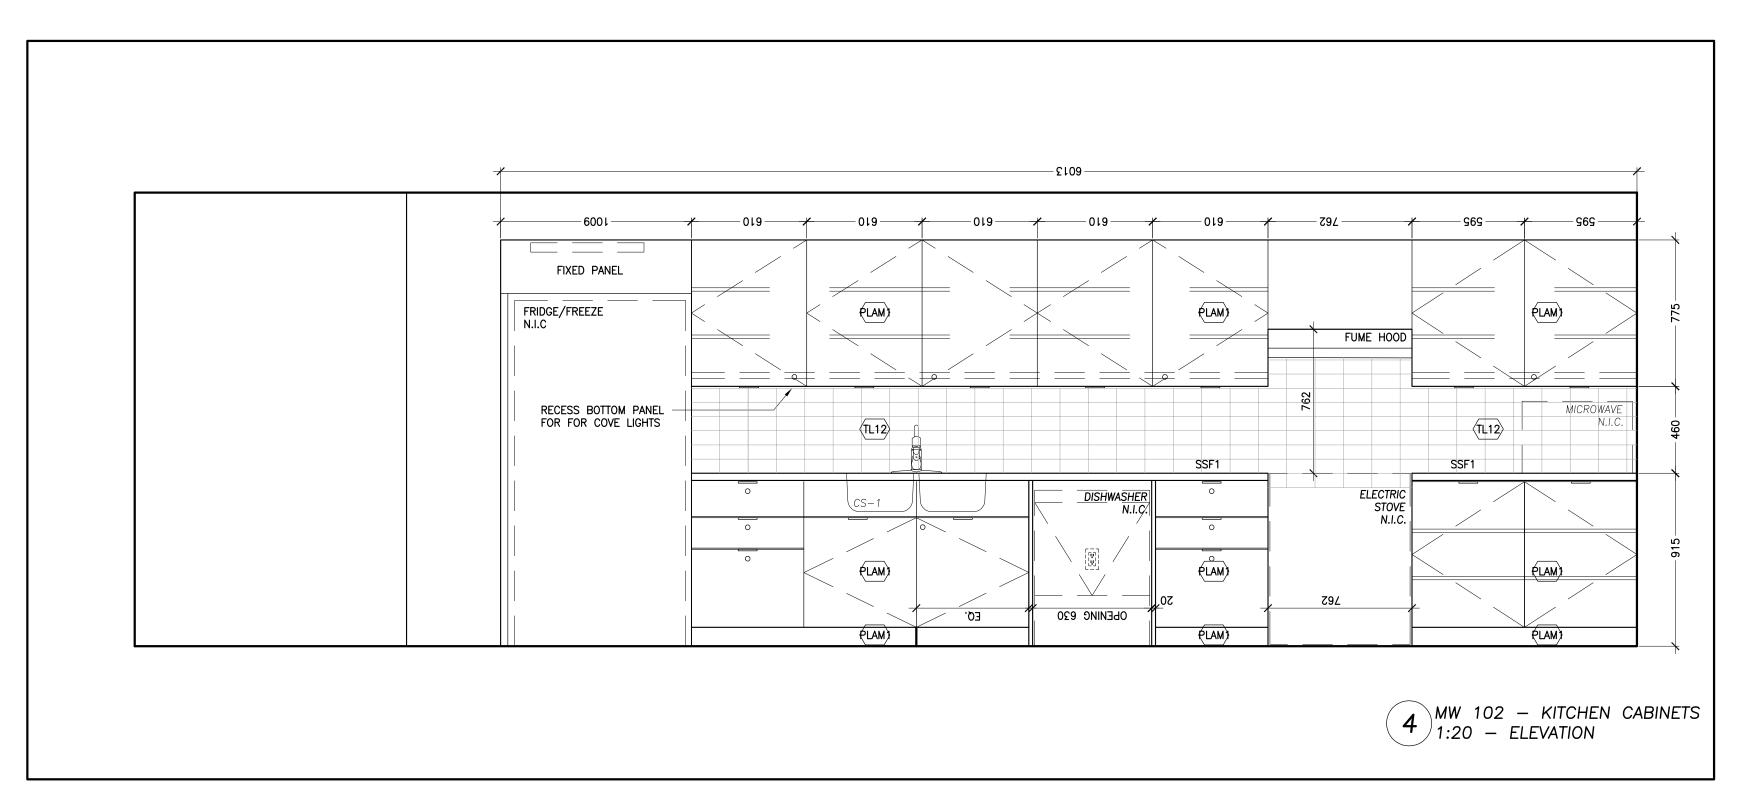
FINISH FLOOR PLANS AND SCHEDULE


1:100

JANUARY 24, 2022

PROJECT NUMBER 2102 DRAWING NUMBER



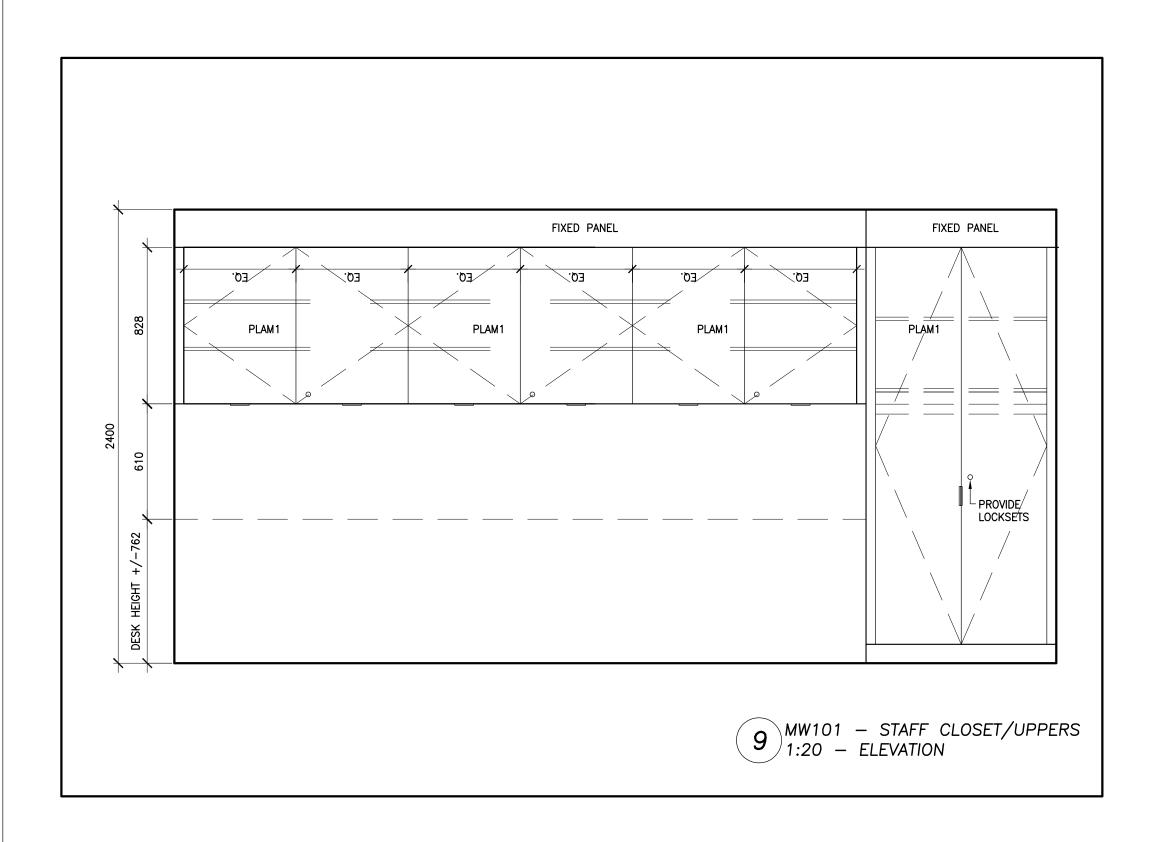

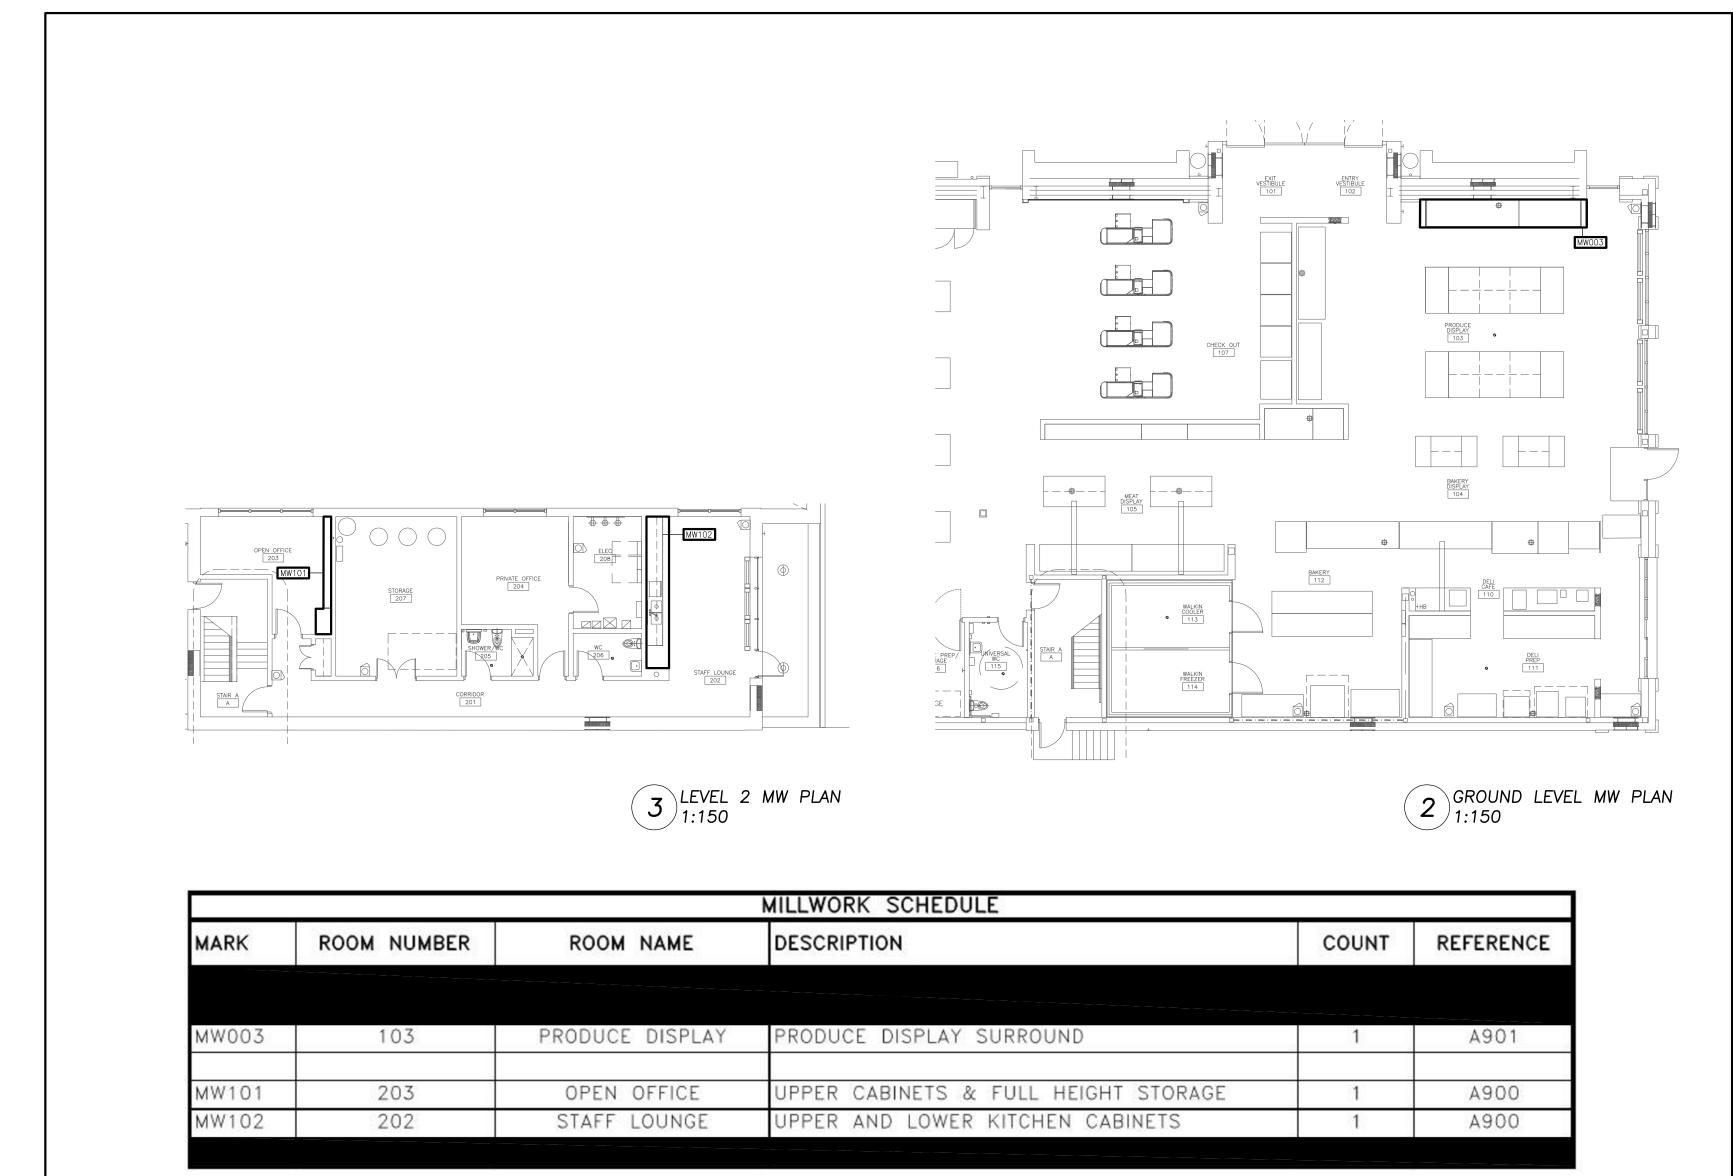

REVISIONS AND ISSUES DESCRIPTION DATE ISSUED FOR SPA 210618 REVISED SPA 210709 REVISED SPA 210809 ISSUED FOR TENDER 210824 ISSUED FOR BUILDING PERMIT 210909 REVISED TENDER 220124 _ _ _

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229 BROADWAY, UNIT 1
ORANGEVILLE, ONTARIO, L9W 1K4
TEL 519 941 0330 FAX 519 941 1830

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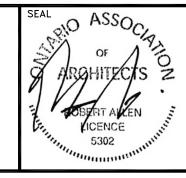
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MECHANICAL AND ELECTRICAL ENGINEERS

1100 - 100 SHEPPARD AVENUE EAST
TORONTO, ONTARIO, M2N 6N5

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NORTH A



PROJECT TITLE

NEW SAYERS FOOD STORE BURLEIGH STREET, APSLEY

DRAWING TITLE

MILLWORK DRAWINGS
scale


AS NOTED

JANUARY 24, 2022

PROJECT NUMBER

1 MILLWORK SCHEDULE

2102
DRAWING NUMBER

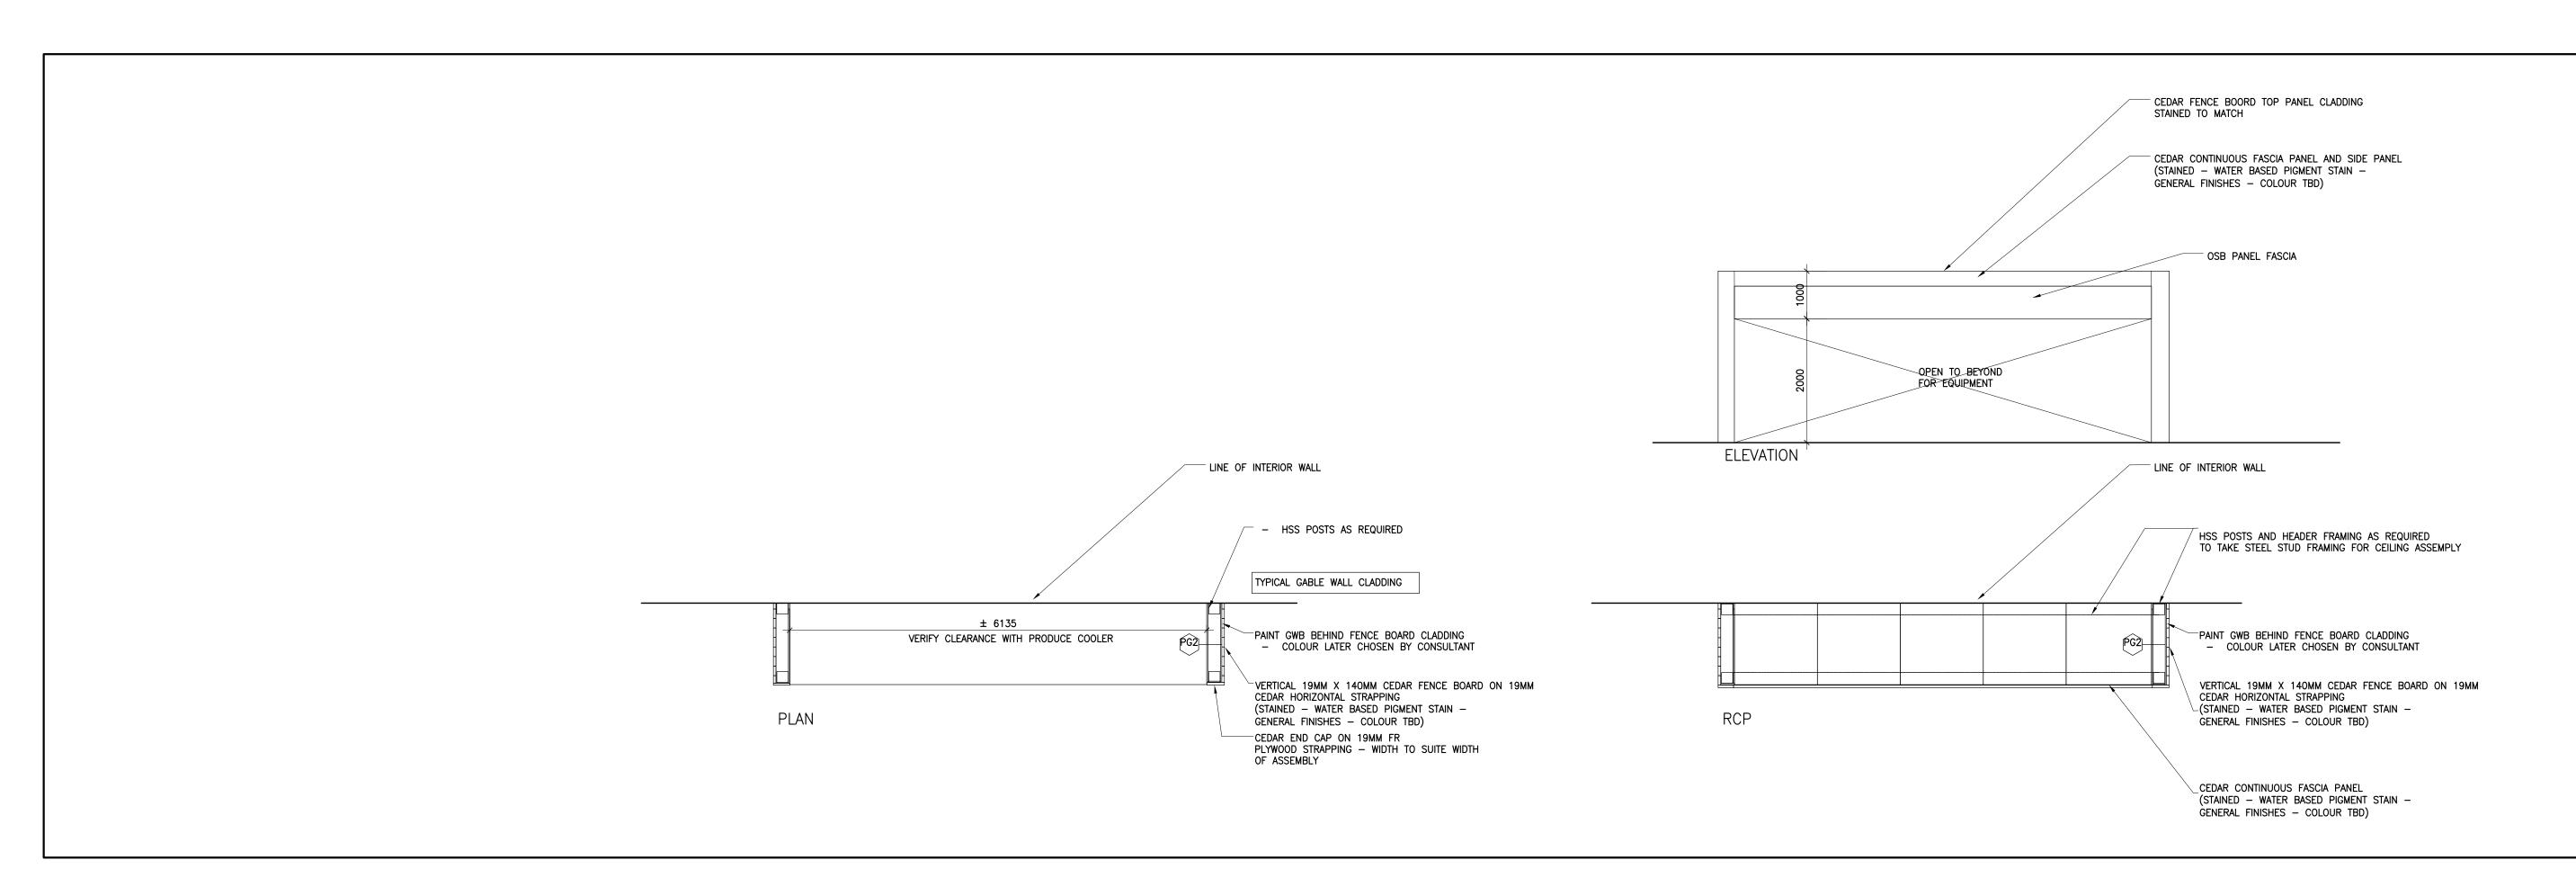

2 MW 003 - PRODUCE COOLER KIOSK 1:50 Contractor must check and verify all dimensions on the job, and report any discrepancies to the Architect before proceeding with the work.

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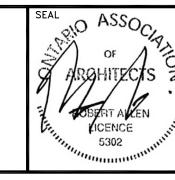
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DRAWING TITLE

MILLWORK DRAWINGS
SCALE

AS NOTED

JANUARY 24, 2022

PROJECT NUMBER

DRAWING NUMBER

A90'



6 SOUTH STREETSCAPE



5 SOUTH ENTRY





3 DELI CAFE 2



2 DELI CAFE 1



1 PRODUCE DISPLAY

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12	_		

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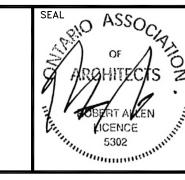
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PROJECT TITLE

NEW SAYERS FOOD STORE BURLEIGH STREET, APSLEY

DRAWING TITLE

RENDERINGS SCALE

AS NOTED

JANUARY 24, 2022

PROJECT NUMBER

2102
DRAWING NUMBER