# NEW SAYERS FOOD STORE APSLEY, ONTARIO

MACLENNAN JAUNKALNS MILLER ARCHITECTS
TRITON ENGINEERING SERVICES LTD, CIVIL ENGINEERS
BLACKWELL STRUCTURAL ENGINEERS
SMITH AND ANDERSEN, MECHANICAL AND ELECTRICAL ENGINEERS



# ISSUED FOR CONSTRUCTION - JULY 15, 2022

# CIVIL C-01 CONSTRUCTION GRADING & SERVICING PLAN C-02 NOTES AND DETAILS C-03 STANDARDS C-04 STANDARDS C-05 STANDARDS

#### **ARCHITECTURAL**

A000	COVER SHEET
A001	SITE SURVEY
A002	SITE PLAN
A003	LOADING STUDY
A004	EX FOUNDATION REMOVAL SITE PLAN
A005	SITE PLAN DETAILS 1
A006	SITE PLAN DETAILS 2

A007 SITE PLAN DETAILS 3
A008 SITE PLAN DETAILS 4
A010 OBC MATRIX

A011 LIFE SAFETY & CODE

A020 ASSEMBLIES & FLOOR TYPES

A021 OUTLINE SPECIFICATION

A022 SUBMITTALS

A100 GROUND LEVEL FLOOR PLAN
A101 LEVEL 2 FLOOR PLAN

A120 GROUND LEVEL SETOUT PLAN

N102 ROOF PLAN

A150 REFLECTED CEILING PLAN

A151 LEVEL 2 REFLECTED CEILING PLAN
A200 BUILDING ELEVATIONS

A300 BUILDING SECTIONS

A310 WALL SECTIONS EAST & SOUTH FACADES

A311 WALL SECTIONS NORTH & WEST FACADES

A312 WALL SECTIONS
A320 SECTION DETAILS

A321 SECTION DETAILS

A322 SECTION DETAILS

A400 UNIVERSAL WC - ENLARGED PLANS

A450 EQUIPMENT FLOOR PLANS

A451 EQUIPMENT SCHEDULE

A452 EQUIPMENT SCHEDULE
A500 INTERIOR ELEVATIONS
A501 INTERIOR ELEVATIONS

A510 INTERIOR WALL SECTIONS

A600 STAIR DRAWINGS

A700 DOOR SCHEDULE AND DETAILS

A710 EXTERIOR & INTERIOR SCREEN SCHEDULES

A800 FINISH FLOOR PLANS AND SCHEDULE

A900 MILLWORK DRAWINGS
A901 MILLWORK DRAWINGS

Δ070 RENDERING

#### **STRUCTURAL**

**GENERAL NOTES** TYPICAL DETAILS TYPICAL DETAILS TYPICAL DETAILS FOUNDATION PLAN SECOND & LOW ROOF FRAMING PLAN HIGH ROOF FRAMING PLAN WIND UPLIFT DIAGRAMS SHEAR FORCE DIAGRAMS **COLUMN SCHEDULE** FRAMING ELEVATIONS FRAMING ELEVATIONS **BUILDING SECTIONS BUILDING SECTIONS BUILDING SECTIONS DETAILED SECTIONS DETAILED SECTIONS DETAILED SECTIONS** 

**DETAILED SECTIONS** 

#### **MECHANICAL**

INICOLI	ANICAL
M000	DRAWING LIST AND LEGEND
M001	MECHANICAL STANDARD DETAILS
M002	MECHANICAL STANDARD DETAILS
M003	MECHANICAL STANDARD DETAILS
M004	MECHANICAL STANDARD DETAILS
M005	MECHANICAL STANDARD DETAILS
M100	SITE PLAN MECHANICAL
M200	MECHANICAL SCHEMATICS
M201	PLUMBING SCHEMATICS
M300	FOUNDATION PLAN PLUMBING AND DRAINAGE

1300 FOUNDATION PLAN PLUMBING AND DRAINAGE 1301 GROUND FLOOR PLAN PLUMBING AND DRAINAGE 1302 SECOND FLOOR PLAN PLUMBING AND DRAINAGE

M303 ROOF PLAN PLUMBING AND DRAINAGE

M401 GROUND FLOOR PLAN HVAC M402 SECOND FLOOR PLAN HVAC

1403 ROOF PLAN HVAC 1501 GROUND FLOOR PLAN KITCHEN PLUMBING AND DRAINAGE

M502 GROUND FLOOR PLAN KITCHEN HVAC

#### **ELECTRICAL**

E000 DRAWING LIST AND LEGEND

E001 LEGEND

E002 ELECTRICAL DETAILS

E003 ELECTRICAL DETAILS
E004 ELECTRICAL DETAILS

E100 SITE PLAN - ELECTRICAL

E200 SINGLE LINE DIAGRAM

E300 GROUND LEVEL - POWER AND SYSTEMS
E301 SECOND LEVEL - POWER AND SYSTEMS

E302 ROOF - POWER AND SYSTEMS

E400 GROUND LEVEL - LIGHTING E401 SECOND LEVEL - LIGHTING

E500 ENLARGED PLAN

Contractor must check and verify all dimensions on the job, and report any discrepancies to the Architect before proceeding with the work.

REV	DESCRIPTION	DATE	В
KEV	DESCRIPTION	DATE	ы
1	REVISED SPA	210809	AE
2	ISSUED FOR TENDER	210824	AB
3	REVISION TO BUILDING PERMIT	220315	AB
4	SI-01	220615	AB
5	BLG SET-OUT CAD	220715	AB
6	ISSUED FOR CONSTRUCTION	220715	AB
7			
8			

# MJMA

maclennan jaunkalns miller architect:

toronto ontario m5v 3c1
416 593 6796
www.mjmarchitects.com

#### TRITON ENGINEERING SERVICES LTD

229 BROADWAY, UNIT 1
ORANGEVILLE, ONTARIO, L9W 1K4
TEL 519 941 0330 FAX 519 941 0

TEL 519 941 0330 FAX 519 941 1830 BLACKWELL

134 PETER STREET, SUITE 1301
TORONTO, ONTARIO, M5V 2H2
TEL 416.593.5300 FAX 416.593.4840


SMITH + ANDERSON MECHANICAL AND ELECTRICAL ENGINEERS

1100 - 100 SHEPPARD AVENUE EAST TORONTO, ONTARIO, M2N 6N5 TEL 416.487.8151 -

#### SAYERS FOOD LIMITED

132 BURLEIGH STREET t: 705.656.4531 e: sayers@apsley.ca

NORTH ARRO

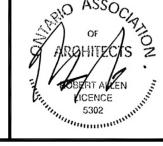

PROJECT TITLE

NEW SAYERS FOOD STORE BURLEIGH STREET, APSLEY


DRAWING TITLE

COVER SHEET

NTS

JULY 15, 2022

2102

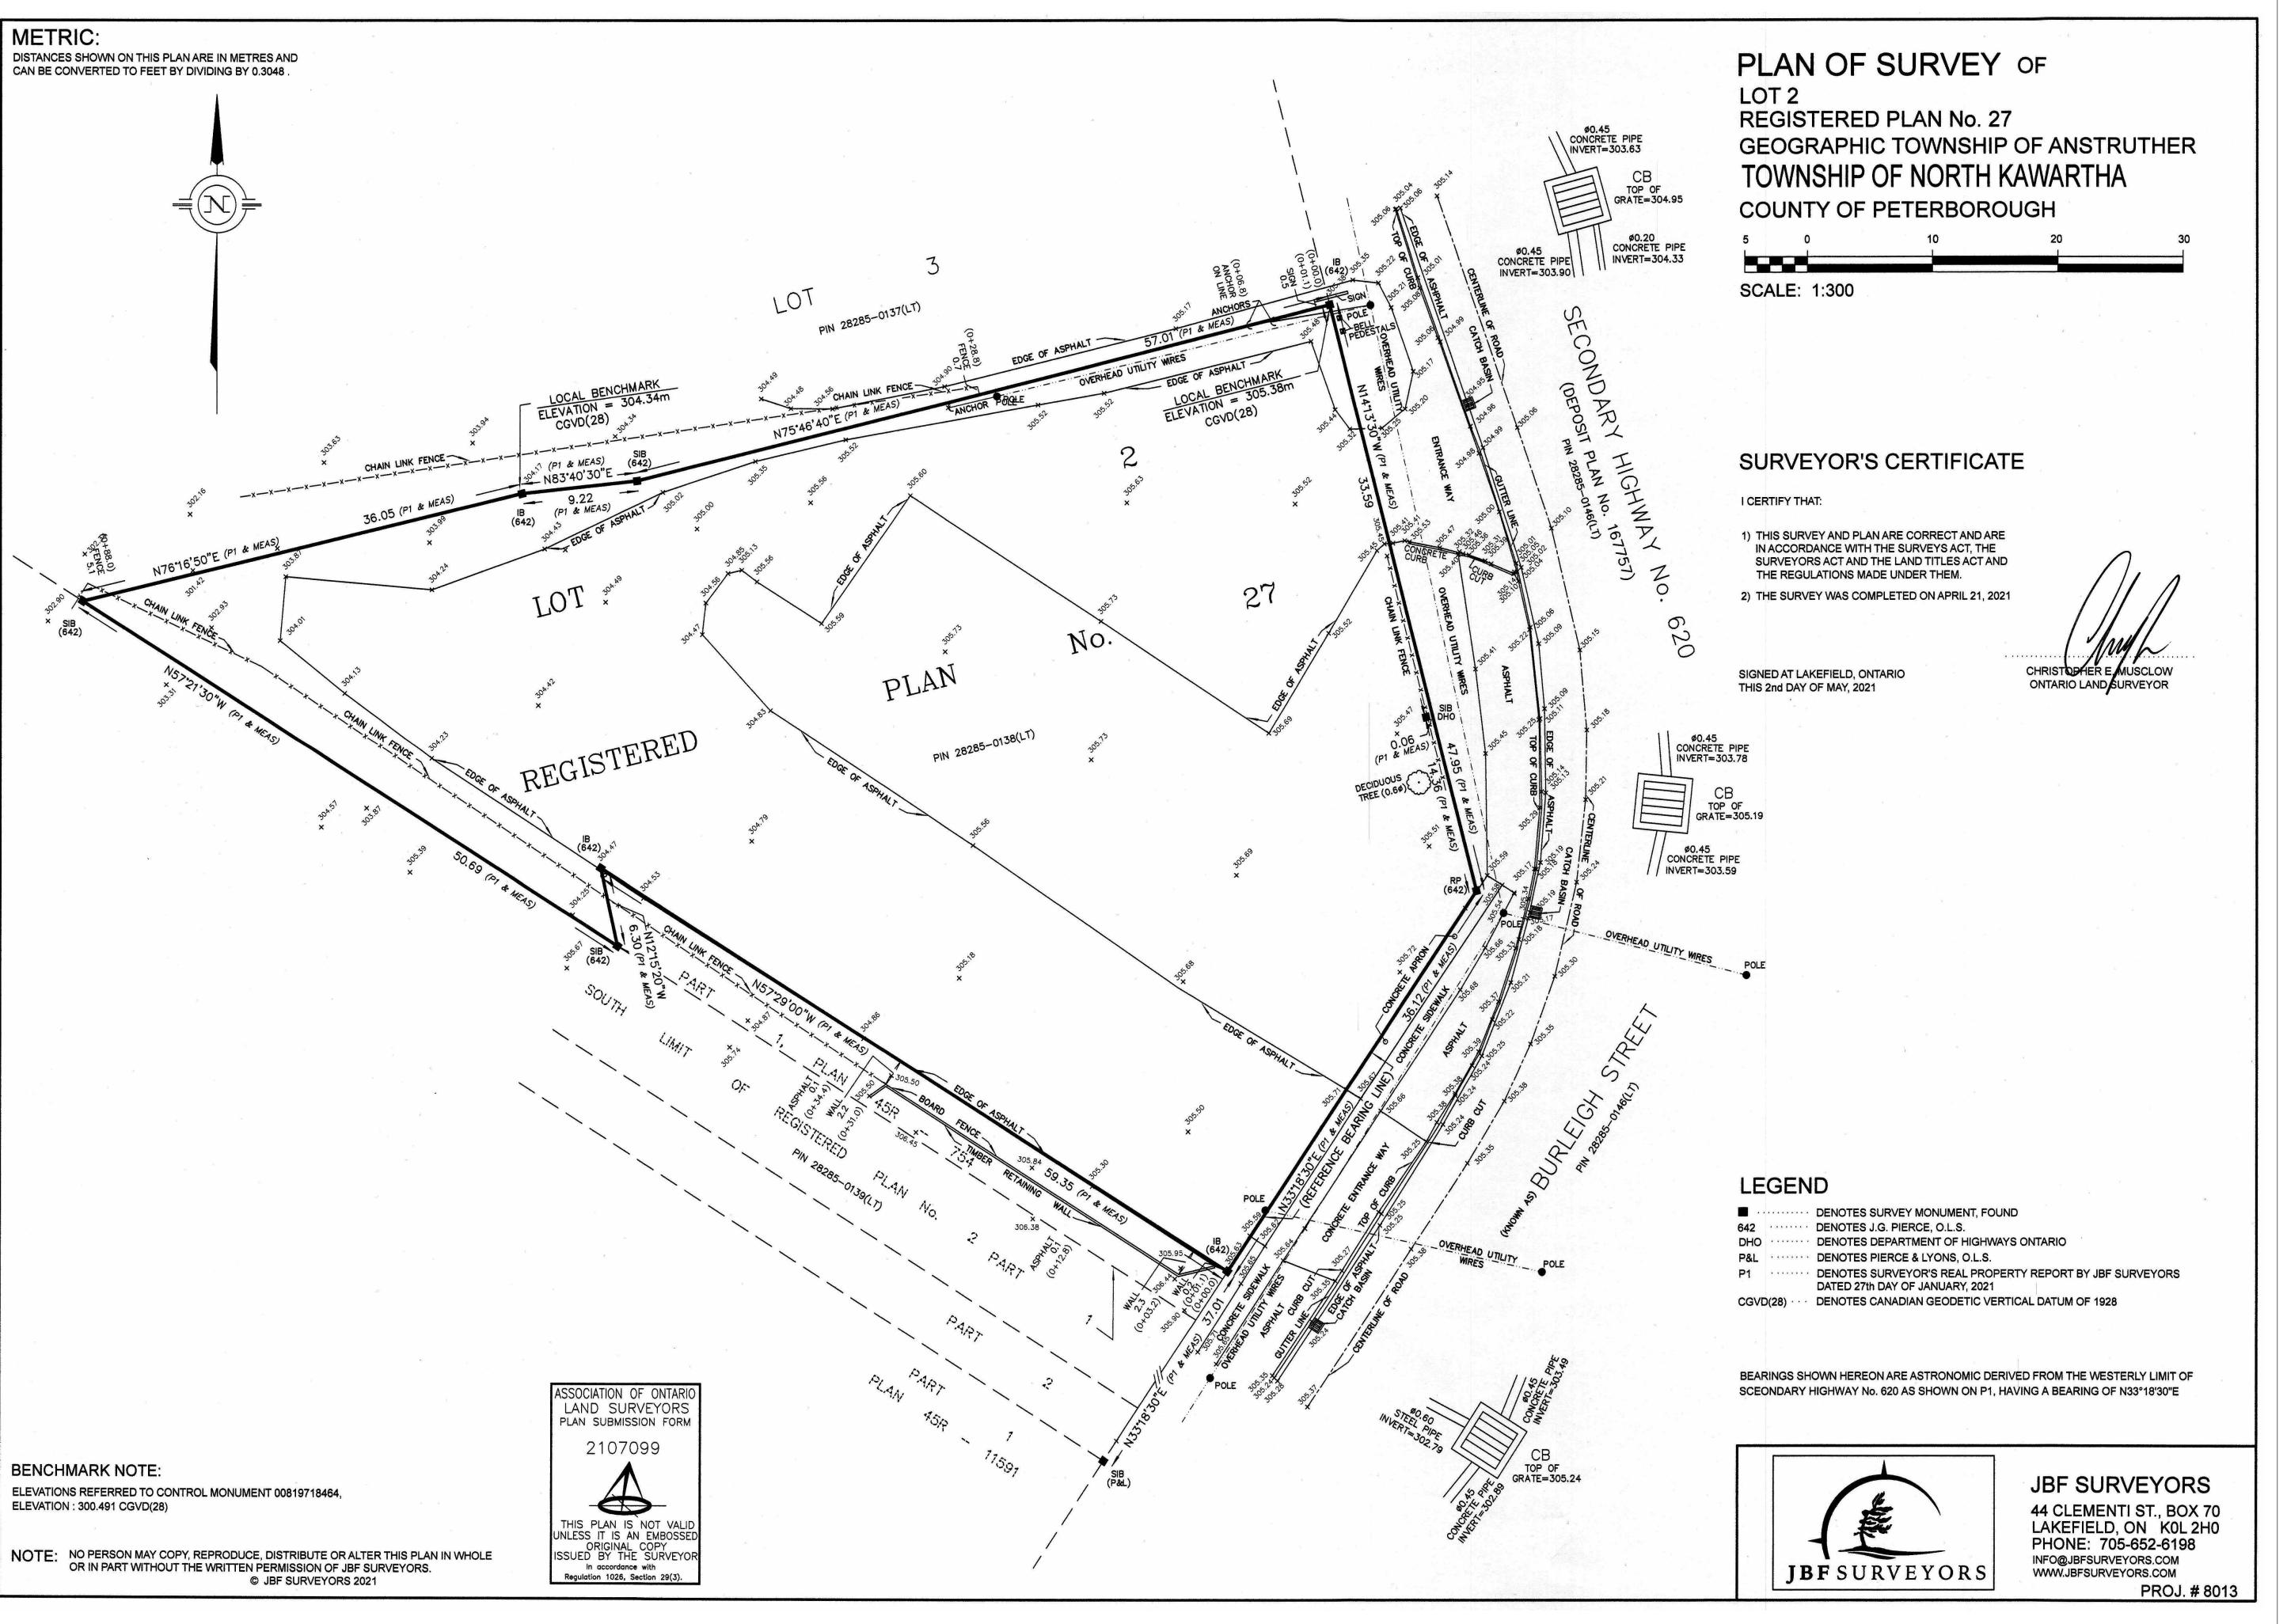

REVISIONS AND ISSUES

ΣV	DESCRIPTION	DATE	BY
	ISSUED FOR SPA	210618	AB
	REVISED SPA	210709	AB
	ISSUED FOR COSTING	210721	AB
	REVISED SPA	210809	AB
	ISSUED FOR TENDER	210824	AB
	REVISED TENDER	220124	AB
	REVISED BUILDING PERMIT	220124	AB

# **MJMA**

maclennan jaunkalns miller architects

425 adelaide street west level 6 toronto ontario m5v 3c1 416 593 6796

www.mjmarchitects.com

TRITON ENGINEERING SERVICES LTD

229 BROADWAY, UNIT 1
ORANGEVILLE, ONTARIO, L9W 1K4
TEL 519 941 0330 FAX 519 941 1830

OKWELL

BLACKWELL STRUCTURAL ENGINEERS

134 PETER STREET, SUITE 1301 TORONTO, ONTARIO, M5V 2H2 TEL 416.593.5300 FAX 416.593.4840

SMITH + ANDERSON MECHANICAL AND ELECTRICAL ENGINEERS

1100 - 100 SHEPPARD AVENUE EAST TORONTO, ONTARIO, M2N 6N5 TEL 416.487.8151 -

SAYERS FOOD LIMITED

132 BURLEIGH STREET t: 705.656.4531 e: sayers@apsley.ca

ARROW

PROJECT TITLE

NEW SAYERS FOOD STORE BURLEIGH STREET, APSLEY

DRAWING TITLE


SITE SURVEY

ITS

JANUARY 24, 2022

PROJECT NUMBER 2102

DRAWING NUMBER

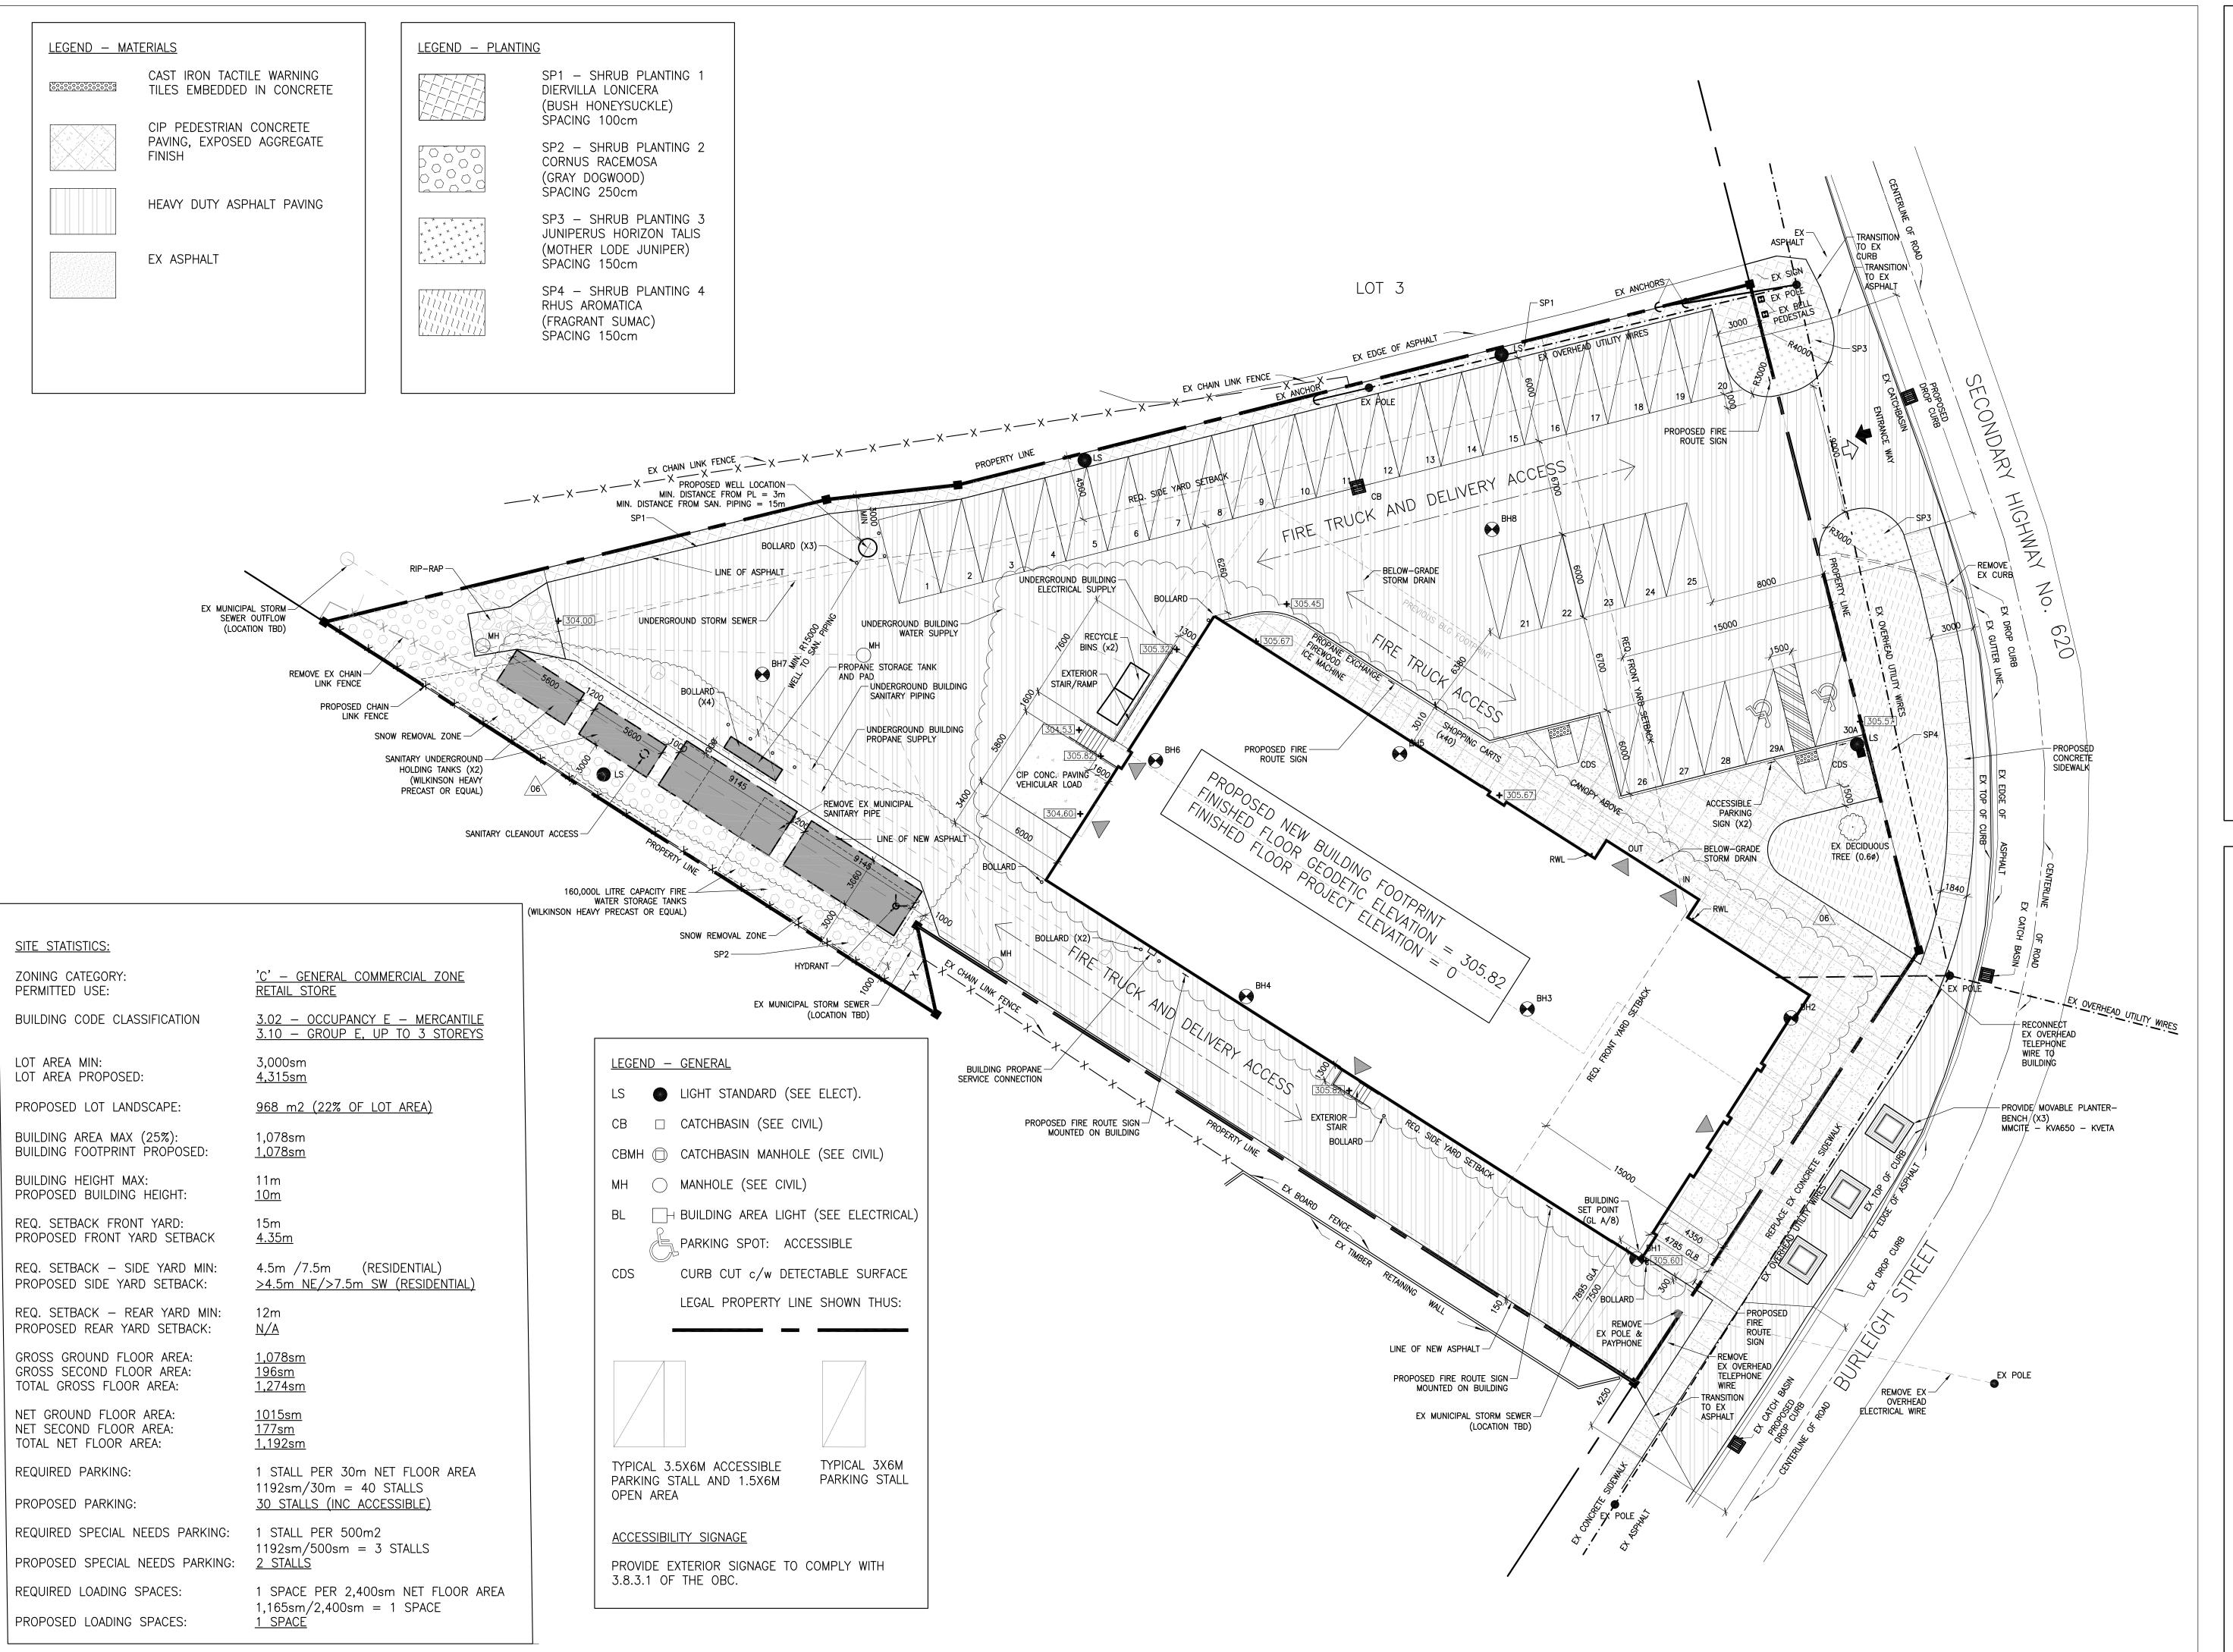

#### REVISIONS AND ISSUES

EV	DESCRIPTION	DATE	BY
	REVISED SPA	210809	AB
!	ISSUED FOR TENDER	210824	AB
3	REVISION TO BUILDING PERMIT	220315	AB
-	SI-01	220615	AB
5	BLG SET-OUT CAD	220715	AB
5	ISSUED FOR CONSTRUCTION	220715	AB
,			

# **MJMA**

maclennan jaunkalns miller architects

425 adelaide street west level 6 toronto ontario m5v 3c1 416 593 6796 www.mjmarchitects.com

#### TRITON ENGINEERING SERVICES LTD

229 BROADWAY, UNIT 1
ORANGEVILLE, ONTARIO, L9W 1K4

TEL 519 941 0330 FAX 519 941 1830

#### BLACKWELL STRUCTURAL ENGINEERS

134 PETER STREET, SUITE 1301
TORONTO, ONTARIO, M5V 2H2
TEL 416.593.5300 FAX 416.593.4840

#### SMITH + ANDERSON


MECHANICAL AND ELECTRICAL ENGINEERS


1100 - 100 SHEPPARD AVENUE EAST

TORONTO, ONTARIO, M2N 6N5
TEL 416.487.8151

## SAYERS FOOD LIMITED

132 BURLEIGH STREET t: 705.656.4531 e: sayers@apsley.ca

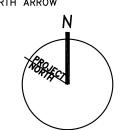

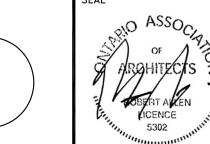

OJECT TITLE

NEW SAYERS FOOD STORE BURLEIGH STREET, APSLEY

DRAWING TITLE

SITE PLAN


SCALE

1:200

JULY 15, 2022

PROJECT NUMBER

2102
DRAWING NUMBER

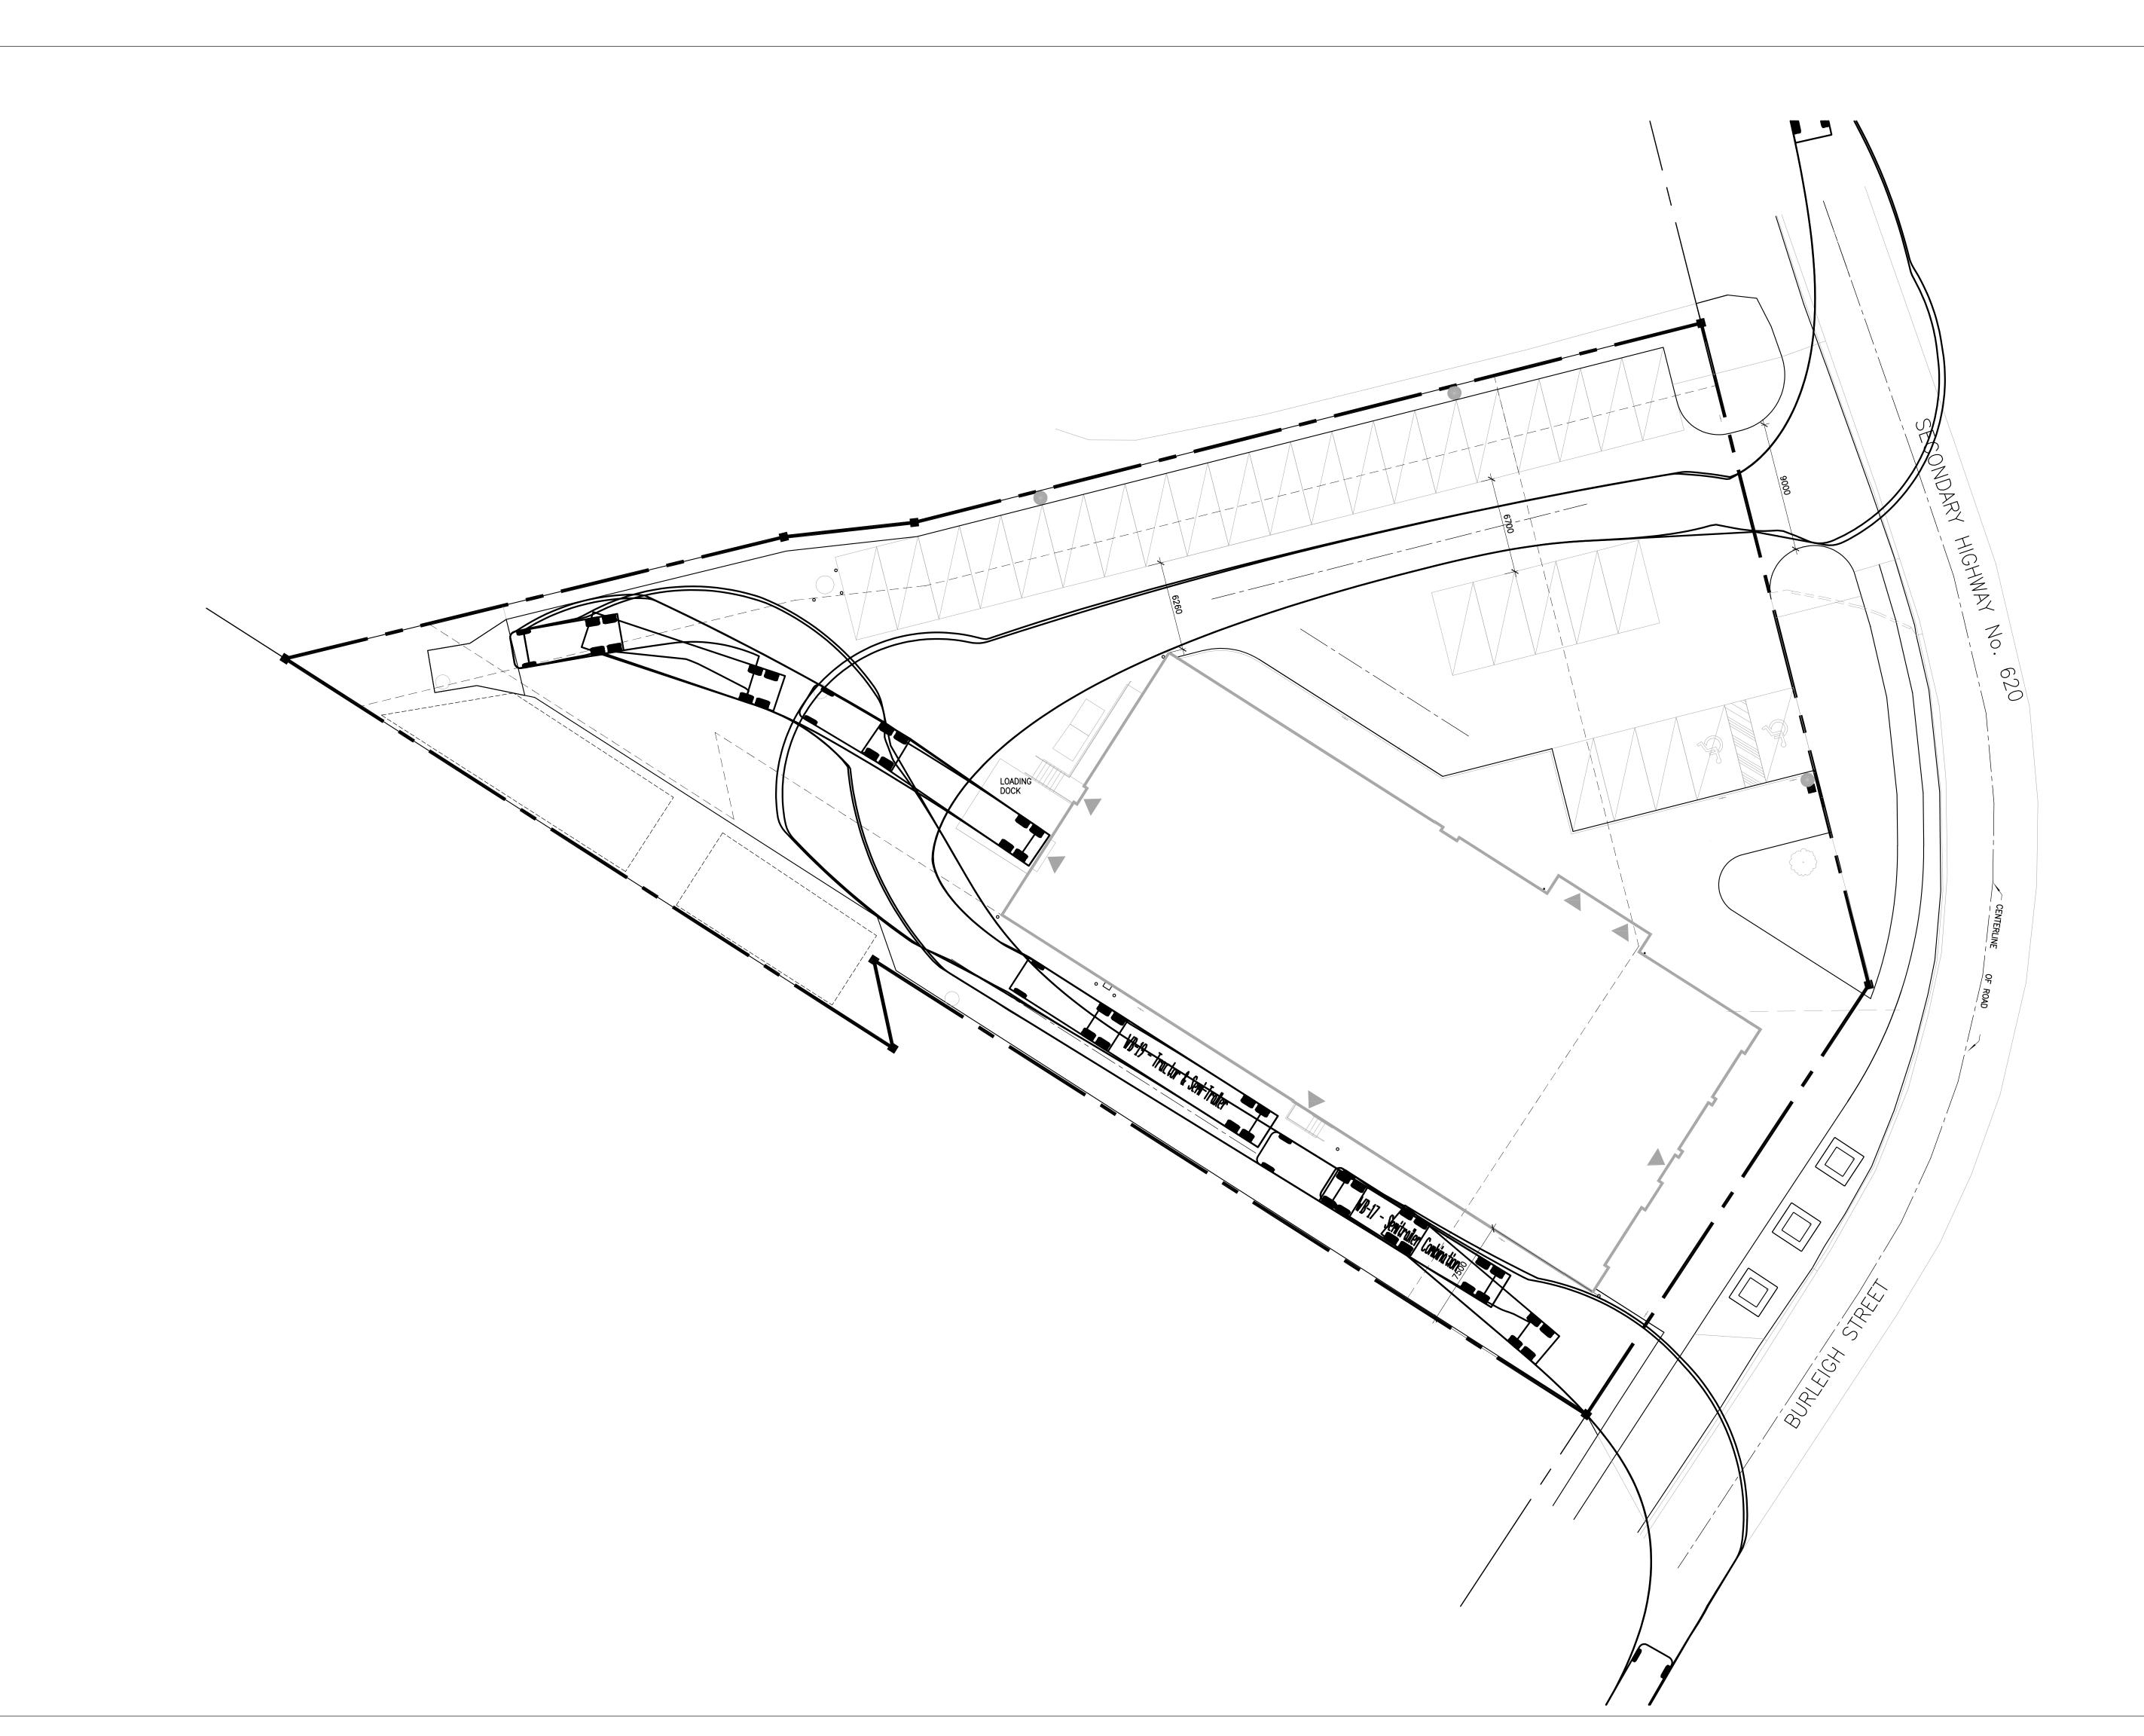

REVISIONS AND ISSUES

REV	DESCRIPTION	DATE	BA
1	REVISED SPA	210809	AE
2	ISSUED FOR TENDER	210824	AE
3	REVISION TO BUILDING PERMIT	220315	AE
4	SI-01	220615	AE
5	BLG SET-OUT CAD	220715	AE
6	ISSUED FOR CONSTRUCTION	220715	AE

# **MJMA**

maclennan jaunkalns miller architects

425 adelaide street west level 6 toronto ontario m5v 3c1 416 593 6796 www.mjmarchitects.com

# TRITON ENGINEERING SERVICES LTD CIVIL ENGINEERS

229 BROADWAY, UNIT 1
ORANGEVILLE, ONTARIO, L9W 1K4
TEL 519 941 0330 FAX 519 941 1830

BLACKWELL STRUCTURAL ENGINEERS


134 PETER STREET, SUITE 1301
TORONTO, ONTARIO, M5V 2H2
TEL 416.593.5300 FAX 416.593.4840

SMITH + ANDERSON
MECHANICAL AND ELECTRICAL ENGINEERS

1100 — 100 SHEPPARD AVENUE EAST TORONTO, ONTARIO, M2N 6N5 TEL 416.487.8151 —

# SAYERS FOOD LIMITED

132 BURLEIGH STREET t: 705.656.4531 e: sayers@apsley.ca

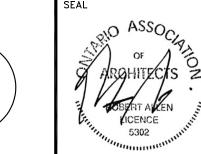

NEW SAYERS FOOD STORE BURLEIGH STREET, APSLEY


LOADING STUDY PLAN

scale 1:200

JULY 15, 2022

PROJECT NUMBER 2102

DRAWING NUMBER

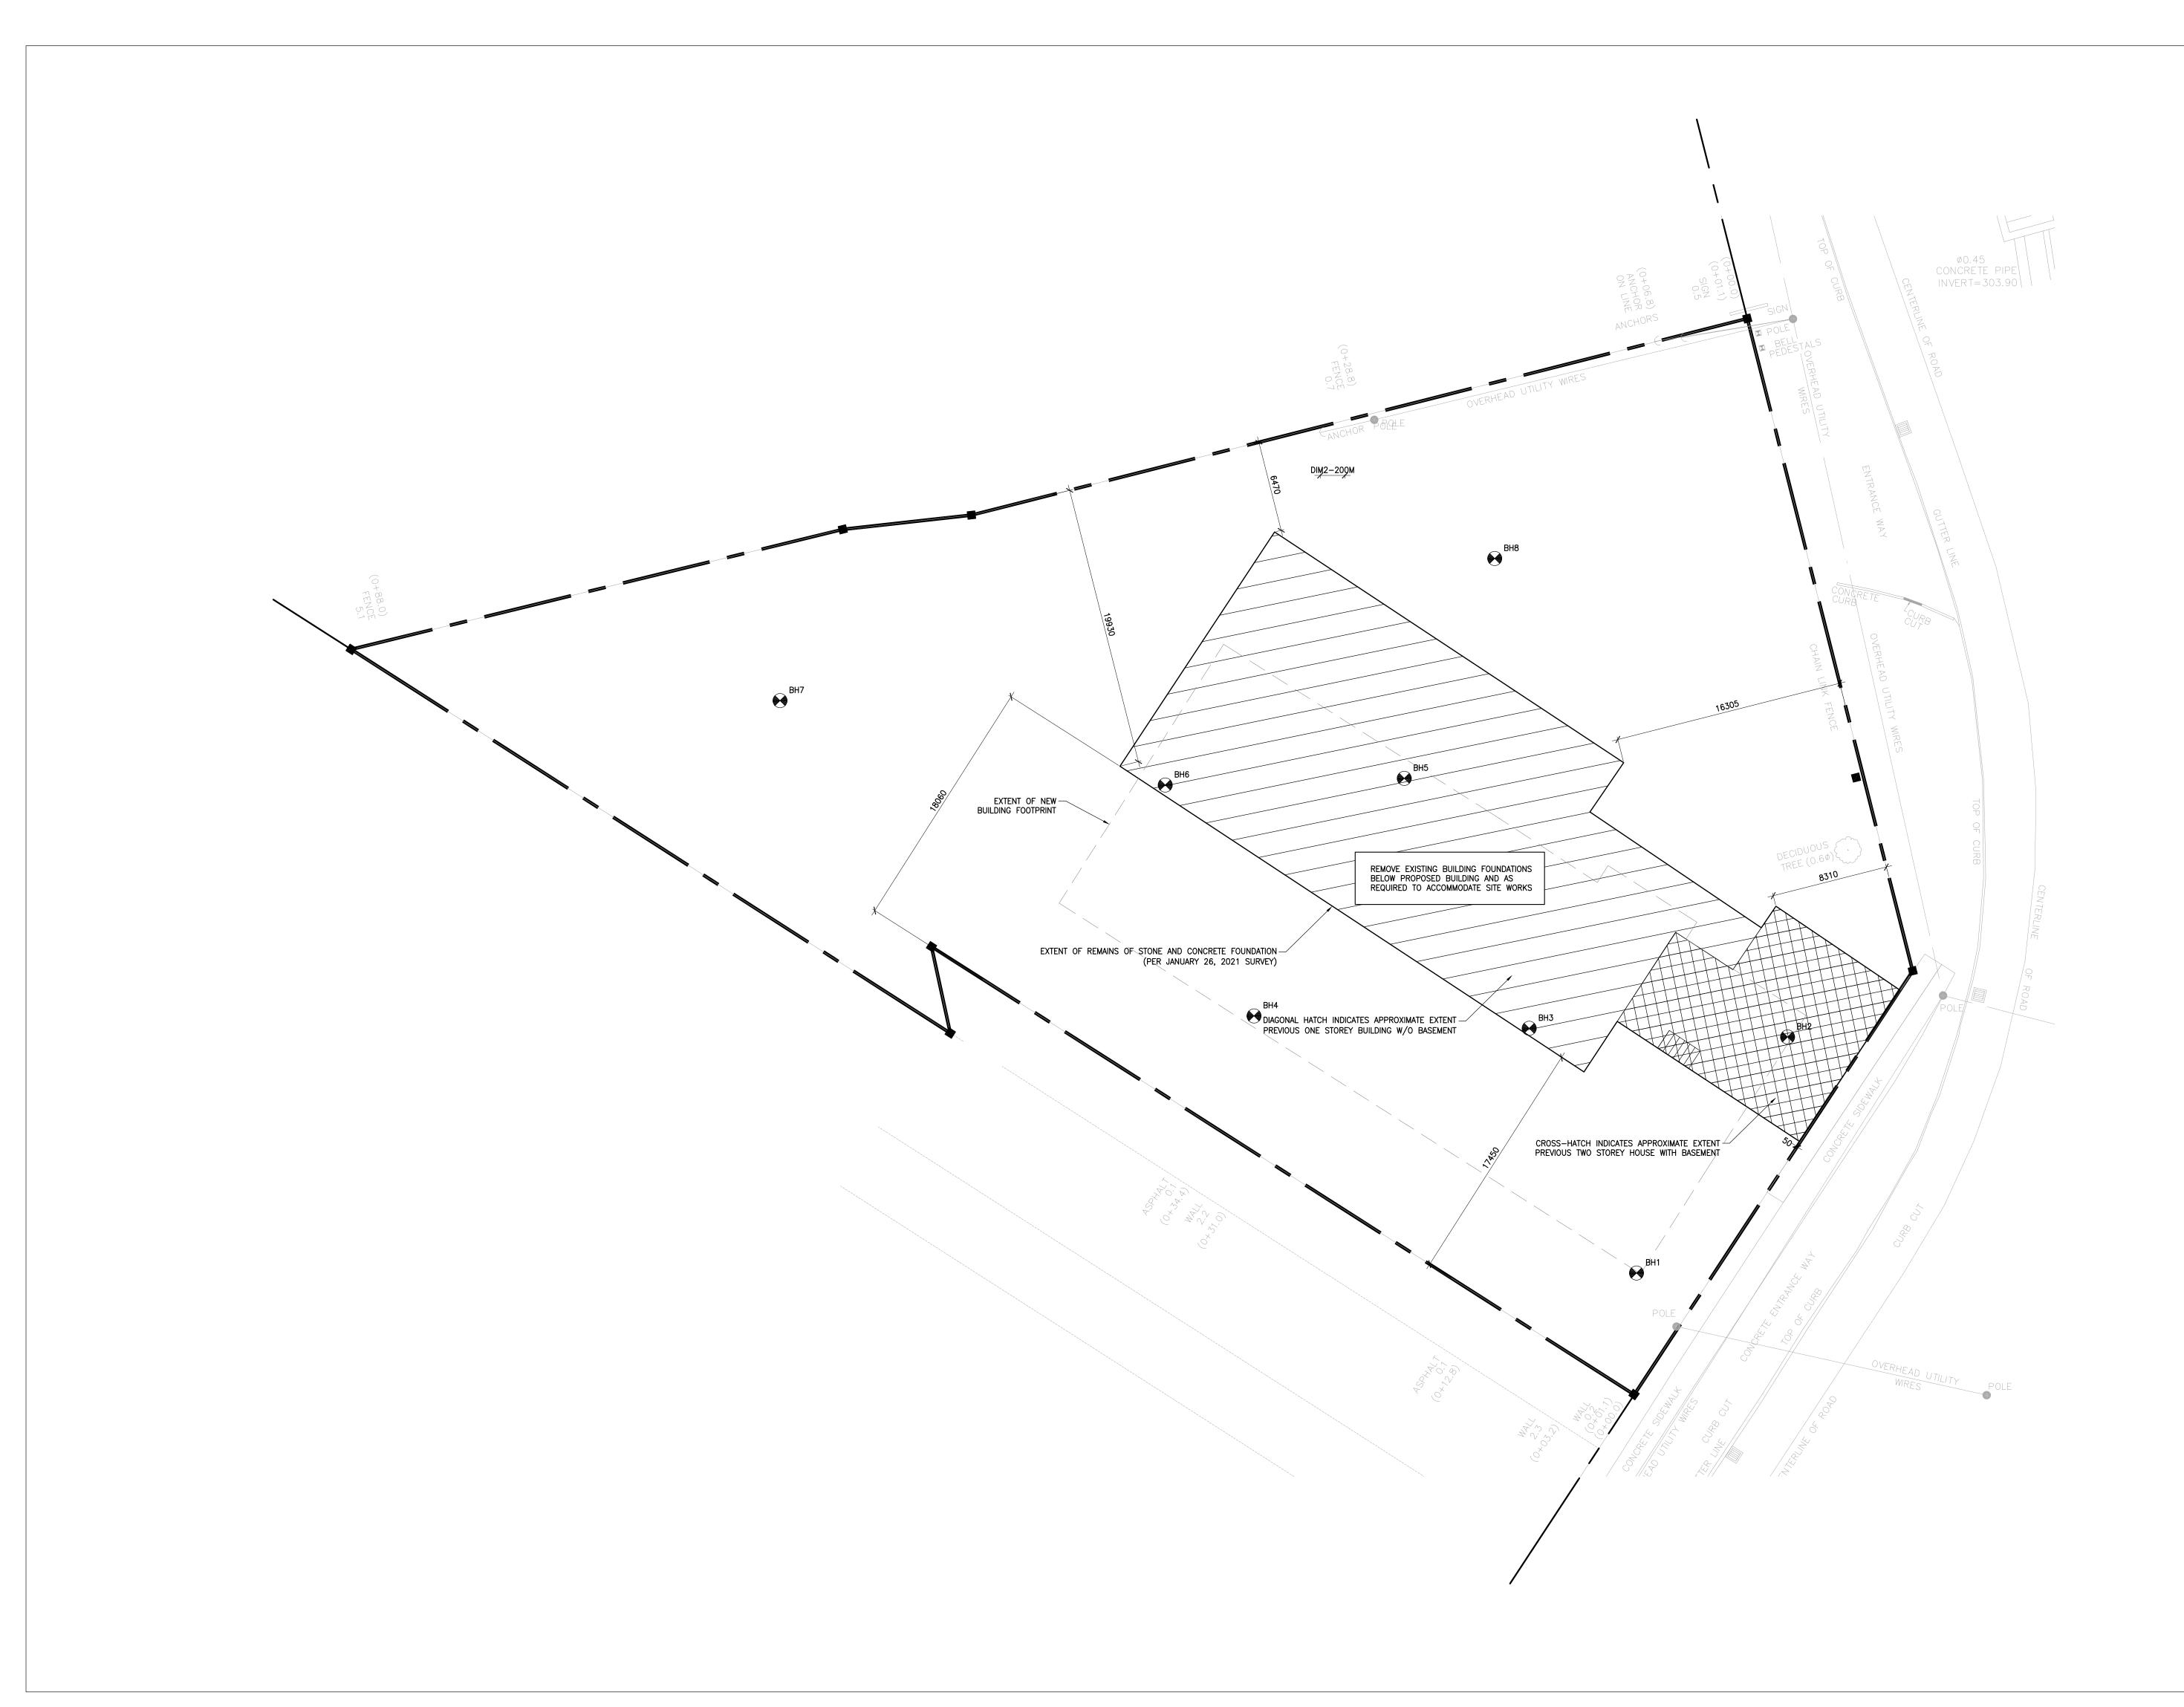

REVISIONS AND ISSUES

REV DESCRIPTION DATE

1 REVISED SPA 210809

2 ISSUED FOR TENDER 210824

 3
 REVISION TO BUILDING PERMIT
 220315

 4
 SI-01
 220615

 5
 BLG SET-OUT CAD
 220715

 6
 ISSUED FOR CONSTRUCTION
 220715

9

MJMA

maclennan jaunkalns miller architects

425 adelaide street west level 6 toronto ontario m5v 3c1 416 593 6796 www.mjmarchitects.com

TRITON ENGINEERING SERVICES LTD CIVIL ENGINEERS

229 BROADWAY, UNIT 1
ORANGEVILLE, ONTARIO, L9W 1K4
TEL 519 941 0330 FAX 519 941 1830

BLACKWELL STRUCTURAL ENGINEERS

134 PETER STREET, SUITE 1301 TORONTO, ONTARIO, M5V 2H2 TEL 416.593.5300 FAX 416.593.4840


SMITH + ANDERSON
MECHANICAL AND ELECTRICAL ENGINEERS

1100 — 100 SHEPPARD AVENUE EAST TORONTO, ONTARIO, M2N 6N5 TEL 416.487.8151 —

## SAYERS FOOD LIMITED

132 BURLEIGH STREET t: 705.656.4531 e: sayers@apsley.ca

NORTH ARROW

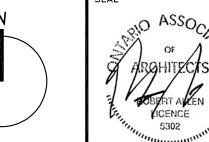

PROJECT TITLE

NEW SAYERS FOOD STORE BURLEIGH STREET, APSLEY

DRAWING TITLE

EX FOUNDATION REMOVAL SITE PLAN


scale 1:200

JULY 15, 2022


PROJECT NUMBER

2102
DRAWING NUMBER

 $\Delta \cap \cap \angle$ 

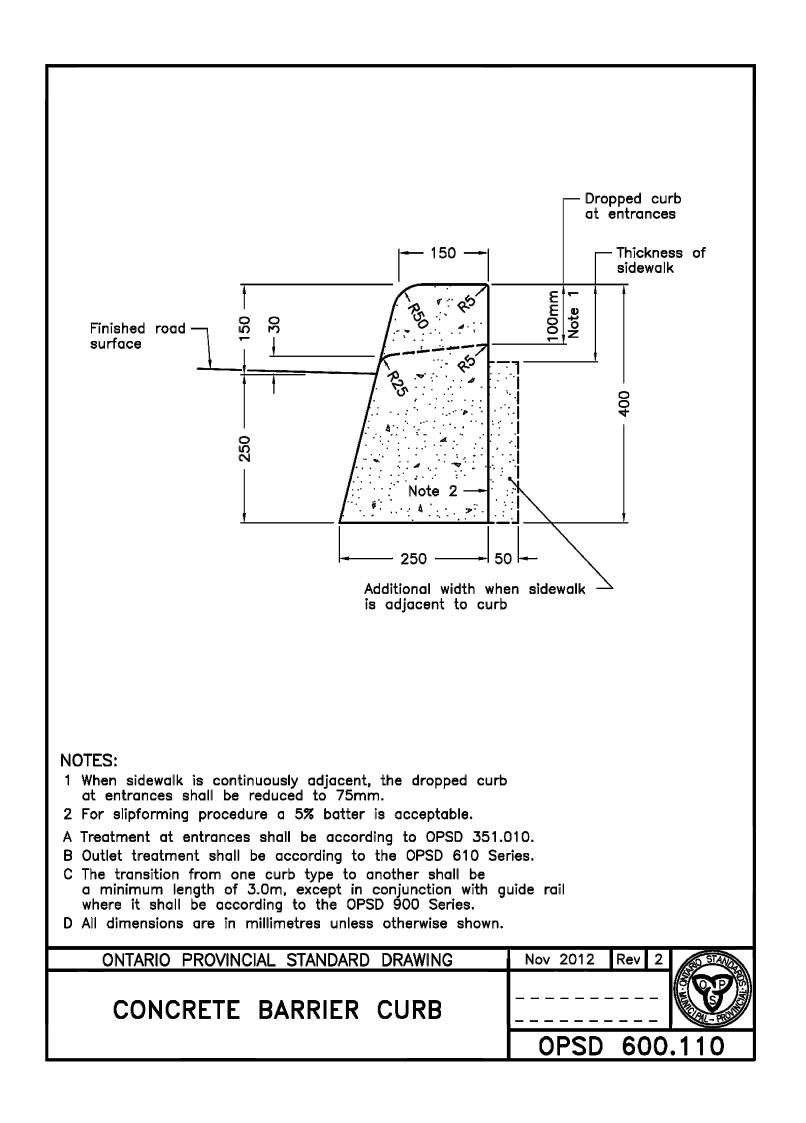


CONCRETE BARRIER CURB

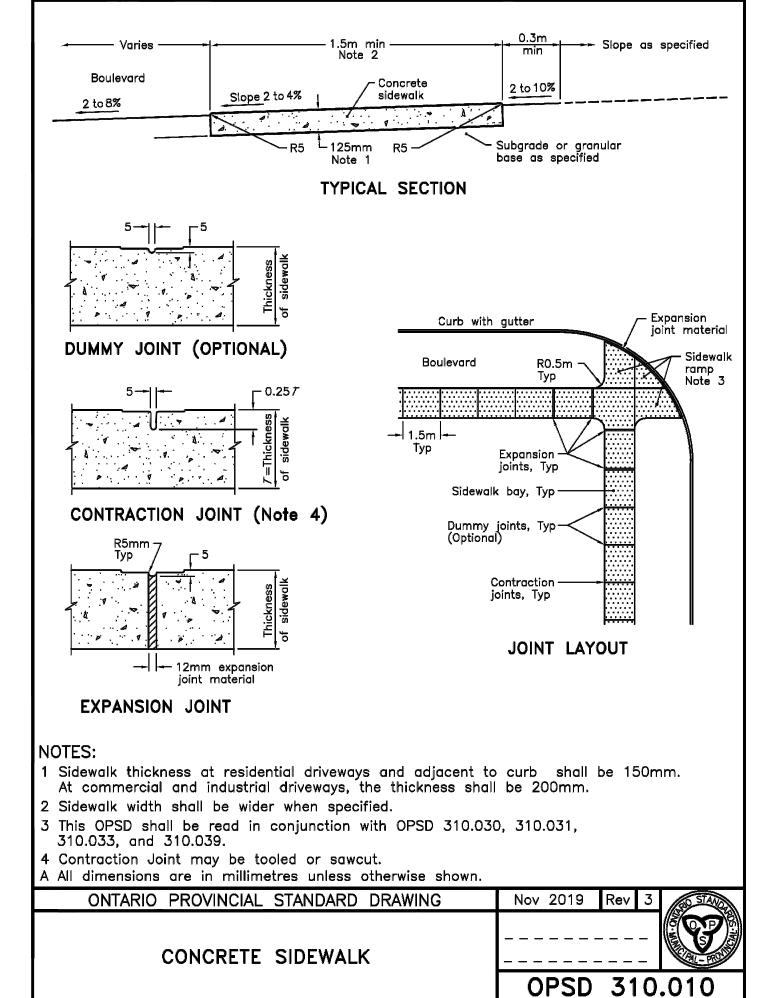

CONCRETE SIDEWALK RAMP

**RAMP ELEVATION** 

1. CONCRETE PAVING BASE TO BE PROVIDED SLOPE TOWARD SUBDRAIN; REFER TO CIVIL DRAWINGS FOR GRADING AND SUBDRAIN DETAILS.

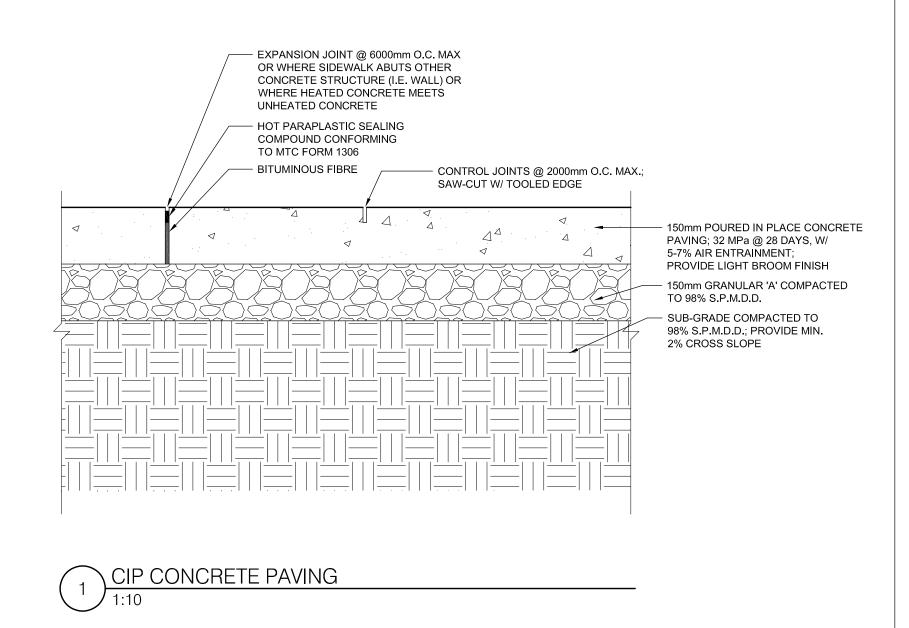


1. SLOPE OF RAMP SHALL NOT EXCEED 8%.
2. CROSS SLOPE OF RAMP SHALL NOT EXCEED 2% IN EITHER DIRECTION.
3. CROSS SLOPE OF FLARED SIDE OF RAMP SHALL NOT EXCEED 10%. 4. DROPPED CURB AT RAMP SHALL BE MODIFIED TO ELIMINATE 30mm STEP AT GUTTER LINE.
5. MINIMUM THICKNESS OF RAMP IS 200mm. MINIMUM THICKNESS OF SIDEWALK AND FLARE SIDES ADJACENT

TO RAMP IS 150mm.

-BACK OF SIDEWALK -EXPANSION JOINT, TYP. THE PLATES SHALL EXTEND THE ENTIRE WIDTH OF THE SIDEWALK RAMP AT A MINIMUM LENGTH OF 610mm, IN ACCORDANCE WITH OPSD 310.039

RAMP PLAN

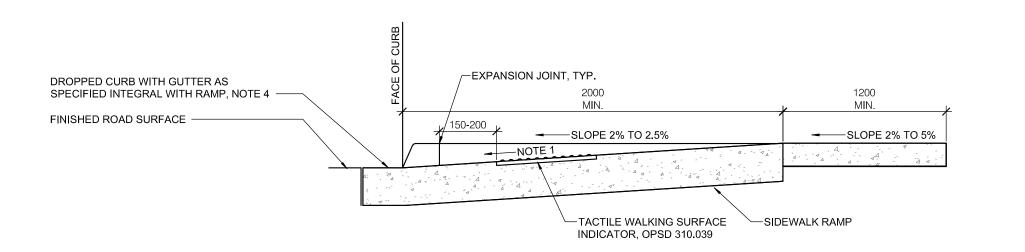

RAMP SECTION

SAYERS FOOD LIMITED

Contractor must check and verify all dimensions on the job, and report any discrepancies to the Architect before proceeding with the work.

REVISION TO BUILDING PERMIT 220315

210809

210824

220615

220715

220715

Do not scale this drawing.

REVISIONS AND ISSUES

DESCRIPTION

REVISED SPA

SI-01

**MJMA** 

425 adelaide street west level 6

toronto ontario m5v 3c1 416 593 6796

www.mjmarchitects.com

CIVIL ENGINEERS 229 BROADWAY, UNIT 1

BLACKWELL STRUCTURAL ENGINEERS

maclennan jaunkalns miller architects

TRITON ENGINEERING SERVICES LTD

ORANGEVILLE, ONTARIO, L9W 1K4
TEL 519 941 0330 FAX 519 941 1830

TORONTO, ONTARIO, M5V 2H2
TEL 416.593.5300 FAX 416.593.4840

MECHANICAL AND ELECTRICAL ENGINEERS

1100 - 100 SHEPPARD AVENUE EAST

134 PETER STREET, SUITE 1301

SMITH + ANDERSON

TORONTO, ONTARIO, M2N 6N5

TEL 416.487.8151 -

ISSUED FOR TENDER

BLG SET-OUT CAD

ISSUED FOR CONSTRUCTION

132 BURLEIGH STREET t: 705.656.4531 e: sayers@apsley.ca

NEW SAYERS FOOD STORE BURLEIGH STREET, APSLEY

DRAWING TITLE SITE PLAN

DETAILS 1 SCALE

AS NOTED

JULY 15, 2022


PROJECT NUMBER

DRAWING NUMBER

CONCRETE SIDEWALK


1. THE SHAPE, COLOUR, HEIGHT AND LOCATION OF SIGNS SHALL BE IN ACCORDANCE WITH THE ONTARIO TRAFFIC MANUAL AS PUBLISHED BY THE MINISTRY OF TRANSPORTATION. 2. ALL SIGNS SHALL BE MANUFACTURED USING "HIGH INTENSITY" SHEETING

CONFORMING TO ASTM D4956-90 TYPE III OR TYPE IV MATERIAL. 3. CONTRACTOR TO SUBMIT DETAILED SHOP DRAWINGS WITH LICENSED ENGINEER'S STAMP FOR REVIEW AND APPROVAL.

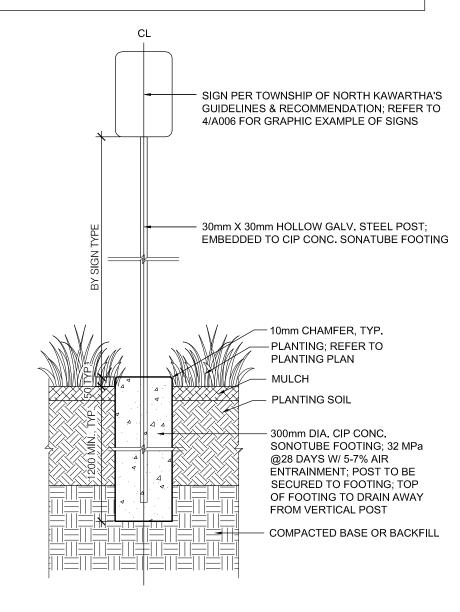

1. THE SHAPE, COLOUR, HEIGHT AND LOCATION OF SIGNS SHALL BE IN ACCORDANCE WITH THE ONTARIO TRAFFIC MANUAL AS PUBLISHED BY THE MINISTRY OF TRANSPORTATION.

2. ALL SIGNS SHALL BE MANUFACTURED USING "HIGH INTENSITY" SHEETING CONFORMING TO ASTM D4956-90 TYPE III OR TYPE IV MATERIAL. 3. CONTRACTOR TO SUBMIT DETAILED SHOP DRAWINGS WITH LICENSED ENGINEER'S STAMP FOR REVIEW AND APPROVAL.

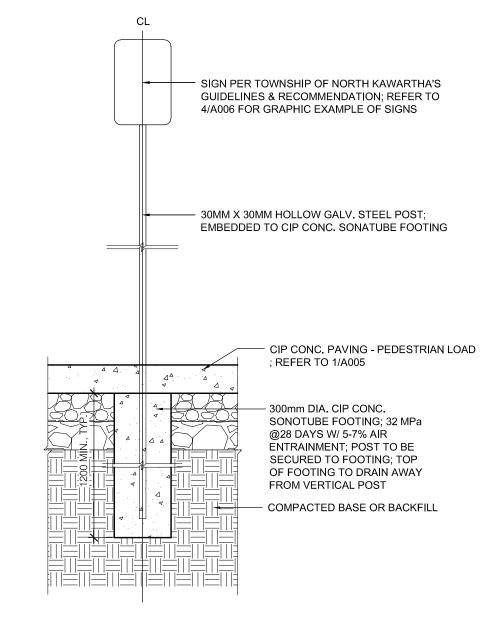






ROUTE

ACCESSIBLE PARKING 1200mm MOUNT HT 2200mm MOUNT HT


SIGN POST AT CIP CONCRETE PAVING

↑ GRAPHIC EXAMPLES OF SIGNS


1. TACTILE PLATE - MANUFACTURER: KINESIK - MODEL: 'ADVANTAGE CAST IRON' - COLOUR: DARK GRAY 2. TO BE INSTALLED PER MANUFACTURER'S SPECIFICATIONS. 3. CONTRACTOR TO SUBMIT DETAILED SHOP DRAWINGS WITH LICENSED ENGINEER'S STAMP FOR REVIEW AND APPROVAL.

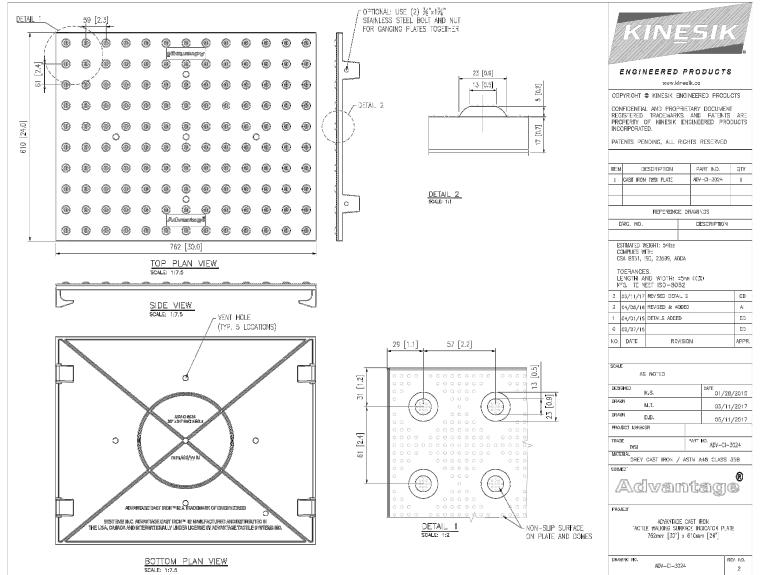

1. BOLLARD - MANUFACTURER: RELIANCE FOUNDRY
- MODEL: 'R-7307-EX' - FINISH: ANODIZED SILVER - MOUNTING: EMBEDDED; FILLED WITH CONC. - INSTALLATION: SET SCREW - ADD REFLECTIVE STRIP: COLOUR TO BE WHITE
2. CONTRACTOR TO SUBMIT DETAILED SHOP DRAWINGS WITH LICENSED ENGINEER'S STAMP FOR REVIEW AND APPROVAL.

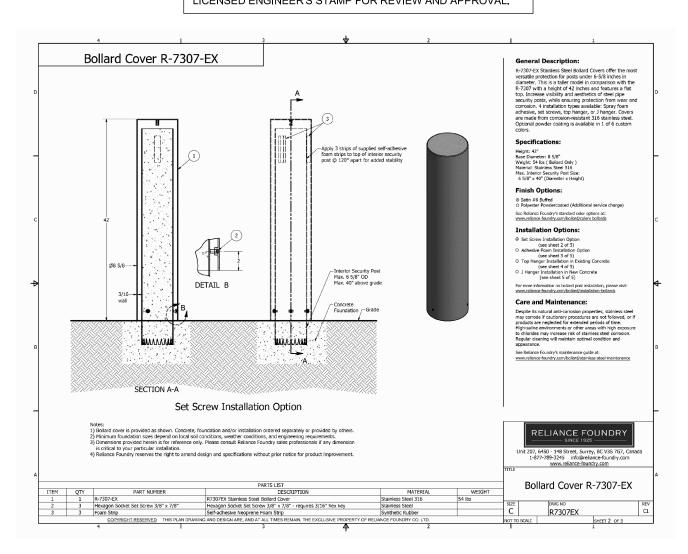

1. CONTRACTOR TO SUBMIT DETAILED SHOP DRAWINGS WITH LICENSED ENGINEER'S STAMP FOR REVIEW AND APPROVAL.

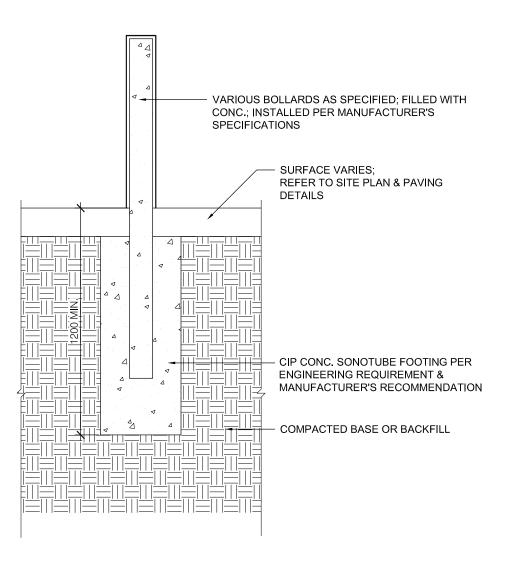

SAYERS FOOD LIMITED

Contractor must check and verify all dimensions on the job, and report any discrepancies to the Architect before proceeding with the work.

REVISION TO BUILDING PERMIT 220315

DATE

210809

210824

220615

220715

220715

Do not scale this drawing.

REVISIONS AND ISSUES

**MJMA** 

425 adelaide street west level 6

toronto ontario m5v 3c1 416 593 6796 www.mjmarchitects.com

CIVIL ENGINEERS

BLACKWELL

229 BROADWAY, UNIT 1

STRUCTURAL ENGINEERS

ORANGEVILLE, ONTARIO, L9W 1K4

134 PETER STREET, SUITE 1301

SMITH + ANDERSON MECHANICAL AND ELECTRICAL ENGINEERS

TORONTO, ONTARIO, M2N 6N5 TEL 416.487.8151 -

TEL 519 941 0330 FAX 519 941 1830

TORONTO, ONTARIO, M5V 2H2
TEL 416.593.5300 FAX 416.593.4840

1100 - 100 SHEPPARD AVENUE EAST

maclennan jaunkalns miller architects

TRITON ENGINEERING SERVICES LTD

DESCRIPTION

REVISED SPA


ISSUED FOR TENDER

BLG SET-OUT CAD

ISSUED FOR CONSTRUCTION

132 BURLEIGH STREET t: 705.656.4531 e: sayers@apsley.ca

NORTH ARROW

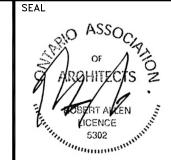

NEW SAYERS FOOD STORE BURLEIGH STREET, APSLEY

SITE PLAN DETAILS 2

AS NOTED


JULY 15, 2022

PROJECT NUMBER


DRAWING NUMBER

NOTES:

1.CONTRACTOR TO VERIFY DIMENSIONS ON SITE.
2. CONTRACTOR TO SUBMIT SHOP DRAWINGS FOR APPROVAL BY LANDSCAPE ARCHITECT PRIOR TO FABRICATION.
3. ALL POSTS AND RAILS SHALL BE GALVANIZED STEEL PIPE 'STANDARD WEIGHT', AND CONFORMING TO CURRENT SPECIFICATIONS DOE HOT DIPPED ZINC COATED (GALVANIZED) WELDED AND SEAMLESS PIPE FOR ORDINARY USES.
4. ALL FENCE COMPONENTS TO BE OF A SUITABLE ALUMINUM ALLY OR OF A STEEL DUCTILE IRON.
5. LINE POSTS SHALL BE SET AT 3.0m CENTRES.
6. BOTTOM RAIL AND FINISHED GRADE 38-75mm CLEARANCE MAX.

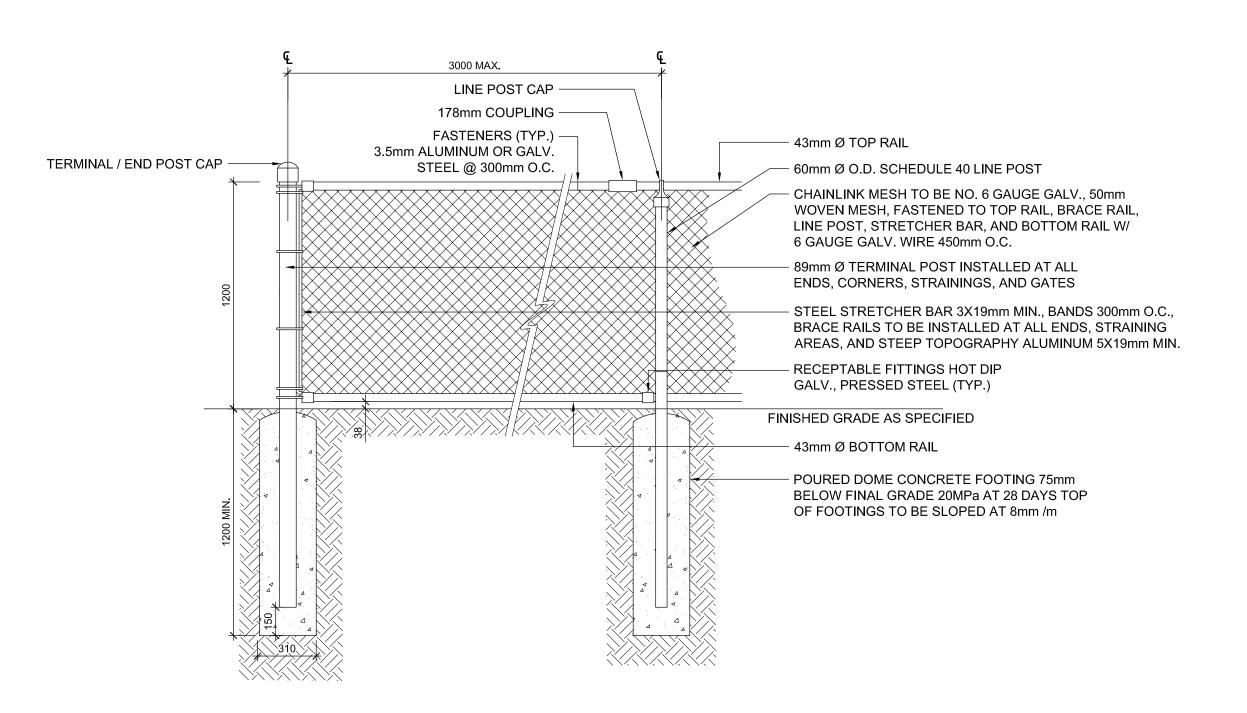

CHAIN LINK FENCE

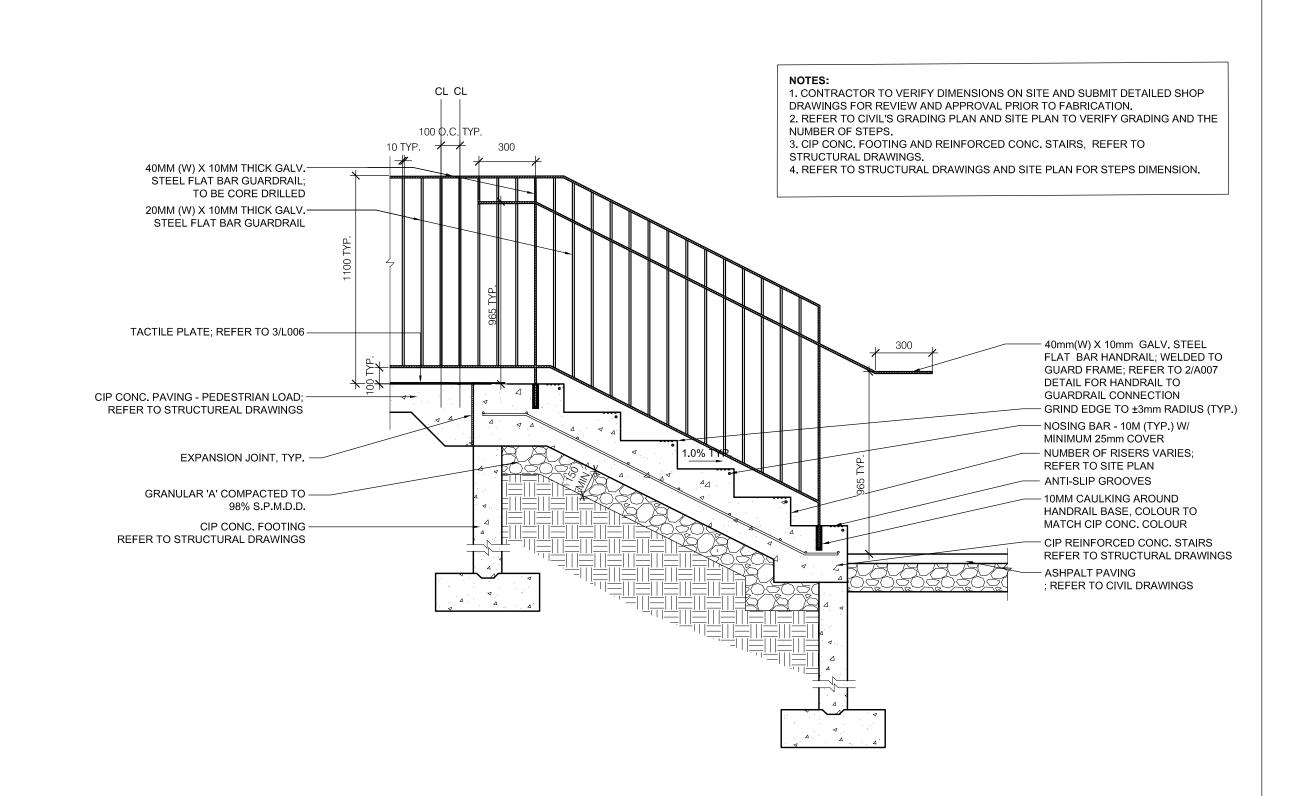

CIP CONCRETE STEPS/ GUARDRAIL/ HANDRAIL

1:10

Contractor must check and verify all dimensions on the job, and report any discrepancies to the Architect before proceeding with the work.

Do not scale this drawing.

REVISIONS	AND ISSUES		
REV	DESCRIPTION	DATE	E
1	REVISED SPA	210809	A
2	ISSUED FOR TENDER	210824	A
3	REVISION TO BUILDING PERMIT	220315	A
4	SI-01	220615	A
5	BLG SET-OUT CAD	220715	A
6	ISSUED FOR CONSTRUCTION	220715	A
7			
_			

# AMLM

maclennan jaunkalns miller architects

425 adelaide street west level 6 toronto ontario m5v 3c1 416 593 6796 www.mjmarchitects.com

#### TRITON ENGINEERING SERVICES LTD

CIVIL ENGINEERS

229 BROADWAY, UNIT 1

ORANGEVILLE, ONTARIO, L9W 1K4

TEL 519 941 0330 FAX 519 941 1830

BLACKWELL STRUCTURAL ENGINEERS 134 PETER STREET, SUITE 1301

TORONTO, ONTARIO, M5V 2H2
TEL 416.593.5300 FAX 416.593.4840

SMITH + ANDERSON mechanical and electrical engineers

1100 - 100 SHEPPARD AVENUE EAST TORONTO, ONTARIO, M2N 6N5 TEL 416.487.8151 -

## SAYERS FOOD LIMITED

132 BURLEIGH STREET t: 705.656.4531 e: sayers@apsley.ca

NORTH ARROW



PROJECT TITLE

NEW SAYERS FOOD STORE BURLEIGH STREET, APSLEY

SITE PLA

SITE PLAN DETAILS 3


AS NOTED

JULY 15, 2022

PROJECT NUMBER

2102
DRAWING NUMBER


A007

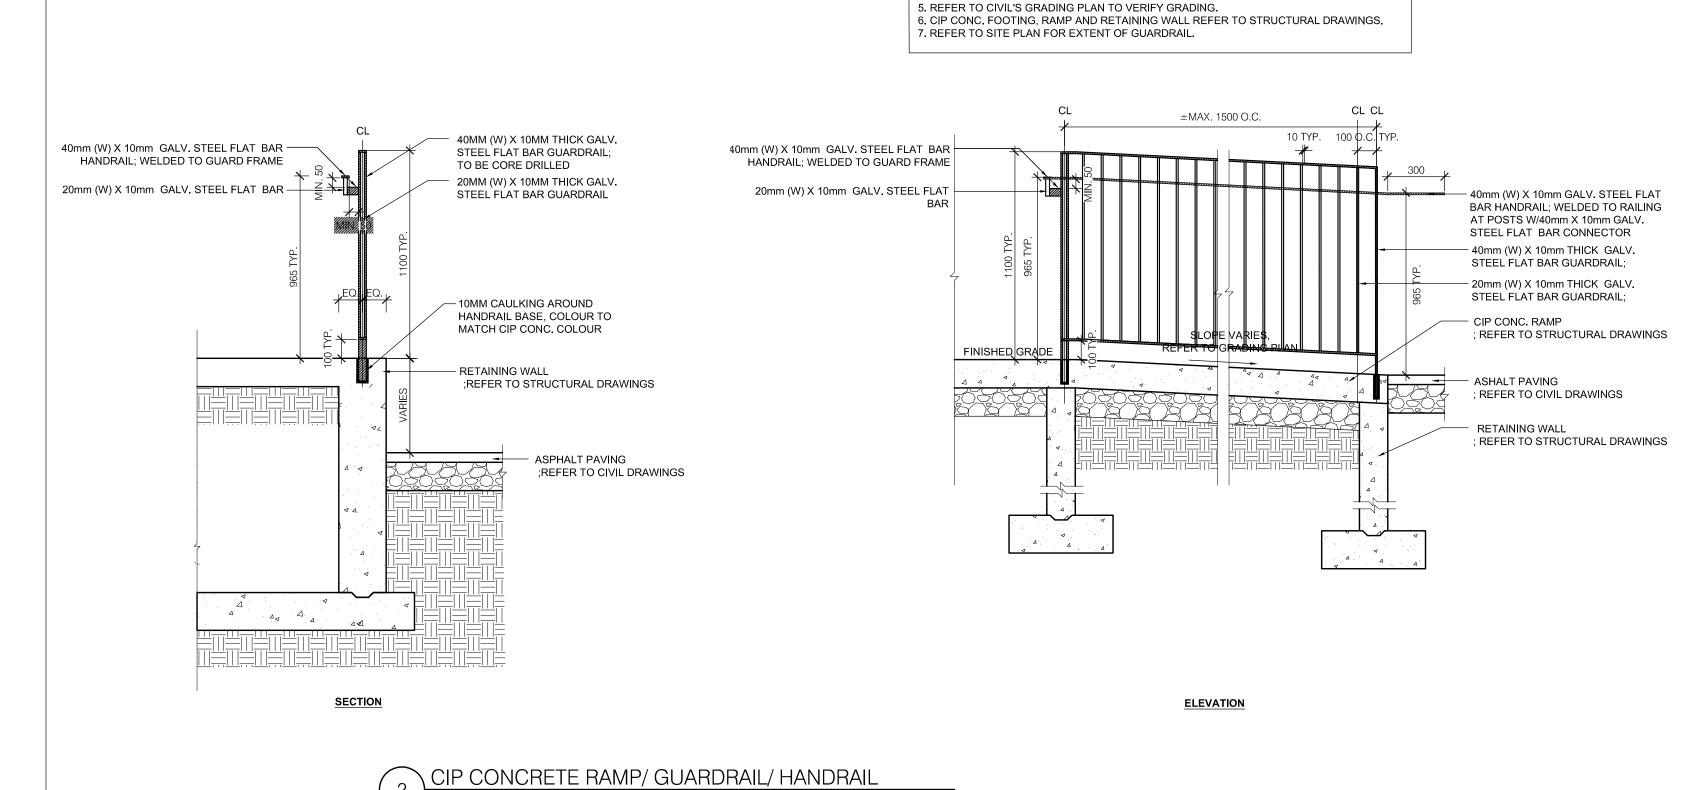

CONTRACTOR TO VERIFY DIMENSIONS ON SITE AND SUBMIT DETAILED SHOP DRAWINGS
 WITH LICENSED ENGINEER'S STAMP FOR REVIEW AND APPROVAL BEFORE FABRICATION.


2. ALL FASTENERS TO BE GALVANIZED AND NON-CORROSIVE..

3. WELD ALL JOINTS TO CREATE A RIGID SECURE STRUCTURE. 4. ALL WELDS GROUND SMOOTH AND NO WELDS OR SEAMS TO SHOW.

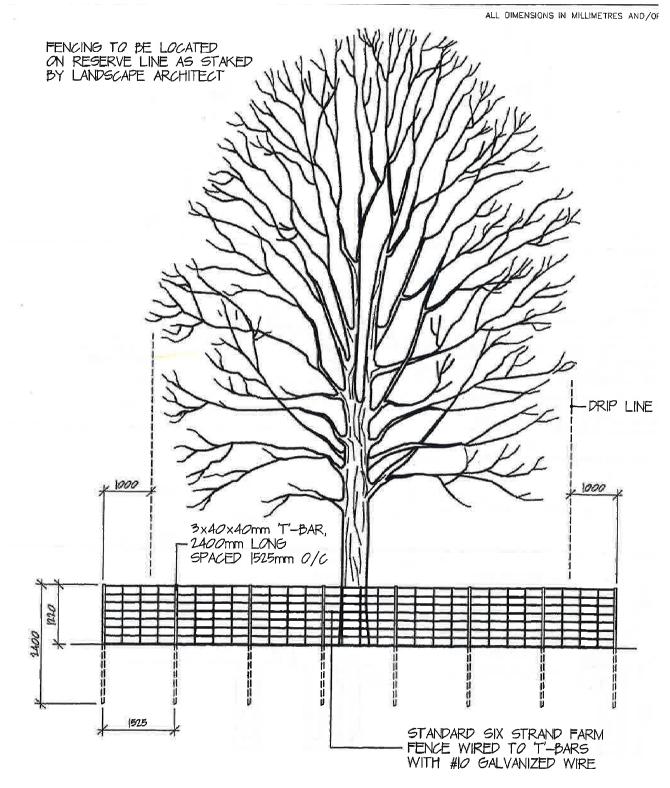


TREE PRESERVATION PROTECTION FENCE

N.T.S.

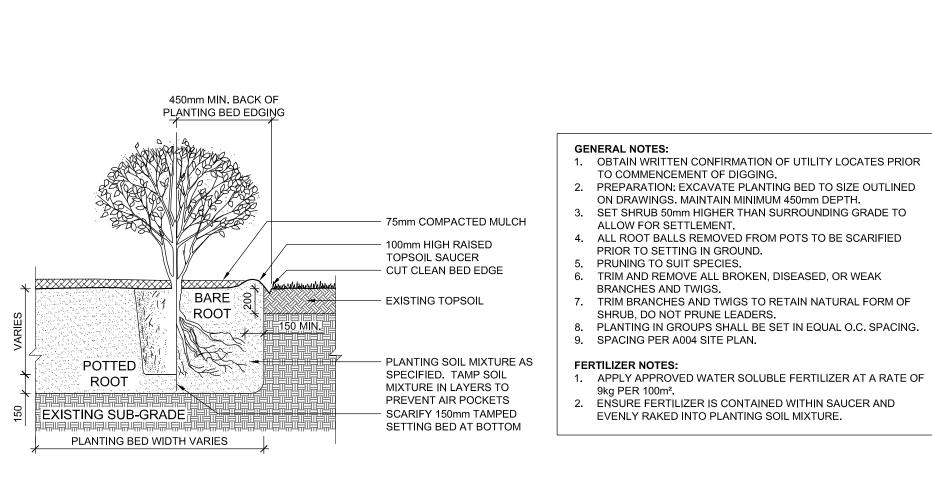

PLANTING

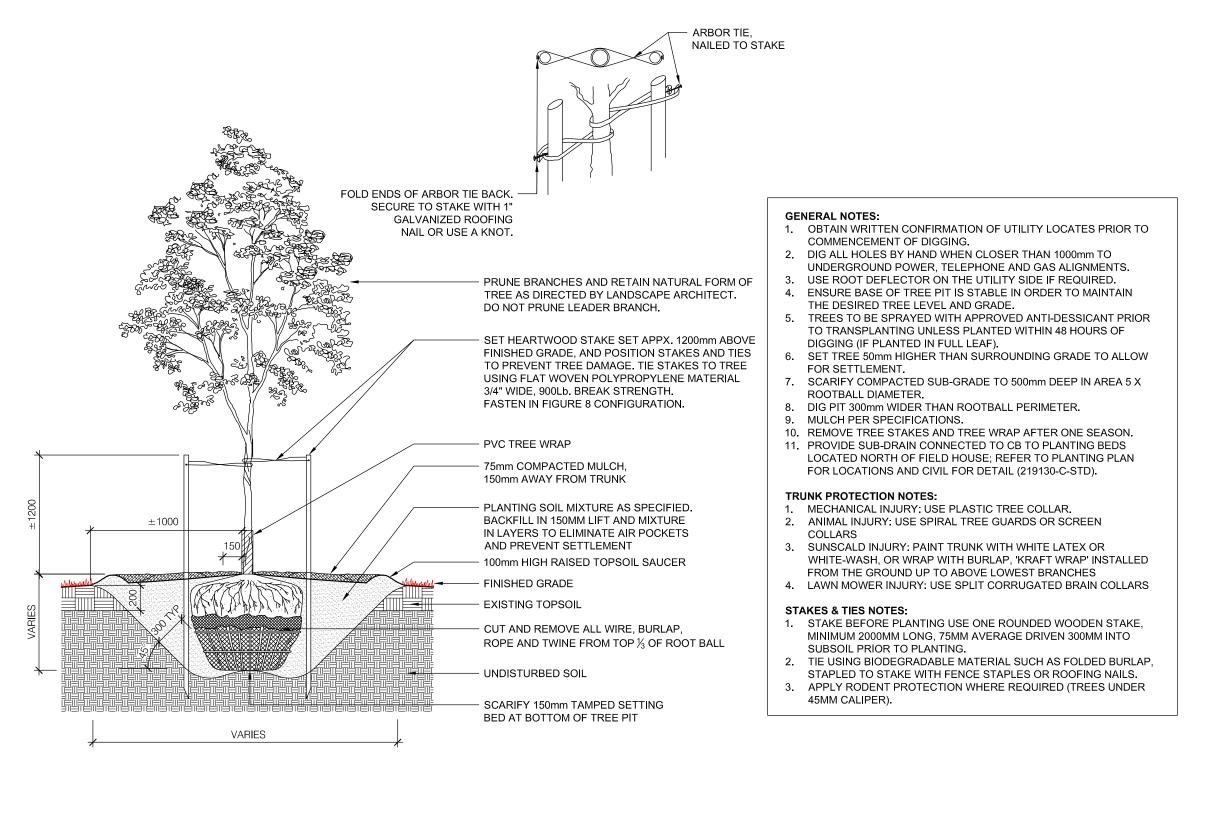

DECIDUOUS TREE PLANTING

Contractor must check and verify all dimensions on the job, and report any discrepancies to the Architect before proceeding with the work.

Do not scale this drawing.

 REVISIONS AND ISSUES

 REV
 DESCRIPTION
 DATE

 1
 REVISED SPA
 210809

 2
 ISSUED FOR TENDER
 210824

 3
 REVISION TO BUILDING PERMIT
 220315

 4
 SI-01
 220615

 5
 BLG SET-OUT CAD
 220715

 6
 ISSUED FOR CONSTRUCTION
 220715

 7

# **MJMA**

maclennan jaunkalns miller architects

425 adelaide street west level 6 toronto ontario m5v 3c1 416 593 6796 www.mjmarchitects.com

CIVIL ENGINEERS

#### TRITON ENGINEERING SERVICES LTD

229 BROADWAY, UNIT 1
ORANGEVILLE, ONTARIO, L9W 1K4

# TEL 519 941 0330 FAX 519 941 1830 BLACKWELL

STRUCTURAL ENGINEERS

134 PETER STREET, SUITE 1301
TORONTO, ONTARIO, M5V 2H2
TEL 416.593.5300 FAX 416.593.4840

#### SMITH + ANDERSON MECHANICAL AND ELECTRICAL ENGINEERS


1100 - 100 SHEPPARD AVENUE EAST TORONTO, ONTARIO, M2N 6N5

TEL 416.487.8151 -

## SAYERS FOOD LIMITED

132 BURLEIGH STREET t: 705.656.4531 e: sayers@apsley.ca

NORTH ARROW

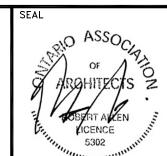

PROJECT TITLE

NEW SAYERS FOOD STORE BURLEIGH STREET, APSLEY

SITE PLAN


DETAILS 4

AS NOTED

JULY 15, 2022

PROJECT NUMBER

2102
DRAWING NUMBER

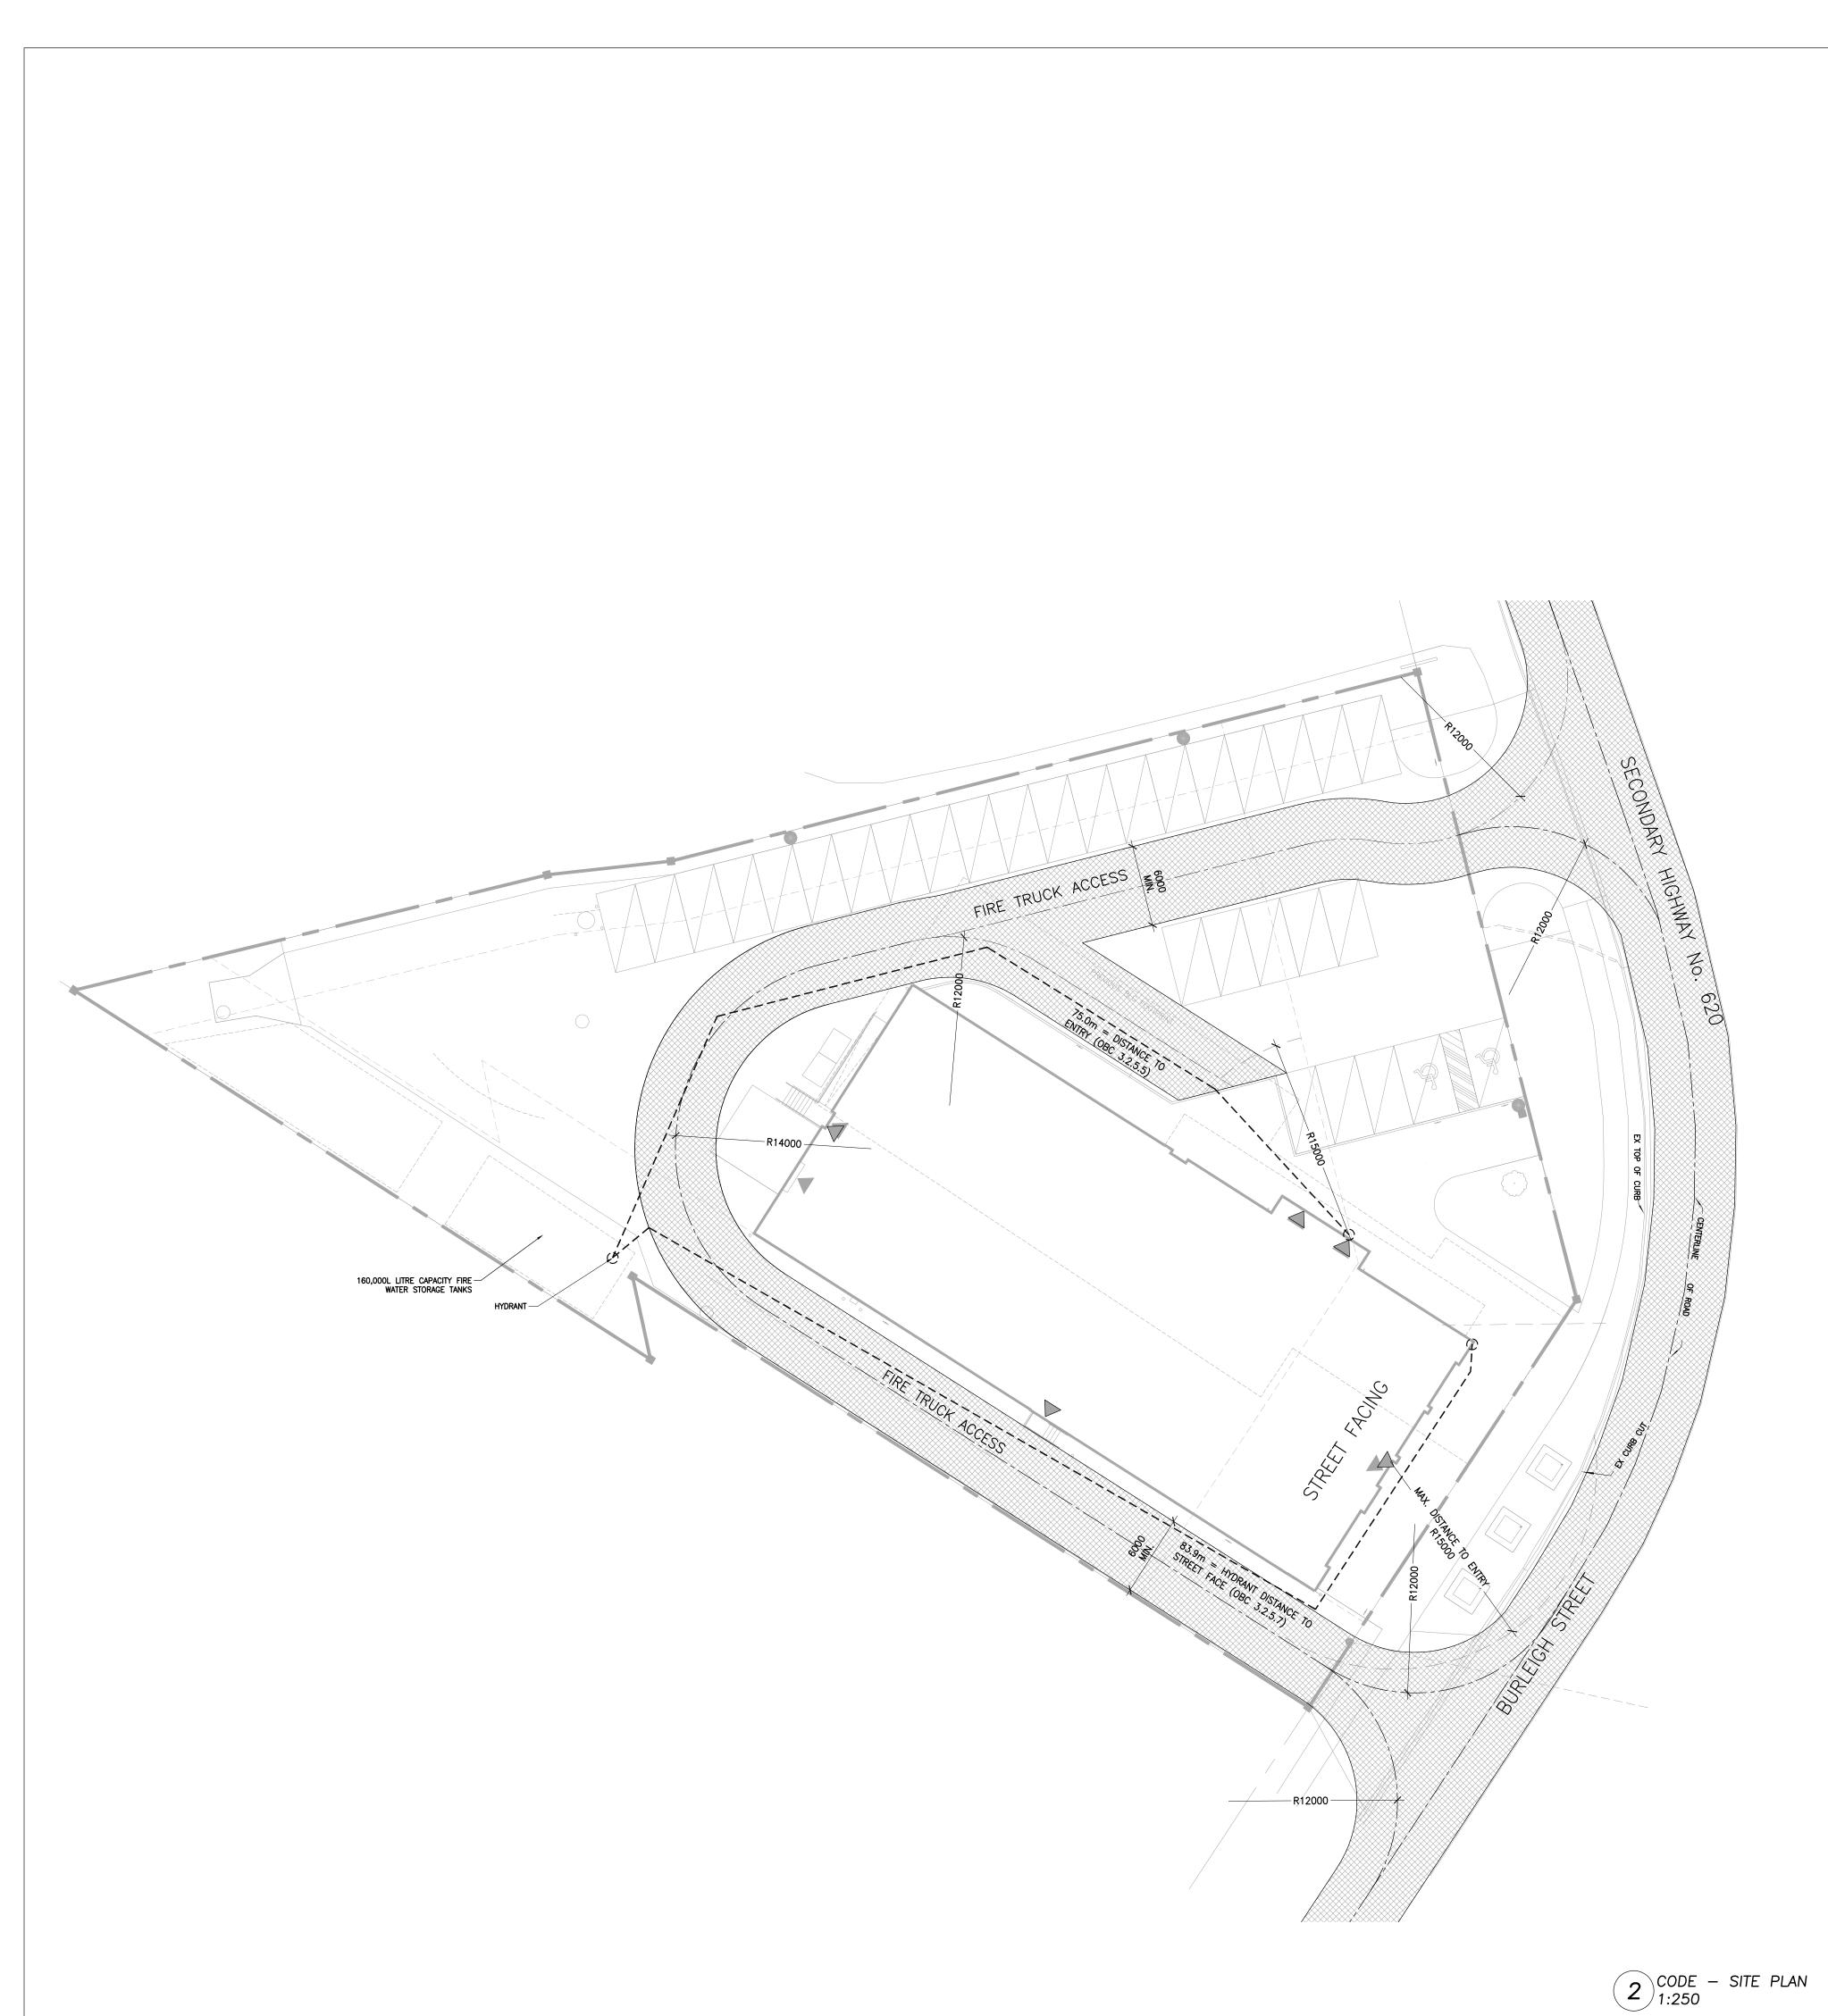

	ictice MacLennan Jai	unkalns Miller Archited	ts						
Address 1	425 Adelaide S	Street West, Level 6					-		
Address 2	Toronto, Ontai						]		
Contact	Andrew Bramı						_		
Name of Pro	ject Sayers Foods						-		
Location/Add	dress 132 Burleigh S	Street					1		
Date	17-Jan-22						Seal & Signature		
3.00 BUILDING C		O.Reg. 332/12			LAST	AMENDMENT	O.Reg. 191/14		723.4.4.0
3.01 PROJECTT	YPE	New Constructio	n						[A] 1.1.2. -
3.02 MAJOR OCC		OCCUPANCY					USE		3.1.2.1.(1)
		E	Mercantile				Grocery Store		-
3.03 SUPERIMPO	OSED MAJOR CIES	No							3.2.2.7.
3.04 BUILDING A	REA (m²)	DESCRIPTION				EXISTING	NEV	V TOTAL	[A] 1.4.1.2
		Building Area TOTAL				0.00	1,078.0	11 17 19 19 19 19 19 19 19 19 19 19 19 19 19	-
3.05 GROSS ARE	ΞΑ (m²)	DESCRIPTION				EXISTING	3456 4020		[A] 1.4.1.2
		Ground Level				0.00			<u>-</u>
		TOTAL				0.00	1,274.0	10 20 10	-
3.06 MEZZANINE	AREA (m²)	DESCRIPTION				EXISTING	) NEV	V TOTAL	. 3.2.1.1.
		TOTAL						-	<u>-</u> -
3.07 BUILDING H	IEIGHT	2	STOREYS A	BOVE GRAD	E		1.70.2 per	(m) ABOVE GRADE	
3.08 HIGH BUILD	NING	O No	STOREYS BE	ELOW GRAD	E				3.2.1.1.
NUMBER OF S	STREETS/	No 1	STREET(S)						3.2.6
3.10 BUILDING C		3.2.2.59.		P TO 3 STO	REYS - FA	CING 1 STREE	TS		3.2.2.20-8
(SIZE AND CON RELATIVE TO C		<del>-</del>	GROUP D A	CCESSORY	(L2)				
3.11 SPRINKLER	SYSTEM	Not Required		PR	OVIDED:	None			3.2.1.5. &
3.12 STANDPIPE	SYSTEM	Not Required							3.2.2.17.
3.13 FIRE ALARM		Not Required			Т	/PE PROVIDED	) N/A		3.2.4.
3.14 WATER SER		No				160,000L Wa	ter Storage Tanks Pr	ovided on Site	
3.15 CONSTRUC	TION TYPE	RESTRICTIONS	Combustible	Permitted					3.2.2.2.20
		ACTUAL	Combination	9		HEAVY TIM	BER CONSTRUCTION	NO NO	3.2.1.4. 4.1.2.1.(3)
3.16 IMPORTANO	CE CATEGORY 	Norm al				- ole 4.1.8.18. Iter			T4.1.2.1.8 4.1.8.18.(1
3.18 OCCUPANT	LOAD	FLOOR		00	CUPANCY	/ TYPE	BASED ON	OCCUPANT LOAD	3.1.17.
		L1 - OPEN SHOP	PING AREA		RCANTIL	E - FIRST	m² per person	(PERSONS)	_
		(576m/3.7) L1 - BAKE & DEL	.I (106m/9.3)		OREY CHENS		m² per person	12	-
		L1 - PRODUCE P	REP (18m/9.3	) кп	CHENS		m² per person	2	
		L1 - MEAT PREP			ORAGE		m² per person	2	
			/III/ <del></del> )		OIGGE		m² ner nerson	2	-
		L2 - OFFICE			FICES		m² per person  Design of space	2	<u>-</u>
		L2 - OFFICE L2 - STORAGE (3	31m/46)	OF	FICES			p=1	· - -
		L2 - OFFICE	31m/46)	OF ST			Design of space	4	- - -
		L2 - OFFICE L2 - STORAGE (C) L2 - PRIVATE OFFICE L2 - STAFF (EMPLOYEES	31m/46)	OF	ORAGE		Design of space  m² per person  Design of space	4	- - -
		L2 - OFFICE L2 - STORAGE (S L2 - PRIVATE OFFICE L2 - STAFF	31m/46)	OF	ORAGE		Design of space m² per person	4	- - -
240 PADDIED E		L2 - OFFICE L2 - STORAGE (S L2 - PRIVATE OFFICE L2 - STAFF (EMPLOYEES FROM OTHER AREAS) TOTAL	31m/46)	OF	ORAGE		Design of space  m² per person  Design of space	4	-
3.19 BARRIER-FI		L2 - OFFICE L2 - STORAGE (3 L2 - PRIVATE OFFICE L2 - STAFF (EMPLOYEES FROM OTHER AREAS) TOTAL Yes	31m/46)	OF	ORAGE		Design of space  m² per person  Design of space	4 1 3	3.8.
3.20 HAZARDOU		L2 - OFFICE L2 - STORAGE (S L2 - PRIVATE OFFICE L2 - STAFF (EMPLOYEES FROM OTHER AREAS) TOTAL		OF	ORAGE	RATING (H)	Design of space  m² per person  Design of space  m² per person  SUPPORTING	4 1 3 - 182	3.8. 3.3.1.2. & 3.3.1.19. 3.2.2.208
3.20 HAZARDOU	SSUBSTANCES	L2 - OFFICE  L2 - STORAGE (STATE OFFICE  L2 - STAFF (EMPLOYEES FROM OTHER AREAS)  TOTAL  Yes	SEMBLY	OF	ORAGE	RATING (H)	Design of space  m² per person  Design of space  m² per person	4 1 3 -	3.8. 3.3.1.2. & 3.3.1.19. 3.2.2.208
3.20 HAZARDOU	SSUBSTANCES	L2 - OFFICE  L2 - STORAGE (3  L2 - PRIVATE OFFICE  L2 - STAFF (EMPLOYEES FROM OTHER AREAS)  TOTAL  YES  NO  HORIZONTAL AS	SEMBLY	OF	ORAGE	x	Design of space  m² per person  Design of space  m² per person  SUPPORTING ASSEMBLY (H)	4 1 3 - 182  NONCOMBUSTIBLE IN LIEU OF RATING	3.8. 3.3.1.2. & 3.3.1.19. 3.2.2.208
3.20 HAZARDOU	SSUBSTANCES	L2 - OFFICE L2 - STORAGE (3 L2 - PRIVATE OFFICE L2 - STAFF (EMPLOYEES FROM OTHER AREAS)  TOTAL YES NO HORIZONTAL AS FLOORS OVER E FLOORS MEZZANINE	SEMBLY	OF	ORAGE	N/A <b>45 min</b> N/A	Design of space  m² per person  Design of space  m² per person  SUPPORTING ASSEMBLY (H)  N/A  45 min  N/A	NONCOMBUSTIBLE IN LIEU OF RATING N/A NO N/A	3.8. 3.3.1.2. & 3.3.1.19. 3.2.2.208
3.20 HAZARDOU	SSUBSTANCES	L2 - OFFICE  L2 - STORAGE (STATE OFFICE  L2 - STAFF (EMPLOYEES FROM OTHER AREAS)  TOTAL  YES  NO  HORIZONTAL AS  FLOORS OVER EMPLOYEES	SEMBLY	OF	ORAGE	N/A 45 min N/A 45 min	Design of space  m² per person  Design of space  m² per person  SUPPORTING ASSEMBLY (H)  N/A  45 min  N/A	A 1 1 3 - 182 NONCOMBUSTIBLE IN LIEU OF RATING N/A NO	3.8. 3.3.1.2. & 3.3.1.19. 3.2.2.208
3.20 HAZARDOU	S SUBSTANCES FIRE RESISTANCE	L2 - OFFICE L2 - STORAGE (3 L2 - PRIVATE OFFICE L2 - STAFF (EMPLOYEES FROM OTHER AREAS)  TOTAL YES NO HORIZONTAL AS FLOORS OVER E FLOORS MEZZANINE	SEMBLY	OF ST OF	ORAGE	N/A <b>45 min</b> N/A	Design of space  m² per person  Design of space  m² per person  SUPPORTING ASSEMBLY (H)  N/A  45 min  N/A	NONCOMBUSTIBLE IN LIEU OF RATING N/A NO N/A	3.8. 3.3.1.2. & 3.3.1.19. 3.2.2.208
3.20 HAZARDOU  3.21 REQUIRED RATINGS	S SUBSTANCES FIRE RESISTANCE	L2 - OFFICE  L2 - STORAGE (3  L2 - PRIVATE OFFICE  L2 - STAFF (EMPLOYEES FROM OTHER AREAS)  TOTAL  YES  NO  HORIZONTAL AS FLOORS OVER E FLOORS MEZZANINE ROOF	SSEMBLY  SSMT  EBF  AREA L.	OF ST OF	ORAGE	N/A 45 min N/A 45 min REQUIRED FRR (H)	Design of space  m² per person  Design of space  m² per person  SUPPORTING ASSEMBLY (H)  N/A  45 min  CONSTRUCTION	NONCOMBUSTIBLE IN LIEU OF RATING: N/A NO N/A YES	3.8. 3.3.1.2. & 3.3.1.19. 3.2.2.208 3.2.1.4.
3.20 HAZARDOU  3.21 REQUIRED RATINGS	S SUBSTANCES FIRE RESISTANCE	L2 - OFFICE L2 - STORAGE (3 L2 - PRIVATE OFFICE L2 - STAFF (EMPLOYEES FROM OTHER AREAS) TOTAL YES NO HORIZONTAL AS FLOORS OVER E FLOORS MEZZANINE ROOF	EBF AREA L.C (m²)	OF ST OF	ORAGE FICES UNGE	N/A 45 min N/A 45 min REQUIRED FRR (H) 1.00	Design of space  m² per person  Design of space  m² per person  SUPPORTING ASSEMBLY (H) N/A  45 min  CONSTRUCTION TYPE  Combustible	A 1 1 3 3	3.8. 3.3.1.2. & 3.3.1.19. 3.2.2.206 3.2.1.4.
3.20 HAZARDOU  3.21 REQUIRED RATINGS	S SUBSTANCES FIRE RESISTANCE	L2 - OFFICE  L2 - STORAGE (3  L2 - PRIVATE OFFICE  L2 - STAFF (EMPLOYEES FROM OTHER AREAS)  TOTAL  YES  NO  HORIZONTAL AS  FLOORS OVER E FLOORS MEZZANINE ROOF  WALL  NORTH-WEST A	EBF AREA L.C (m²)	OF ST OF LO	ORAGE FICES UNGE	N/A 45 min N/A 45 min REQUIRED FRR (H) 1.00	Design of space m² per person Design of space m² per person  SUPPORTING ASSEMBLY (H) N/A 45 min CONSTRUCTION TYPE Combustible Permitted Combustible Permitted Combustible	NONCOMBUSTIBLE IN LIEU OF RATINGS N/A NO N/A YES CLADDING TYPE Combustible Permit	3.8. 3.3.1.2. & 3.3.1.19. 3.2.2.206 3.2.1.4.
3.20 HAZARDOU  3.21 REQUIRED RATINGS	S SUBSTANCES FIRE RESISTANCE	L2 - OFFICE  L2 - STORAGE (STATE OFFICE  L2 - STAFF (EMPLOYEES FROM OTHER AREAS)  TOTAL  YES  NO  HORIZONTAL AS  FLOORS OVER BE FLOORS  MEZZANINE  ROOF  WALL  NORTH-WEST A	EBF AREA L.C (m²) 178.0	OF ST OF LO 18.50	ORAGE FICES UNGE FIOR HAL 2.30 1.90	N/A 45 min N/A 45 min REQUIRED FRR (H) 1.00	Design of space m² per person Design of space m² per person  SUPPORTING ASSEMBLY (H) N/A 45 min  CONSTRUCTION TYPE Combustible Permitted Combustible Permitted Combustible Permitted Combustible Permitted Combustible Permitted Combustible	NONCOMBUSTIBLE IN LIEU OF RATINGS N/A NO N/A YES  CLADDING TYPE  Combustible Permit	3.8. 3.3.1.2. & 3.3.1.19. 3.2.2.206 2.3.2.1.4
3.20 HAZARDOU  3.21 REQUIRED RATINGS	S SUBSTANCES FIRE RESISTANCE	L2 - OFFICE  L2 - STORAGE (3  L2 - PRIVATE OFFICE  L2 - STAFF (EMPLOYEES FROM OTHER AREAS)  TOTAL  YES  NO  HORIZONTAL AS FLOORS OVER E FLOORS MEZZANINE ROOF  WALL  NORTH-WEST A  NORTH-WEST C  NORTH-EAST A	EBF AREA L.C (m²) 178.0 19.0 6.0	OF ST OF LO 18.50 18.50 18.50	ORAGE FICES UNGE 1 OR H/L 2.30 1.90 1.70 4.90	N/A 45 min N/A 45 min REQUIRED FRR (H) 1.00	Design of space  m² per person  Design of space  m² per person  SUPPORTING ASSEMBLY (H)  N/A  45 min  CONSTRUCTION TYPE  Combustible Permitted	NONCOMBUSTIBLE IN LIEU OF RATINGS N/A NO N/A YES  CLADDING TYPE  Combustible Permit Combustible Permit Combustible Permit	3.8. 3.3.1.2. & 3.3.1.19. 3.2.2.208 3.2.1.4.
3.20 HAZARDOU  3.21 REQUIRED RATINGS	S SUBSTANCES FIRE RESISTANCE	L2 - OFFICE  L2 - STORAGE (3  L2 - PRIVATE OFFICE  L2 - STAFF (EMPLOYEES FROM OTHER AREAS)  TOTAL  YES  NO  HORIZONTAL AS FLOORS OVER E FLOORS MEZZANINE ROOF  WALL  NORTH-WEST A  NORTH-WEST A  NORTH-WEST C  NORTH-EAST A	EBF AREA L.C (m²) 178.0 19.0 6.0 396.0	OF ST OF LO 18.50 18.50 19.60 15.60	ORAGE FICES UNGE 1 OR H/L 2.30 1.90 1.70 4.90 2.26	N/A 45 min N/A 45 min  REQUIRED FRR (H)  1.00  1.00	Design of space m² per person Design of space m² per person  SUPPORTING ASSEMBLY (H) N/A 45 min CONSTRUCTION TYPE Combustible Permitted Combustible Permitted Combustible Permitted Combustible Permitted Combustible Permitted Combustible Permitted	NONCOMBUSTIBLE IN LIEU OF RATING N/A NO N/A YES CLADDING TYPE Combustible Permit Combustible Permit Combustible Permit Noncombustible Recombustible Permit	3.8. 3.3.1.2.8 3.3.1.19. 3.2.2.20.6 3.2.1.4
3.20 HAZARDOU  3.21 REQUIRED RATINGS	S SUBSTANCES FIRE RESISTANCE	L2 - OFFICE L2 - STORAGE (3 L2 - PRIVATE OFFICE L2 - STAFF (EMPLOYEES FROM OTHER AREAS) TOTAL YES NO HORIZONTAL AS FLOORS OVER E FLOORS MEZZANINE ROOF WALL NORTH-WEST A NORTH-WEST A SOUTH-EAST A SOUTH-EAST A	EBF AREA L.C (m²) 178.0 19.0 6.0 396.0 179.0	OF ST OF LC D. (m) L/H 18.50 18.50 19.60 15.60	ORAGE FICES UNGE H OR H/L 2.30 1.90 1.70 4.90 2.26 1.80	N/A 45 min N/A 45 min REQUIRED FRR (H)  1.00	Design of space  m² per person  Design of space  m² per person  SUPPORTING ASSEMBLY (H)  N/A  45 min  CONSTRUCTION TYPE  Combustible Permitted	NONCOMBUSTIBLE IN LIEU OF RATINGS N/A NO N/A YES CLADDING TYPE Combustible Permit Combustible Permit Combustible Permit Noncombustible Recombustible Permit	3.8. 3.3.1.2.8 3.3.1.19. 3.2.2.20.8 3.2.1.4.  3.2.3.  ted - ted - ted - ted - ted - ted - ted
3.20 HAZARDOU  3.21 REQUIRED RATINGS	S SUBSTANCES FIRE RESISTANCE	L2 - OFFICE  L2 - STORAGE (3  L2 - PRIVATE OFFICE  L2 - STAFF (EMPLOYEES FROM OTHER AREAS)  TOTAL  YES  NO  HORIZONTAL AS FLOORS OVER E FLOORS MEZZANINE ROOF  WALL  NORTH-WEST A  NORTH-WEST A  NORTH-WEST C  NORTH-EAST A	EBF AREA L.C (m²) 178.0 19.0 6.0 396.0	OF ST OF LO 18.50 18.50 19.60 15.60	ORAGE FICES UNGE 1 OR H/L 2.30 1.90 1.70 4.90 2.26	N/A 45 min N/A 45 min REQUIRED FRR (H)  1.00	Design of space  m² per person  Design of space  m² per person  SUPPORTING ASSEMBLY (H)  N/A  45 min  CONSTRUCTION TYPE  Combustible Permitted	NONCOMBUSTIBLE IN LIEU OF RATING N/A NO N/A YES CLADDING TYPE Combustible Permit Combustible Permit Combustible Permit Noncombustible Recombustible Permit	3.8. 3.3.1.2.8 3.3.1.19. 3.2.2.20.8 3.2.1.4.  3.2.3.  ted - ted - ted - ted - ted - ted - ted
3.20 HAZARDOU  3.21 REQUIRED RATINGS	S SUBSTANCES FIRE RESISTANCE	L2 - OFFICE L2 - STORAGE (3 L2 - PRIVATE OFFICE L2 - STAFF (EMPLOYEES FROM OTHER AREAS) TOTAL YES NO HORIZONTAL AS FLOORS OVER E FLOORS MEZZANINE ROOF WALL NORTH-WEST A NORTH-WEST A SOUTH-EAST A SOUTH-EAST A	EBF AREA L.C (m²) 178.0 19.0 6.0 396.0 179.0	OF ST OF LC D. (m) L/H 18.50 18.50 19.60 15.60	ORAGE FICES UNGE H OR H/L 2.30 1.90 1.70 4.90 2.26 1.80	N/A 45 min  N/A 45 min  REQUIRED FRR (H)  1.00  - 1.00 - 2.00	Design of space  m² per person  Design of space  m² per person  SUPPORTING ASSEMBLY (H)  N/A  45 min  CONSTRUCTION TYPE  Combustible Permitted	NONCOMBUSTIBLE IN LIEU OF RATINGS N/A NO N/A YES CLADDING TYPE Combustible Permit Combustible Permit Combustible Permit Noncombustible Recombustible Permit	3.8. 3.3.1.2. & 3.3.1.19. 3.2.2.206 2.3.2.1.4.
3.20 HAZARDOU  3.21 REQUIRED RATINGS  3.22 SPATIAL SE	S SUBSTANCE FIRE RESISTANCE  PARATION	L2 - OFFICE  L2 - STORAGE (S)  L2 - PRIVATE OFFICE  L2 - STAFF (EMPLOYEES FROM OTHER AREAS)  TOTAL  YES  NO  HORIZONTAL AS  FLOORS OVER B FLOORS  MEZZANINE  ROOF  WALL  NORTH-WEST A  NORTH-WEST C  NORTH-EAST A  SOUTH-EAST A  SOUTH-EAST B  SOUTH-EAST A	EBF AREA L.C (m²) 178.0 19.0 6.0 396.0 179.0 35.0 246.0	OF ST OF LO 18.50 18.50 19.60 15.60 7.50	ORAGE FICES UNGE HOR H/L 2.30 1.90 1.70 4.90 2.26 1.80 4.90	N/A 45 min N/A 45 min REQUIRED FRR (H) 1.00 2.00 2.00	Design of space  m² per person  Design of space  m² per person  SUPPORTING ASSEMBLY (H)  N/A  45 min  CONSTRUCTION TYPE  Combustible Permitted	NONCOMBUSTIBLE IN LIEU OF RATING: N/A NO N/A YES  CLADDING TYPE  Combustible Permit Combustible Permit Combustible Permit Noncombustible Recombustible Recombustible Permit	3.8. 3.3.1.2. & 3.3.1.19. 3.2.2.206 3.2.1.4.  3.2.3.  ted  ted  ted  ted  ted  q'd  ted  q'd  -
3.20 HAZARDOU  3.21 REQUIRED RATINGS	S SUBSTANCE  FIRE RESISTANCE  FARATION  FIXTURE	L2 - OFFICE  L2 - STORAGE (S)  L2 - PRIVATE OFFICE  L2 - STAFF (EMPLOYEES FROM OTHER AREAS)  TOTAL  YES  NO  HORIZONTAL AS FLOORS OVER E FLOORS MEZZANINE ROOF  WALL  NORTH-WEST A  NORTH-WEST B  NORTH-EAST A  SOUTH-EAST B  SOUTH-WEST B	EBF AREA L.C (m²) 178.0 19.0 6.0 396.0 179.0 246.0 96.0	OF ST OF LO 18.50 18.50 19.60 15.60 7.50 7.50	ORAGE FICES UNGE 1 OR HAL 2.30 1.90 1.70 4.90 2.26 1.80 4.90 2.90	N/A 45 min N/A 45 min REQUIRED FRR (H) 1.00 2.00 2.00 1.00	Design of space  m² per person  Design of space  m² per person  SUPPORTING ASSEMBLY (H)  N/A  45 min  CONSTRUCTION TYPE  Combustible Permitted	NONCOMBUSTIBLE IN LIEU OF RATINGS N/A NO N/A YES  CLADDING TYPE  Combustible Permit Combustible Permit Combustible Permit Noncombustible Recombustible Recom	3.8. 3.3.1.2. & 3.3.1.19. 3.2.2.206 3.2.1.4.  3.2.3.  ted  ted  ted  ted  ted  q'd  ted  q'd  -
3.20 HAZARDOU  3.21 REQUIRED RATINGS  3.22 SPATIAL SE	S SUBSTANCE  FIRE RESISTANCE  FARATION  FIXTURE	L2 - OFFICE  L2 - STORAGE (3  L2 - PRIVATE OFFICE  L2 - STAFF (EMPLOYEES FROM OTHER AREAS)  TOTAL  YES  NO  HORIZONTAL AS FLOORS OVER E FLOORS MEZZANINE ROOF  WALL  NORTH-WEST A  NORTH-WEST A  SOUTH-EAST A  SOUTH-EAST A  SOUTH-WEST B  SOUTH-WEST C	EBF AREA L.C (m²) 178.0 19.0 6.0 396.0 179.0 246.0 96.0	OF ST OF LO LO 18.50 18.50 19.60 15.60 7.50 7.50 7.50	ORAGE FICES UNGE 1 OR HAL 2.30 1.90 1.70 4.90 2.26 1.80 4.90 2.90	N/A 45 min N/A 45 min REQUIRED FRR (H) 1.00 2.00 2.00 1.00  XCEPT AS NOT	Design of space  m² per person  Design of space  m² per person  SUPPORTING ASSEMBLY (H)  N/A  45 min  CONSTRUCTION TYPE  Combustible Permitted	NONCOMBUSTIBLE IN LIEU OF RATINGS N/A NO N/A YES  CLADDING TYPE  Combustible Permit Combustible Permit Combustible Permit Noncombustible Recombustible Recom	3.8. 3.3.1.2.8 3.3.1.19. 3.2.2.20.6 3.2.1.4.  3.2.3
3.20 HAZARDOU  3.21 REQUIRED RATINGS  3.22 SPATIAL SE	S SUBSTANCE  FIRE RESISTANCE  FARATION  FIXTURE	L2 - OFFICE  L2 - STORAGE (3)  L2 - PRIVATE OFFICE  L2 - STAFF (EMPLOYEES FROM OTHER AREAS)  TOTAL  YES  NO  HORIZONTAL AS FLOORS OVER E FLOORS MEZZANINE ROOF  WALL  NORTH-WEST A  NORTH-WEST C  NORTH-EAST A  SOUTH-EAST A  SOUTH-EAST B  SOUTH-WEST C  RATIO: FLOOR  FLOOR  RATIO: FLOOR  FLOOR  RATIO: FLOOR  FLOOR  RATIO: FLOOR  FLOOR  RATIO: FLOOR  RATIO: FLOOR  LEVEL/AREA  L1 - PUBLIC (P) -	EBF AREA L.C (m²) 178.0 19.0 6.0 396.0 179.0 35.0 246.0 96.0	OF ST OF LO LO D. (m) L/H 18.50 18.50 18.50 19.60 15.60 7.50 7.50 7.50	ORAGE FICES UNGE  H OR H/L  2.30 1.90 1.70 4.90 2.26 1.80 4.90 2.90 E = 50:50 E	N/A  45 min  N/A  45 min  REQUIRED FRR (H)  1.00  2.00  2.00  1.00  XCEPT AS NOTO	Design of space  m² per person  Design of space  m² per person  SUPPORTING ASSEMBLY (H)  N/A  45 min  CONSTRUCTION TYPE  Combustible Permitted	NONCOMBUSTIBLE IN LIEU OF RATINGS N/A NO N/A YES  CLADDING TYPE  Combustible Permit Combustible Permit Combustible Permit Noncombustible Recombustible Recom	3.8. 3.3.1.2.8 3.3.1.19. 3.2.2.20.6 3.2.1.4.  3.2.3
3.20 HAZARDOU  3.21 REQUIRED RATINGS  3.22 SPATIAL SE	S SUBSTANCE  FIRE RESISTANCE  FARATION  FIXTURE	L2 - OFFICE  L2 - STORAGE (3)  L2 - PRIVATE OFFICE  L2 - STAFF (EMPLOYEES FROM OTHER AREAS)  TOTAL  YES  NO  HORIZONTAL AS FLOORS OVER E FLOORS MEZZANINE ROOF  WALL  NORTH-WEST A  NORTH-WEST A  SOUTH-EAST A  SOUTH-EAST A  SOUTH-WEST B  SOUTH-WEST C  RATIO: FLOOR  FLOOR  RATIO: FLOOR	EBF AREA L.C (m²) 178.0 19.0 6.0 396.0 179.0 35.0 246.0 96.0	OF ST OF LO LO D. (m) L/H 18.50 18.50 18.50 19.60 15.60 7.50 7.50 7.50	ORAGE FICES UNGE HOR HAL 2.30 1.90 1.70 4.90 2.26 1.80 4.90 4.90 2.90 E 50:50 E	N/A  45 min  N/A  45 min  REQUIRED FRR (H)  1.00  2.00  2.00  1.00  XCEPT AS NOT OBC SENTENCE	Design of space m² per person  Design of space  m² per person  SUPPORTING ASSEMBLY (H) N/A  45 min  CONSTRUCTION TYPE  Combustible Permitted  Combustible Permitted	NONCOMBUSTIBLE IN LIEU OF RATINGS N/A NO N/A YES CLADDING TYPE Combustible Permit Combustible Permit Combustible Permit Noncombustible Rec Combustible Permit Noncombustible Rec Combustible Permit Noncombustible Rec Combustible Permit Fixtures PROVIDED	3.8. 3.3.1.2.8 3.3.1.19. 3.2.2.20.6 3.2.1.4.  3.2.3
3.20 HAZARDOU  3.21 REQUIRED RATINGS  3.22 SPATIAL SE	S SUBSTANCE FIRE RESISTANCE  EPARATION  FIXTURE ENTS	L2 - OFFICE  L2 - STORAGE (3)  L2 - PRIVATE OFFICE  L2 - STAFF (EMPLOYEES FROM OTHER AREAS)  TOTAL  YES  NO  HORIZONTAL AS FLOORS OVER E FLOORS MEZZANINE ROOF  WALL  NORTH-WEST A  NORTH-WEST C  NORTH-EAST A  SOUTH-EAST A  SOUTH-EAST B  SOUTH-WEST C  RATIO: FLOOR  FLOOR  RATIO: FLOOR  FLOOR  RATIO: FLOOR  FLOOR  RATIO: FLOOR  FLOOR  RATIO: FLOOR  RATIO: FLOOR  LEVEL/AREA  L1 - PUBLIC (P) -	EBF AREA L.C (m²) 178.0 19.0 6.0 396.0 179.0 35.0 246.0 96.0 28.0	OF ST OF ST OF LCC OF ST OF LCC OF ST OF LCC OF ST OF LCC OF ST OF	ORAGE FICES UNGE HOR HAL 2.30 1.90 1.70 4.90 2.26 1.80 4.90 4.90 2.90 E 50:50 E CUPANT AD 174 8	N/A  45 min  N/A  45 min  REQUIRED FRR (H)  1.00  2.00  2.00  1.00  XCEPT AS NOTO SENTENCE  3.7.4.8 (2.A)	Design of space  m² per person  Design of space  m² per person  SUPPORTING ASSEMBLY (H)  N/A  45 min  CONSTRUCTION TYPE  Combustible Permitted  Ted OTHERWISE  FIXTURES REQUIRED  1MV1F  1 WC	NONCOMBUSTIBLE IN LIEU OF RATINGS N/A NO N/A YES  CLADDING TYPE  Combustible Permit Combustible Permit Combustible Permit Combustible Permit Noncombustible Rec Combustible Permit Noncombustible Rec Combustible Permit Noncombustible Rec In Non	3.8. 3.3.1.2.8 3.3.1.19. 3.2.2.20.6 3.2.1.4.  3.2.3
3.21 REQUIRED RATINGS  3.22 SPATIAL SE  3.23 PLUMBING REQUIREM  3.24 ENERGY EF	S SUBSTANCE FIRE RESISTANCE  EPARATION  FIXTURE ENTS	L2 - OFFICE  L2 - STORAGE (S)  L2 - PRIVATE OFFICE  L2 - STAFF (EMPLOYEES FROM OTHER AREAS)  TOTAL  YES  NO  HORIZONTAL AS  FLOORS OVER E FLOORS  MEZZANINE  ROOF  WALL  NORTH-WEST A  NORTH-WEST A  SOUTH-EAST A  SOUTH-EAST A  SOUTH-EAST B  SOUTH-WEST C  RATIO:  FLOOR  RATIO:  FLOOR  L2 - GROUP D ST	EBF AREA LE (m²) 178.0 19.0 6.0 396.0 179.0 246.0 96.0 28.0 MA	OF ST OF ST OF LCC OF ST OF LCC OF ST OF LCC OF ST OF LCC OF ST OF	ORAGE FICES UNGE HOR HAL 2.30 1.90 1.70 4.90 2.26 1.80 4.90 4.00 2.90 ECUPANT AD 174 8 E - ANSI/AS	N/A  45 min  N/A  45 min  REQUIRED FRR (H)  1.00  1.00  2.00  2.00  1.00  XCEPT AS NOTO OBC SENTENCE 3.7.4.8 (2.A) 3.7.4.7 (2)	Design of space  m² per person  Design of space  m² per person  SUPPORTING ASSEMBLY (H)  N/A  45 min  CONSTRUCTION TYPE  Combustible Permitted  Ted OTHERWISE  FIXTURES REQUIRED  1MV1F  1 WC	NONCOMBUSTIBLE IN LIEU OF RATINGS N/A NO N/A YES  CLADDING TYPE  Combustible Permit Combustible Permit Combustible Permit Combustible Permit Noncombustible Rec Combustible Permit Noncombustible Rec Combustible Permit Noncombustible Rec In Non	3.8. 3.3.1.2.8 3.3.1.19. 3.2.2.20.6 3.2.1.4.  3.2.3
3.21 REQUIRED RATINGS  3.22 SPATIAL SE  3.23 PLUMBING REQUIREM	S SUBSTANCE FIRE RESISTANCE  EPARATION  FIXTURE ENTS	L2 - OFFICE  L2 - STORAGE (3  L2 - PRIVATE OFFICE  L2 - STAFF (EMPLOYEES FROM OTHER AREAS)  TOTAL  YES  NO  HORIZONTAL AS FLOORS OVER E FLOORS MEZZANINE ROOF  WALL  NORTH-WEST A  NORTH-WEST A  SOUTH-EAST A  SOUTH-EAST A  SOUTH-EAST A  SOUTH-WEST B  SOUTH-WEST C  RATIO:  FLOOR LEVEL/AREA  L1 - PUBLIC (P) - L2 - GROUP D ST	EBF AREA LE (m²) 178.0 19.0 6.0 396.0 246.0 96.0 28.0 MA	OF ST OF ST OF LCC OF ST OF LCC OF ST OF LCC OF ST OF	ORAGE FICES UNGE HOR HAL 2.30 1.90 1.70 4.90 2.26 1.80 4.90 2.90 E = 50:50 E CUPANT AD 174 8 E - ANSI/A: T)	N/A  45 min  N/A  45 min  REQUIRED FRR (H)  1.00  2.00  2.00  1.00  XCEPT AS NOT OBC SENTENCE  3.7.4.8 (2.A)  3.7.4.7 (2)  SHRAE/IES 90.	Design of space  m² per person  Design of space  m² per person  SUPPORTING ASSEMBLY (H)  N/A  45 min  CONSTRUCTION TYPE  Combustible Permitted  Ted OTHERWISE  FIXTURES REQUIRED  1MV1F  1 WC	NONCOMBUSTIBLE IN LIEU OF RATINGS N/A NO N/A YES  CLADDING TYPE  Combustible Permit Combustible Permit Combustible Permit Combustible Permit Noncombustible Rec Combustible Permit Noncombustible Rec Combustible Permit Noncombustible Rec In Non	3.8. 3.3.1.2.8 3.3.1.19. 3.2.2.20.6 3.2.1.4.  3.2.3
3.21 REQUIRED RATINGS  3.22 SPATIAL SE  3.23 PLUMBING REQUIREM  3.24 ENERGY EF	S SUBSTANCE FIRE RESISTANCE  EPARATION  FIXTURE ENTS	L2 - OFFICE  L2 - STORAGE (3  L2 - PRIVATE OFFICE  L2 - STAFF (EMPLOYEES FROM OTHER AREAS)  TOTAL  YES  NO  HORIZONTAL AS FLOORS OVER E FLOORS MEZZANINE ROOF  WALL  NORTH-WEST A  NORTH-WEST A  SOUTH-EAST A  SOUTH-EAST A  SOUTH-EAST A  SOUTH-WEST B  SOUTH-WEST C  RATIO:  FLOOR LEVEL/AREA  L1 - PUBLIC (P) - L2 - GROUP D ST  COMPLIANCE PA CLIMATIC ZONE:	EBF AREA L.C (m²)  178.0  19.0  6.0  396.0  179.0  246.0  96.0  28.0  MA  FSTAFF (S) M  TAFF  ATH: PR  6-  Te-Resistance R	0. (m) L/H 18.50 18.50 19.60 15.60 7.50 7.50 7.50 RLE:FEMALE OCCUPATION (BANCROF	ORAGE FICES UNGE HOR H/L 2.30 1.90 1.70 4.90 2.26 1.80 4.90 4.90 2.90 1.74 8 E - ANSI/A	N/A  45 min  N/A  45 min  REQUIRED FRR (H)  1.00  2.00  2.00  1.00  XCEPT AS NOT OBC SENTENCE  3.7.4.8 (2.A)  3.7.4.7 (2)  SHRAE/IES 90.	Design of space  m² per person  Design of space  m² per person  SUPPORTING ASSEMBLY (H)  N/A  45 min  CONSTRUCTION TYPE  Combustible Permitted  Ted OTHERWISE  FIXTURES REQUIRED  1MV1F  1 WC	NONCOMBUSTIBLE IN LIEU OF RATINGS N/A NO N/A YES  CLADDING TYPE  Combustible Permit Combustible Permit Combustible Permit Combustible Permit Noncombustible Rec Combustible Permit Noncombustible Rec Combustible Permit Noncombustible Rec In Non	3.8. 3.3.1.2.8 3.3.1.19. 3.2.2.20.6 3.2.1.4.  3.2.3

 REVISIONS AND ISSUES
 DATE
 BY

 1
 REVISED SPA
 210809
 AB

 2
 ISSUED FOR TENDER
 210824
 AB

 3
 REVISION TO BUILDING PERMIT
 220315
 AB

 4
 SI-01
 220615
 AB

 5
 BLG SET-OUT CAD
 220715
 AB

 6
 ISSUED FOR CONSTRUCTION
 220715
 AB

 7

MJMA

maclennan jaunkalns miller architects

425 adelaide street west level 6 toronto ontario m5v 3c1 416 593 6796

www.mjmarchitects.com

TRITON ENGINEERING SERVICES LTD

CIVIL ENGINEERS

229 BROADWAY, UNIT 1

ORANGEVILLE, ONTARIO, L9W 1K4

TEL 519 941 0330 FAX 519 941 1830

TEL 519 941 0330 FAX 519 941 7

STRUCTURAL ENGINEERS

134 PETER STREET, SUITE 1301
TORONTO, ONTARIO, M5V 2H2
TEL 416.593.5300 FAX 416.593.4840


SMITH + ANDERSON MECHANICAL AND ELECTRICAL ENGINEERS

1100 - 100 SHEPPARD AVENUE EAST TORONTO, ONTARIO, M2N 6N5
TEL 416.487.8151 -

## SAYERS FOOD LIMITED

132 BURLEIGH STREET t: 705.656.4531 e: sayers@apsley.ca

ARROW

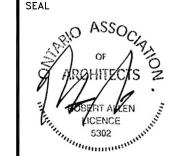

PROJECT TITLE

NEW SAYERS FOOD STORE BURLEIGH STREET, APSLEY

RAWING TITLE

OBC MATRIX


AS SHOWN

JULY 15, 2022

PROJECT NUMBER
2102

DRAWING NUMBER



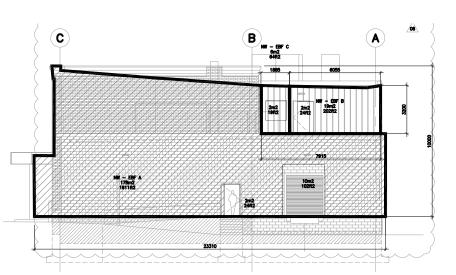

#### NORTH-WEST FACE A

178m2 = EXPOSED BUILDING FACE

18.5m = LIMITING DISTANCE

2.3 = L/H = MAX. UNPROTECT. OPENING (3.2.3.1.C) 6.7%

= ACTUAL UNPROTECT. OPENINĠ = REQ. FRR (3.2.3.7)

NON/C = REQ. CONSTRUCTION TYPE (3.2.3.7) NON/C = REQ. CLADDING TYPE (3.2.3.7)

#### NORTH-WEST FACE B

= EXPOSED BUILDING FACE

18.5m = LIMITING DISTANCE

1.9 = L/H = MAX. UNPROTECT. OPENING (3.2.3.1.C)

10.5% = ACTUAL UNPROTECT. OPENING 0 HR = REQ. FRR (3.2.3.7)

NON/C = REQ. CONSTRUCTION TYPE (3.2.3.7)NON/C = REQ. CLADDING TYPE (3.2.3.7)

#### NORTH-WEST FACE C

= EXPOSED BUILDING FACE


18.5m = LIMITING DISTANCE

1.7 = L/H

= MAX. UNPROTECT. OPENING (3.2.3.1.C) 33%

= ACTUAL UNPROTECT. OPENING = REQ. FRR (3.2.3.7) 0 HR

NON/C = REQ. CONSTRUCTION TYPE (3.2.3.7) NON/C = REQ. CLADDING TYPE (3.2.3.7)

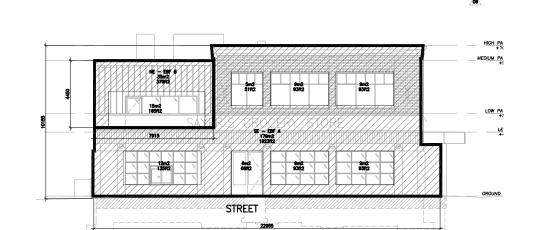

= EXPOSED BUILDING FACE

= LIMITING DISTANCE 2.26

= L/H = MAX. UNPROTECT. OPENING (\*3.2.3.10)

= ACTUAL UNPROTECT. OPENINĠ 33%

= REQ. FRR (3.2.3.7) NON/C = REQ. CONSTRUCTION TYPE (3.2.3.7)

NON/C = REQ. CLADDING TYPE (3.2.3.7)

#### SOUTH-EAST FACE B

= EXPOSED BUILDING FACE

= LIMITING DISTANCE

1.8 = L/H = MAX. UNPROTECT. OPENING (3.2.3.1.C)


= ACTUAL UNPROTECT. OPENING

= REQ. FRR (3.2.3.7)


NON/C = REQ. CONSTRUCTION TYPE (3.2.3.7)

NON/C = REQ. CLADDING TYPE (3.2.3.7)


SPATIAL SEPERATION/EXPOSURE ANALYSIS

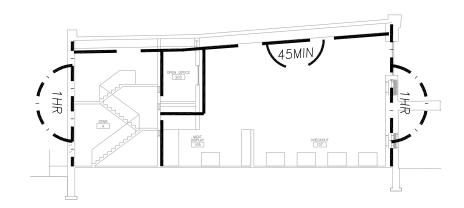

8 BUILDING SECTION - LIFE SAFETY 1:250

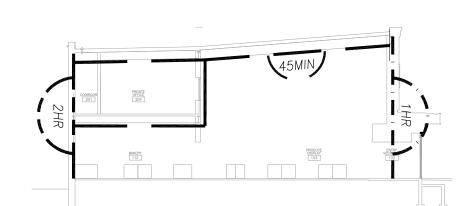

7 BUILDING SECTION - LIFE SAFETY 1:250

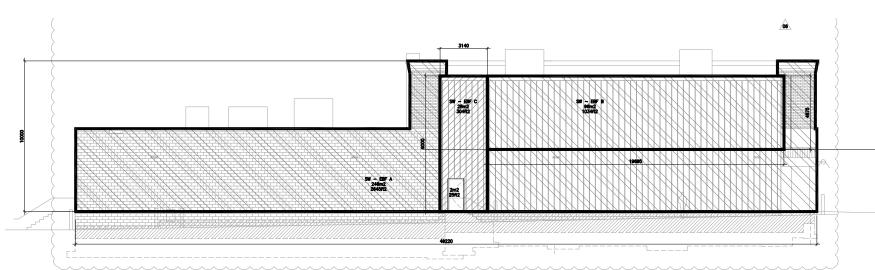

#### SOUTH-WEST FACE A

246m2 = EXPOSED BUILDING FACE

= LIMITING DISTANCE

= L/H 4.9 12% = MAX. UNPROTECT. OPENING (3.2.3.1.C)

= ACTUAL UNPROTECT. OPENING 0% 2HR = REQ. FRR (H)

NON/C = CONSTRUCTION TYPE = CLADDING TYPE

#### SOUTH-WEST FACE B

= EXPOSED BUILDING FACE

7.5m = LIMITING DISTANCE

= L/H

22% = MAX. UNPROTECT. OPENING (3.2.3.1.C) = ACTUAL UNPROTECT. OPENING

= REQ. FRR (3.2.3.7)

NON/C = REQ. CONSTRUCTION TYPE (3.2.3.7) NON = REQ. CLADDING TYPE (3.2.3.7)

#### SOUTH-WEST FACE C

= EXPOSED BUILDING FACE


7.5m = LIMITING DISTANCE

2.9 = L/H 58% = MAX. UNPROTECT. OPENING (3.2.3.1.C)

7.1% = ACTUAL UNPROTECT. OPENING

1HR = REQ. FRR (3.2.3.7)

NON/C = REQ. CONSTRUCTION TYPE (3.2.3.7) NON/C = REQ. CLADDING TYPE (3.2.3.7)

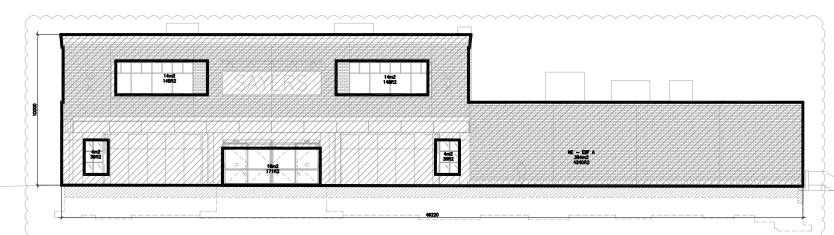


#### NORTH-EAST FACE A

= EXPOSED BUILDING FACE


= LIMITING DISTANCE

= MAX. UNPROTECT. OPENING (3.2.3.10)


= ACTUAL UNPROTECT. OPENINĠ = REQ. FRR (3.2.3.7) NON/C = REQ. CONSTRUCTION TYPE (3.2.3.7) = REQ. CLADDING TYPE (3.2.3.7)

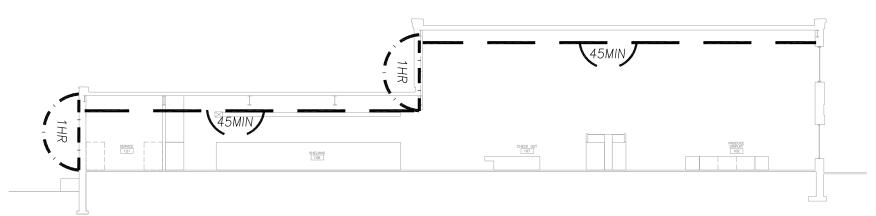

6 BUILDING SECTION - LIFE SAFETY 1:250

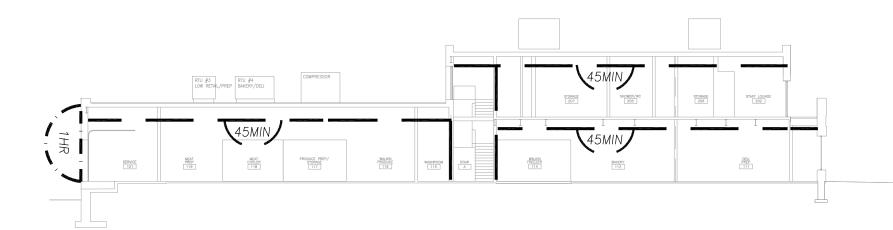

5 BUILDING SECTION - LIFE SAFETY 1:250

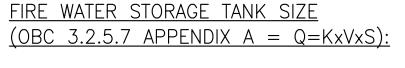

=K (WATER SUPPLY COEFFICIENT) 7,375 m3 = V (TOTAL BUILDING VOLUME)=S (TOTAL SPATIAL COEFFICIENT)

159,218L = Q (MIN. SUPPLY OF WATER)160,000L =PROPOSED SUPPLY OF WATER



#### <u>OBC - ENERGY EFFICIENCY (SB-10)</u>

= PRESCRIPTIVE (2013 ANSI/ASHRAE/IES 90.1

CLIMATE ZONE = 6 (BANCROFT)

= MAINTAIN SLAB/WALL/FOOTING INSULATION PER FIGURE 5-1


STL CONNECT. = MAX 2% OF EXTERIOR AREA OR THERMAL BREAKS


BUILDING BASES = MAX. UN-INSULATED = 200mm

#### BUILDING ENVELOP REQUIREMENTS (CLIMATE ZONE 6, (A,B)(I-P)

ELEMENT	TYPE	ASSEMBLY MAX.	U-VALUE	INSULATION MIN. R-VALUE
ROOF	INS. ENTIRELY ABOVE DECK	U-0.029		R-35 ci
WALLS	STEEL FRAMED	U-0.044		R-13 + R-15 ci
WALLS	BELOW GRADE	C-0.050		R-20 ci
SLAB-ON-GRADE	UNHEATED	F-0.459		R-15 for 48 in.
OPAQUE DOORS	SWINGING	U-0.45		
OPAQUE DOORS	NON-SWINGING	U-0.45		
FENESTRATION	NON-METAL FRAME	U-0.29	(MAX. SHGC 0.4, MIN.	VT/SHGC 1.10)
FENESTRATION	METAL FRAME: FIXED	U-0.38	'n	,
FENESTRATION	METAL FRAME: OPERABLE	U-0.45	"	
FENESTRATION	METAL FRAME: ENTRANCE DOOR	U-0.69	"	



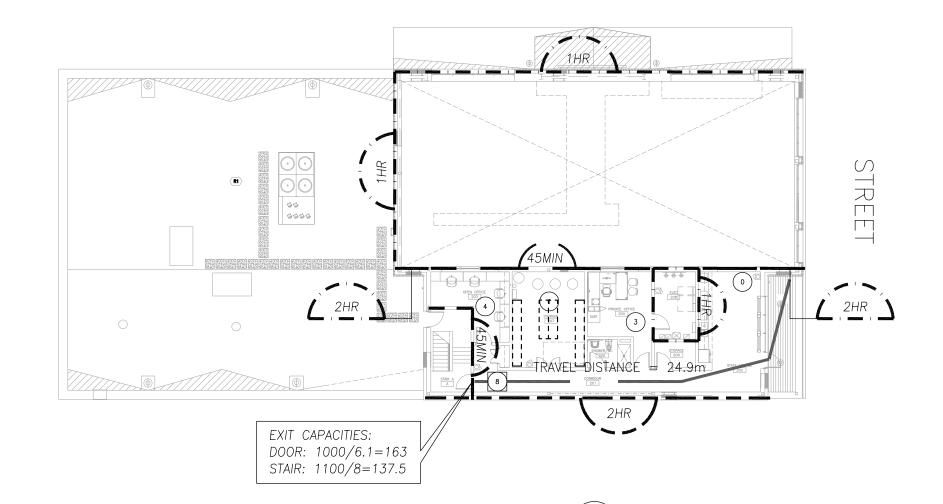

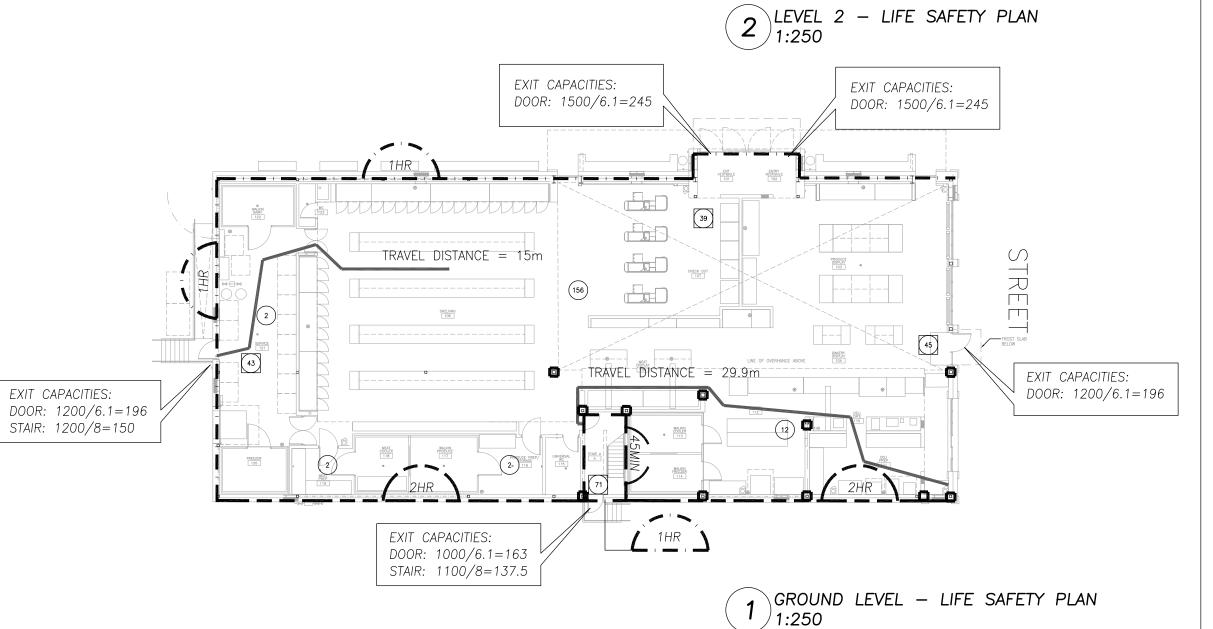

Contractor must check and verify all dimensions on the job, and report any discrepancies to the Architect before proceeding with the work. Do not scale this drawing.

REVISIONS	AND ISSUES		
REV	DESCRIPTION	DATE	ВУ
1	REVISED SPA	210809	AE
2	ISSUED FOR TENDER	210824	AE
3	REVISION TO BUILDING PERMIT	220315	AE
4	SI-01	220615	AE
5	BLG SET-OUT CAD	220715	AE
6	ISSUED FOR CONSTRUCTION	220715	AE
7			

# **MJMA**

maclennan jaunkalns miller architects

425 adelaide street west level 6 toronto ontario m5v 3c1 416 593 6796 www.mjmarchitects.com

#### TRITON ENGINEERING SERVICES LTD

CIVIL ENGINEERS 229 BROADWAY, UNIT 1 ORANGEVILLE, ONTARIO, L9W 1K4

TEL 519 941 0330 FAX 519 941 1830 BLACKWELL

STRUCTURAL ENGINEERS 134 PETER STREET, SUITE 1301 TORONTO, ONTARIO, M5V 2H2
TEL 416.593.5300 FAX 416.593.4840

SMITH + ANDERSON MECHANICAL AND ELECTRICAL ENGINEERS

1100 - 100 SHEPPARD AVENUE EAST TORONTO, ONTARIO, M2N 6N5 TEL 416.487.8151 -

#### SAYERS FOOD LIMITED

132 BURLEIGH STREET t: 705.656.4531 e: sayers@apsley.ca



NEW SAYERS FOOD STORE BURLEIGH STREET, APSLEY

DRAWING TITLE

LIFE SAFETY & CODE


JULY 15, 2022

AS SHOWN

PROJECT NUMBER

2102

DRAWING NUMBER

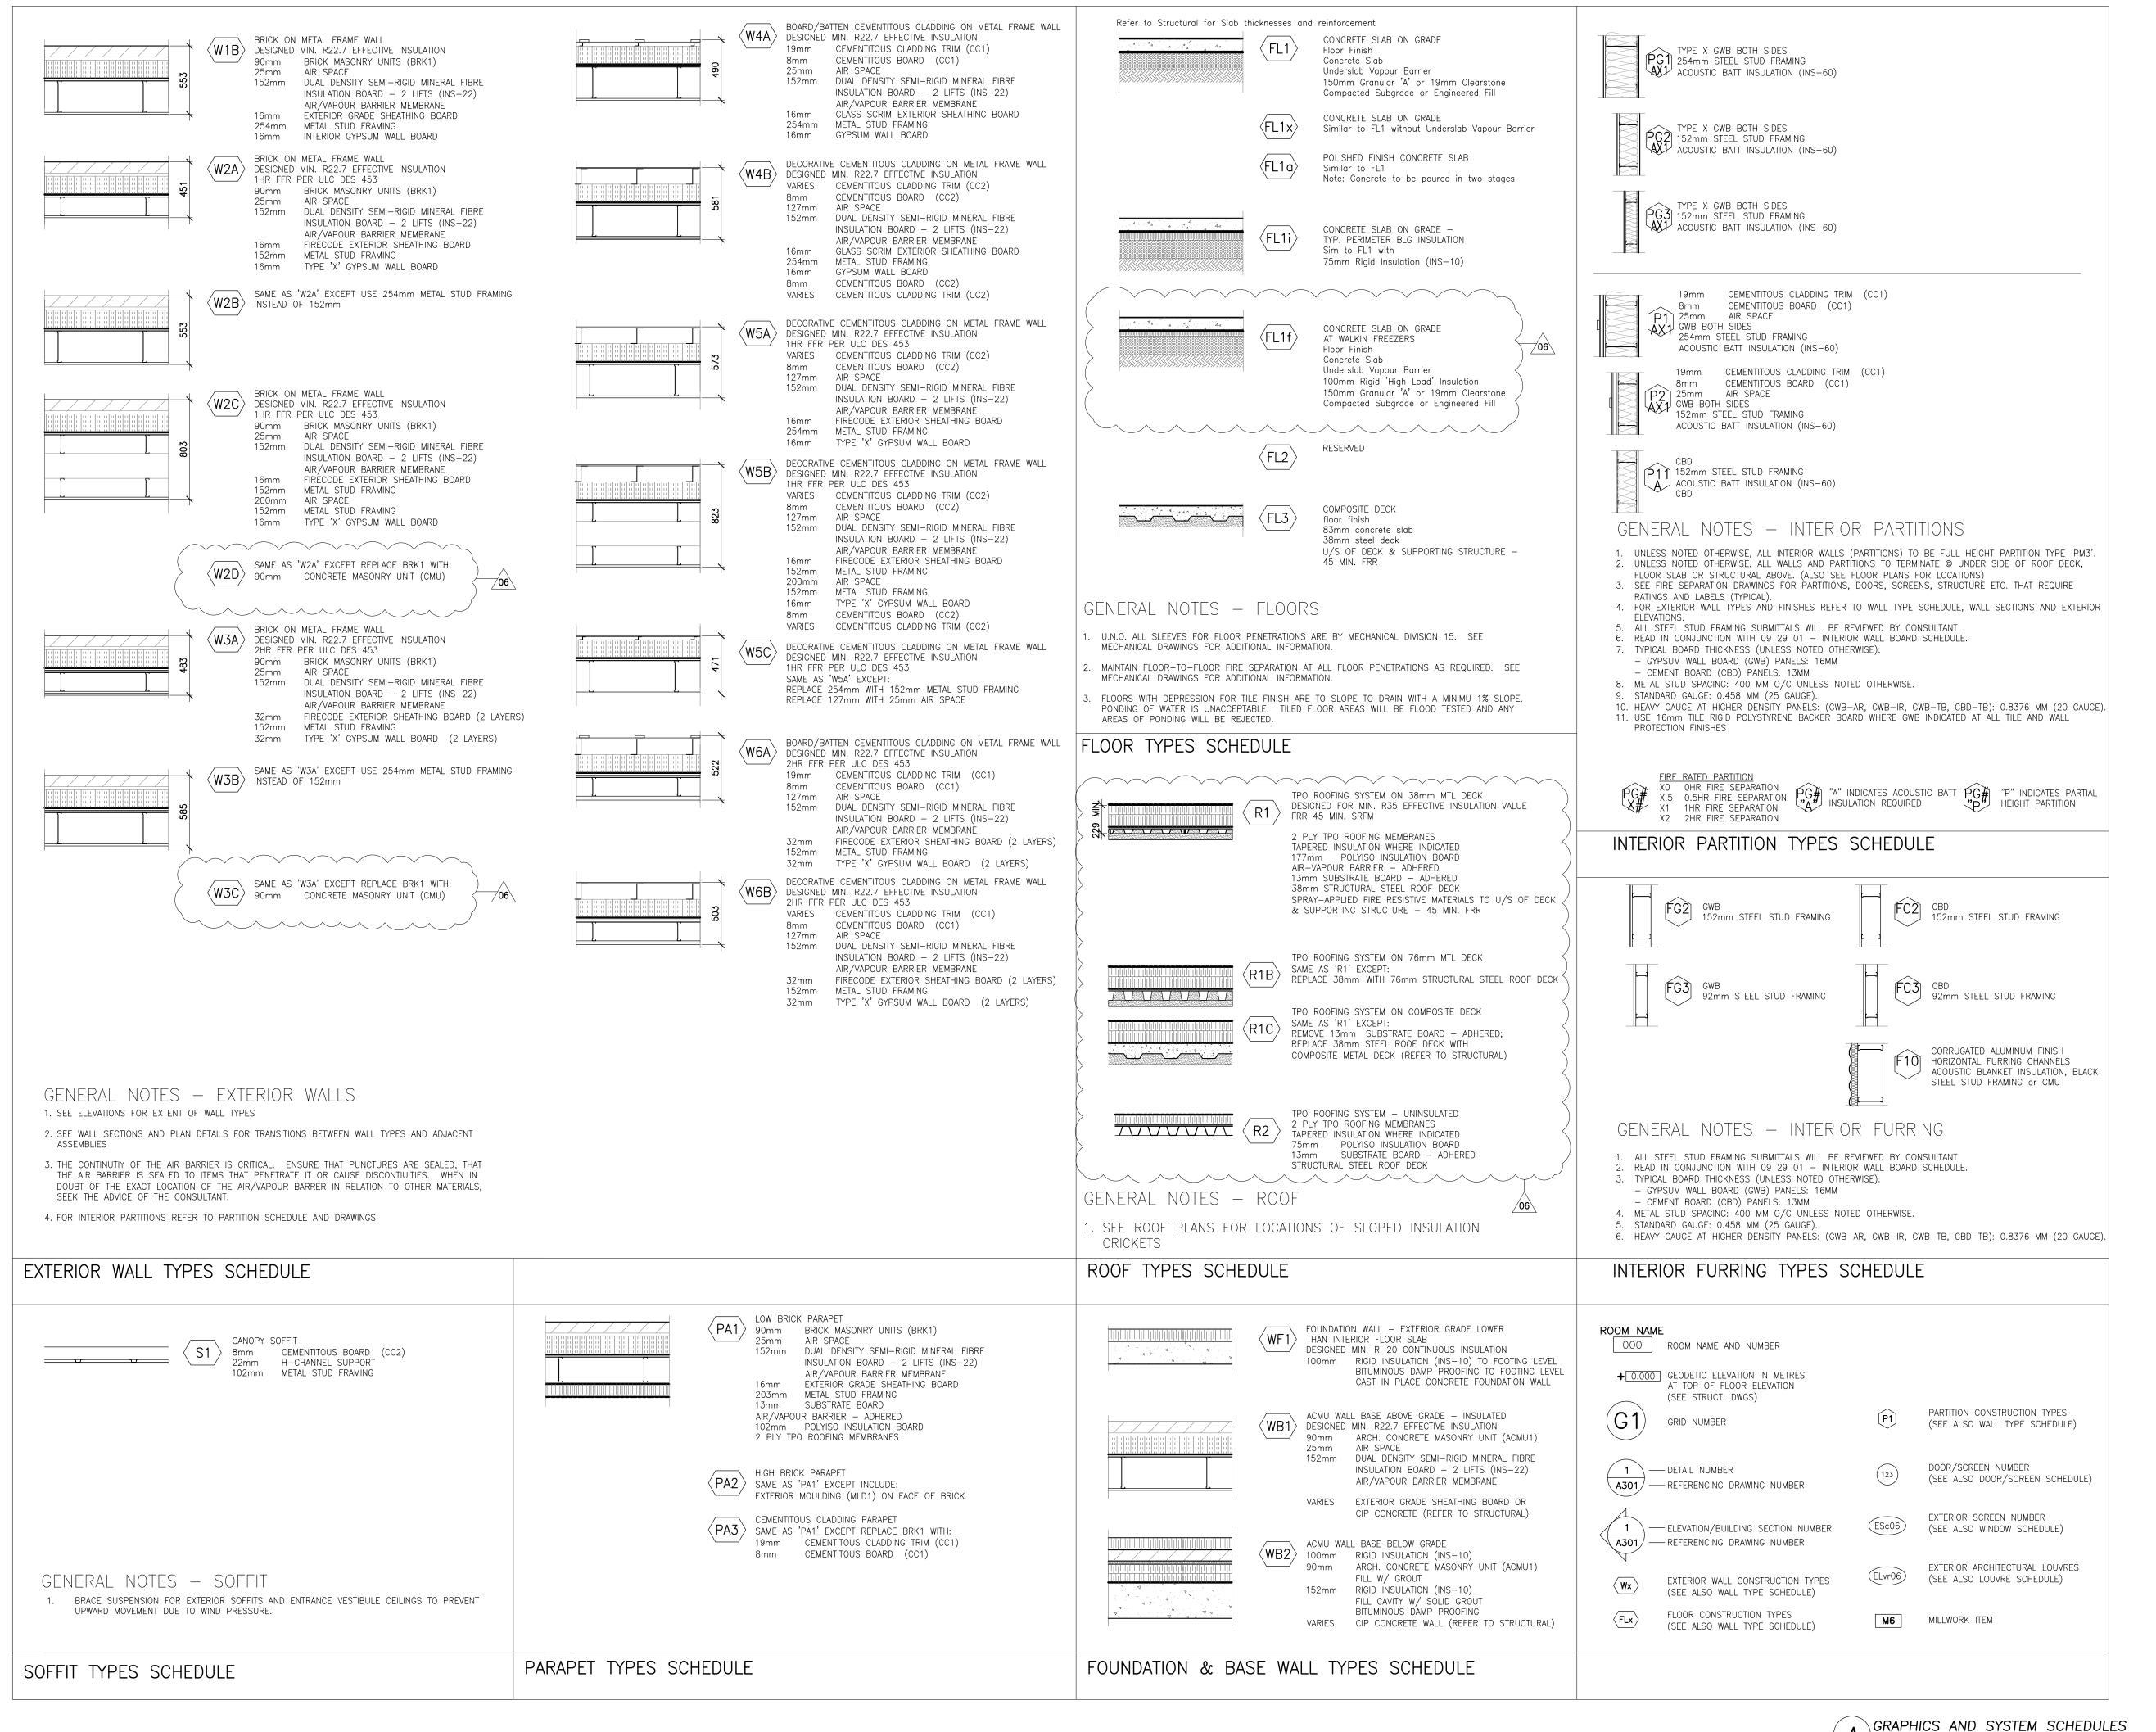

REVISIONS AND ISSUES DESCRIPTION DATE REVISED SPA 210809 ISSUED FOR TENDER 210824 REVISION TO BUILDING PERMIT 220315 220615 SI-01 BLG SET-OUT CAD 220715 ISSUED FOR CONSTRUCTION 220715

MJMA

maclennan jaunkalns miller architects

425 adelaide street west level 6 toronto ontario m5v 3c1 416 593 6796 www.mjmarchitects.com

TRITON ENGINEERING SERVICES LTD

CIVIL ENGINEERS 229 BROADWAY, UNIT 1 ORANGEVILLE, ONTARIO, L9W 1K4

TEL 519 941 0330 FAX 519 941 1830

BLACKWELL STRUCTURAL ENGINEERS

134 PETER STREET, SUITE 1301 TORONTO, ONTARIO, M5V 2H2 TEL 416.593.5300 FAX 416.593.4840

SMITH + ANDERSON MECHANICAL AND ELECTRICAL ENGINEERS

1100 - 100 SHEPPARD AVENUE EAST TORONTO, ONTARIO, M2N 6N5 TEL 416.487.8151 -

SAYERS FOOD LIMITED

132 BURLEIGH STREET t: 705.656.4531 e: sayers@apsley.ca

NORTH ARROW

NEW SAYERS FOOD STORE BURLEIGH STREET, APSLEY


DRAWING TITLE

ASSEMBLIES & FLOOR TYPES

JULY 15, 2022

PROJECT NUMBER 2102

DRAWING NUMBER

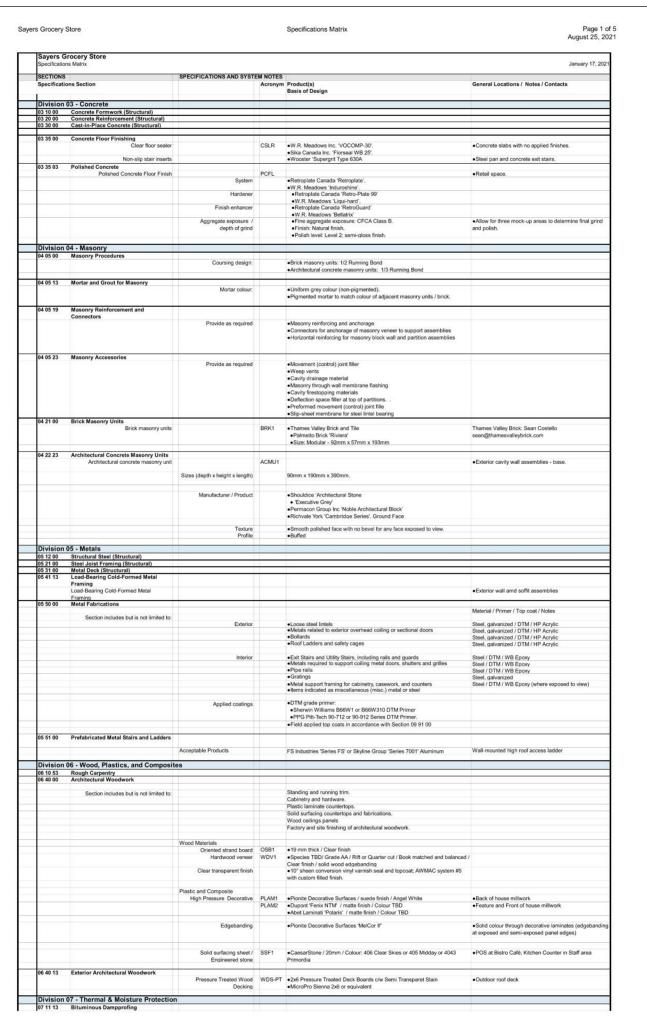


rs Grocery S				Specifications Matrix	Page August 25,
SECTIONS Specificatio		SPECIFICATIONS AND SYSTE		Product(s)	General Locations / Notes / Contacts
	Prefinished steel flashing		+-	Basis of Design Minimum thickness:	
				●0.61 mm (0.0239*) (24 gauge), colour TBD.	
07 81 00	Sprayed Fire-Resistive Materials (SFRM)				
	At Contractor's option, use either type of spi	rayed fire resistive materials specit	iod, but uso	only one type throughout the Work.	
	Cementitious Fireproofing (Wet-Mix)	Standarc density	+	AD Fire ⊃rotection Systems 'Southwest Fireproofing Type 5GP'.	
				GCP Applied Technologies 'Monokote MK-6'.  Isolatek nternational 'Cafco 300'  GCP Applied Technologies 'Monokote MK-6'.  Isolatek nternational 'Cafco 300'  GCP Applied Technologies 'Monokote MK-6'.  Isolatek nternational 'Cafco 300'  GCP Applied Technologies 'Monokote MK-6'.	
		Medium density		A/D Fire Protection Systems Inc. 'Southwest Fireproofing Type 5MD'. GCP Applied Technologies 'Z-106 G'.	
				Isolatek nternational 'Cafco 400'.	
	Minera-Fibre Fireproofing (Dry-Mix)		1	AD Fire Protection Systems 'A/D Type FP'.  AD Fire Protection Systems 'A/D Type FP'.	
				Isolatek nternational 'Cafco Blaze-Shield DCF'.     Isolatek nternational 'Cafco Blaze-Shield II'.	
07 84 00	Joint Firestopping and Smoke Seals		_	Soldier Heritatorial Guico Glazo Gridon II.	
07 92 00	Joint Sealants  Acceptable manufacturers		1	•BASF	
	Acceptable mand acturers			DOWSIL     Momentive	
				●Sika	
			1	•Tremco	
	Exterior sealants	Joints in vertical surfaces Horizontal trafficable joints	+	Sika 'Sikasil WS-290' Sika 'Sikaflex 15LM	
	Interior sealants		$\pm$	•Sika 'Sikaflex 1A'	
		Movement joints in vertical surfaces		Sika 'Sikaflex 15LM'	
		Mildew resistant one part silicone sealant		•Sika 'Sikasil GP'	
	Schecule				
		Exterior			Perimeters of exterior openings     Movement and control joints
					Exterior joints between mascriry and insitu concrete.     Exterior joints in horizontal wearing surfaces.
					<ul> <li>Perimeters of louvres.</li> </ul>
					<ul> <li>Perimeters of mechanical and electrical penetrations</li> </ul>
		Interior	_		Movement and control joints     Interior control and expansion joints in floor and wall
					<ul> <li>Interior control and expansion joints in floor and wall surfaces.</li> </ul>
					Perimeters of exterior door and window frames.     Exposed interior control joints in gypsum board.
		Interior - mildaw resistant	+		Millwork junctions with walls     Perimeter joints of wet fixtures
					Counter/wall junctions at countertops     Food preparation areas
Division 0	08 - Openings				
08 11 13	Steel Doors and Frames (HM)  Acceptable manufacturers			◆All Steel Doors 2000 Ltd.	
				Apex Industries Inc. Artek Door (1985) Ltd.	
				Daybar Industries Ltd.	
				Fleming-Baron Door Products. Gensteel Doors.	
				M.c. Daley Manufacturing Co. Ltd.     Shanahan's Manufacturing Ltd.	
				Tril ium Steel Doors Limited.  Nis on Hollow Metal Limited.	
	Steel doors and panels				
		Exterior and insulated doors		Face sheets fabricated from 1.34 mm (0.053") (16 gauge) steel.     Steel stiffened core.	
				<ul> <li>Longitudinal edges continuously walded the full height of the door, filled and ground smooth with no visible seams.</li> </ul>	
				◆Insulation core: Polyisocyanurate.	
		Interior and non-insulated doors and panels		Face sheets fabricated from '.06 mm (0.042") (18 gauge) steel     Honeycomb core.	
1	Frames	Exterior and thermally broken		Lor gitudinal edges mechanically interlocked.  1.34 mm (0.053") (16 gauge) steel.	
		frames Interior frames		•1.34 mm (0.053") (16 gauge) steel.	
	Finish		$\overline{}$	Mirimum Galvanneal coating designation ZF120 (A40).	
OB 11 13	Fire Rated Glass and Framing		+		
1	Acceptable manuracturer			Technical Glass Products (TGP)	Cornor Martin
		Fire-rated steel framing	_	TCD 'Eisefram on Designar's Country of the country	Tel: 416-312-1059
	Framing Finish		$\pm$	TCP 'Fireframes Designer Series' fire-rated narrow profile framing Powder coating to match colour CC1	
	Glass	Fire-rated glass		TGP 'Fire_ite' 5 mm (3/16") fire-rated glazing, Standard Grade.	
	Rating			45 minutes	
OB 13 00	Steel Traffic Doors		$\pm$		
	Interior traffic dcors			Sennecs Holcings - Chase Doors, Series: Durulite Retailer     Bumpers: Tear Drop	Bruce Nakamura bnakamura@senneca.com
				Window Package: Standard Single Aluminum Lower Hinge Guard	
				•Fasteners: Steel Jamb •Gaskets Full	
				Seals: Standard 2* Inner Hinne Seal: 180 y 90 degrees.	
08 14 00	Wood Doors		1	CHILDE CHILD CHILD MITTERS	
00 14 00	Wood poors  Wood entry door and sidelight		WED1	Lepage Millwork 'Craftsman'     Single Decryith Pight Side Light and Postangular Transom	◆Front entry door
				Single Door with R ght Side Light and Rectangular Transom     Infili: Door Glass Panel Infili	Lepage Millwork
				Sidelites: Glass Infill     Door and Frame Finish: Mahogany – Rawhide; Saddle; Natural; Charcoal	jim@haliburtonlumber.ccm
				Hardware: Baldwir Collection – Classic     Sill Anodzied Bronze, brass or Aluminum or similar	https://www.lepagemillwork.com/en-ca/
1			$\pm$		
an c - · ·	Overhead Sectional Doors			Refer to Section 11 13 19 - Leading Dock Accessories     Refer to Drawing A700	
OB 3313			$\pm \overline{}$	Overhead motorized insulated steel sectional doors w/ acrylic glazing	
08 3313 08 42 29	Automatic Sliding Entrance Doors	AUTOMATIC SLIDING DOOR	SED1	Horton Automatics, "Proslide Series 2021", sliding door system with electric belt drive operator	
	Automatic Sliding Entrance Doors Automatic Sliding Door		1	Door type: 310 - SX & SD     Optext i-oneXT motion/presence detectors and m/s manual locking	Nick Gaudet ngaudet@hortonontario.com
				Fin sh: FPG Duranar XL, custom colour	905-331-7491 x122
	Automatic Sliding Door		CW1	●Fin.sh: PPG Duranar XL. custom colour	
08 42 29	Automatic Sliding Door		CW1	Fin sh: FPG Duranar XL_custom colour  Alumicor ThermaWall TW2200 Series; capped and Structural Silicone Glazad (SSG), thermally broken assembly, sizes as indicated	905-331-7491 x122 ◆Exterior - Refer to drawing A710.
08 42 29	Automatic Sliding Door		CW1	Finsh: FPG Duranar XL custom colour  Alumicor ThermaWall TW2200 Series', capped and Structural Silicone	
08 42 29	Automatic Sliding Door		CW1	Fin sh: FPG Duranar XL custom colour      Alumicor ThermaWall TW2200 Series', capped and Structural Silicone Glazad (SSG), thermally broken assembly, sizes as indicated     Fin sh: FPG Duranar XL, custom colour      Alumicor 'Shadowline 970, thermally broken assembly, sizes as indicated.	
08 42 29	Automatic Sliding Door  Aluminum-Framed Glazing Systems  Curtainwall			Fin sh FPG Duranar XL custom colour      Alumicor ThermaWall TW2200 Series'; capped and Structural Silicone Glazad (SSG), thermally broken assembly, sizes as indicated     Fin sh FPG Duranar XL, custom colour	●Exerior - Reter to drawing A710.
08 42 29	Automatic Sliding Door  Aluminum-Framed Glazing Systems  Curtainwall			Fin sh: FPG Duranar XL custom colour      Alumicor ThermaWall TW2200 Series', capped and Structural Silicone Glazad (SSG), thermally broken assembly, sizes as indicated     Fin sh: FPG Duranar XL, custom colour      Alumicor 'Shadowline 970, thermally broken assembly, sizes as indicated.	●Exerior - Reter to drawing A710.

	SECTIONS		SPECIFICATIONS AND SYST			
	Specification				Product(s) Basis of Design	General Locations / Notes / Contacts
		Fluid -Applied EpoxyFlooring		EPFC2	Stonhard "Stonshield HRI" with broadcast / "Stoneproof ME7" waterproofing     Colour: Steel grey	
		Base			■intsgral cove base, 6" high	
	09 91 00	Painting			■integral cove base, o nign  ——————————————————————————————————	
1	03 31 00	Scope	Non-paintable surfaces		Painting of interior and exterior paintable surfaces.  Vaterial and equipment furnished prime and finish painted.	
					**Termis surfaces of steel trains and stacks.  **Prayed firer-esistive materials.  **Prayed firer-esistive materials.  **Prayed firer-esistive materials.  **Prayed firer-esistive materials.  **Sulds on.  **Callass state], weathering steel, copper, bronze, chromium plate, nickel, anodized or facquered or mill finished aluminum, Monel metal.  **Issulds on.  **Class and plastic, except exposed PVC pizing.  **Prayed material finishes on sonry veneers.  **Vetallia and massic insulation finishes.  **Portaire material finishes on floors, stair treads, stair nosing and landings.  **Issulated electric cables.  **Vechined parts of machiney and equipment.  **Vechined for finish materials.	
1		Exterior Paint Systems Comontitious dadeing	Primer coat		Factory primod	
			Tcp coats (2 coats)		High Perfromance Acrylic (HP Acrylic):     Sherwin Williams Sher-Cryl HPA B66-351, semi-gloss.	
$\exists$		Interior Paint Systems HIPAC Latex:	Primer coat		As recommended by top coat manufacturer or as indicated below.	●Public areas
		High performance architectural latex	Tcp coats (2 coats)		Benjamin Moore Aura Waterborne Latex K52x series. Sherwin Williams Duration Interior Acrylic Latex A9x-1200 Series.	secretar of Malak
					Dulux Diamond 14220/15110 Interior Acrylic.	-Dayle of house areas for desired
		W8 Epoxy: Water based light ind ustrial coaling	Primer coat Top coats (2 coats)		As recommended by top coat manufacturer or as indicated below.     Berijamiii Moire Corolled i Prie-Calalyzed Welerburne Epuxy V34 * / V342     Sherwin Williams Pre-Catalyzed Waterbased Epoxy K45 / K46-150 Series.     PPP Pit-Glaze WB1 Intanor Pre-Catalyzed Water-Borne Epoxy 13-310 / 16-510.	Back of house areas, food prep areas, washrooms.
		Metal fabrictions	Primer coat  Top coats (2 coats)		DTM Rust Inhibitive Primer Strewin Williams B66W1 or B66W310 DTM Primer. PPG Ptt-Tech 90-712 or 90-912 Series DTM Primer. HHAC Latex	Steel dcors and frames and miscellaneous items including pipes, ducts, equipment and related brackets and supports). Includes factory primed and galvanized or galvanneal metal.
$\exists$		Primed Miscellaneous Metals and	Primer coat		WB Epoxy     In accordance with Section 05.50 C0 and as recommended by top coat	
		Architectural Metals supplied by Division 05.	1111101 0000		manufacturer	
			Tcp coats (2 coats)		HIFAC Latex     WB Epoxy	◆Refer to Section 05 50 00 for locations
		Dressed lumber	Primer coat		◆PPG Dulux Gripper #60000	
		Cungum hoord	Tcp coats (2 coats)  Primer coat		HIFAC Latex     Dulux X-pert #11000 or Dulux Ultra Zero VOC #97300	
		Gypsum board	Tcp coats (2 coats)		HIPAC Latex     WB Epoxy	
		Colour schecule		PT1	Benjamin Moore: Chantilly Lace #2121-70	
				PT2 PT3	TBD TBD	
		0 - Specialties Pre-manufactured shower enclosure				
		Shower alcove base and backwalls			-Model: DreamLine QWALL-5 Shower Base and Backwalls – 60" -QWall 5 Backwalls and Single Throshold SlimLine Base -Size: 34'Dx6'Wx76'3'Drein Location Right -Colour White -Colour White	
	10 26 23	Wall and Door Protection  Wall and door protection	Panel	WP1	Altro Puraguard 4'x9' (W139) or 4'x10' (W135) panel.  Colour: White	Altro: Chris Johnson cjohnson@altro.com
			Accessories		Continuous joint strips Start + edge trim Estamal / internal conneners Stainless steel corners Cap strips Altrollia_naklests  Altrollia_naklests	416-428-3964
	10 28 00	Washroom and Janitor Accessories				
		Schecule	Grab Bars	GRB1	Bobrick 38mm Diameter Straight Grab Bar, 610mm (Horizontal)	
			0.130 Data	GRB2	Bobrick 38mm Diameter 90 Degree Grab Bar, 762mm x 762mm     Fnish: Type 304 stainless steel with 'NAAMM Brushed No.4' finish with	
			Hanc Dryer	HCD1	*knurled gripping surface  • Dyson Arblade V	
4			Traile Diyer		●F nish: Sprayed nickel	
			Mirror		Bobrick B-165 2436, 610mm x 910mm	
			Soap Dispenser		•TBD	
			Toilet Pener - Jolder	TPH	Bobrick: Limbo-Roll Surface-Mounted Toilet Tissue Dispenser B-2890'	
νI	$\Delta$		<u> </u>			
7		1 - Equipment Loading Dock Leveler and Accessories			Serco - Referto Drawing A700	
				Н		
		2 - Furnishings Entrance Floor Mat Entrance Floor Mat				●Entry Vestibules

Sayers Grocery			Specifications Matrix	Page September 29
			Construct typical wall assembly installation showing all applicable details.	
		-		
0	7 46 46	Cemen	l titious Cladding	
			Construct minimum 10 m2 (100 ft2) area of each typical wall assembly installation	
			showing all applicable details.	
	7 62 00	Metal F	Flashing	
	7 02 00		Provide on-site mock-up of the following:	
			Coping flashing.      Roof edge flashing.	
			Counter flashing.	
			Fascia flashing.     Special flashing conditions	
	0 24 00	Tiling		
	9 31 00	Tiling	Provide grouted mock-up: 1220 mm x 1220 mm (48" x 48") sample panels of each tile type and	
			colour, texture, size, and pattern of tile and grout.	
			Install each product and colour mock-up for acceptance by Consultant. Accepted	
			mock-up shall form basis of standard of workmanship for remainder of work. Mock-up shall consist of floor/wall/base corner intersection including cove base inside and outside corners, with 300 mm	
			(12") of finish product on each face.	
H	9 65 13	Prema	nufactured Bases Premanufactured base mock-up shall include at least one inside corner, one	
			outside corner plus 3 m (10'-0") of straight run.	
0	9 65 18	Slip Re	esistive Vinyl SheetFlooring  Provide mock-up of sufficient size to indicate adhesion, joint welding, edge treatment, and coved	
			base.	
0	9 91 00	Paintin		
			Provide full finished mock-up installation of each paint colour, for indicated surfaces and mock-up size, showing colour and finish selected by Consultant, under lighting conditions matching final	
			area lighting, for acceptance by Consultant. Locate at Place of the Work as part of finished	
			installation if accepted.	
		Evteric	or Improvement	
		Concre	ete Reinforcement Submit engineered shop drawings for reinforcement	
		Cast-II	n-Place Concrete Submit certified mix designs for each type of concrete to be used, stating the specific	
			location, using structural element for which the mix applies and 305 mm (12") x 305 mm (12") sample of specified finish.	
		IVIetal F	Fabrication Submit engineered shop drawings of all exterior metal work, including, bollard, sign post, handrail	
			at cip concrete steps and ramp, and chain link fence. Provide in shop drawings plans, sections and	
			large scale details. Indicate components and methods of assembly, materials and their characteristics, fastenings, metal finishes, welds, and their structural characteristics relative to their	
			purpose, and other fabrication information required. Indicate site connections and methods.	
		0		
		Site Fu	umishing Submit engineered shop drawings and product data sheets of bench, movable planter & bench,	
			and tactile place.	
		Topsoi	 	
			Product data sheets: Submit data describing planting mix components and certificates indicating that	
			the materials meet specification requirements for review a minimum of 45 business days prior to	
			planned installation of planting mix. Samples:	
			Submit samples of planting mix components for approval a minimum of 45	
			business days prior to planned installation of planting mix with clear label on samples with relevant identifying characteristics including but not limited to the type of material, percentange of each	
			component materials, source and stockpile location, and manufacturer contact information.	
			Samples to be submitted for review and acceptance at the same time as test reports.	
1			Test reports:	
			Submit written laboratory test results for approval within 20 business days of approval of planting mix components.	
			The sample of th	

ayer	s Grocery S	Store			Specifications Matrix	Page 2 of August 25, 202	
	SECTIONS Specification	ns Section	SPECIFICATIONS AND SYSTE		Product(s)	General Locations / Notes / Contacts	
		Bituminous Dampprofing			Basis of Design  • Dampproofing coating: for ambient and substrate temperatures below 5°C:  • Primer: Penetrating asphalt primer, to CGSB 37-GP-9Ma-1983.  • Dampproofing coating: for ambient and substrate temperatures above 5°C:  • Mineral colloid asphalt emulsion: to CAN/CGSB 37.2-M88.	Proposition and Control of the Contr	
	07 21 00	Thermal Insulation					
		Thermal insulation for foundat	ion and below grade applications Rigid XPS insulation board	INS-10	Dow 'Styrofoam SM'     Corning 'Foamular C-300'.	Below grade vertical and horizontal applications.	
		Thermal insulat	on for wall and soffit applications Semi-rigid dual density mineral-fibre insulation board (cavity wall type).	INS-22	Rockwool 'Cavityrock'	Cavity wall assemblies. Rain screen assemblies.	
			ermal insulation for roof systems Rigid polyisocyanurate insulation board Flat and tapered	INS-52	◆Refer to Section 07 52 16	Roofing assemblies	
		Tr	ermal insulation for roof systems Mineral-fibre Acoustic Fire Batt (AFB)	INS-60	•Refer to Section 09 29 00	Gypsum board partitions.	
	07 21 29	Sprayed-Applied Foamed-on Place Insulation			BASF Building Systems 'Walltite – CM01'.		
		Spray foam insulation  Sprayed protective thermal barrier			Carlisle Spray Foam Insulation 'SeafTite One'.     Demillec Inc. 'Heatlok Soya HFO/Polarfoam SOYA HFO'.     Elastochem Specially Chemicalis Inc. 'Insulthane Extreme'.     Soprema 'Sopra SPF 202'.     Thermal barrier that meets the requirements of classification B when tested.	Soffit locations	
		VVQ-54250 4 18800 5500, -VV,000			in conformance with CAN/ULC-S124, "Test for the Evaluation of Protective Coverings for Foamed Plastic".		
	07 26 16	Below-Grade Vapour Barrier Underslab vapour barrier Air Barrier Systems			Minimum 0.38 mm (15 mils).  Stego Industries' Stego Wrap Vapor Barrier'.  W.R. Meadows 'PERMINATOR'.	•Interior concrete slabs on grade	
		Sheet-Applied, Vapour Impermeable Self- Adhesive Air/Vapour Barrier Membrane System		AVB	GCP Applied Technologies "Perm-A-Barrier Wall Membrane".     Henry Company Blueskin SA' and 'Blueskin SA LT     Soprema "Sopraseal Sick 1100 T".     W.R. Meadows 'Air Shield' and 'Low Temperature Air Shield'.	Exterior assemblies	
		Vapour permeable weather barrier membrane			SRP AirOutshield Wall.	Exterior assemblies - directly behind cladding panel	
	07 44 63	EPS Moulding with Cementitious Coating Parapet exterior moulding		MLD1	Canamould Exterior Mouldings		
		Parapet exterior invuturity		MEDI	Profile: BAN-012 / Size: 7 ½" x 24 ½"     C-Mold - Reinforcing Mesh & Cementitious Exterior Coating     Colour: Custom		
	07 46 46	Cementitious Cladding  Board and Batten cementitious cladding		CC1	Interior and Exterior Board and Batten Siding     Board: Hardie Panel Vertical Siding or Equivalent	Ross Corley Ross.corley@jameshardie.com	
					3. Board Thickness: 0.312" (8mm) 4. Finish: Cedar Mill 5. Colour: Colour Later Chosen By Consultant – From Non Standard 'Dream Colour Colour Later Chosen By Consultant – From Non Standard 'Dream Colour Colour Colection. Accessories: 6. Exterior Base at Grade: 100mm high Royal Board – 9760 SurEdge 7. Battens: Hardie Trim Batten Board – Rustic 19mm thick x 64mm Wide; maximum 12-0" lengths 6. Outside Corner: 54 101mmWx25mm Thick Hardie Trim Boards 9. Perimeter and Window Trim: 5/4 101mm x 25mm Thick Hardie Trim Boards 10. Flashing: Provide alumium flashing at all horizontal window trims 11. Trim Fasteners: Hardie plat taps for Concealed Fastening 12. Colour: To match Hardie Panel Vertical Siding 13. REFER TO HARDI TRIM MANUAL FOR TYPICAL TRIM, FLASHING AND INSTALLATION DETAILS		
		Cementitious cladding wth custom trim		CC2 EXTERIOR	Custom cuts to suit panelling design and profiles	https://www.jameshardie.ca/products/hardietrim- boards	
				CC2 INTERIOR	Printed for field painting     MDF FLAT PANEL     PANEL SIZE 4'X8" 1/2" THICK     CUSTOM CUT PANELS TO SUIT PANELLING DESIGN AND PROFILES		<u> </u>
		Trims	Exterior Interior		Miratoc EXTIRA Panels     Decorative Wood Trims	https://miratecextira.com/extira-exterior-panels https://monaghanlumber.com/wp- content/uploads/2016/10/Special-Order-Moulding- Catalogue.pdf	
$\sim$	07 54 23	Theromoplastic Polyolefin (TPO) Roofing	×		· · · · · · · · · · · · · · · · · · ·	* * * * * * * * * * * * * * * * * * * *	) ,
		SBS Modified Bitumen Roofing System			20		$\int Z$
		Extended warranty  Acceptable manufacturers			20 year total system warranty including labour, materials, and installation quality.     No dollar limit.     LEXCAN		
		Membrane installation	Acceptable application methods		Per Manufacturer's Recommendation		
							}
		Materials	Roof membrane		LEXCAN - Hi-Tuff TPO Membrane		)
			Substrate board /		■CGC Securork Brand - Control Class Mat Book Beauti		)
			Parapet sheathing board		CGC Securock Brand - Coated Glass-Mat Roof Board' Georgia Pacific 'DensDeck Prime Roof Board with Eonic Technology'  LEXCOR - PE-8 - Vapour Retarder Membrane		)
			Air and Vapour Barrier	INS-51	Rigid polyisocyanurate insulation board  CANVILC S704-11 Type 2 and Class 3 138 kPa (20 psi)		)
			Pre-cast concrete pavers		minimum compressive strength.  •Armtec 'Natural Small Diamond'		5
					•610 mm (24") square x 45 mm (1-3/4") height, slip resistant textured finish		/

	ECTIONS		SPECIFICATIONS AND SYST			Product(e)	General Locations / Nation (Cont
S	pecification	Sliding service window		SW1	$\rightarrow$	Product(s)  Basis of Design  ●Horton Automatics, 'Series 8900'.	General Locations / Notes / Contacts  • Exterior - Refer to drawing A710.
		Sharing Service William		3,441		Horon Automatics, Series seur.     Boor type: XO     Manual pull, thumb lock.	- Note: to starting A7 to.
╀			_	<u> </u>		●Finish: PPG Duranar XL, custom colour.	
08		Finish Hardware Glass and Glazing			=	Cash allowance	Refer to Drawing A710.
	5 60 00	Insulating glass unit		IGU		Double glazed, sealed insulating units:	Refer to Drawing A710.
						<ul> <li>Warm edge, hermetically sealed, CAN/CGSB 12.8-97, minimum 12 mm (1/2") air space, 90% argon/10% air filled, desiccant filled warm edge spacer.</li> </ul>	
$^{+}$						Low 'E' coating: VITRO 'Solarban 60'.	
+					$\dashv$	Warm edge spacer, stainless steel.  Prelco 'R-Max'	
F					$\exists$	Fenzi 'Chromatech Ultra'	
T		Glass types				Annealed glass Heat treated (tempered of heat strengthened) glass	
						Laminated glass	
ţ						PVB, not less that 0.76 mm (0.030") thick, clear.	
		9 - Finishes Metal Supports for Gypsum Board					
Ł			and cement board partitions, interi	orceilings	s, sha	Itwalls, and interior assemblies as indicated.	
09	9 29 00	Gypsum and Cement Board Schedule			$\dashv$		
Γ			Interior walls			<ul> <li>Impact resistant gypsum board, moisture and mould resistant, Type X,</li> <li>16mm thick.</li> </ul>	
T						CertainTeed 'Air-Renew Extreme Impact Resistant Board'.     GC C 'Sheetrock Brand Panels Mold Tough VHI Firecode X'	
						Georgia-Pacific 'DensArmor Plus Impact-Resistant Panel'.	
L					$\Box$	National Gypsum 'High-Impact XP'.  Lafarge 'Protecta HIR 300 Type X with Mold Defense'	
f			Interior ceilings			Abuse resistant gypsum board, moisture and mould resistant, Type X,	
+				$\vdash$	$\dashv$	16mm thick.  ◆CertainTeed 'Air-Renew Extreme Abuse Resistant Board'.	
						CGC 'Sheetrock Brand Panels Mold Tough AR'.     Georgia-Pacific 'DensArmor Plus Abuse-Resistant Panel'.	
						National Gypsum 'High-Abuse XP'.     I afarce 'Protecta AR 100 Type X with Mold Defense'	
ŧ			Tile backer board, interior			Alafarge 'Protecta AR 100 Type X with Mold Defense'  Glass scrimmed, Type X, 16mm thick.	
L			walls and ceilings	Щ_	_		
L						CertainTeed 'GlasRoc Diamondback Tile Backer'.     Georgia-Pacific 'Dens-Shield Tile Backer'.	
1			Exterior grade sheathing			Fibreglass mat faced, Type X, 16mm thick.	
						CertainTeed 'GlasRoc Sheathing'.     CGC 'Securock Glass-Mat Sheathing'.	
						Georgia-Pacific 'Dens-Glass Gold'.  Lafarge ;Weather Defense Platinum Sheathing'.	
Ŧ			Acoustic insulation	INIC 60	50	Alarge , weather Detense Haunum Sheatning .  Mineral-fibre acoustic fire batts.	
t			Acoustic insulation	843-01	~	<ul> <li>Johns Manville 'MinWool Sound Attenuation Fire Batts'.</li> </ul>	
L				Ц		Owens-Corning 'SAFB'.  Rockwool 'AFB'.	
t			Seamless drywall vents		$\dashv$	Vintage Grilles	http://canamould.com/wp/wordpress/wp-
						Pattern: Santa Fe or Herringbone.	content/uploads/2019/12/CANAGRILLE-brochure-1.pdf
09	9 31 00	Tiling			$\dashv$		
F		Schedule	Floor tile	TL01		◆Centura Tile 'Time 2.0'	Public washrooms
						◆Size: 300mmx300mm ◆Colour: TBD - Black #66T29NR or Grey #36T27NR or Carbon #36T28NR	Centura Tile: Elizabeth Livingston
						Colour. 100 - Disor #0012041C of Orey#0012744C of Calborn#0012041C	elivingston@centura.ca
t				TL02		Daltile or American Olean – Mosaic Colour Body Porcelain     Size:1" Hexagon	416-434-8626 ◆Front door mat
						Colour:Black A33 / Ice White A25	Daltile: Warren Booth
L						Custom hand laid pattern	warren.booth@daltile.com 905-738-2099
t			Wall and ceiling tile				
				TL 10		Centura Tile 'Vitra' Size:100mmx400mm 9016 Subway Tile	Washroom and Showe rareas     Kitchen prep areas
						Colour: Bright White Matte and Gloss mix (60%Matte / 30%Gloss)     Pattern: Vertical, 1/3 Offset Bond	
						Corner Trim: Schluter JOLLY, Brushed Anodized Aluminum, Satin Clear	
╀				TL11	$\dashv$	Centura Tile 'Concave' Size 1"x6" (12"x12" sheets)	Bistro Area feature tile ceiling and wall
						◆Size:3" x 4" x 6"	and the state of t
						Colour: Pottery White Mosaic BHTH01036 (TL11a) and/or Celadon Green Mosaics BHTH06096 (TL11b)	
$\dagger$				TL12	$\dashv$	Centura Tile 'Plain Colours'	Staff Kitchen backsplash
L						Size: 3" x 6"     Colour: White Ice IN08136M, matte	
f			Thinset mortar / bond coat -	H	$\dashv$	Laticrete 254 Platinum	
+			Walls and Floors Thinset mortar / bond coat -	$\vdash$		Mapei Ultraflex LFT Laticrete 254 Platinum	
+			Ceilings Epoxy grout	$\vdash$		Mapei Ultralite S2 Laticrete SpectraLock PRO	
$\vdash$			Epony grout	-		Kerapoxy CQ	
09	9 51 23	Acoustical Tile Ceilings  Acoustical Tiles		ACT	$\dashv$	Pooldon Sonar Square Lautin /TPD\ white	■Ctaff admin area
1		Acoustical Tiles		ACT1		Rockfon Sonar Square Lay-in, (TBD), white.  24" x 48" standard imperial sizes.	Staff admin area
#		Standard suspension system.				Armstrong 'Prelude XL 15/16" Exposed Tee System'.	
09	9 62 90	Tactile Warning Surface Indicators			$\exists$		
ľ		Tactile Warning Surface Indicator (TWSI) - Polymer				Detectable Warning Surface Tile: ◆Kinesik 'Eon Tile'.	Exit Stairs
						Surface mount tactile warning surfacing tiles with integral domes.	
09	9 65 13	Premanufactured Bases					
F		Rubber base				Tarkett 'Millwork Wall Finishing System', wall base.  Profile: 'Mandalay'	
						Height: 115 mm (4 1/2"), 76 mm ( 3"), 64 mm (2 1/2").     Thickness: 9.5 mm (3/8").	
-	0.65.40	Clin Decictive ) // mul Chart		Н_	$\dashv$	Inickness: 9.5 mm (3/8").     Colour: to later selection.	
US		Slip Resistive Vinyl Sheet Flooring					I God and a second a second and
		Slip Resistive Vinyl Flooring		SFT-0	U1	Colour: Dolphin K3010	Kitchen, Dishwashing, Prep areas
		_				●Heat welded seams	Altro: Chris Johnson cjohnson@altro.com
O.	9 65 60	Resilient Flooring		<b>Y</b>	$\triangleleft$	<b>Y YYYYY Y</b>	6-428-064
Ť		Resilient Flooring		RFL1		LVP to Beaulieu Seaside or Varia Series -	Kitchen and staff areas
1	$\searrow$		p~~~		$\wedge$		
+		Fluid Applied Floor Coatings					
09	9 67 00				$\rightarrow$		
09	9 67 00	Fluid -Applied Epoxy Flooring		EPFC	1	Stonhard 'Stonekote GS4' Colour: TBD	Back of house areas, exit stairs, under pedimat

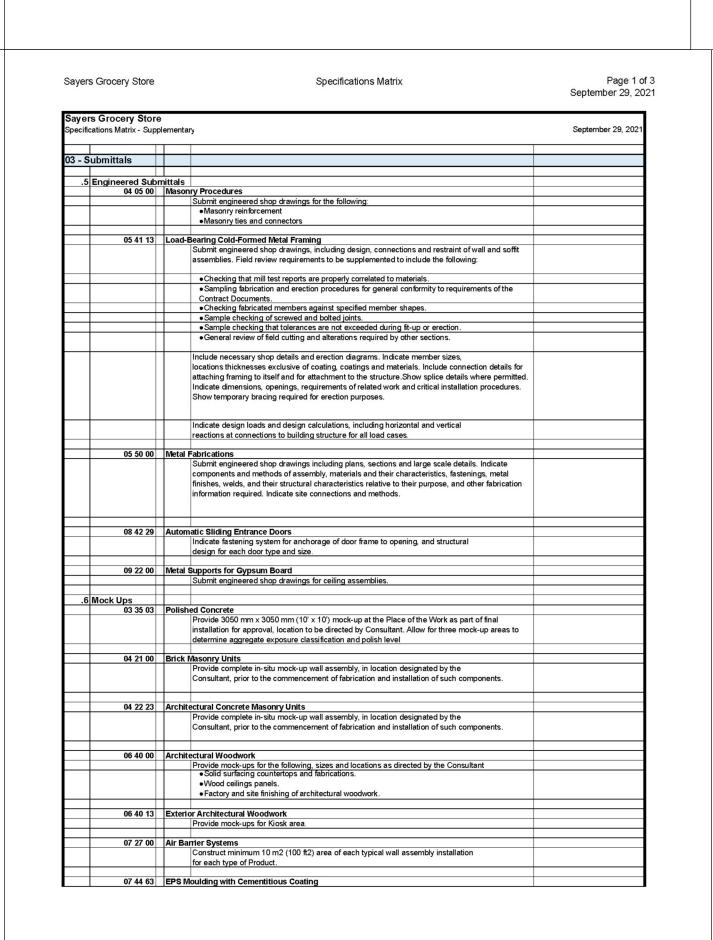

ayers Grocery Store	Specifications Matrix	Page : September 29,
	Unit Paving	
	Product data sheets:	
	Submit product data sheets for each paver type and colour	
	Shop drawings:	
	Submit shop drawings including bedding, bonding, jointing and setting details, and the	
	dimensions and identifying number of each piece of stone with indication of sizes, thicknesses,	
	dimensions, layout, finishes, compressive strength, joint and setting mix designs, jointing	
	clearances, clearanced between pavers and the adjacent building element.	
	Samples - paver:	
	Submit 6 full size samples of each paver type and colour to show texture, finish, and range of	
	colour to be supplied.	
	Samples - setting bed and joint fill material:	
	Submit samples of setting bed and joint filler material.	
	Design Calculations:	
	.1 Submit design calculations for paving assembly as prepared by qualified	
	professional engineer registered in the Place of the Work.	
	.2 Submit design calculations complete with references to codes and standards used	
	in such calculations, supporting the proposed design represented by the submittal.	
	Prepare calculations in a clear and comprehensive manner.	
	.3 Upon completion of the parts of the Work covered by the design calculations, the	
	professional engineer responsible for the preparation of the design calculations	
	and for undertaking the periodic field reviews described above, shall prepare a	
	letter of general conformity for those parts of the Work, certifying that they have	
	been provided in accordance with the requirements both of the Contract	
	Documents and of the authorities having jurisdiction over the Place of the Work.	
	Test data:	
	.1 Provide test certificates of tests carried out by an independent testing laboratory	
	verifying that stone meets the specifications, for each colour of stone. If certificates	
	are not available, retain an independent inspection and testing company to carry	
	out the tests, minimum of 3 specimens for each test unless otherwise specified in	
	ASTM. Submit test certificates to Consultant at least 8 weeks before commencing	
1	stone installation	
	.2 Provide certificate signed by manufacturer that the stone materials to be	
	supplied comply with specified performance characteristics and physical	

 REV
 DESCRIPTION
 DATE
 BY

 1
 REVISED SPA
 210809
 AB

 2
 ISSUED FOR TENDER
 210824
 AB

 3
 REVISION TO BUILDING PERMIT
 220315
 AB

 4
 SI-01
 220615
 AB

 5
 BLG SET-OUT CAD
 220715
 AB

 6
 ISSUED FOR CONSTRUCTION
 220715
 AB

 7
 B

 9
 10

 11
 11

# AMLM

maclennan jaunkalns miller architects

425 adelaide street west level 6
toronto ontario m5v 3c1
416 593 6796
www.mjmarchitects.com

#### TRITON ENGINEERING SERVICES LTD

CIVIL ENGINEERS

229 BROADWAY, UNIT 1

ORANGEVILLE, ONTARIO, L9W 1K4

TEL 519 941 0330 FAX 519 941 1830

#### BLACKWELL STRUCTURAL ENGINEERS

134 PETER STREET, SUITE 1301
TORONTO, ONTARIO, M5V 2H2
TEL 416.593.5300 FAX 416.593.4840


#### SMITH + ANDERSON mechanical and electrical engineers

1100 - 100 SHEPPARD AVENUE EAST TORONTO, ONTARIO, M2N 6N5 TEL 416.487.8151 -

## SAYERS FOOD LIMITED

132 BURLEIGH STREET t: 705.656.4531 e: sayers@apsley.ca

NORTH ARROW

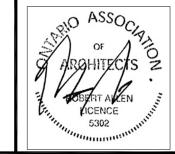

PROJECT TITLE

NEW SAYERS FOOD STORE BURLEIGH STREET, APSLEY

DRAWING TITLE

OUTLINE SPECIFICATION

NTS

JULY 15, 2022

PROJECT NUMBER

2102
DRAWING NUMBER

Specifications  03 - Submit	neered Subm 04 05 00		September 29, 20
Specifications  03 - Submit	ittals  neered Subm 04 05 00	ititals  Masonry Procedures  Submit engineered shop drawings for the following:  • Masonry reinforcement • Masonry ties and connectors  Load-Bearing Cold-Formed Metal Framing  Submit engineered shop drawings, including design, connections and restraint of wall and soffit assemblies. Field review requirements to be supplemented to include the following:  • Checking that mill test reports are properly correlated to materials.  • Sampling fabrication and erection procedures for general conformity to requirements of the Contract Documents.  • Checking fabricated members against specified member shapes.  • Sample checking of screwed and bolted joints.  • Sample checking that tolerances are not exceeded during fit-up or erection.  • General review of field cutting and alterations required by other sections.  Include necessary shop details and erection diagrams. Indicate member sizes, locations thicknesses exclusive of coating, coatings and materials. Include connection details for attaching framing to itself and for attachment to the structure. Show splice details where permitted. Indicate dimensions, openings, requirements of related work and critical installation procedures.	September 29, 20
	neered Subm 04 05 00	Masonry Procedures  Submit engineered shop drawings for the following:  •Masonry reinforcement •Masonry ties and connectors  Load-Bearing Cold-Formed Metal Framing  Submit engineered shop drawings, including design, connections and restraint of wall and soffit assemblies. Field review requirements to be supplemented to include the following:  •Checking that mill test reports are properly correlated to materials.  •Sampling fabrication and erection procedures for general conformity to requirements of the Contract Documents.  •Checking fabricated members against specified member shapes.  •Sample checking of screwed and bolted joints.  •Sample checking that tolerances are not exceeded during fit-up or erection.  •General review of field cutting and alterations required by other sections.  Include necessary shop details and erection diagrams. Include connection details for attaching framing to itself and for attachment to the structure. Show splice details where permitted. Indicate dimensions, openings, requirements of related work and critical installation procedures.	
	neered Subm 04 05 00	Masonry Procedures  Submit engineered shop drawings for the following:  •Masonry reinforcement •Masonry ties and connectors  Load-Bearing Cold-Formed Metal Framing  Submit engineered shop drawings, including design, connections and restraint of wall and soffit assemblies. Field review requirements to be supplemented to include the following:  •Checking that mill test reports are properly correlated to materials.  •Sampling fabrication and erection procedures for general conformity to requirements of the Contract Documents.  •Checking fabricated members against specified member shapes.  •Sample checking of screwed and bolted joints.  •Sample checking that tolerances are not exceeded during fit-up or erection.  •General review of field cutting and alterations required by other sections.  Include necessary shop details and erection diagrams. Include connection details for attaching framing to itself and for attachment to the structure. Show splice details where permitted. Indicate dimensions, openings, requirements of related work and critical installation procedures.	
.5 Engir	04 05 00	Masonry Procedures  Submit engineered shop drawings for the following:  •Masonry reinforcement •Masonry ties and connectors  Load-Bearing Cold-Formed Metal Framing  Submit engineered shop drawings, including design, connections and restraint of wall and soffit assemblies. Field review requirements to be supplemented to include the following:  •Checking that mill test reports are properly correlated to materials.  •Sampling fabrication and erection procedures for general conformity to requirements of the Contract Documents.  •Checking fabricated members against specified member shapes.  •Sample checking of screwed and bolted joints.  •Sample checking that tolerances are not exceeded during fit-up or erection.  •General review of field cutting and alterations required by other sections.  Include necessary shop details and erection diagrams. Include connection details for attaching framing to itself and for attachment to the structure. Show splice details where permitted. Indicate dimensions, openings, requirements of related work and critical installation procedures.	
.5 Engir	04 05 00	Masonry Procedures  Submit engineered shop drawings for the following:  •Masonry reinforcement •Masonry ties and connectors  Load-Bearing Cold-Formed Metal Framing  Submit engineered shop drawings, including design, connections and restraint of wall and soffit assemblies. Field review requirements to be supplemented to include the following:  •Checking that mill test reports are properly correlated to materials.  •Sampling fabrication and erection procedures for general conformity to requirements of the Contract Documents.  •Checking fabricated members against specified member shapes.  •Sample checking of screwed and bolted joints.  •Sample checking that tolerances are not exceeded during fit-up or erection.  •General review of field cutting and alterations required by other sections.  Include necessary shop details and erection diagrams. Include connection details for attaching framing to itself and for attachment to the structure. Show splice details where permitted. Indicate dimensions, openings, requirements of related work and critical installation procedures.	
		Submit engineered shop drawings for the following:  • Masonry reinforcement • Masonry ties and connectors  Load-Bearing Cold-Formed Metal Framing Submit engineered shop drawings, including design, connections and restraint of wall and soffit assemblies. Field review requirements to be supplemented to include the following:  • Checking that mill test reports are properly correlated to materials. • Sampling fabrication and erection procedures for general conformity to requirements of the Contract Documents.  • Checking fabricated members against specified member shapes. • Sample checking of screwed and bolted joints. • Sample checking that tolerances are not exceeded during fit-up or erection. • General review of field cutting and alterations required by other sections.  Include necessary shop details and erection diagrams. Indicate member sizes, locations thicknesses exclusive of coating, coatings and materials. Include connection details for attaching framing to itself and for attachment to the structure. Show splice details where permitted. Indicate dimensions, openings, requirements of related work and critical installation procedures.	
	05 41 13	Masonry ties and connectors  Load-Bearing Cold-Formed Metal Framing Submit engineered shop drawings, including design, connections and restraint of wall and soffit assemblies. Field review requirements to be supplemented to include the following:	
	05 41 13	Load-Bearing Cold-Formed Metal Framing  Submit engineered shop drawings, including design, connections and restraint of wall and soffit assemblies. Field review requirements to be supplemented to include the following:  • Checking that mill test reports are properly correlated to materials.  • Sampling fabrication and erection procedures for general conformity to requirements of the Contract Documents.  • Checking fabricated members against specified member shapes.  • Sample checking of screwed and bolted joints.  • Sample checking that tolerances are not exceeded during fit-up or erection.  • General review of field cutting and alterations required by other sections.  Include necessary shop details and erection diagrams. Indicate member sizes, locations thicknesses exclusive of coating, coatings and materials. Include connection details for attaching framing to itself and for attachment to the structure. Show splice details where permitted. Indicate dimensions, openings, requirements of related work and critical installation procedures.	
	05 41 13	Submit engineered shop drawings, including design, connections and restraint of wall and soffit assemblies. Field review requirements to be supplemented to include the following:   • Checking that mill test reports are properly correlated to materials.  • Sampling fabrication and erection procedures for general conformity to requirements of the Contract Documents.  • Checking fabricated members against specified member shapes.  • Sample checking of screwed and bolted joints.  • Sample checking that tolerances are not exceeded during fit-up or erection.  • General review of field cutting and alterations required by other sections.  Include necessary shop details and erection diagrams. Indicate member sizes, locations thicknesses exclusive of coating, coatings and materials. Include connection details for attaching framing to itself and for attachment to the structure. Show splice details where permitted. Indicate dimensions, openings, requirements of related work and critical installation procedures.	
		assemblies. Field review requirements to be supplemented to include the following:  • Checking that mill test reports are properly correlated to materials. • Sampling fabrication and erection procedures for general conformity to requirements of the Contract Documents. • Checking fabricated members against specified member shapes. • Sample checking of screwed and bolted joints. • Sample checking that tolerances are not exceeded during fit-up or erection. • General review of field cutting and alterations required by other sections.  Include necessary shop details and erection diagrams. Indicate member sizes, locations thicknesses exclusive of coating, coatings and materials. Include connection details for attaching framing to itself and for attachment to the structure. Show splice details where permitted. Indicate dimensions, openings, requirements of related work and critical installation procedures.	
		Sampling fabrication and erection procedures for general conformity to requirements of the Contract Documents.  Checking fabricated members against specified member shapes.  Sample checking of screwed and bolted joints.  Sample checking that tolerances are not exceeded during fit-up or erection.  General review of field cutting and alterations required by other sections.  Include necessary shop details and erection diagrams. Indicate member sizes, locations thicknesses exclusive of coating, coatings and materials. Include connection details for attaching framing to itself and for attachment to the structure. Show splice details where permitted. Indicate dimensions, openings, requirements of related work and critical installation procedures.	
		Contract Documents.  Checking fabricated members against specified member shapes.  Sample checking of screwed and bolted joints.  Sample checking that tolerances are not exceeded during fit-up or erection.  General review of field cutting and alterations required by other sections.  Include necessary shop details and erection diagrams. Indicate member sizes, locations thicknesses exclusive of coating, coatings and materials. Include connection details for attaching framing to itself and for attachment to the structure. Show splice details where permitted. Indicate dimensions, openings, requirements of related work and critical installation procedures.	
		Checking fabricated members against specified member shapes.  Sample checking of screwed and bolted joints.  Sample checking that tolerances are not exceeded during fit-up or erection.  General review of field cutting and alterations required by other sections.  Include necessary shop details and erection diagrams. Indicate member sizes, locations thicknesses exclusive of coating, coatings and materials. Include connection details for attaching framing to itself and for attachment to the structure. Show splice details where permitted. Indicate dimensions, openings, requirements of related work and critical installation procedures.	
		Sample checking that tolerances are not exceeded during fit-up or erection.  General review of field cutting and alterations required by other sections.  Include necessary shop details and erection diagrams. Indicate member sizes, locations thicknesses exclusive of coating, coatings and materials. Include connection details for attaching framing to itself and for attachment to the structure. Show splice details where permitted. Indicate dimensions, openings, requirements of related work and critical installation procedures.	
		General review of field cutting and alterations required by other sections.  Include necessary shop details and erection diagrams. Indicate member sizes, locations thicknesses exclusive of coating, coatings and materials. Include connection details for attaching framing to itself and for attachment to the structure. Show splice details where permitted. Indicate dimensions, openings, requirements of related work and critical installation procedures.	
		locations thicknesses exclusive of coating, coatings and materials. Include connection details for attaching framing to itself and for attachment to the structure. Show splice details where permitted. Indicate dimensions, openings, requirements of related work and critical installation procedures.	
		locations thicknesses exclusive of coating, coatings and materials. Include connection details for attaching framing to itself and for attachment to the structure. Show splice details where permitted. Indicate dimensions, openings, requirements of related work and critical installation procedures.	
+		Indicate design loads and design calculations, including horizontal and vertical reactions at connections to building structure for all load cases.	
	05 50 00	Metal Fabrications	
		Submit engineered shop drawings including plans, sections and large scale details. Indicate components and methods of assembly, materials and their characteristics, fastenings, metal finishes, welds, and their structural characteristics relative to their purpose, and other fabrication information required. Indicate site connections and methods.	
	20.40.00		
	08 42 29	Automatic Sliding Entrance Doors  Indicate fastening system for anchorage of door frame to opening, and structural design for each door type and size.	
	09 22 00	Metal Supports for Gypsum Board	
		Submit engineered shop drawings for ceiling assemblies.	
.6 Mock	k line		
10 1410011		Polished Concrete	
		Provide 3050 mm x 3050 mm (10' x 10') mock-up at the Place of the Work as part of final installation for approval, location to be directed by Consultant. Allow for three mock-up areas to determine aggregate exposure classification and polish level	
	04 21 00	Brick Masonry Units	
		Provide complete in-situ mock-up wall assembly, in location designated by the Consultant, prior to the commencement of fabrication and installation of such components.	
	04 22 23	Architectural Concrete Masonry Units	
	04 22 23	Provide complete in-situ mock-up wall assembly, in location designated by the  Consultant, prior to the commencement of fabrication and installation of such components.	
	06 40 00	Architectural Woodwork	
		Provide mock-ups for the following, sizes and locations as directed by the Consultant  Solid surfacing countertops and fabrications.  Wood ceilings panels.  Factory and site finishing of architectural woodwork.	
	00.40.40		
	06 40 13	Exterior Architectural Woodwork  Provide mock-ups for Kiosk area.	
	07 27 00	Air Barrier Systems  Construct minimum 10 m2 (100 ft2) area of each typical wall assembly installation	
		for each type of Product.	
	07 44 63	EPS Moulding with Cementitious Coating	

Sayers Grocery Store	Specifications Matrix	Pa
		September
	Unit Paving	
	Product data sheets:	
	Submit product data sheets for each paver type and colour	
	Shop drawings:	
	Submit shop drawings including bedding, bonding, jointing and setting details, and the	
	dimensions and identifying number of each piece of stone with indication of sizes, thicknesses,	
	dimensions, layout, finishes, compressive strength, joint and setting mix designs, jointing	
	clearances, clearanced between pavers and the adjacent building element.	
	Samples - paver:	
	Submit 6 full size samples of each paver type and colour to show texture, finish, and range of	
	colour to be supplied.	
	Samples - setting bed and joint fill material:	
	Submit samples of setting bed and joint filler material.	
	Design Calculations:	
	.1 Submit design calculations for paving assembly as prepared by qualified	
	professional engineer registered in the Place of the Work.	
	.2 Submit design calculations complete with references to codes and standards used	
	in such calculations, supporting the proposed design represented by the submittal.	
	Prepare calculations in a clear and comprehensive manner.	
	.3 Upon completion of the parts of the Work covered by the design calculations, the	
	professional engineer responsible for the preparation of the design calculations	
	and for undertaking the periodic field reviews described above, shall prepare a	
	letter of general conformity for those parts of the Work, certifying that they have	
	been provided in accordance with the requirements both of the Contract	
	Documents and of the authorities having jurisdiction over the Place of the Work.	
	Test data:	
	.1 Provide test certificates of tests carried out by an independent testing laboratory	
	verifying that stone meets the specifications, for each colour of stone. If certificates	
	are not available, retain an independent inspection and testing company to carry	
	out the tests, minimum of 3 specimens for each test unless otherwise specified in	
	ASTM. Submit test certificates to Consultant at least 8 weeks before commencing	
	stone installation	
	.2 Provide certificate signed by manufacturer that the stone materials to be	
	supplied comply with specified performance characteristics and physical	

Specifications Matrix Page 2 of 3 Sayers Grocery Store September 29, 2021 Construct typical wall assembly installation showing all applicable details. 07 46 46 Cementitious Cladding
Construct minimum 10 m2 (100 ft2) area of each typical wall assembly installation showing all applicable details. 07 62 00 Metal Flashing

Provide on-site mock-up of the following:

• Coping flashing.

- Poof edge flashing. Counter flashing. Fascia flashing. Special flashing conditions 09 31 00 Tilling Provide grouted mock-up: 1220 mm x 1220 mm (48" x 48") sample panels of each tile type and colour, texture, size, and pattern of tile and grout. Install each product and colour mock-up for acceptance by Consultant. Accepted mock-up shall form basis of standard of workmanship for remainder of work. Mock-up shall consist of floor/wall/base corner intersection including cove base inside and outside corners, with 300 mm (12") of finish product on each face. 09 65 13 Premanufactured Bases

Premanufactured base mock-up shall include at least one inside corner, one control of straight run. 09 65 18 Slip Resistive Vinyl SheetFlooring

Provide mock-up of sufficient size to indicate adhesion, joint welding, edge treatment, and coved | Painting | Provide full finished mock-up installation of each paint colour, for indicated surfaces and mock-up | Provide full finished mock-up installation of each paint colour, for indicated surfaces and mock-up installation of each paint colour, for indicated surfaces and mock-up installation of each paint colour, for indicated surfaces and mock-up installation of each paint colour, for indicated surfaces and mock-up installation of each paint colour, for indicated surfaces and mock-up installation of each paint colour, for indicated surfaces and mock-up installation of each paint colour, for indicated surfaces and mock-up installation of each paint colour, for indicated surfaces and mock-up installation of each paint colour, for indicated surfaces and mock-up installation of each paint colour, for indicated surfaces and mock-up installation of each paint colour, for indicated surfaces and mock-up installation of each paint colour, for indicated surfaces and mock-up installation of each paint colour, for indicated surfaces and mock-up installation of each paint colour, for indicated surfaces and mock-up installation of each paint colour, for indicated surfaces and mock-up installation of each paint colour. size, showing colour and finish selected by Consultant, under lighting conditions matching final area lighting, for acceptance by Consultant. Locate at Place of the Work as part of finished installation if accepted. Exterior Improvement Concrete Reinforcement Submit engineered shop drawings for reinforcement Cast-in-Place Concrete

Submit certified mix designs for each type of concrete to be used, stating the specific location, using structural element for which the mix applies and 305 mm (12") x 305 mm (12") sample of specified finish. Submit engineered shop drawings of all exterior metal work, including, bollard, sign post, handrail at cip concrete steps and ramp, and chain link fence. Provide in shop drawings plans, sections and large scale details. Indicate components and methods of assembly, materials and their characteristics, fastenings, metal finishes, welds, and their structural characteristics relative to their purpose, and other fabrication information required. Indicate site connections and methods. Site Furnishing
Submit engineered shop drawings and product data sheets of bench, movable planter & bench, and tactile place. Product data sheets:
Submit data describing planting mix components and certificates indicating that the materials meet specification requirements for review a minimum of 45 business days prior to planned installation of planting mix. Samples:
Submit samples of planting mix components for approval a minimum of 45 business days prior to planned installation of planting mix with clear label on samples with relevant identifying characteristics including but not limited to the type of material, percentange of each component materials, source and stockpile location, and manufacturer contact information. Samples to be submitted for review and acceptance at the same time as test reports. <u>Test reports:</u>
Submit written laboratory test results for approval within 20 business days of approval of planting

Contractor must check and verify all dimensions on the job, and report any discrepancies to the Architect before proceeding with the work.

Do not scale this drawing.

# REVISIONS AND ISSUES DESCRIPTION DATE BY 1 REVISED SPA 210809 AB 2 ISSUED FOR TENDER 210824 AB 3 REVISION TO BUILDING PERMIT 220315 AB 4 SI-01 220615 AB

ISSUED FOR CONSTRUCTION 220715

220715

BLG SET-OUT CAD

8

10

# **MJMA**

www.mjmarchitects.com

maclennan jaunkalns miller architects

425 adelaide street west level 6
toronto ontario m5v 3c1
416 593 6796

#### TRITON ENGINEERING SERVICES LTD

CIVIL ENGINEERS

229 BROADWAY, UNIT 1

ORANGEVILLE, ONTARIO, L9W 1K4

TEL 519 941 0330 FAX 519 941 1830

TEL 519 941 0330 FAX 519 941

BLACKWELL

STRUCTURAL ENGINEERS

134 PETER STREET, SUITE 1301
TORONTO, ONTARIO, M5V 2H2
TEL 416.593.5300 FAX 416.593.4840


SMITH + ANDERSON mechanical and electrical engineers

1100 - 100 SHEPPARD AVENUE EAST TORONTO, ONTARIO, M2N 6N5 TEL 416.487.8151 -

## SAYERS FOOD LIMITED

132 BURLEIGH STREET t: 705.656.4531 e: sayers@apsley.ca

NORTH ARROW

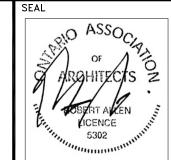

PROJECT TITL

NEW SAYERS FOOD STORE BURLEIGH STREET, APSLEY

DRAWING TITLE

SUBMITTALS


scale NTS

JULY 15, 2022

PROJECT NUMBER

2102

DRAWING NUMBER

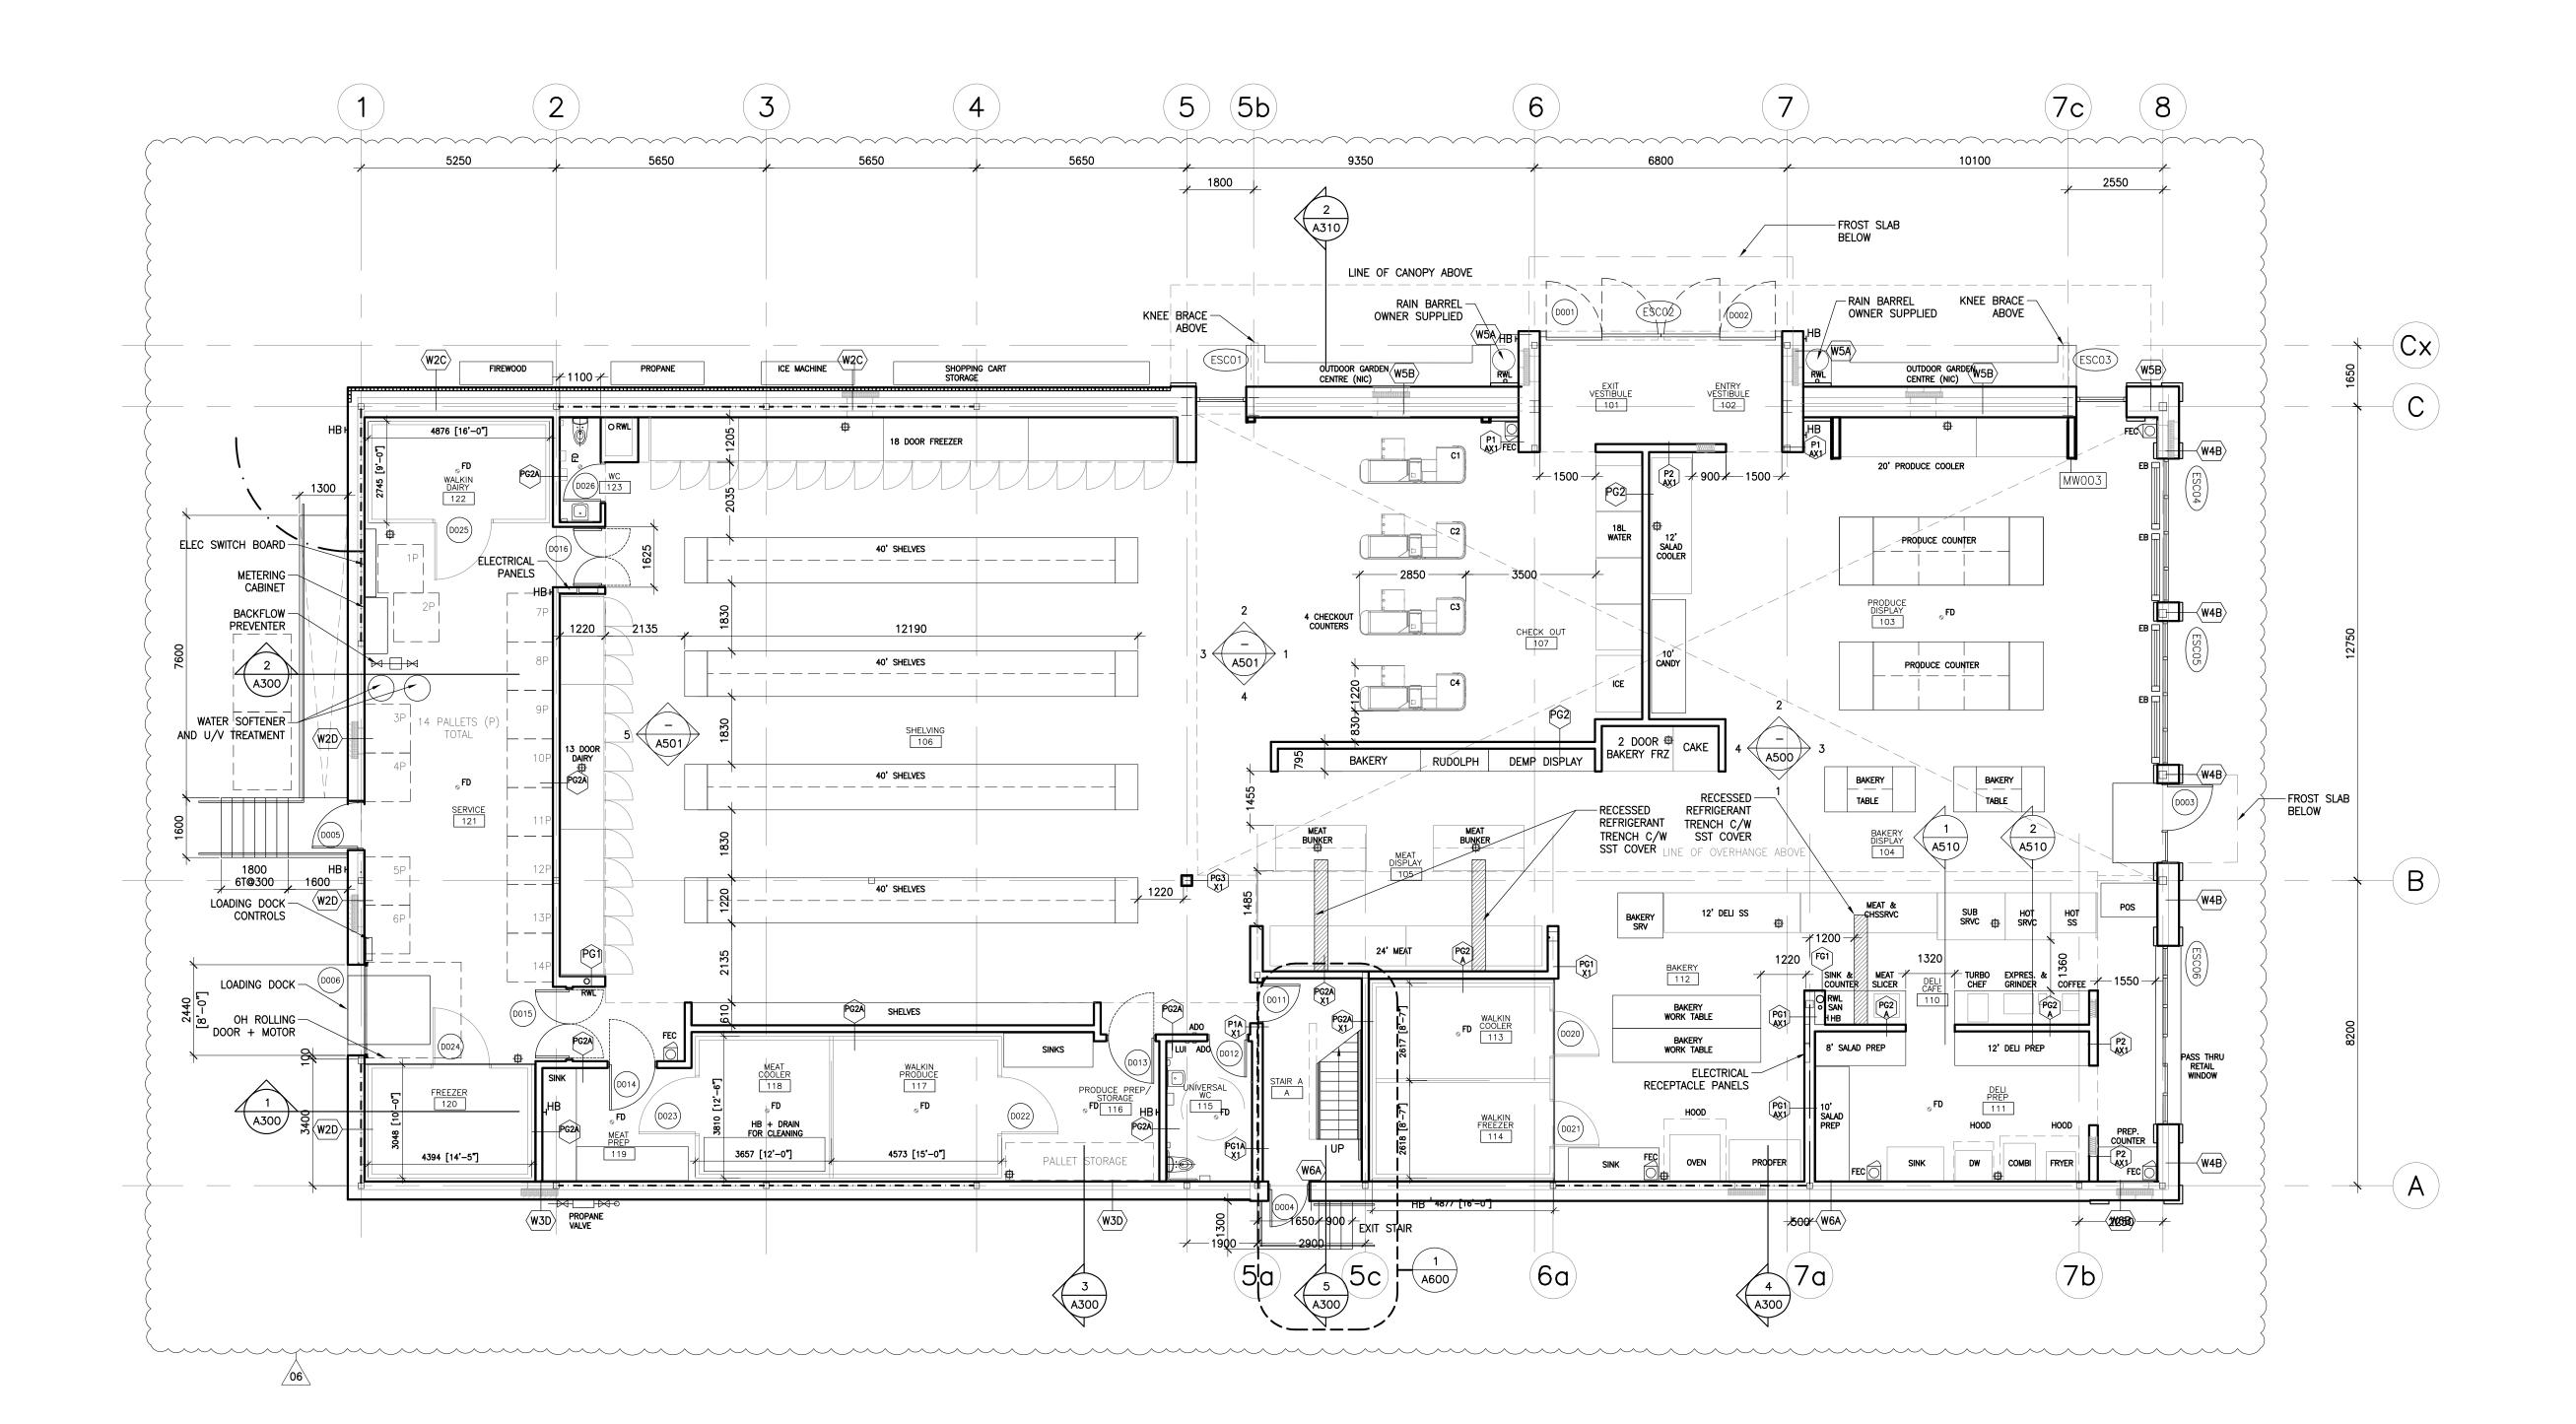

REVISIONS	AND ISSUES		
REV	DESCRIPTION	DATE	В
1	REVISED SPA	210809	AE
2	ISSUED FOR TENDER	210824	AE
3	REVISION TO BUILDING PERMIT	220315	AE
4	SI-01	220615	AE
5	BLG SET-OUT CAD	220715	AE
6	ISSUED FOR CONSTRUCTION	220715	AE
7			

11 12

# AMLM

maclennan jaunkalns miller architects

425 adelaide street west level 6 toronto ontario m5v 3c1 416 593 6796 www.mjmarchitects.com

## TRITON ENGINEERING SERVICES LTD

229 BROADWAY, UNIT 1
ORANGEVILLE, ONTARIO, L9W 1K4
TEL 519 941 0330 FAX 519 941 1830

EL 519 941 0330 FAX 519 941

BLACKWELL
STRUCTURAL ENGINEERS

134 PETER STREET, SUITE 1301

TORONTO, ONTARIO, M5V 2H2
TEL 416.593.5300 FAX 416.593.4840


SMITH + ANDERSON


MECHANICAL AND ELECTRICAL ENGINEERS

1100 — 100 SHEPPARD AVENUE EAST TORONTO, ONTARIO, M2N 6N5 TEL 416.487.8151 —

## SAYERS FOOD LIMITED

132 BURLEIGH STREET t: 705.656.4531 e: sayers@apsley.ca

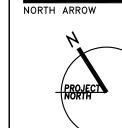

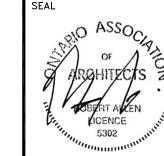

PROJECT TITL

NEW SAYERS FOOD STORE BURLEIGH STREET, APSLEY

DRAWING TITLE

GROUND LEVEL FLOOR PLAN


1:100

JULY 15, 2022

PROJECT NUMBER

2102
DRAWING NUMBER

۸ 1 O O

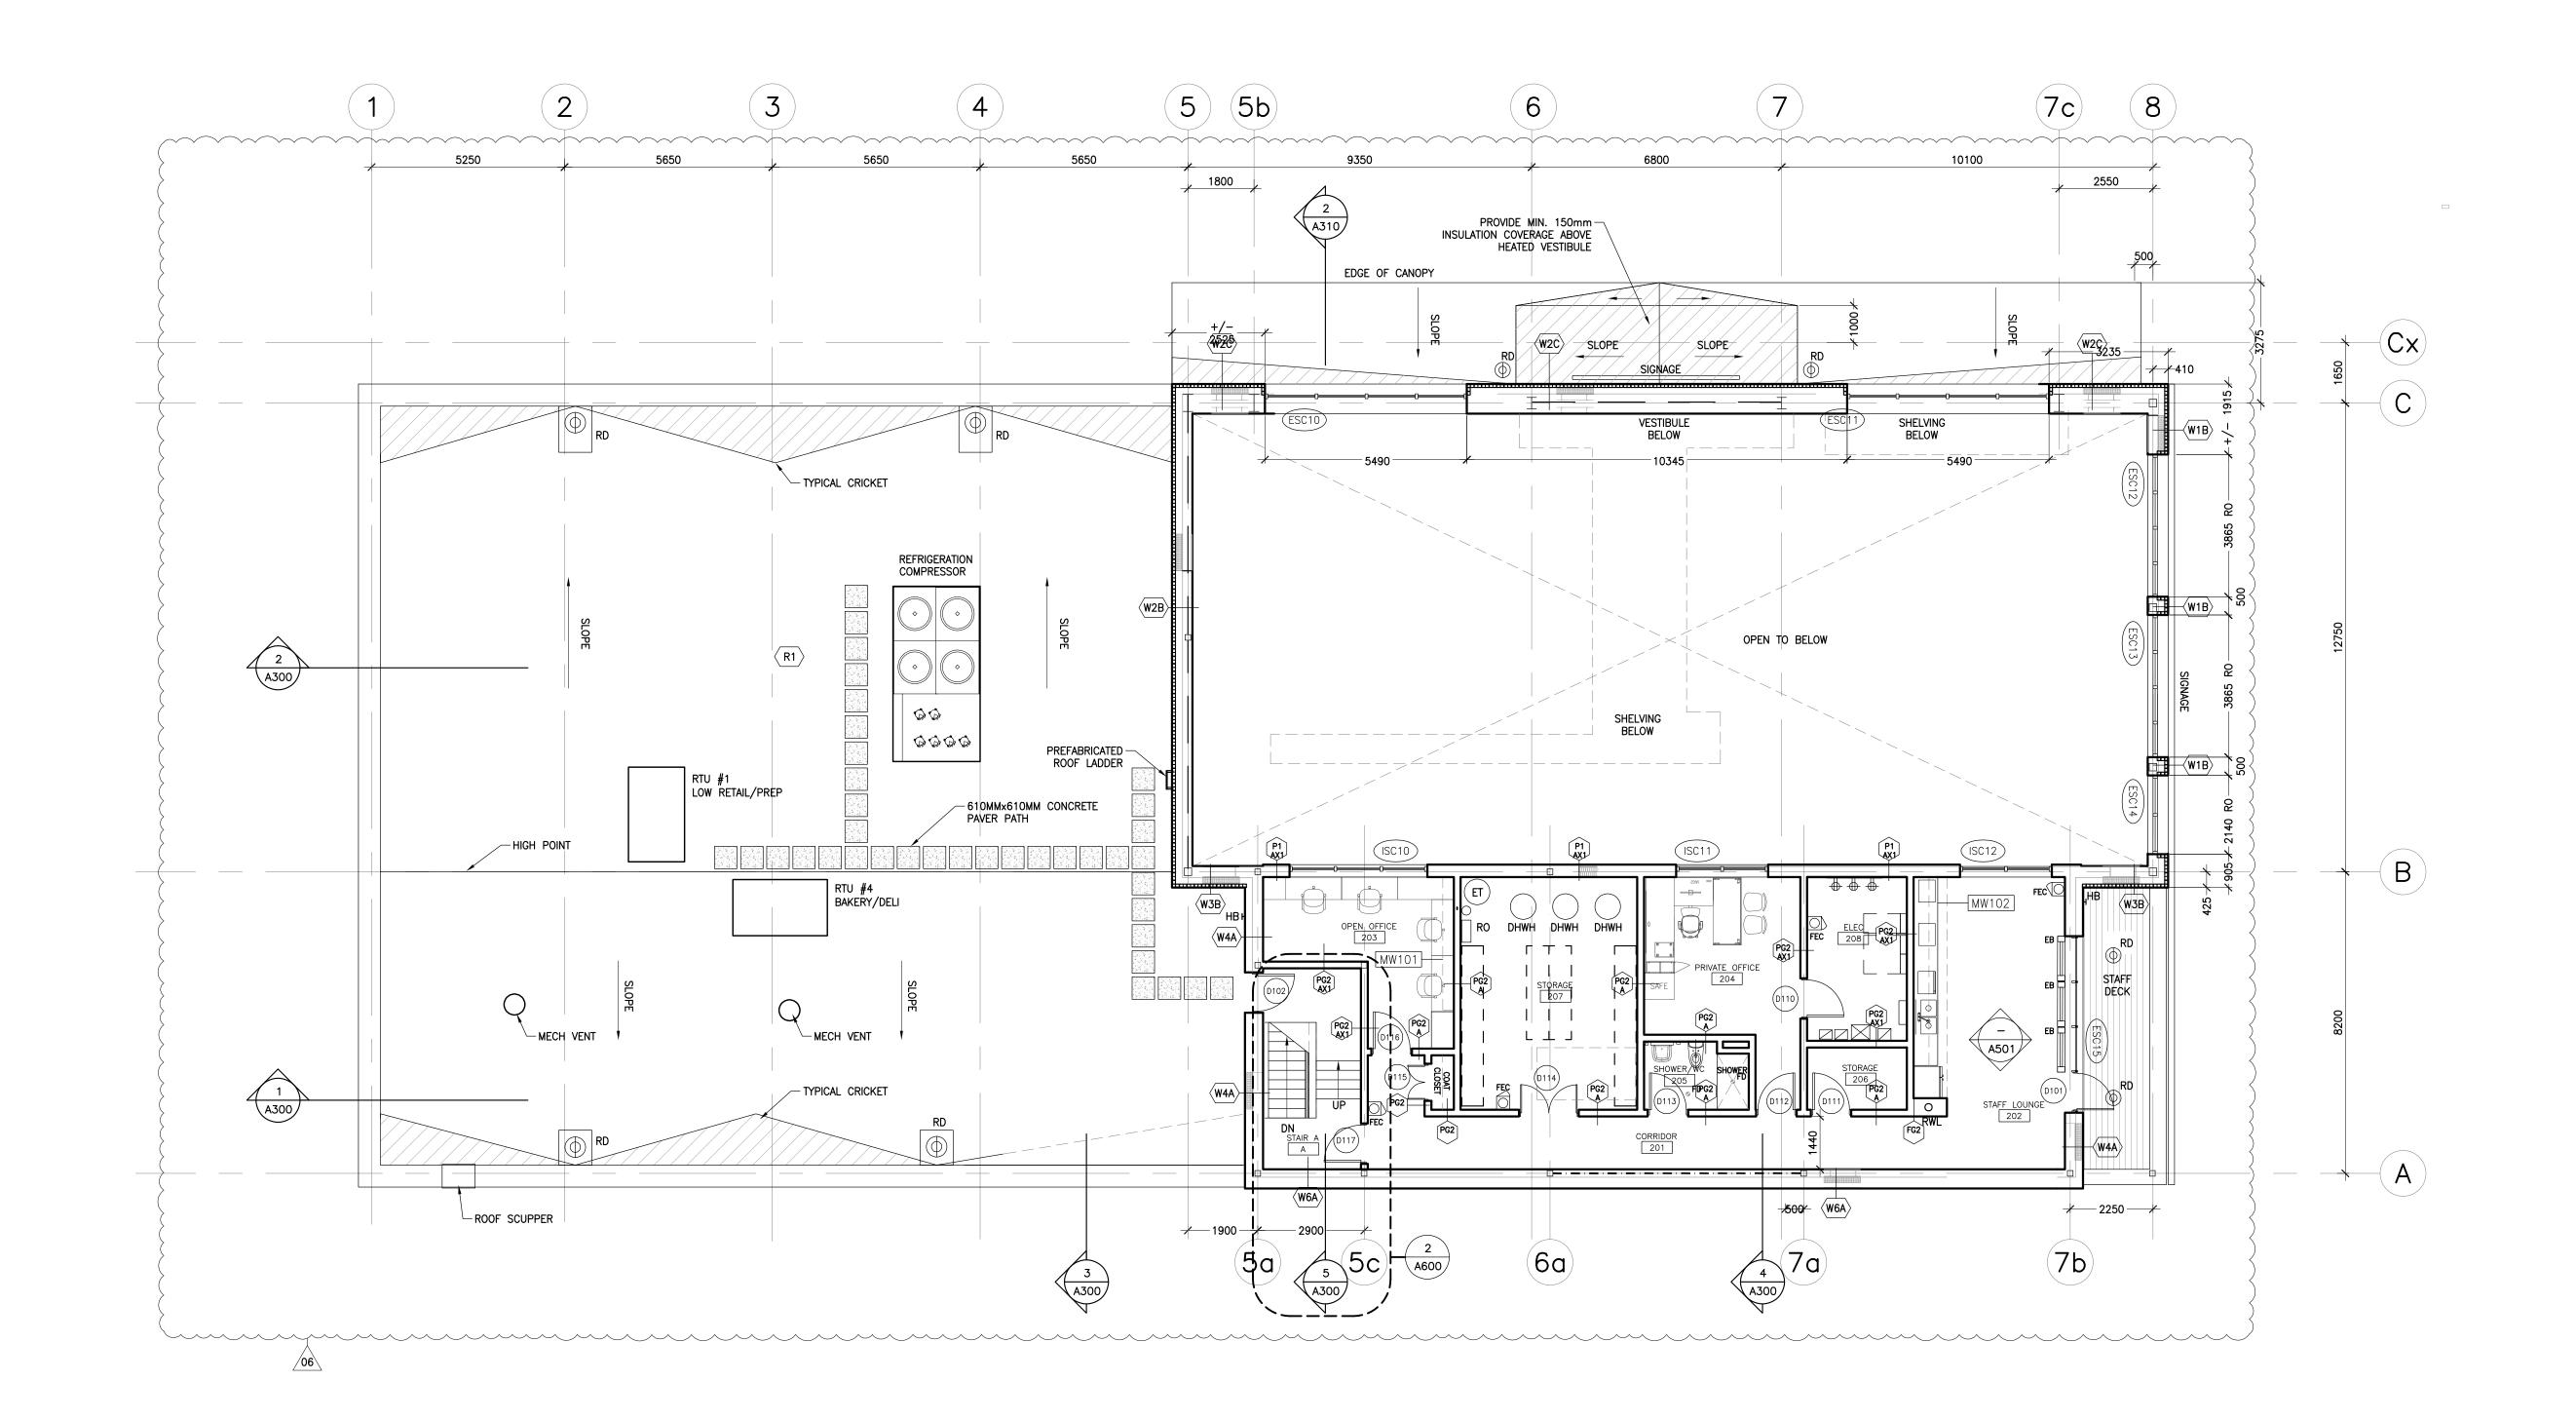

REV	DESCRIPTION	DATE	B
INL V	DESCRIPTION	DATE	, D
1	REVISED SPA	210809	AB
2	ISSUED FOR TENDER	210824	AB
3	REVISION TO BUILDING PERMIT	220315	AB
4	SI-01	220615	AB
5	BLG SET-OUT CAD	220715	AB
6	ISSUED FOR CONSTRUCTION	220715	AB
7			

# **MJMA**

maclennan jaunkalns miller architects

425 adelaide street west level 6 toronto ontario m5v 3c1 416 593 6796 www.mjmarchitects.com

#### TRITON ENGINEERING SERVICES LTD CIVIL ENGINEERS

229 BROADWAY, UNIT 1 ORANGEVILLE, ONTARIO, L9W 1K4
TEL 519 941 0330 FAX 519 941 1830

#### BLACKWELL STRUCTURAL ENGINEERS


134 PETER STREET, SUITE 1301 TORONTO, ONTARIO, M5V 2H2 TEL 416.593.5300 FAX 416.593.4840

#### SMITH + ANDERSON MECHANICAL AND ELECTRICAL ENGINEERS

1100 — 100 SHEPPARD AVENUE EAST TORONTO, ONTARIO, M2N 6N5 TEL 416.487.8151 —

## SAYERS FOOD LIMITED

132 BURLEIGH STREET t: 705.656.4531 e: sayers@apsley.ca

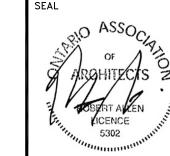

NEW SAYERS FOOD STORE BURLEIGH STREET, APSLEY


LEVEL 2 FLOOR PLAN

1:100

JULY 15, 2022

PROJECT NUMBER

2102 DRAWING NUMBER

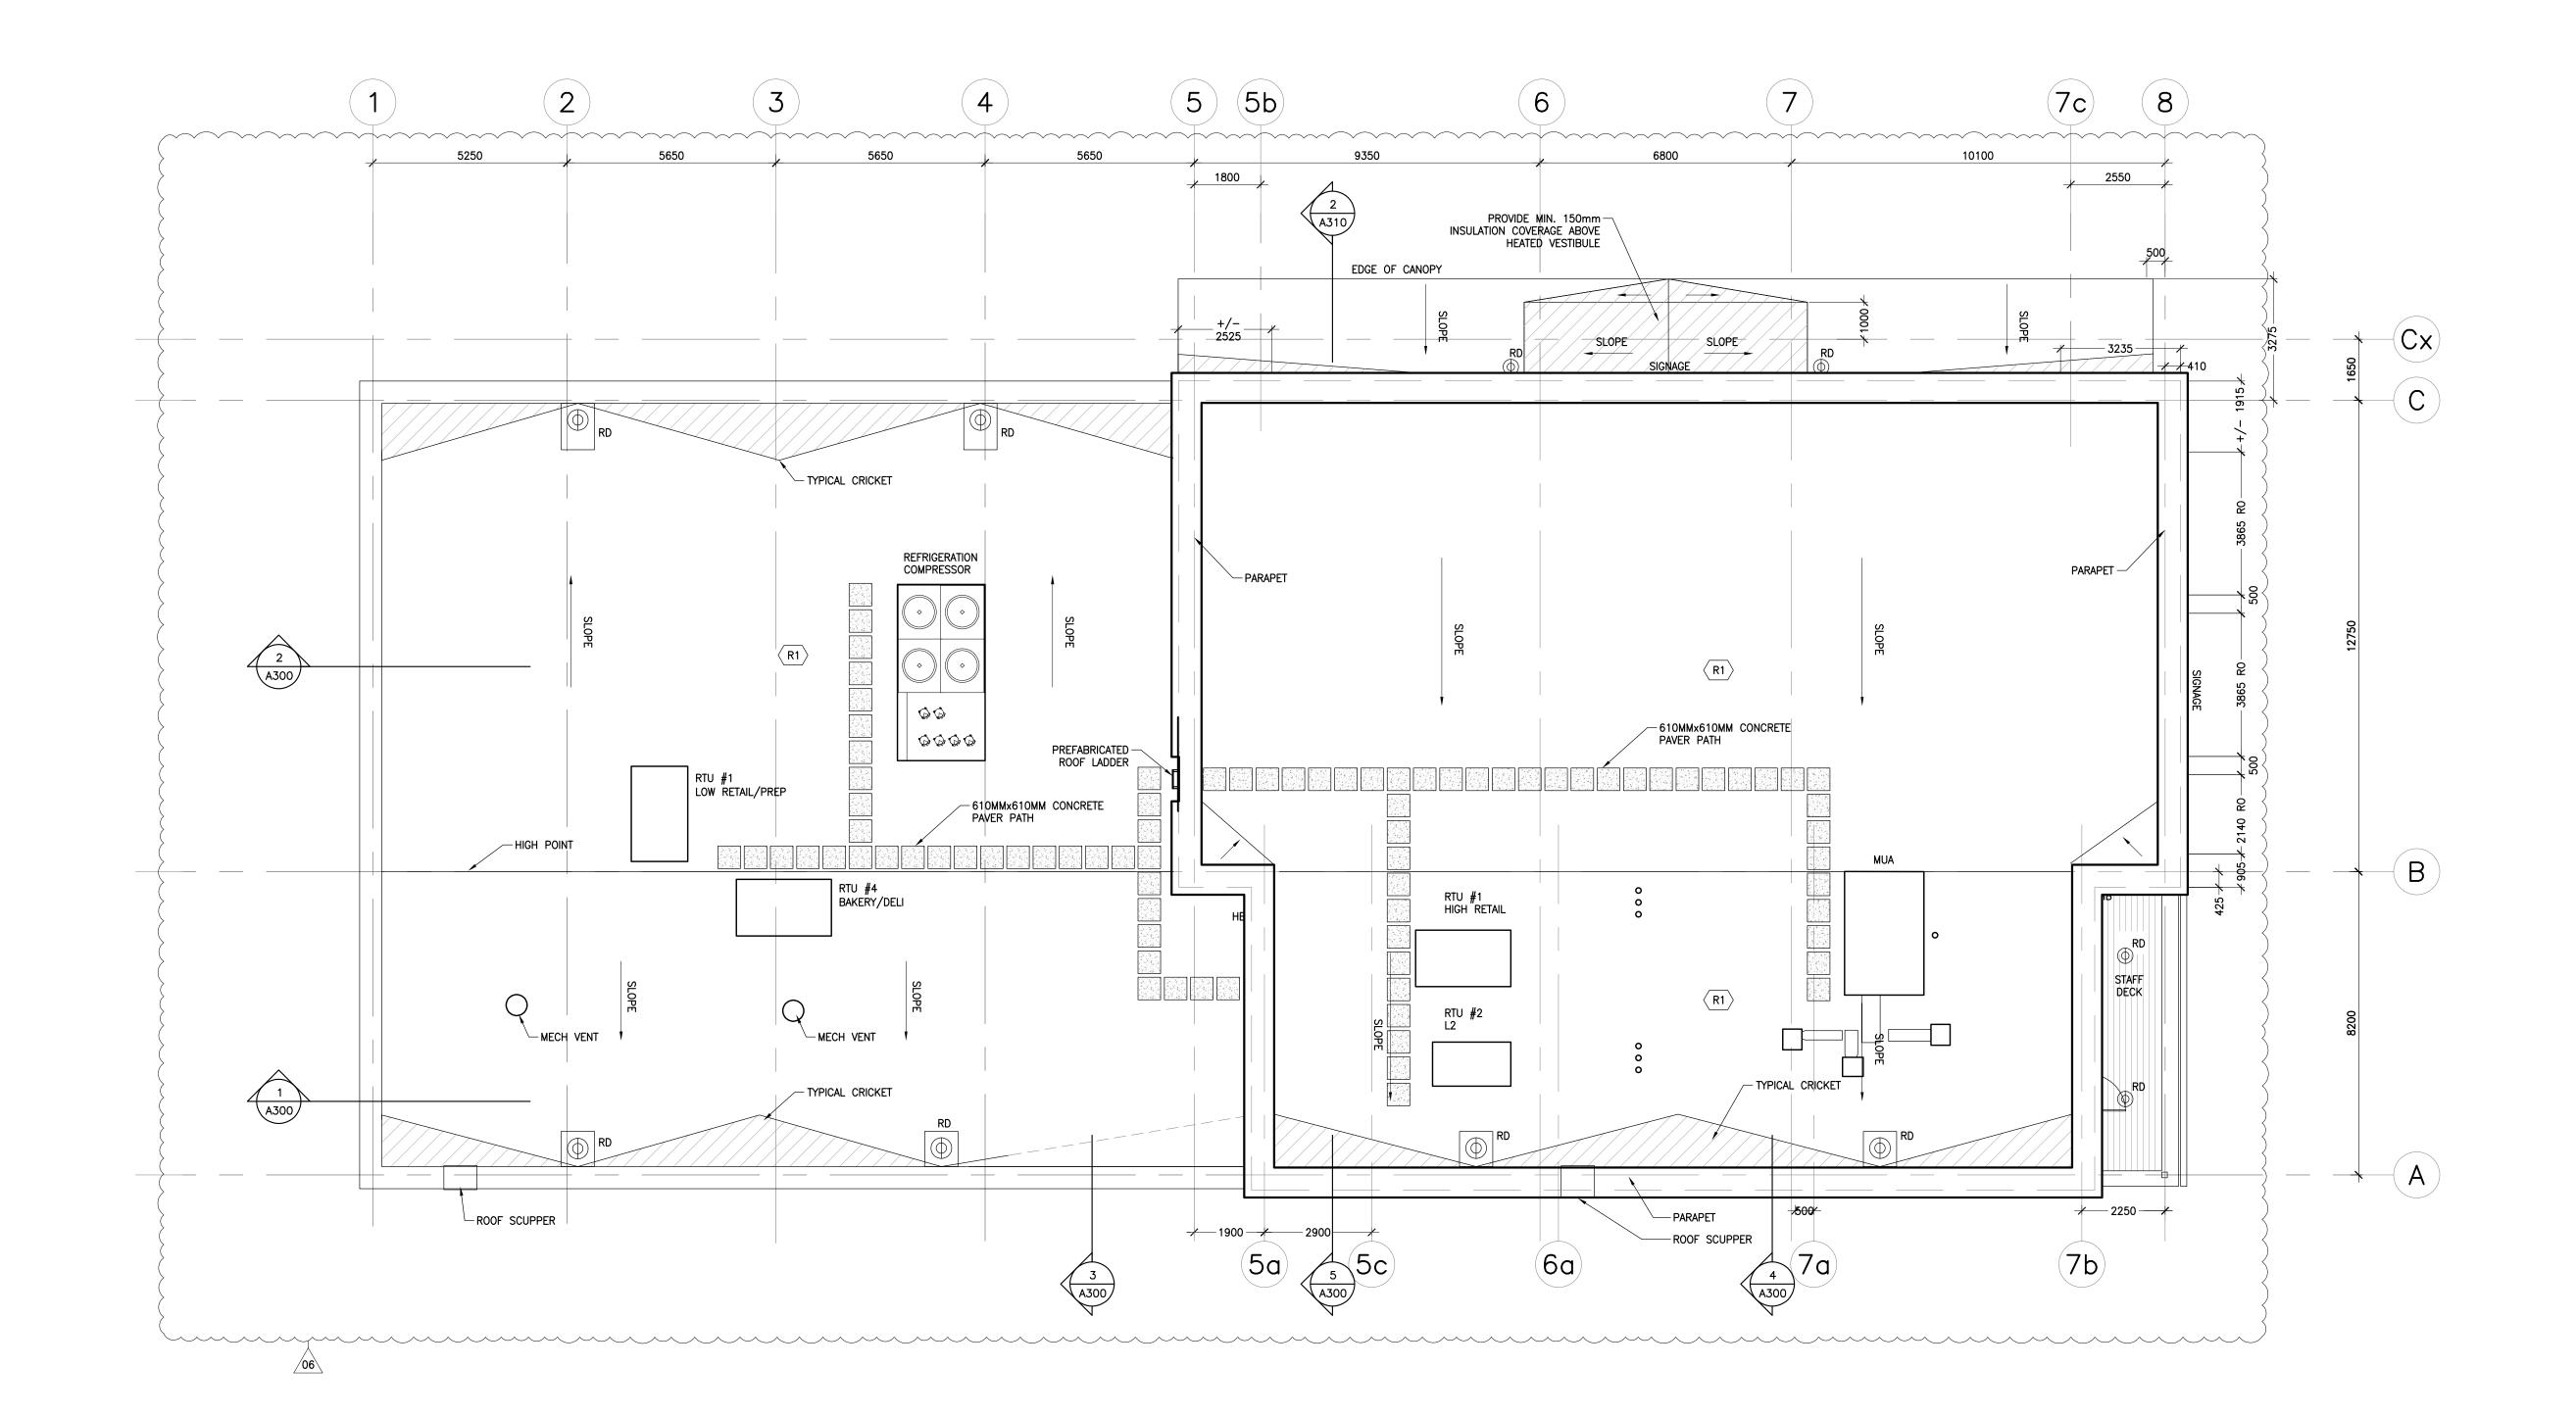

 REVISIONS AND ISSUES
 DATE
 BY

 1
 REVISED SPA
 210809
 AE

 2
 ISSUED FOR TENDER
 210824
 AE

 3
 REVISION TO BUILDING PERMIT
 220315
 AE

 4
 SI-01
 220615
 AE

 5
 BLG SET-OUT CAD
 220715
 AE

ISSUED FOR CONSTRUCTION 220715

10

11 12

# AMLM

maclennan jaunkalns miller architects

425 adelaide street west level 6 toronto ontario m5v 3c1 416 593 6796 www.mjmarchitects.com

#### TRITON ENGINEERING SERVICES LTD

229 BROADWAY, UNIT 1 ORANGEVILLE, ONTARIO, L9W 1K4 TEL 519 941 0330 FAX 519 941 1830

TEL 519 941 0330 FAX 519 941

BLACKWELL

STRUCTURAL ENGINEERS

134 PETER STREET, SUITE 1301
TORONTO, ONTARIO, M5V 2H2
TEL 416.593.5300 FAX 416.593.4840

SMITH + ANDERSON


MECHANICAL AND ELECTRICAL ENGINEERS

1100 - 100 SHEPPARD AVENUE EAST TORONTO, ONTARIO, M2N 6N5 TEL 416.487.8151 -

## SAYERS FOOD LIMITED

132 BURLEIGH STREET t: 705.656.4531 e: sayers@apsley.ca

NORTH ARRO

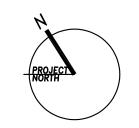

PROJECT TIT

NEW SAYERS FOOD STORE BURLEIGH STREET, APSLEY

DRAWING TITLE

ROOF PLAN


scale 1:100

JULY 15, 2022

PROJECT NUMBER

2102
DRAWING NUMBER

4102

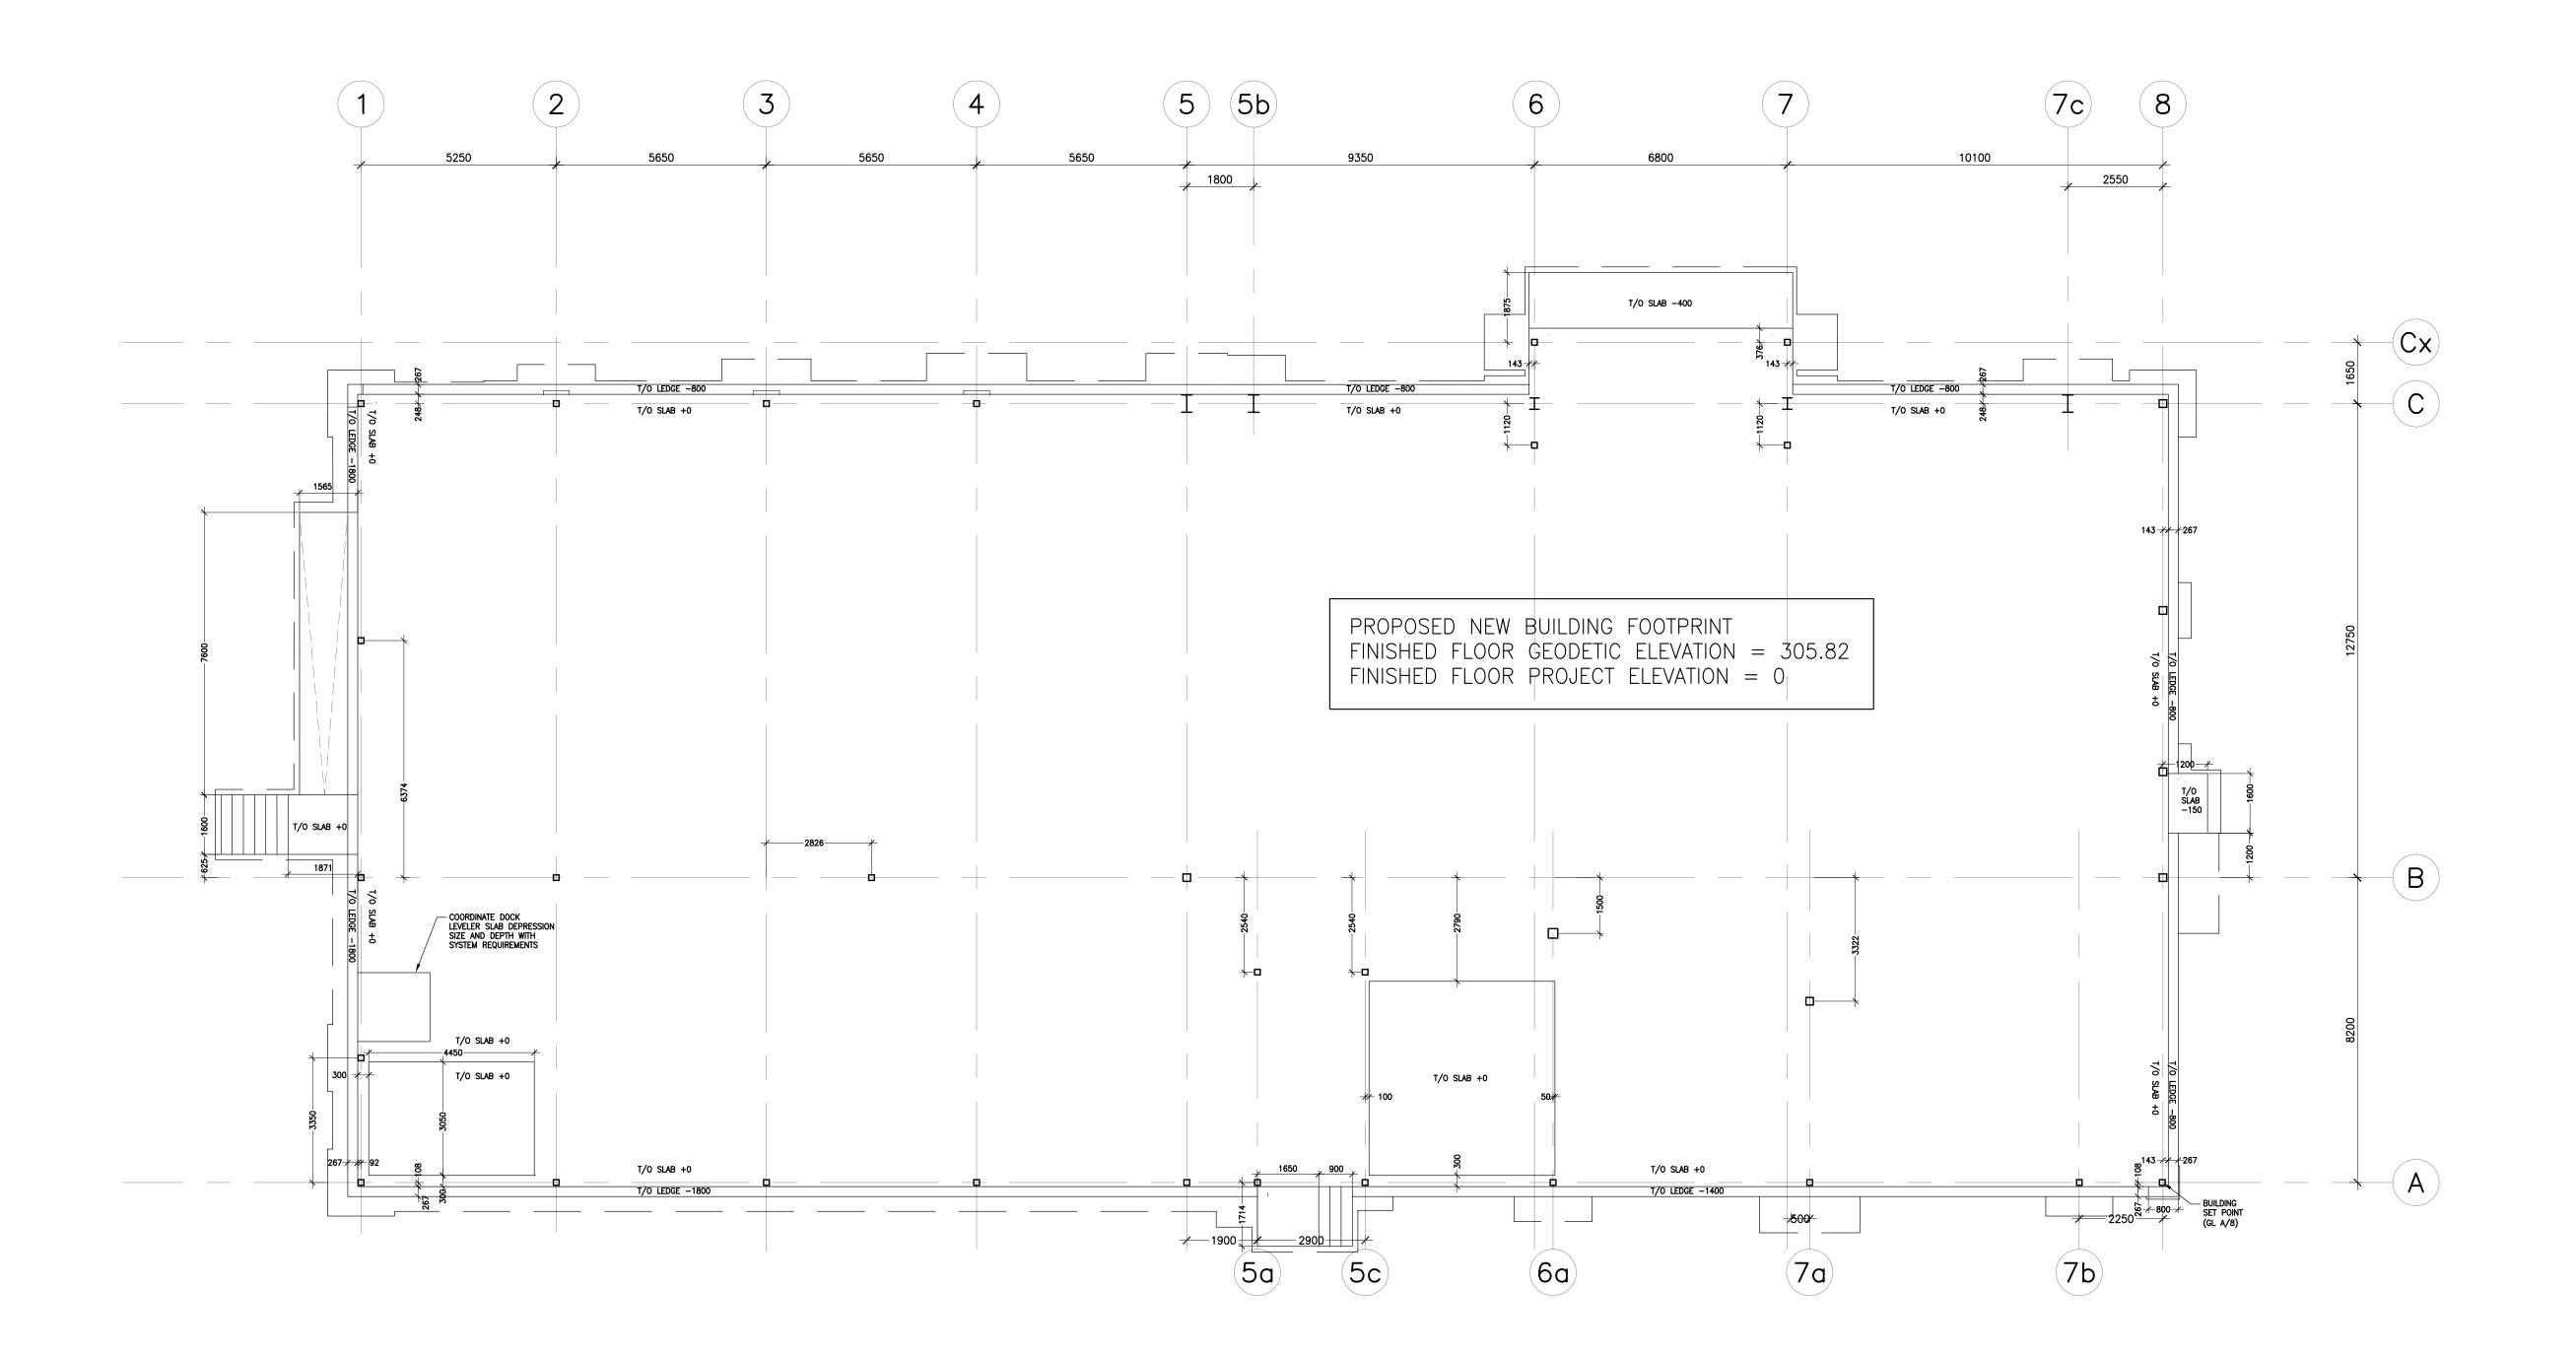

REVISIONS AND ISSUES

REV	DESCRIPTION	DATE	BY
1	REVISED SPA	210809	AB
2	ISSUED FOR TENDER	210824	AB
3	REVISION TO BUILDING PERMIT	220315	AB
4	SI-01	220615	AB
5	BLG SET-OUT CAD	220715	AB
6	ISSUED FOR CONSTRUCTION	220715	AB
7			

10

12

# MJMA

maclennan jaunkalns miller architects

425 adelaide street west level 6 toronto ontario m5v 3c1 416 593 6796 www.mjmarchitects.com

#### TRITON ENGINEERING SERVICES LTD

229 BROADWAY, UNIT 1
ORANGEVILLE, ONTARIO, L9W 1K4
TEL 519 941 0330 FAX 519 941 1830

TEL 519 941 0330 FAX 519 941

BLACKWELL

STRUCTURAL ENGINEERS

134 PETER STREET, SUITE 1301
TORONTO, ONTARIO, M5V 2H2
TEL 416.593.5300 FAX 416.593.4840

SMITH + ANDERSON

MECHANICAL AND ELECTRICAL ENGINEERS


1100 - 100 SHEPPARD AVENUE EAST
TORONTO, ONTARIO, M2N 6N5
TEL 416.487.8151 -

## SAYERS FOOD LIMITED

132 BURLEIGH STREET t: 705.656.4531 e: sayers@apsley.ca

NORTH ARR



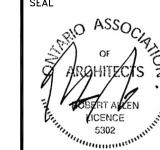

PROJECT T

NEW SAYERS FOOD STORE BURLEIGH STREET, APSLEY

DRAWING TIT


GROUND LEVEL SETOUT PLAN

1:100

JULY 15, 2022

PROJECT NUMBER

2102
DRAWING NUMBER

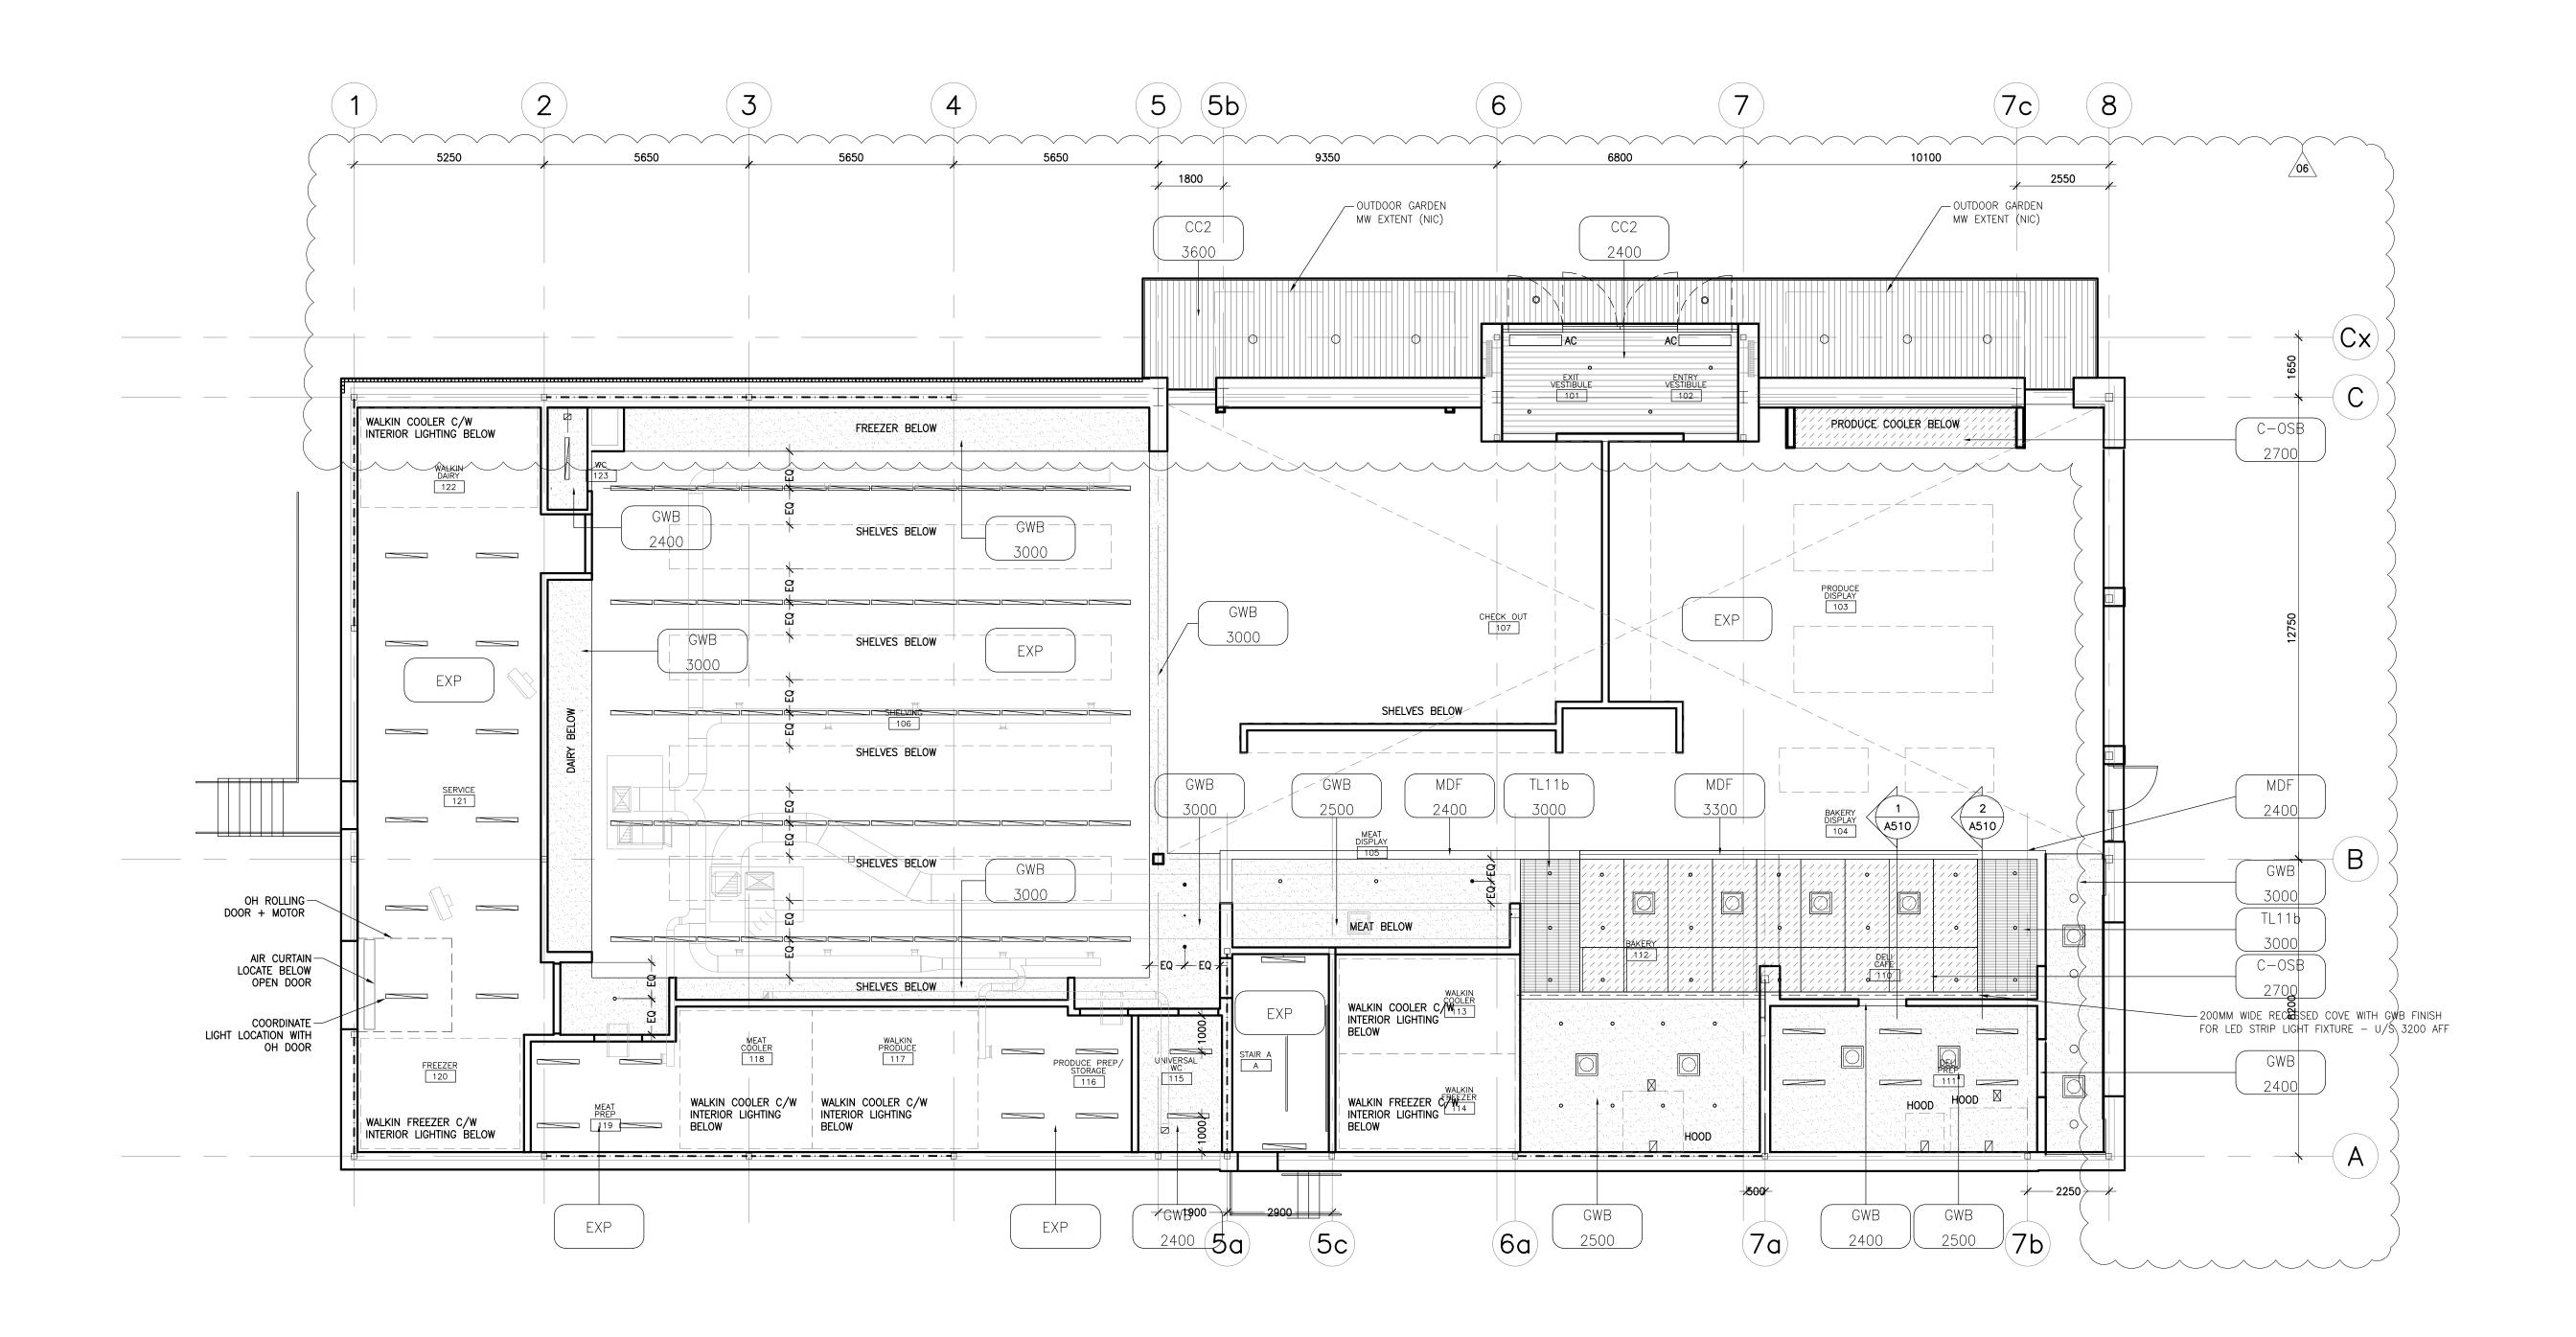

REVISIONS AND ISSUES

REV	DESCRIPTION	DATE	BY
1	REVISED SPA	210809	AB
2	ISSUED FOR TENDER	210824	AB
3	REVISION TO BUILDING PERMIT	220315	AB
4	SI-01	220615	AB
5	BLG SET-OUT CAD	220715	AB
6	ISSUED FOR CONSTRUCTION	220715	AB
7			

# MJMA

maclennan jaunkalns miller architects 425 adelaide street west level 6 toronto ontario m5v 3c1 416 593 6796

#### TRITON ENGINEERING SERVICES LTD CIVIL ENGINEERS

229 BROADWAY, UNIT 1 ORANGEVILLE, ONTARIO, L9W 1K4
TEL 519 941 0330 FAX 519 941 1830

BLACKWELL

www.mjmarchitects.com

STRUCTURAL ENGINEERS 134 PETER STREET, SUITE 1301 TORONTO, ONTARIO, M5V 2H2
TEL 416.593.5300 FAX 416.593.4840

SMITH + ANDERSON MECHANICAL AND ELECTRICAL ENGINEERS


1100 - 100 SHEPPARD AVENUE EAST TORONTO, ONTARIO, M2N 6N5

TEL 416.487.8151 -

## SAYERS FOOD LIMITED

132 BURLEIGH STREET t: 705.656.4531 e: sayers@apsley.ca

NORTH ARROW

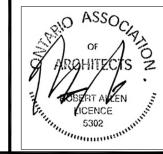

NEW SAYERS FOOD STORE BURLEIGH STREET, APSLEY

GROUND LEVEL REFLECTED CEILING PLANS


1:100

JULY 15, 2022

PROJECT NUMBER

2102

DRAWING NUMBER

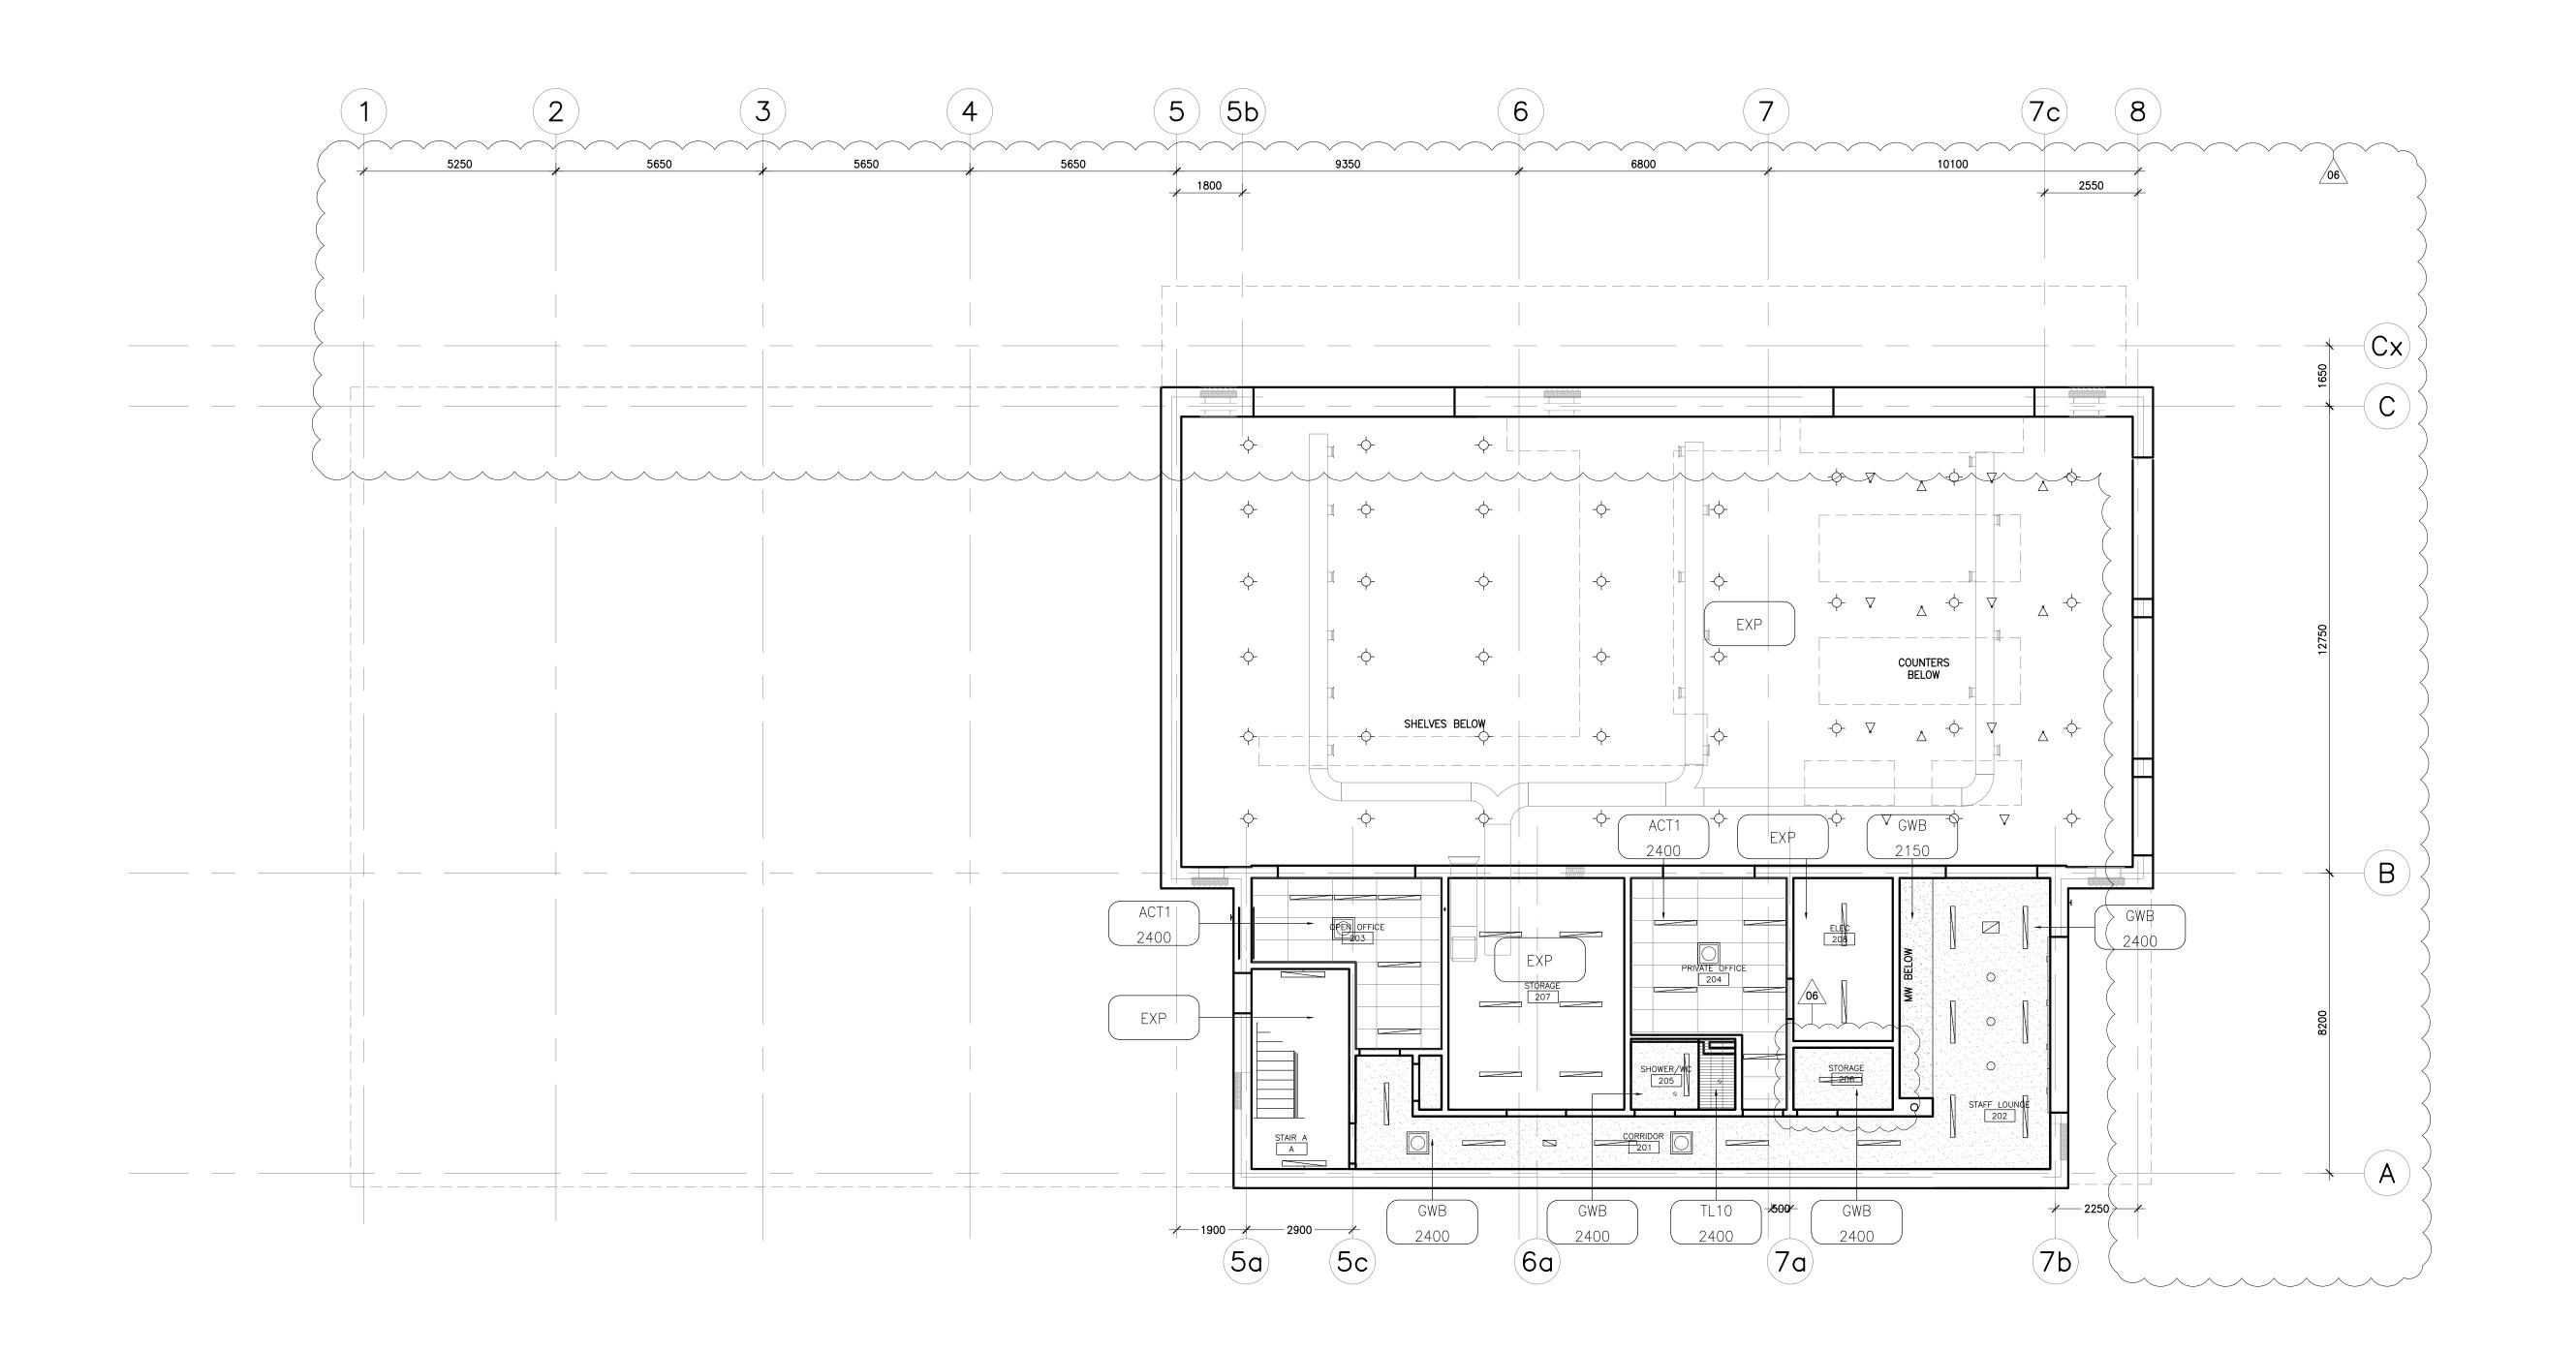

REVISIONS AND ISSUES

REV DESCRIPTION

1 REVISED SPA

 1
 REVISED SPA
 210809
 Af

 2
 ISSUED FOR TENDER
 210824
 Af

 3
 REVISION TO BUILDING PERMIT
 220315
 Af

 4
 SI-01
 220615
 Af

 5
 BLG SET-OUT CAD
 220715
 Af

 6
 ISSUED FOR CONSTRUCTION
 220715
 Af

9

11

# MJMA

www.mjmarchitects.com

maclennan jaunkalns miller architects

425 adelaide street west level 6
toronto ontario m5v 3c1
416 593 6796

# TRITON ENGINEERING SERVICES LTD CIVIL ENGINEERS

229 BROADWAY, UNIT 1 ORANGEVILLE, ONTARIO, L9W 1K4 TEL 519 941 0330 FAX 519 941 1830

#### BLACKWELL STRUCTURAL ENGINEERS

134 PETER STREET, SUITE 1301
TORONTO, ONTARIO, M5V 2H2
TEL 416.593.5300 FAX 416.593.4840

#### SMITH + ANDERSON MECHANICAL AND ELECTRICAL ENGINEERS

1100 - 100 SHEPPARD AVENUE EAST TORONTO, ONTARIO, M2N 6N5 TEL 416.487.8151 -

## SAYERS FOOD LIMITED

132 BURLEIGH STREET t: 705.656.4531 e: sayers@apsley.ca

NORTH ARROW



PROJECT T

NEW SAYERS FOOD STORE BURLEIGH STREET, APSLEY

DRAWING TITL


LEVEL 2 REFLECTED CEILING PLAN

1:100

JULY 15, 2022

PROJECT NUMBER

2102
DRAWING NUMBER

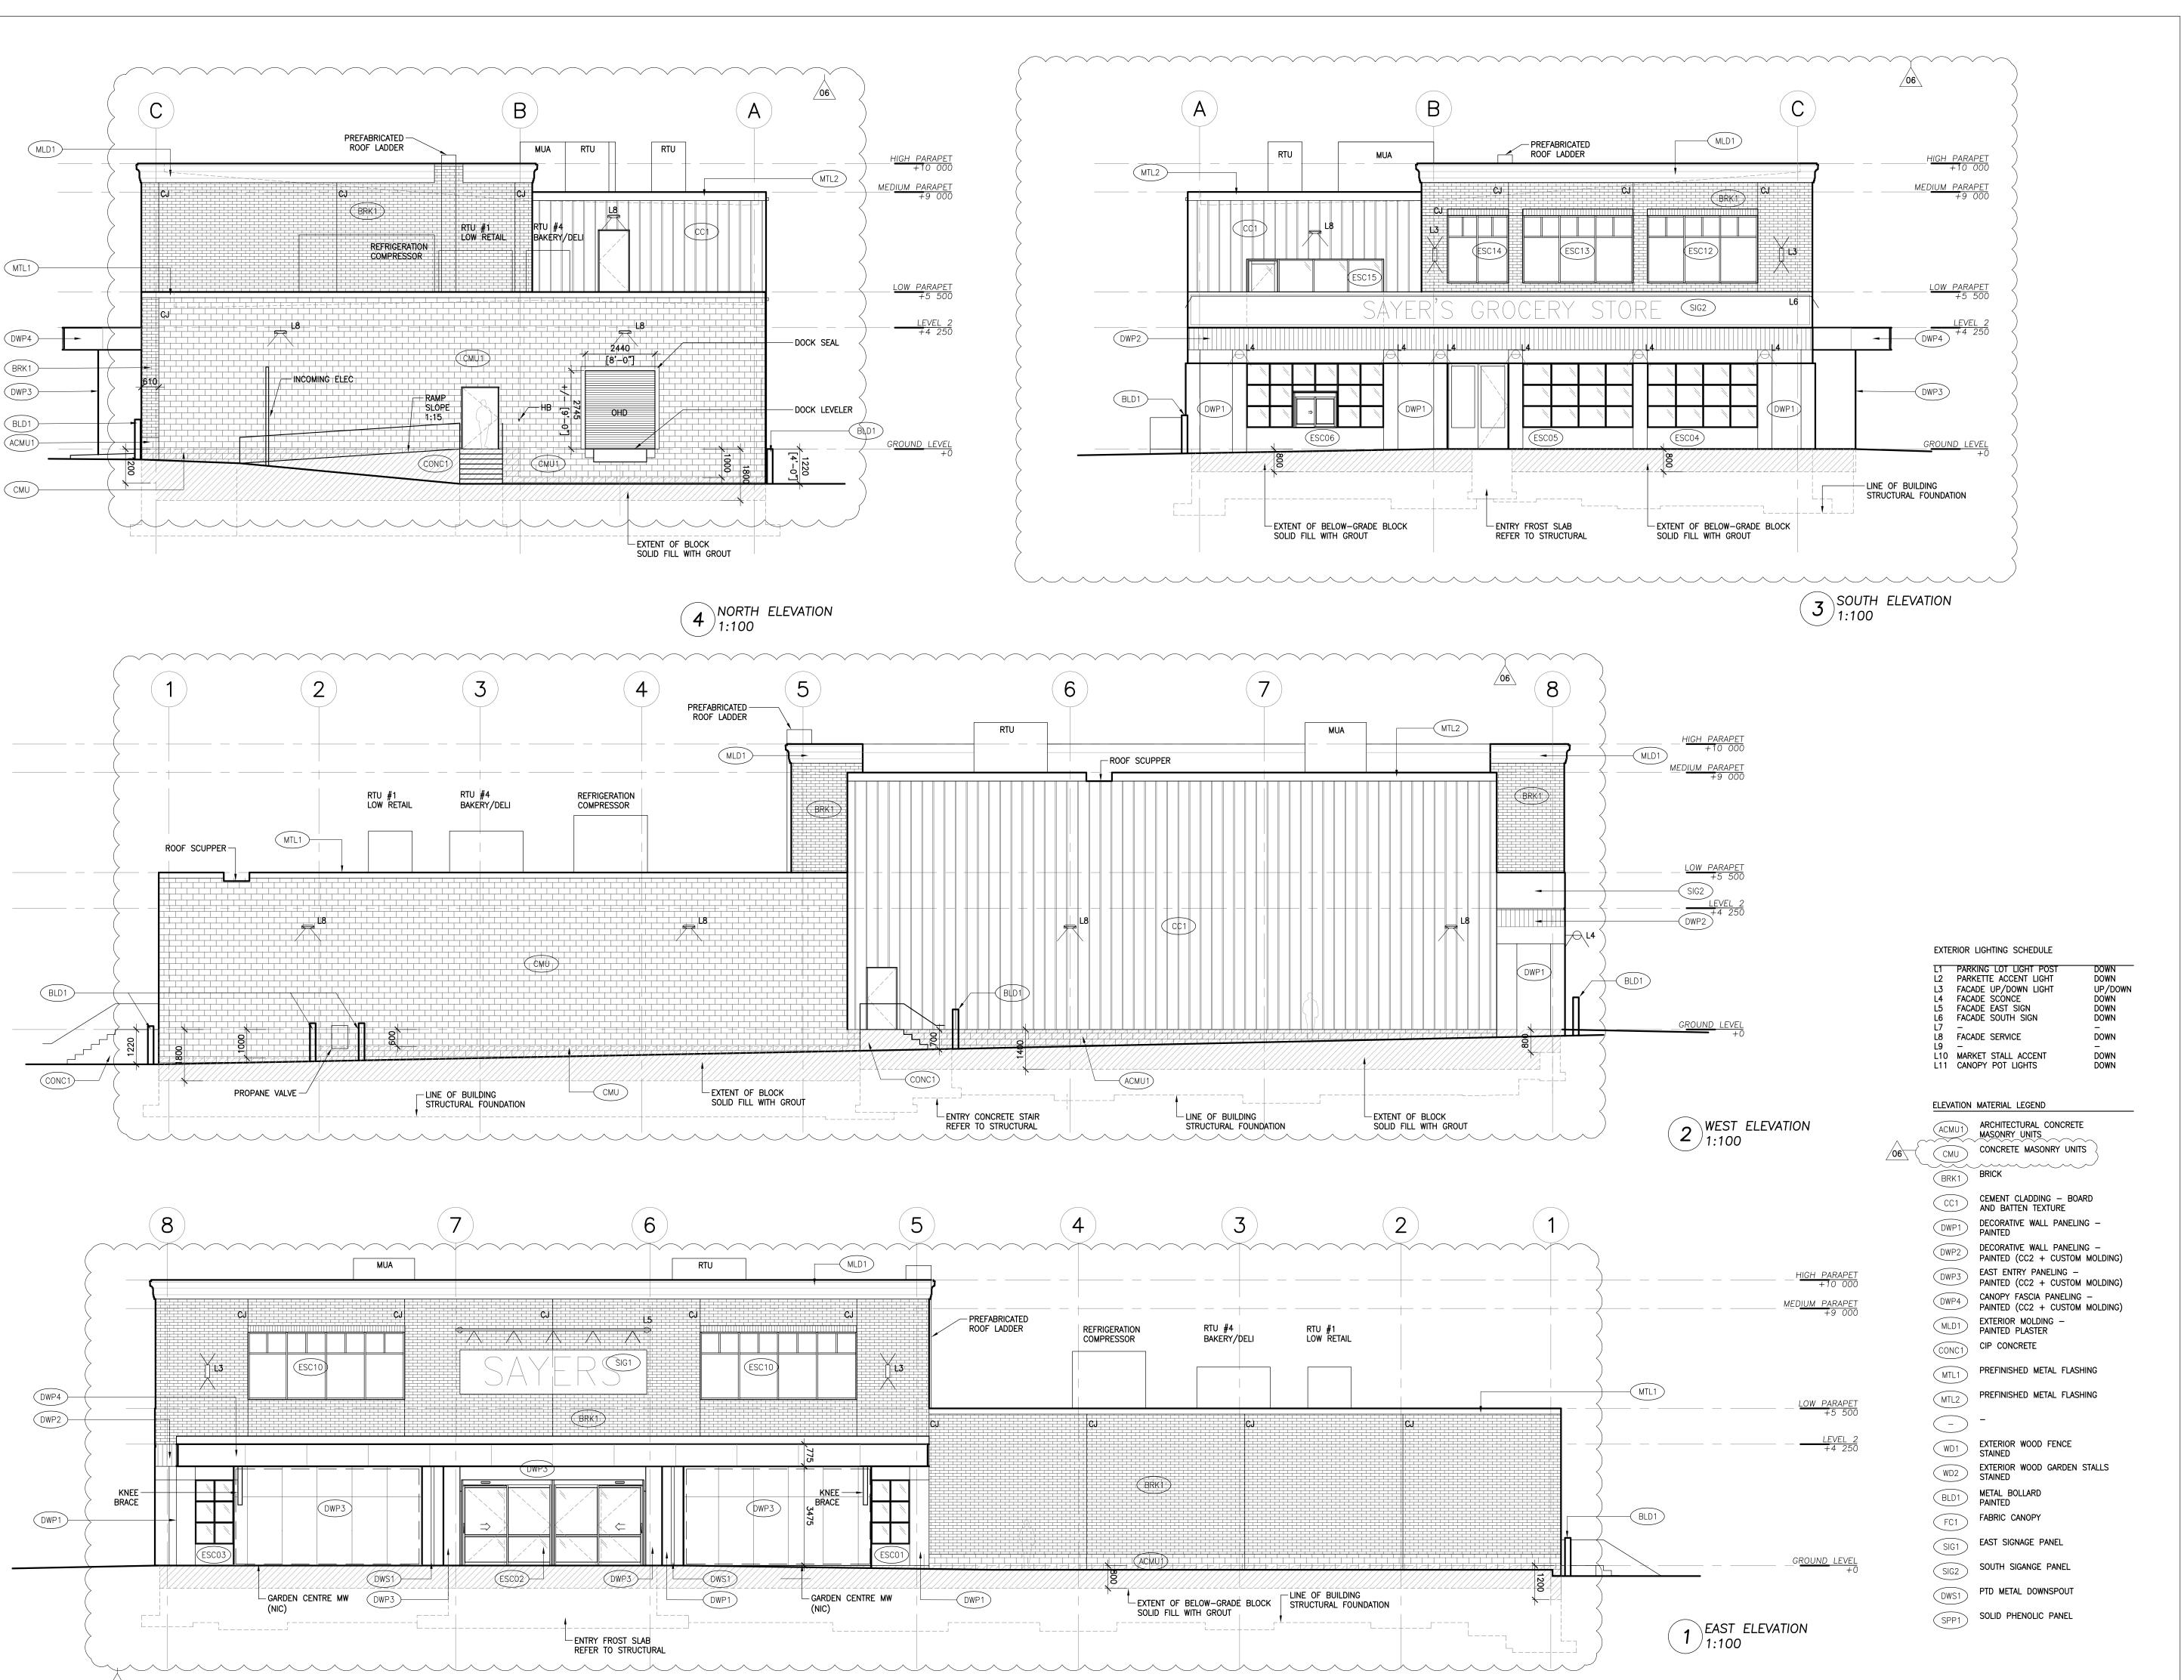

 REVISIONS AND ISSUES

 REV
 DESCRIPTION
 DATE

 1
 REVISED SPA
 210809

 2
 ISSUED FOR TENDER
 210824

 3
 REVISION TO BUILDING PERMIT
 220315

 4
 SI-01
 220615

BLG SET-OUT CAD

ISSUED FOR CONSTRUCTION

220715

220715

9 10

# MJMA

maclennan jaunkalns miller architects
425 adelaide street west level 6

toronto ontario m5v 3c1 416 593 6796 www.mjmarchitects.com

#### TRITON ENGINEERING SERVICES LTD CIVIL ENGINEERS

229 BROADWAY, UNIT 1
ORANGEVILLE, ONTARIO, L9W 1K4
TEL 519 941 0330 FAX 519 941 1830

TEL 519 941 0330 FAX 519 941 1

BLACKWELL

STRUCTURAL ENGINEERS

134 PETER STREET, SUITE 1301
TORONTO, ONTARIO, M5V 2H2
TEL 416.593.5300 FAX 416.593.4840

SMITH + ANDERSON

MECHANICAL AND ELECTRICAL ENGINEERS

1100 – 100 SHEPPARD AVENUE EAST TORONTO, ONTARIO, M2N 6N5

TEL 416.487.8151 -

## SAYERS FOOD LIMITED

132 BURLEIGH STREET t: 705.656.4531 e: sayers@apsley.ca

NORTH ARROW



PROJECT TITLE

NEW SAYERS FOOD STORE BURLEIGH STREET, APSLEY

DRAWING TITLE

BUILDING ELEVATIONS

1:100


DATE
IIIV 15 2022

JULY 15, 2022

PROJECT NUMBER

2102

DRAWING NUMBER

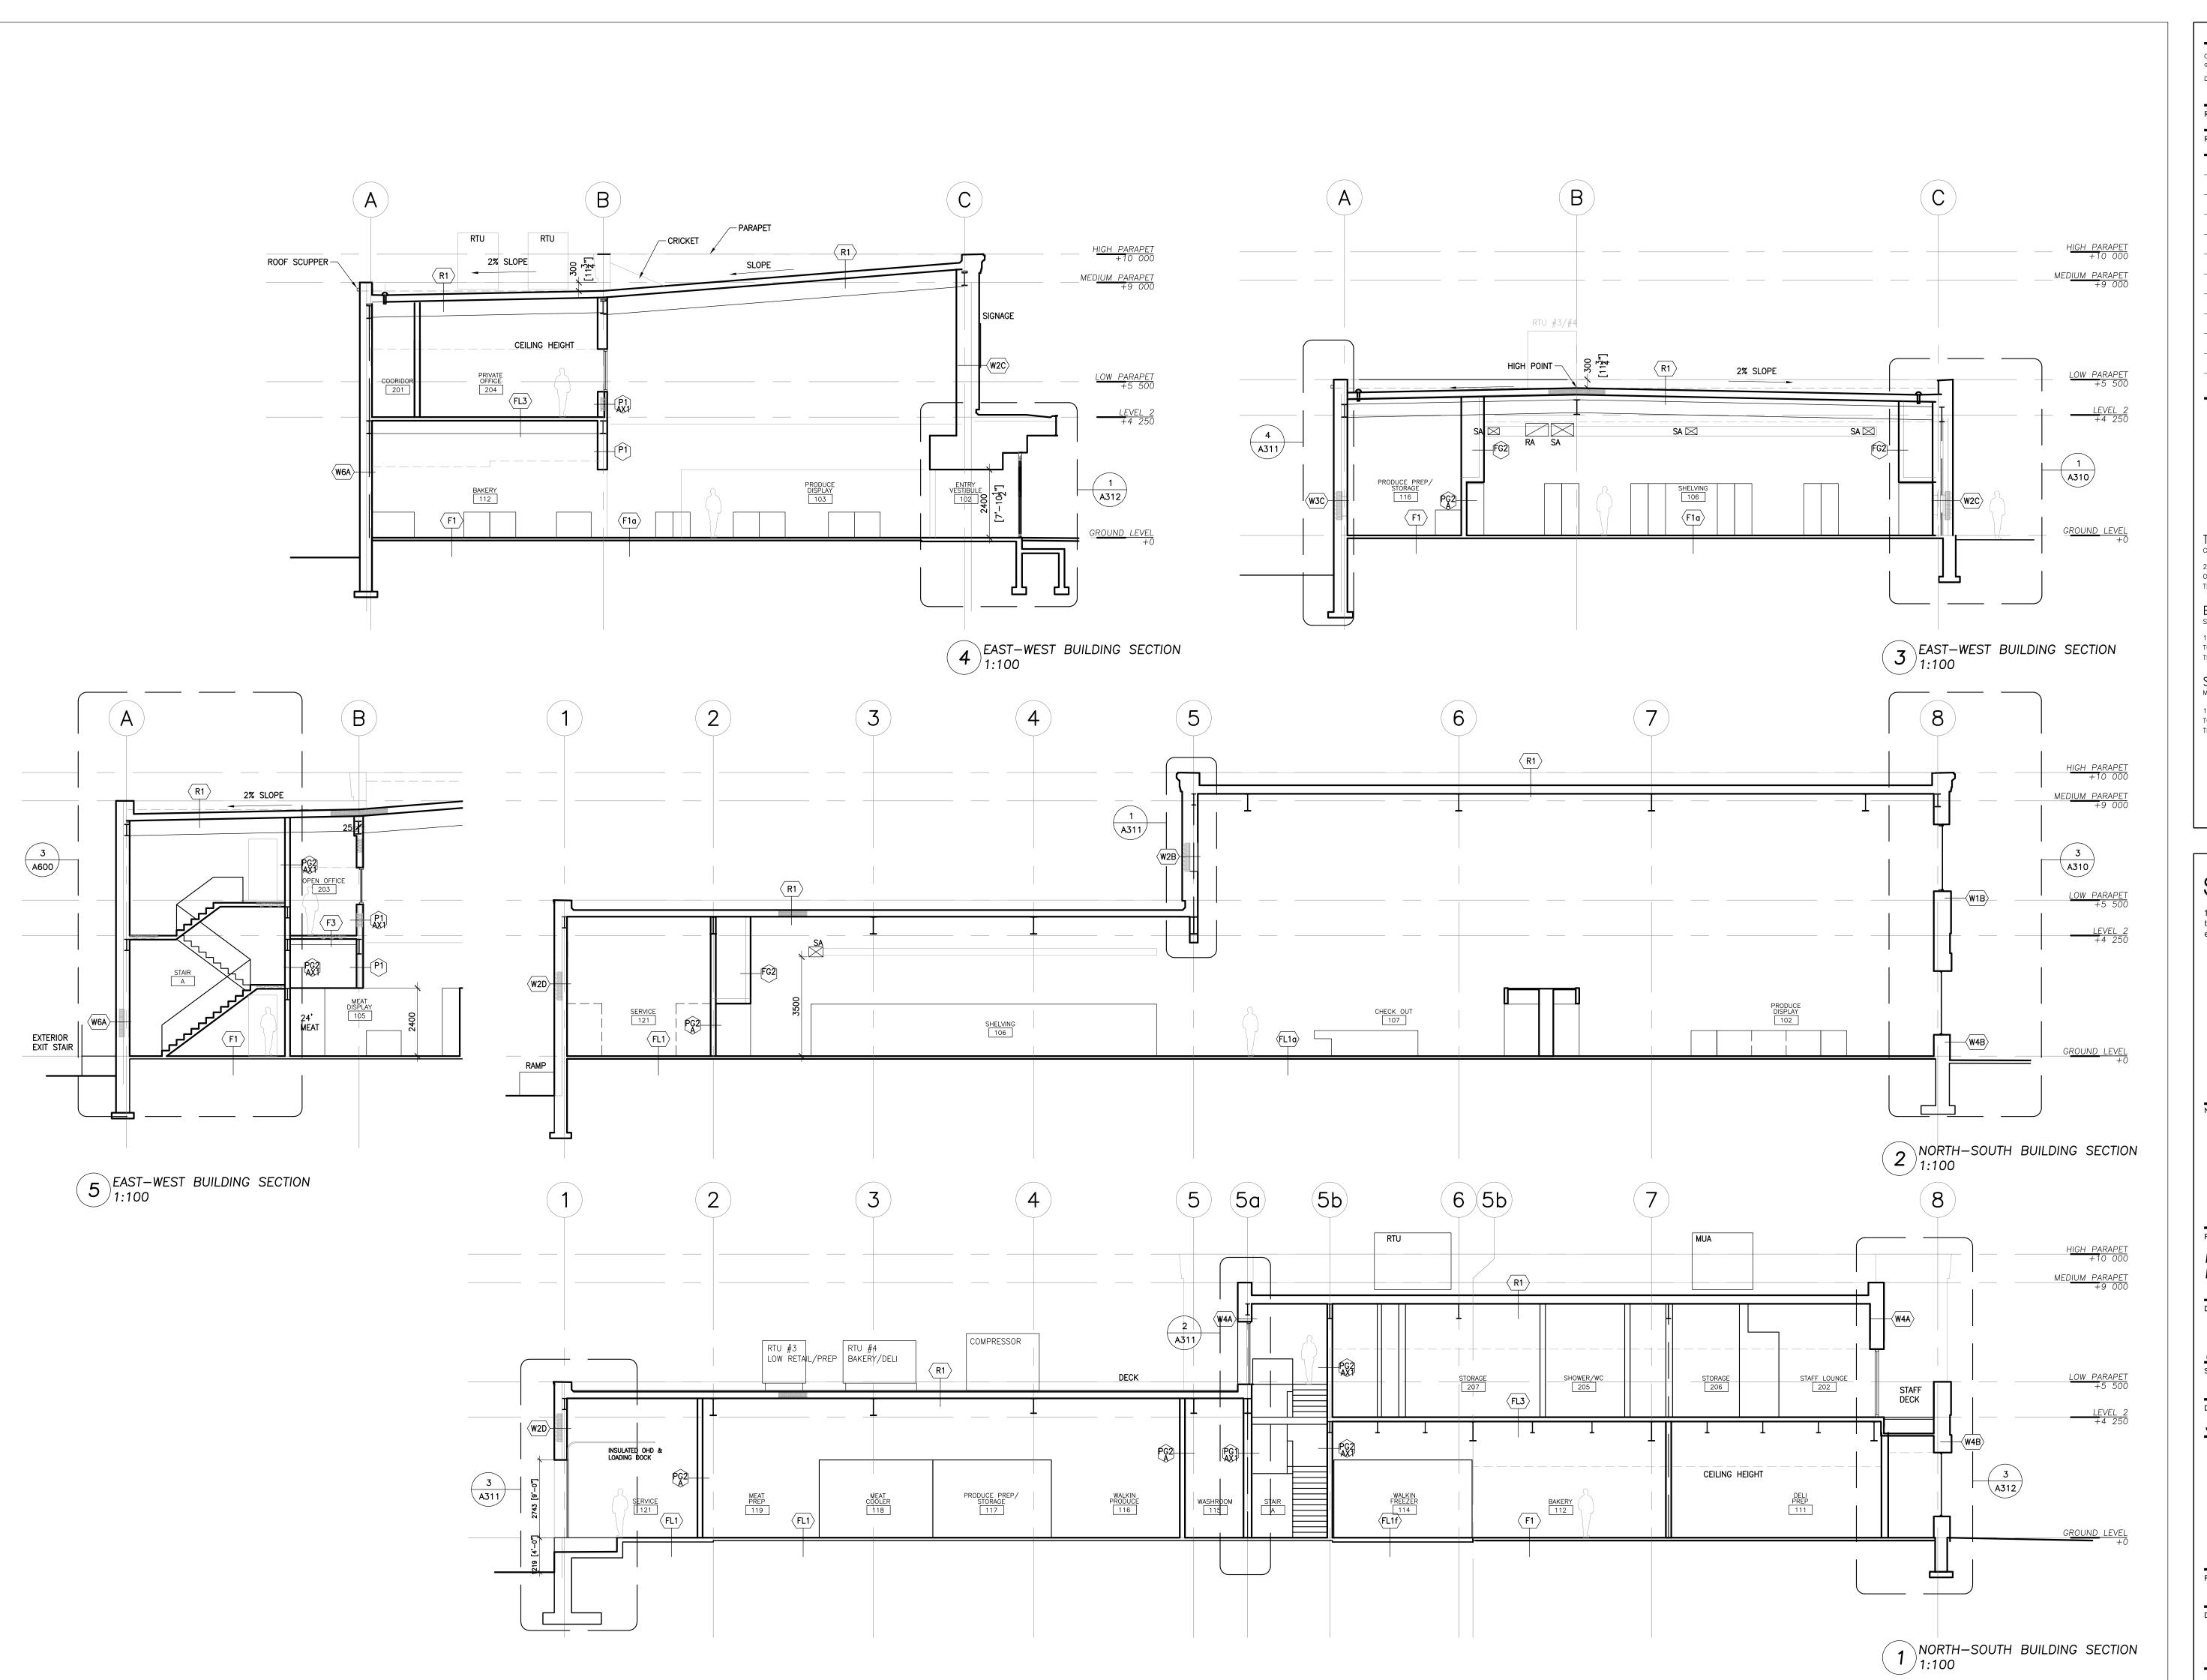

 REV
 DESCRIPTION
 DATE

 1
 REVISED SPA
 210809

 2
 ISSUED FOR TENDER
 210824

 3
 REVISION TO BUILDING PERMIT
 220315

 4
 SI-01
 220615

 5
 BLG SET-OUT CAD
 220715

 6
 ISSUED FOR CONSTRUCTION
 220715

 7
 8

 9

# **MJMA**

maclennan jaunkalns miller architects

425 adelaide street west level 6 toronto ontario m5v 3c1 416 593 6796 www.mjmarchitects.com

### TRITON ENGINEERING SERVICES LTD CIVIL ENGINEERS

229 BROADWAY, UNIT 1
ORANGEVILLE, ONTARIO, L9W 1K4

ORANGEVILLE, ONTARIO, L9W 1K4
TEL 519 941 0330 FAX 519 941 1830

BLACKWELL STRUCTURAL ENGINEERS

134 PETER STREET, SUITE 1301 TORONTO, ONTARIO, M5V 2H2 TEL 416.593.5300 FAX 416.593.4840

SMITH + ANDERSON


MECHANICAL AND ELECTRICAL ENGINEERS

1100 - 100 SHEPPARD AVENUE EAST
TORONTO, ONTARIO, M2N 6N5
TEL 416.487.8151 -

# SAYERS FOOD LIMITED

132 BURLEIGH STREET t: 705.656.4531 e: sayers@apsley.ca

NORTH ARROW

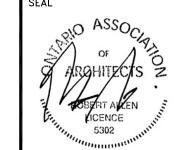

PROJECT TITLE

NEW SAYERS FOOD STORE BURLEIGH STREET, APSLEY

DRAWING TITLE

BUILDING SECTIONS


1:100

DATE

JULY 15, 2022

PROJECT NUMBER

2102
DRAWING NUMBER

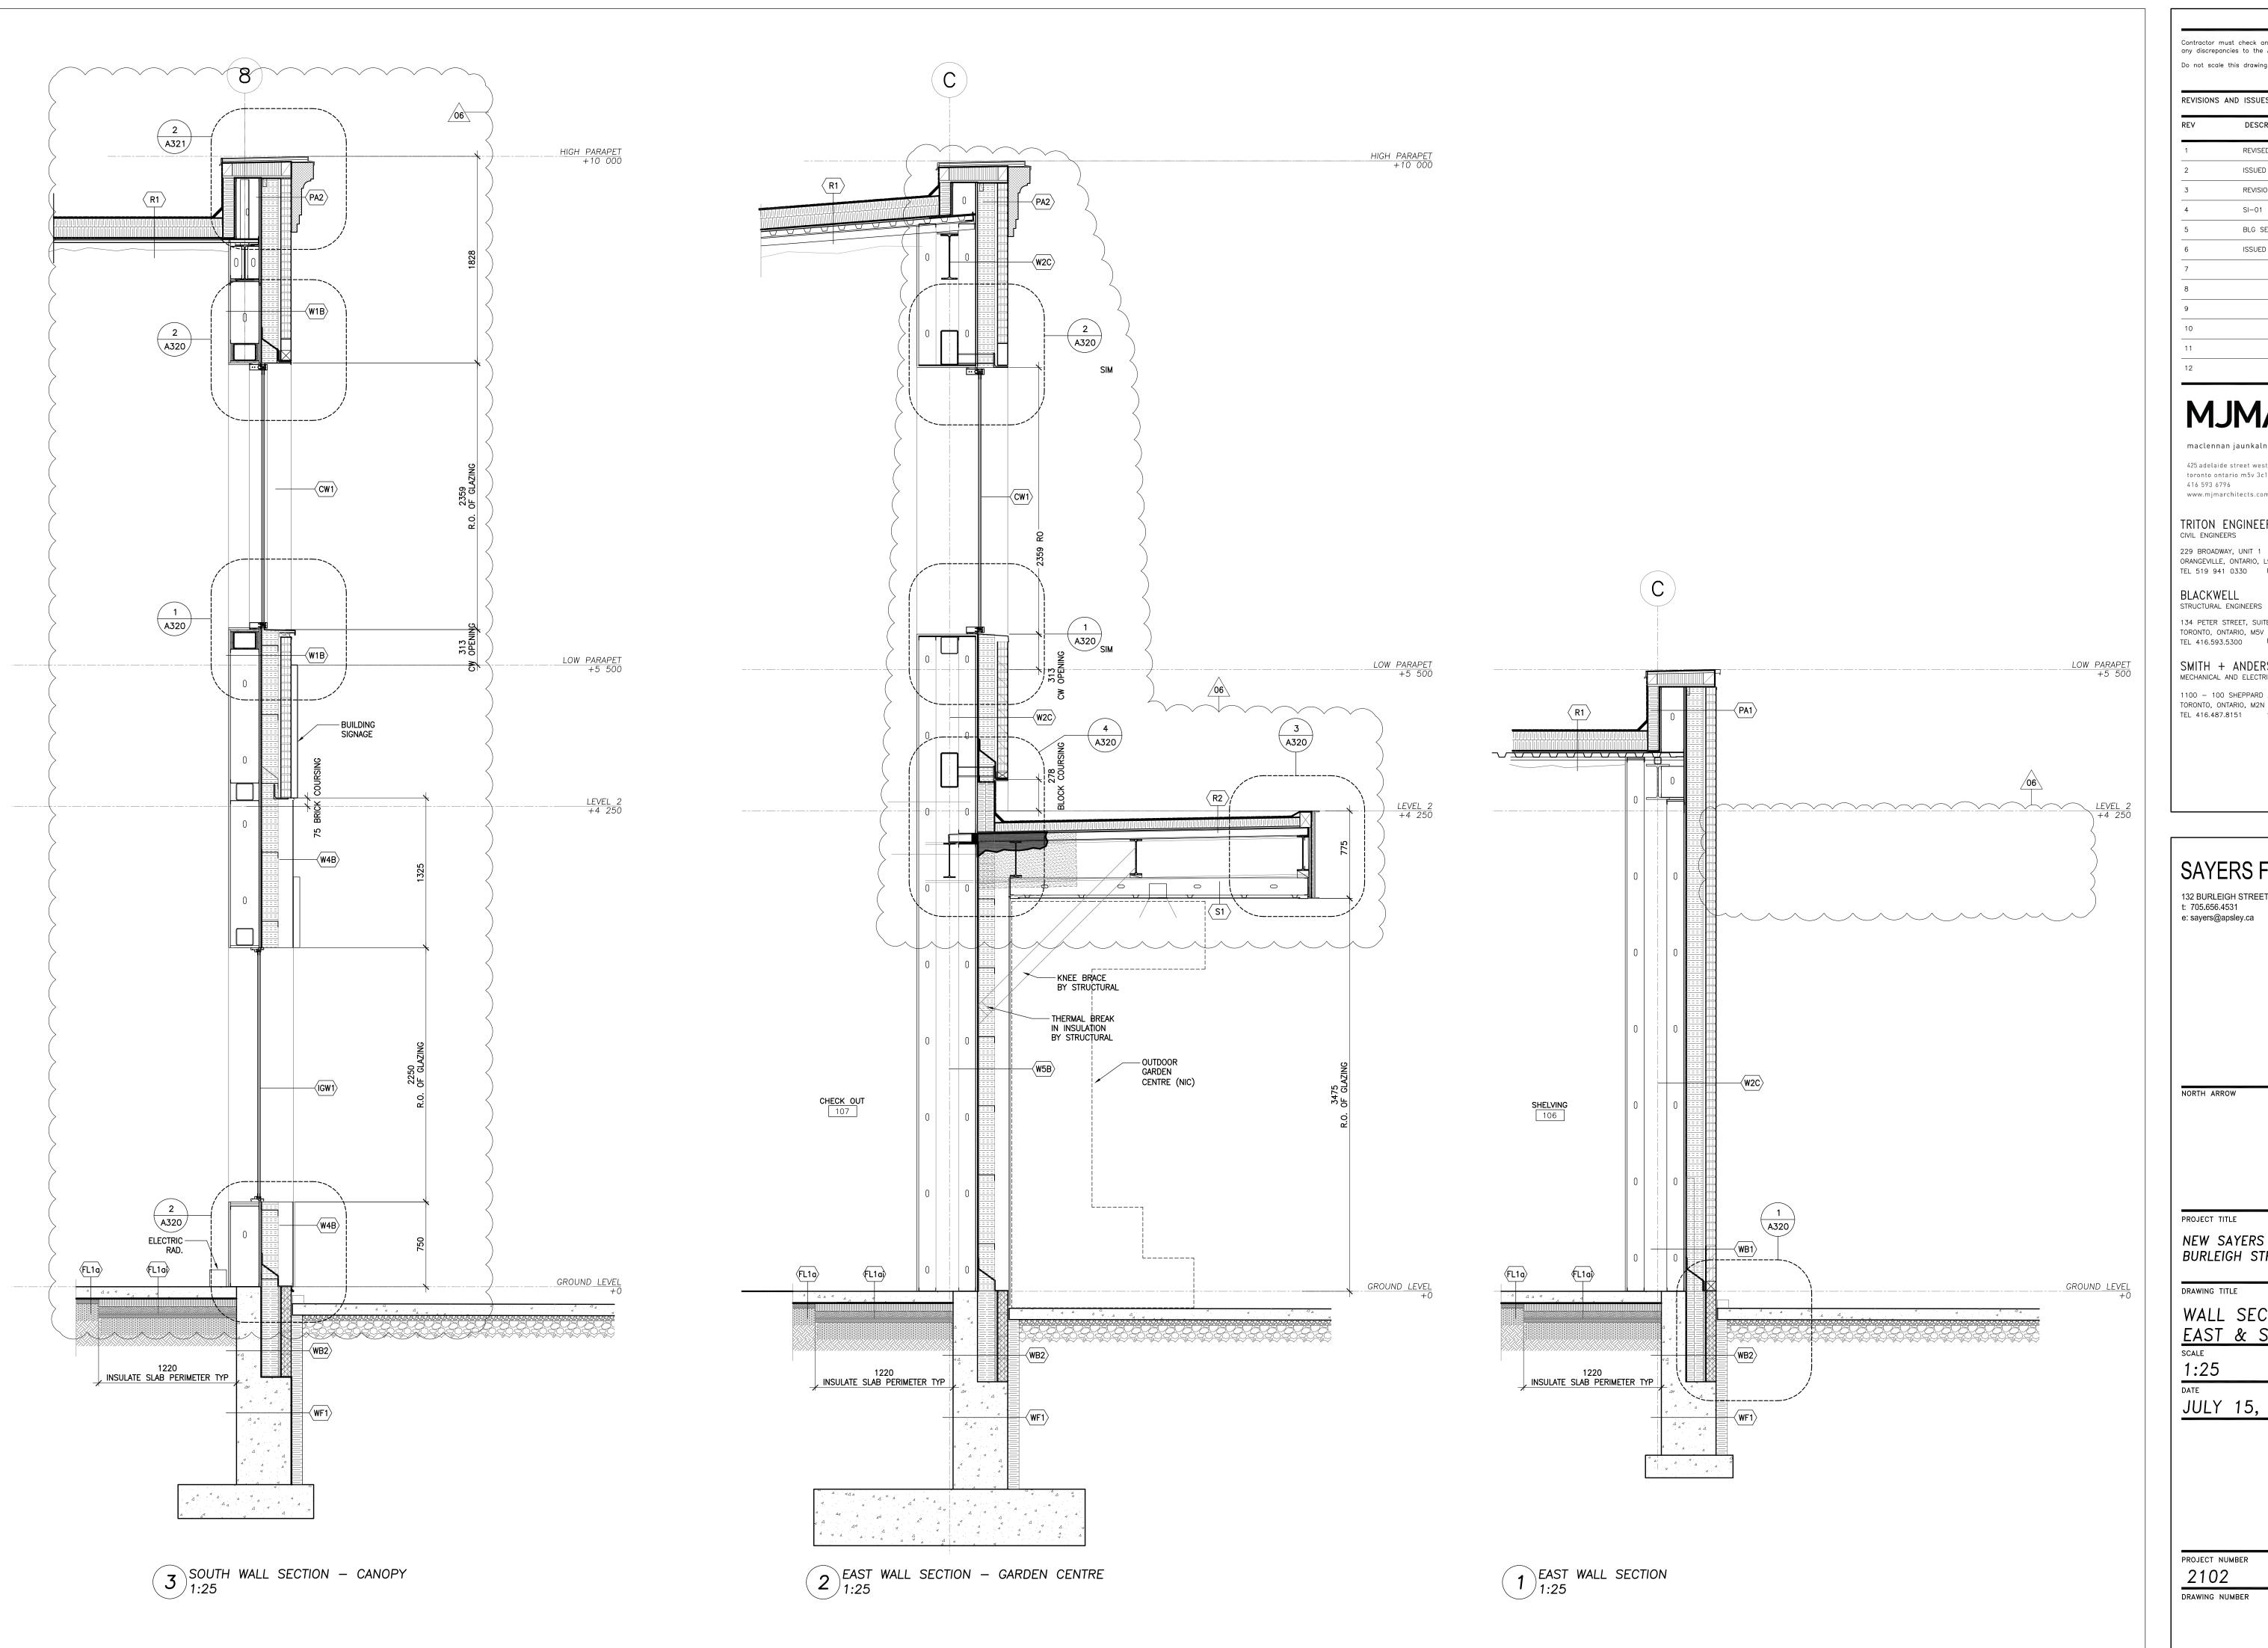

REVISIONS AND ISSUES DESCRIPTION REVISED SPA 210809 ISSUED FOR TENDER 210824 REVISION TO BUILDING PERMIT 220315 220615 BLG SET-OUT CAD 220715 ISSUED FOR CONSTRUCTION 220715

# **MJMA**

maclennan jaunkalns miller architects

425 adelaide street west level 6 toronto ontario m5v 3c1 416 593 6796 www.mjmarchitects.com

#### TRITON ENGINEERING SERVICES LTD

229 BROADWAY, UNIT 1 ORANGEVILLE, ONTARIO, L9W 1K4
TEL 519 941 0330 FAX 519 941 1830

BLACKWELL


134 PETER STREET, SUITE 1301 TORONTO, ONTARIO, M5V 2H2
TEL 416.593.5300 FAX 416.593.4840

SMITH + ANDERSON MECHANICAL AND ELECTRICAL ENGINEERS

1100 — 100 SHEPPARD AVENUE EAST TORONTO, ONTARIO, M2N 6N5 TEL 416.487.8151 —

## SAYERS FOOD LIMITED

132 BURLEIGH STREET t: 705.656.4531 e: sayers@apsley.ca

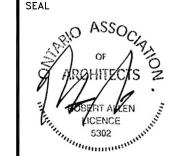


NEW SAYERS FOOD STORE BURLEIGH STREET, APSLEY

WALL SECTIONS EAST & SOUTH FACADES

1:25

JULY 15, 2022

2102

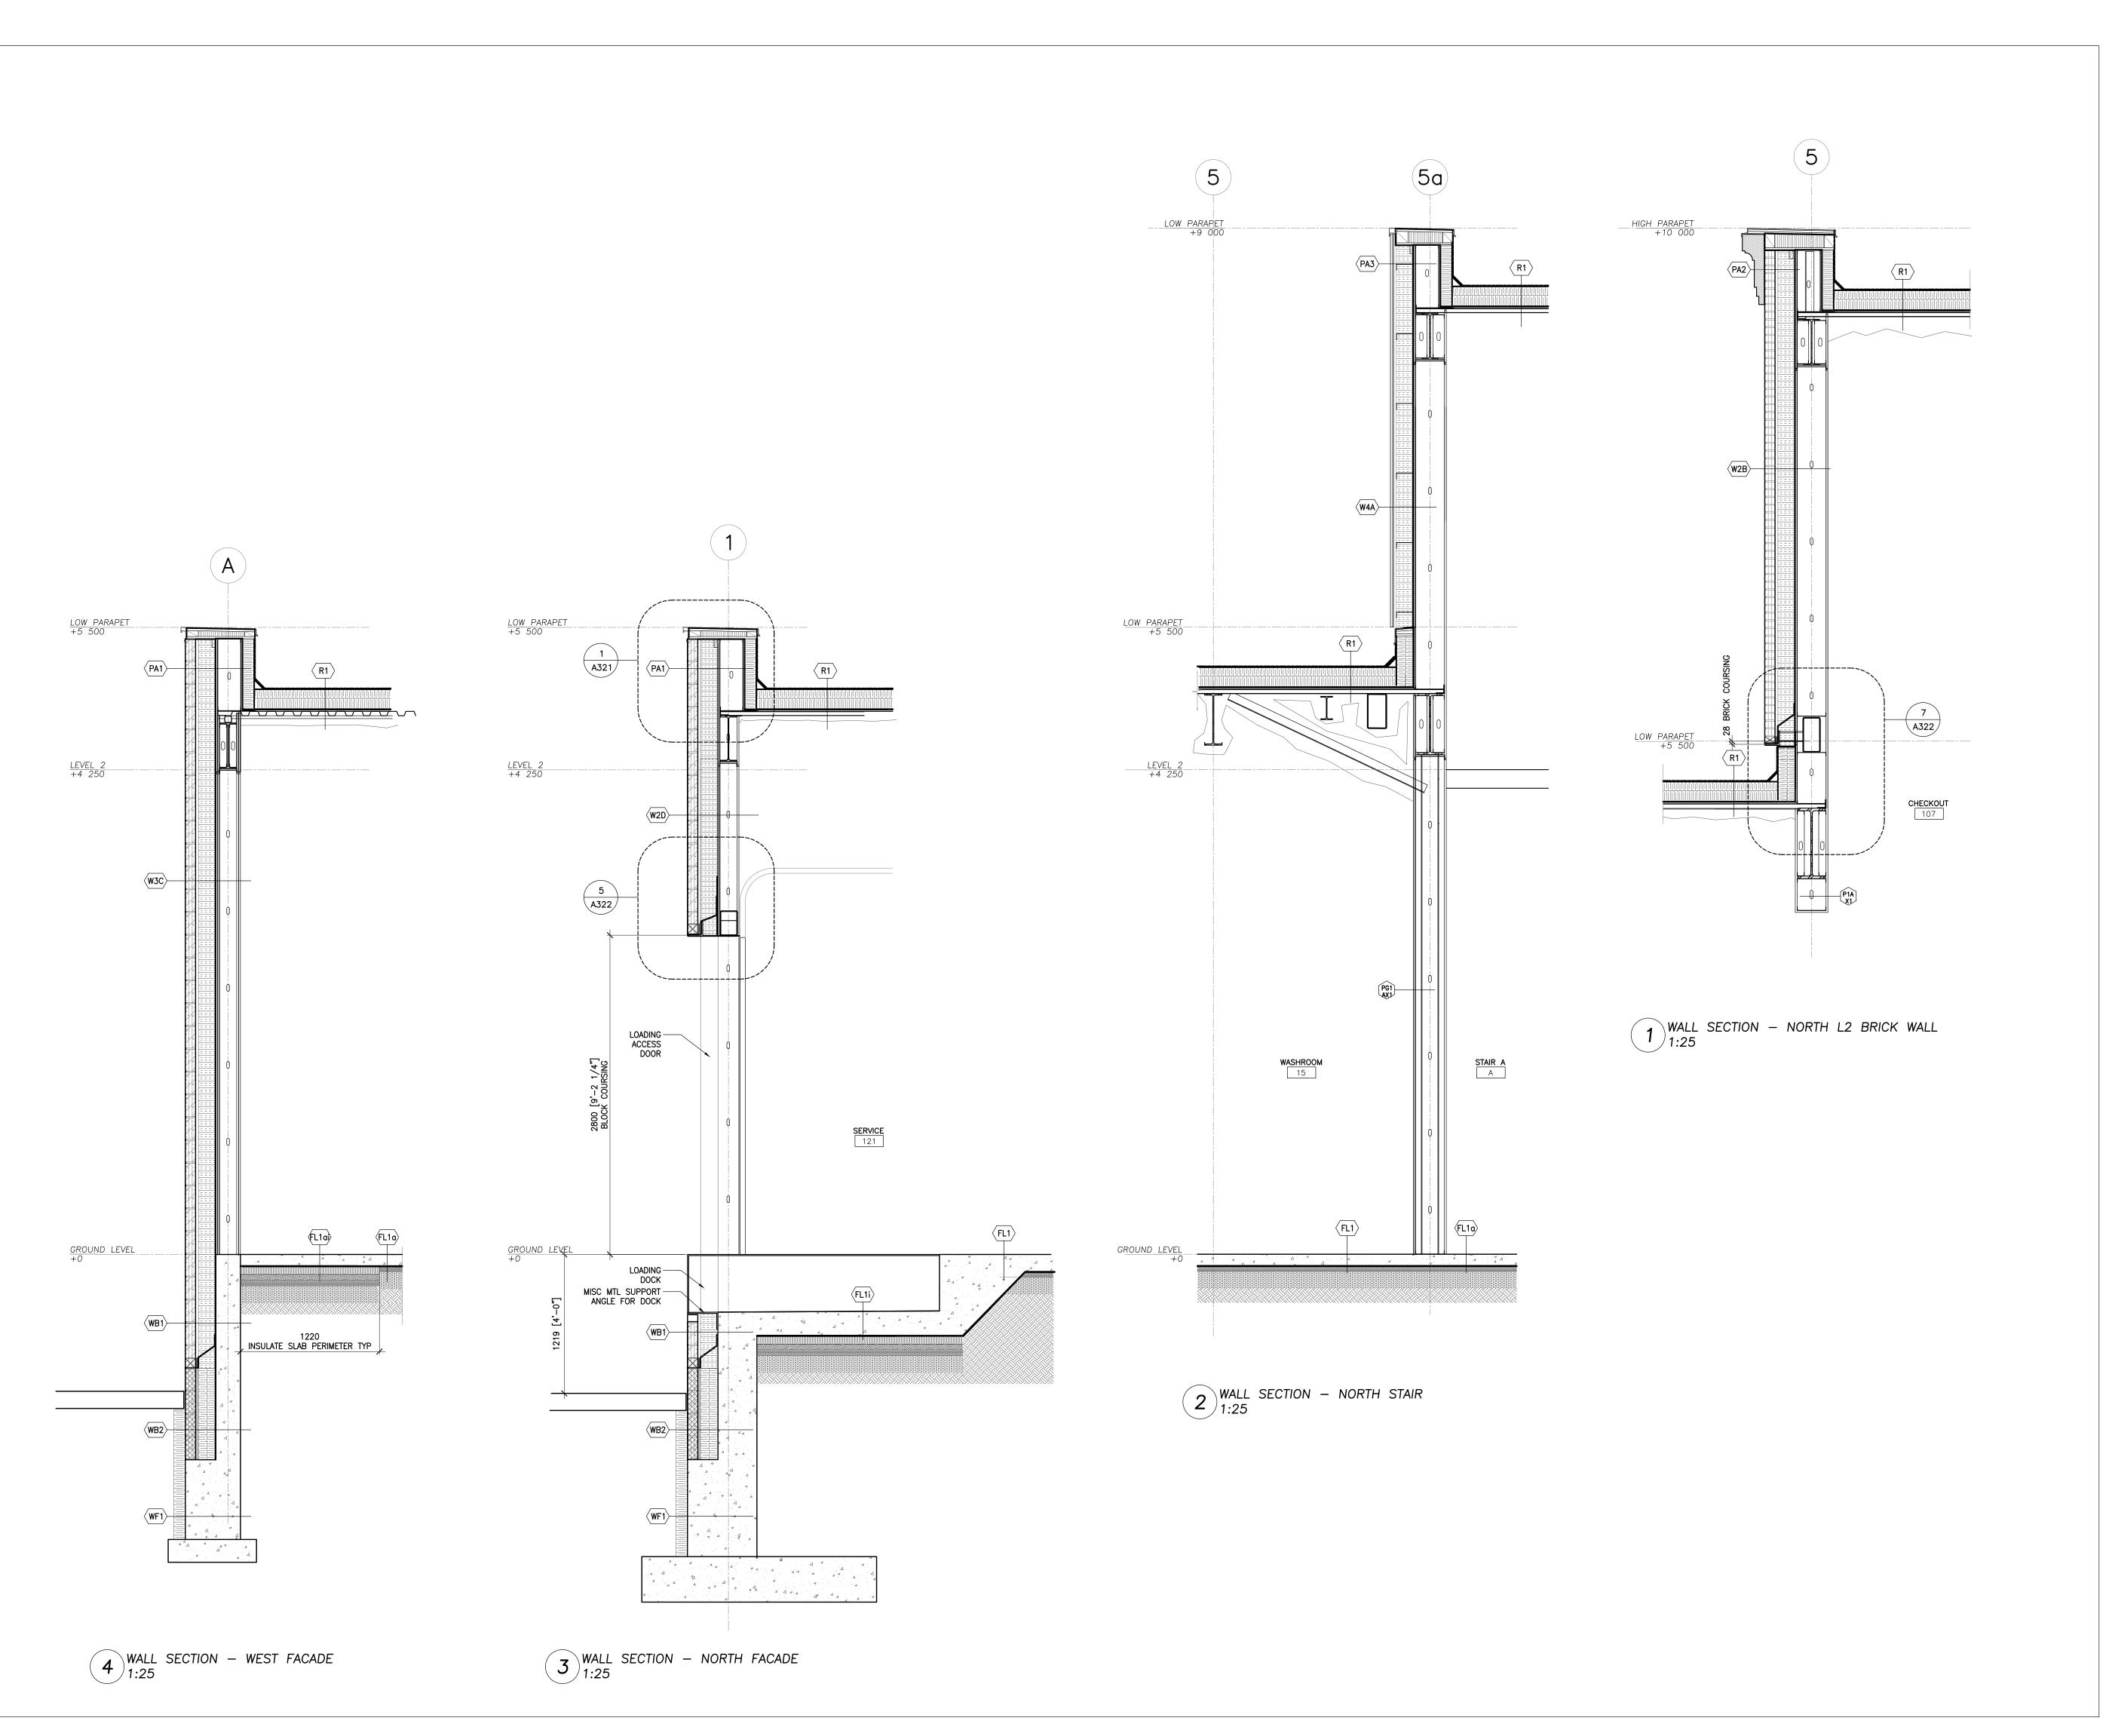

REVISIONS	AND ISSUES		
REV	DESCRIPTION	DATE	E
1	REVISED SPA	210809	Д
2	ISSUED FOR TENDER	210824	Д
3	REVISION TO BUILDING PERMIT	220315	Д
4	SI-01	220615	Δ
5	BLG SET-OUT CAD	220715	Α
6	ISSUED FOR CONSTRUCTION	220715	A
7			

# **MJMA**

maclennan jaunkalns miller architects

425 adelaide street west level 6 toronto ontario m5v 3c1 416 593 6796 www.mjmarchitects.com

## TRITON ENGINEERING SERVICES LTD CIVIL ENGINEERS

229 BROADWAY, UNIT 1
ORANGEVILLE, ONTARIO, L9W 1K4
TEL 519 941 0330 FAX 519 941 1830

BLACKWELL

STRUCTURAL ENGINEERS


134 PETER STREET, SUITE 1301 TORONTO, ONTARIO, M5V 2H2 TEL 416.593.5300 FAX 416.593.4840

SMITH + ANDERSON MECHANICAL AND ELECTRICAL ENGINEERS

1100 — 100 SHEPPARD AVENUE EAST TORONTO, ONTARIO, M2N 6N5 TEL 416.487.8151 —

## SAYERS FOOD LIMITED

132 BURLEIGH STREET t: 705.656.4531 e: sayers@apsley.ca

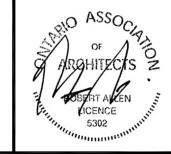


NEW SAYERS FOOD STORE BURLEIGH STREET, APSLEY

WALL SECTIONS
NORTH & WEST FACADES
scale
1:25

JULY 15, 2022

2102
DRAWING NUMBER

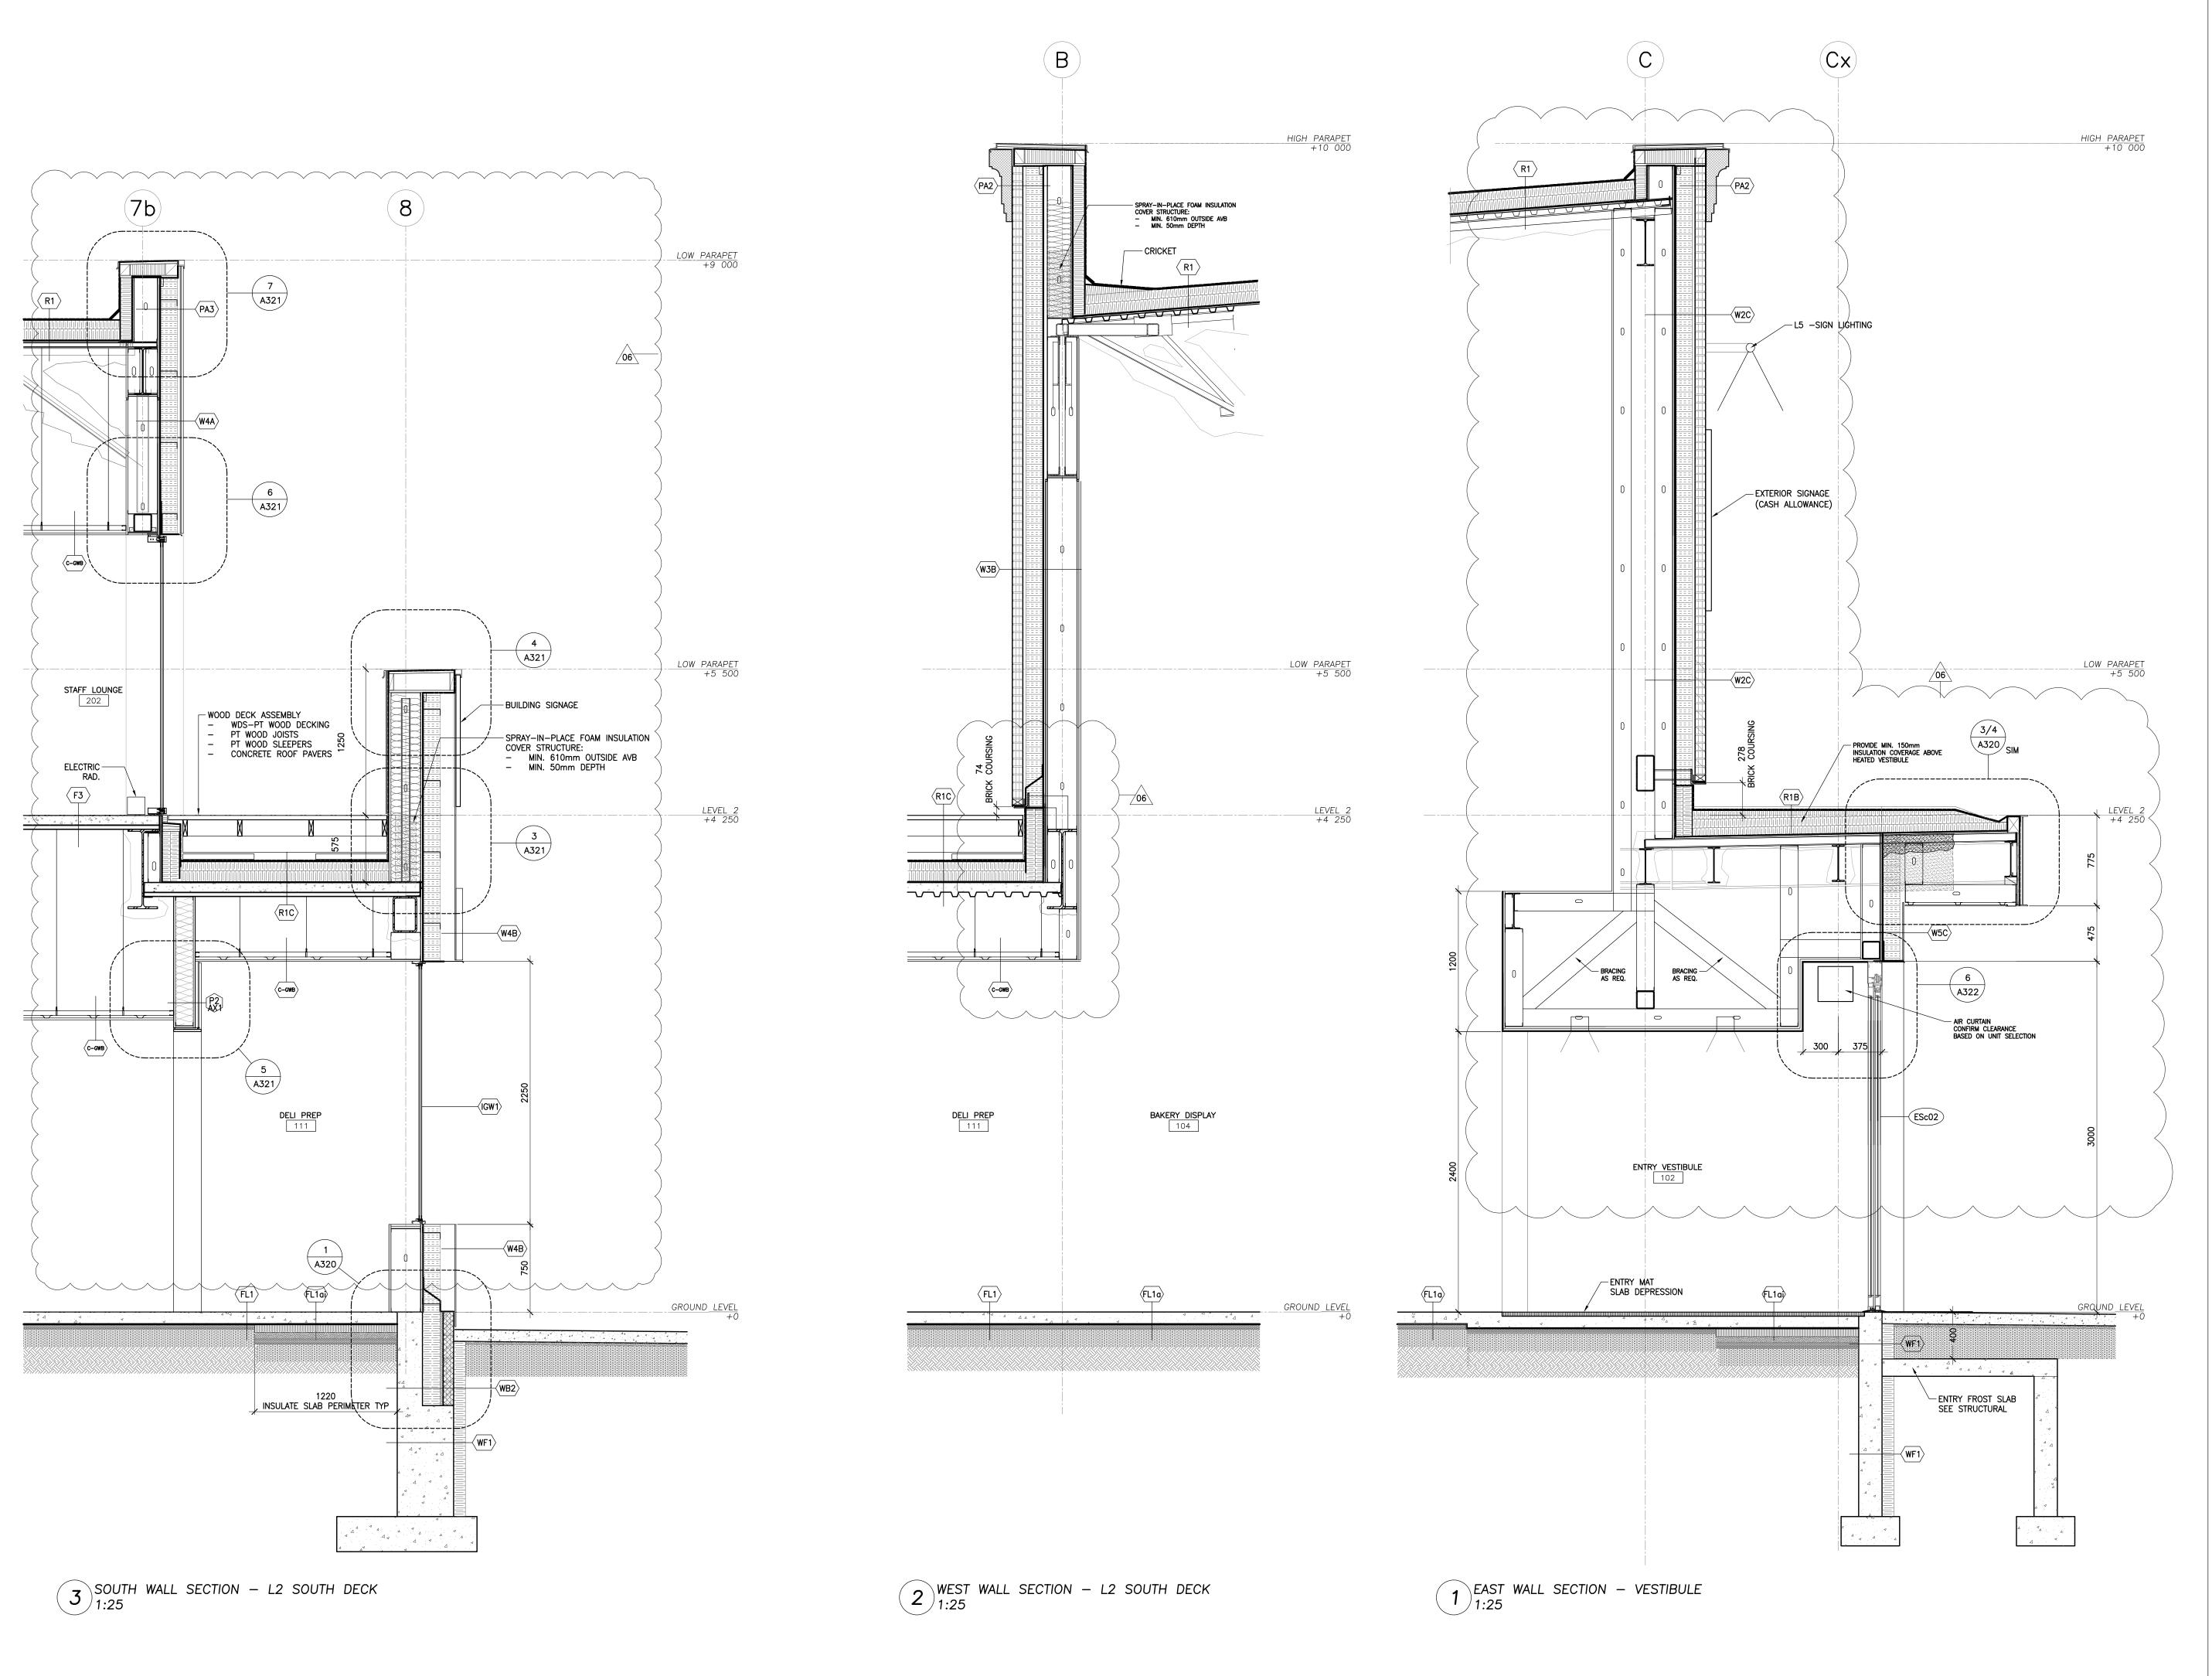

 REVISIONS AND ISSUES

 REV
 DESCRIPTION
 DATE

 1
 REVISED SPA
 210809

 2
 ISSUED FOR TENDER
 210824

 3
 REVISION TO BUILDING PERMIT
 220315

 4
 SI-01
 220615

 5
 BLG SET-OUT CAD
 220715

ISSUED FOR CONSTRUCTION 220715

10

# **MJMA**

maclennan jaunkalns miller architects
425 adelaide street west level 6

toronto ontario m5v 3c1 416 593 6796 www.mjmarchitects.com

#### TRITON ENGINEERING SERVICES LTD

229 BROADWAY, UNIT 1
ORANGEVILLE, ONTARIO, L9W 1K4
TEL 519 941 0330 FAX 519 941 1830

BLACKWELL

134 PETER STREET, SUITE 1301 TORONTO, ONTARIO, M5V 2H2 TEL 416.593.5300 FAX 416.593.4840

STRUCTURAL ENGINEERS

SMITH + ANDERSON MECHANICAL AND ELECTRICAL ENGINEERS

1100 - 100 SHEPPARD AVENUE EAST TORONTO, ONTARIO, M2N 6N5
TEL 416.487.8151 -

# SAYERS FOOD LIMITED

132 BURLEIGH STREET t: 705.656.4531 e: sayers@apsley.ca

NORTH ARRO



PROJECT TITLE

NEW SAYERS FOOD STORE BURLEIGH STREET, APSLEY

AAAAAA CE


WALL SECTIONS

1:25

JULY 15, 2022

PROJECT NUMBER

2102
DRAWING NUMBER

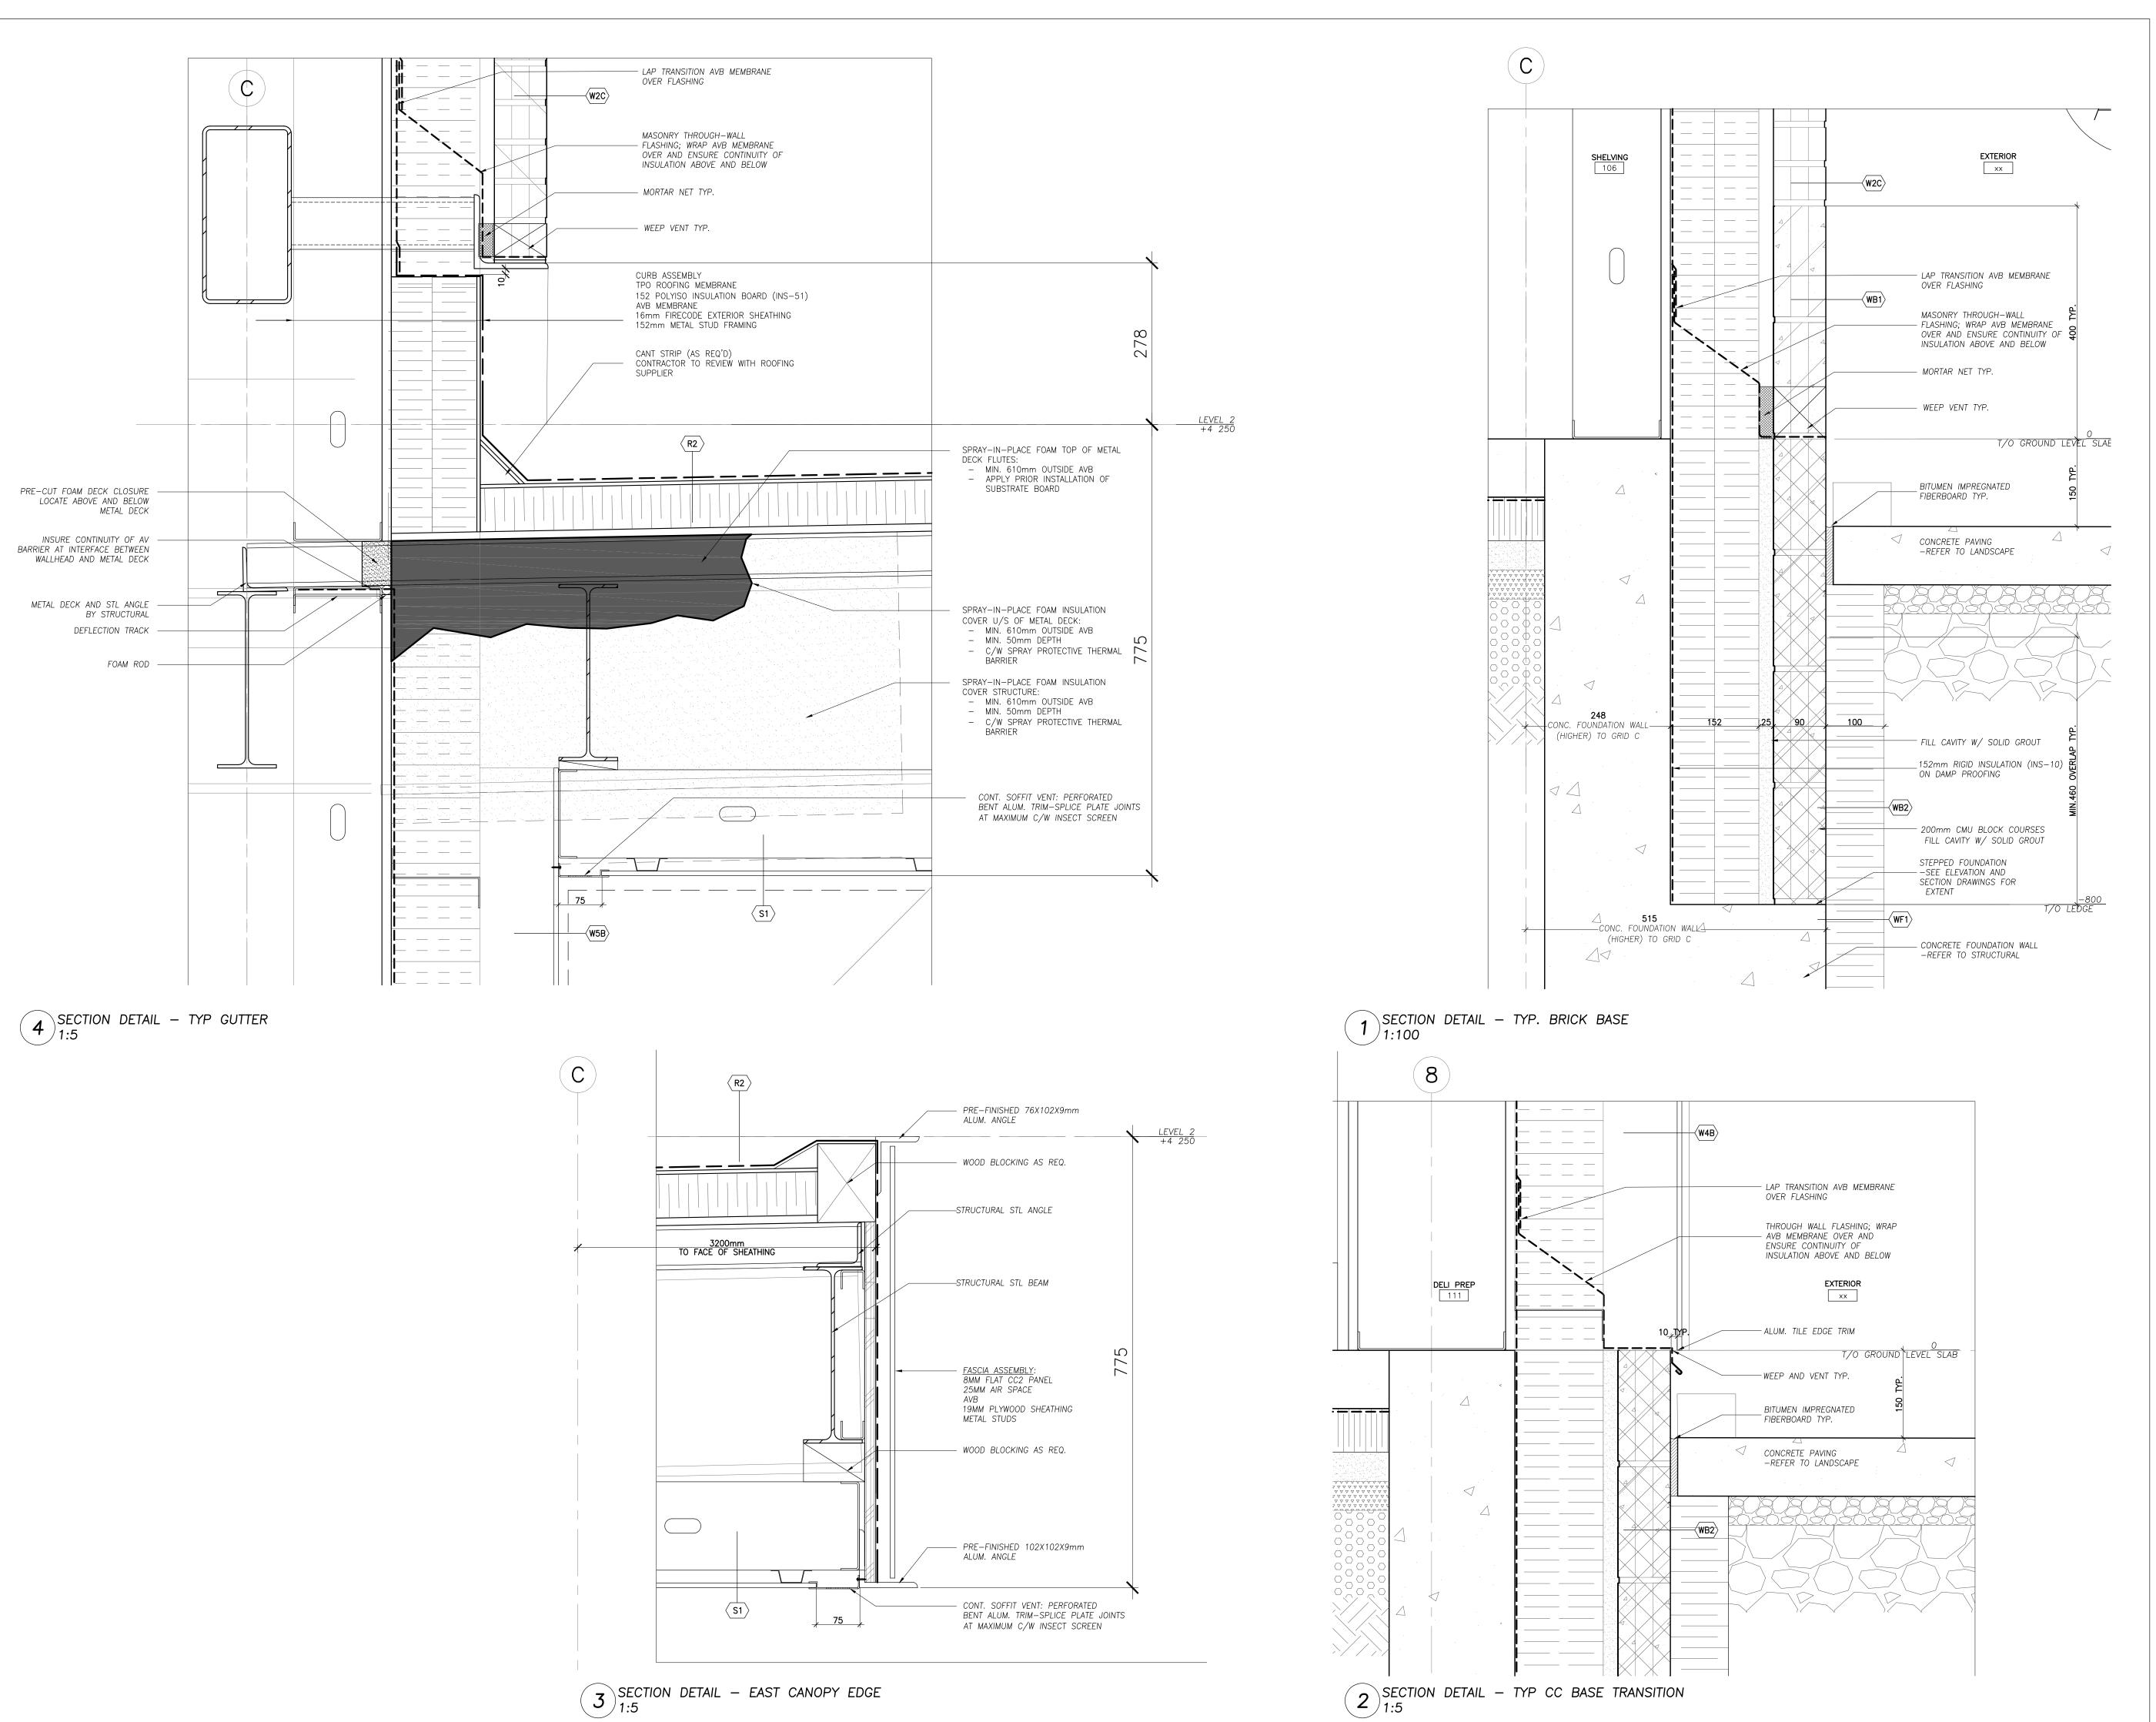

 REVISIONS AND ISSUES
 DATE
 BY

 1
 REVISED SPA
 210809
 AE

 2
 ISSUED FOR TENDER
 210824
 AE

 3
 REVISION TO BUILDING PERMIT
 220315
 AE

 4
 SI-01
 220615
 AE

 5
 BLG SET-OUT CAD
 220715
 AE

 6
 ISSUED FOR CONSTRUCTION
 220715
 AE

 7
 AE

AMLM

maclennan jaunkalns miller architects

425 adelaide street west level 6
toronto ontario m5v 3c1
416 593 6796
www.mjmarchitects.com

#### TRITON ENGINEERING SERVICES LTD

229 BROADWAY, UNIT 1
ORANGEVILLE, ONTARIO, L9W 1K4
TEL 519 941 0330 FAX 519 941 1830

BLACKWELL

STRUCTURAL ENGINEERS

134 PETER STREET, SUITE 1301
TORONTO, ONTARIO, M5V 2H2
TEL 416.593.5300 FAX 416.593.4840


SMITH + ANDERSON MECHANICAL AND ELECTRICAL ENGINEERS

1100 - 100 SHEPPARD AVENUE EAST TORONTO, ONTARIO, M2N 6N5
TEL 416.487.8151 -

# SAYERS FOOD LIMITED

132 BURLEIGH STREET t: 705.656.4531 e: sayers@apsley.ca

NORTH ARROW

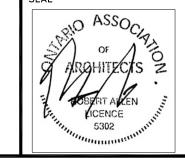

PROJECT TITL

NEW SAYERS FOOD STORE BURLEIGH STREET, APSLEY

DRAWING TITLE


SECTION DETAILS

1:5


JULY 15, 2022

PROJECT NUMBER 2102


DRAWING NUMBER

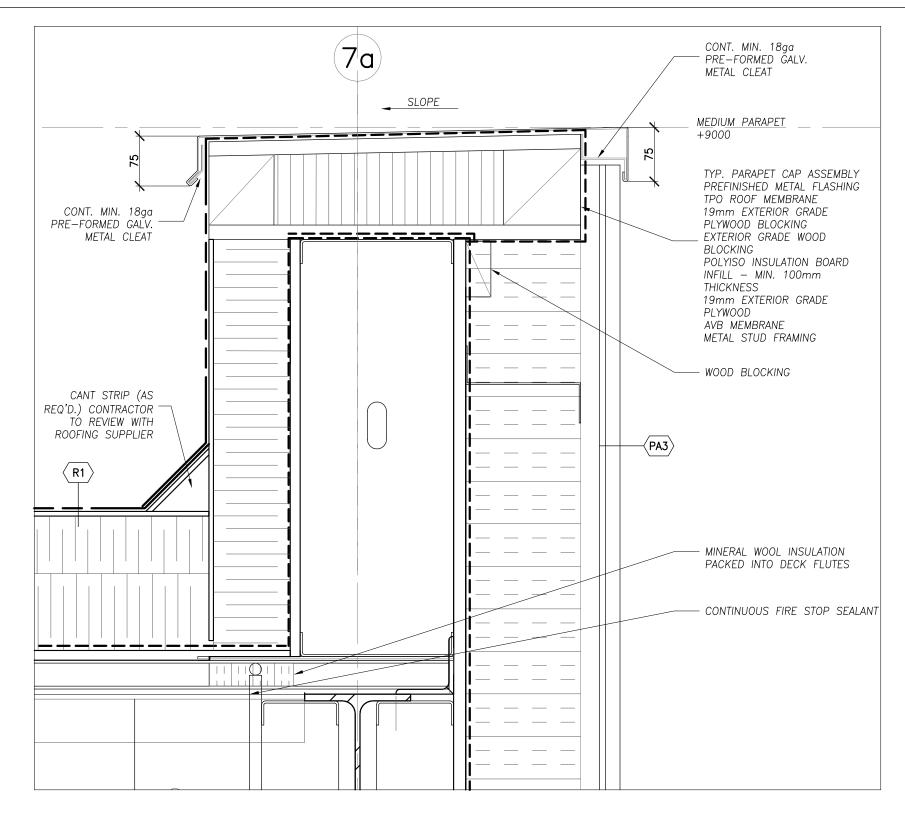



# 7 SECTION DETAIL - SOUTH CC1 PARAPET 1:5

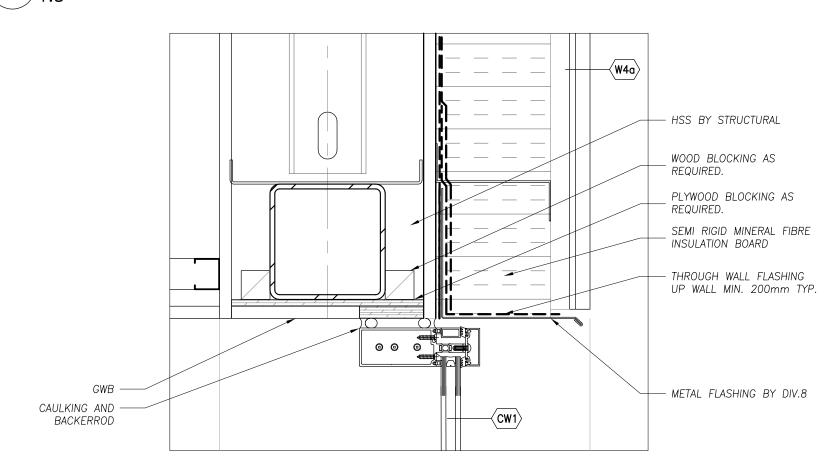


# 6 SECTION DETAIL - SOUTH DECK DOOR HEAD 1:5

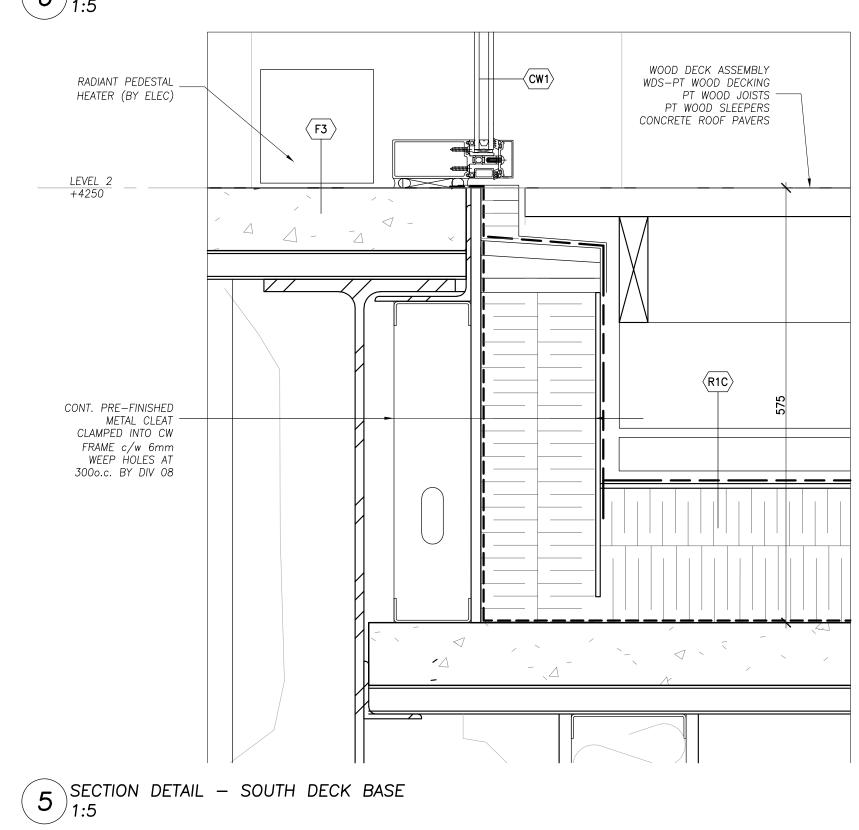

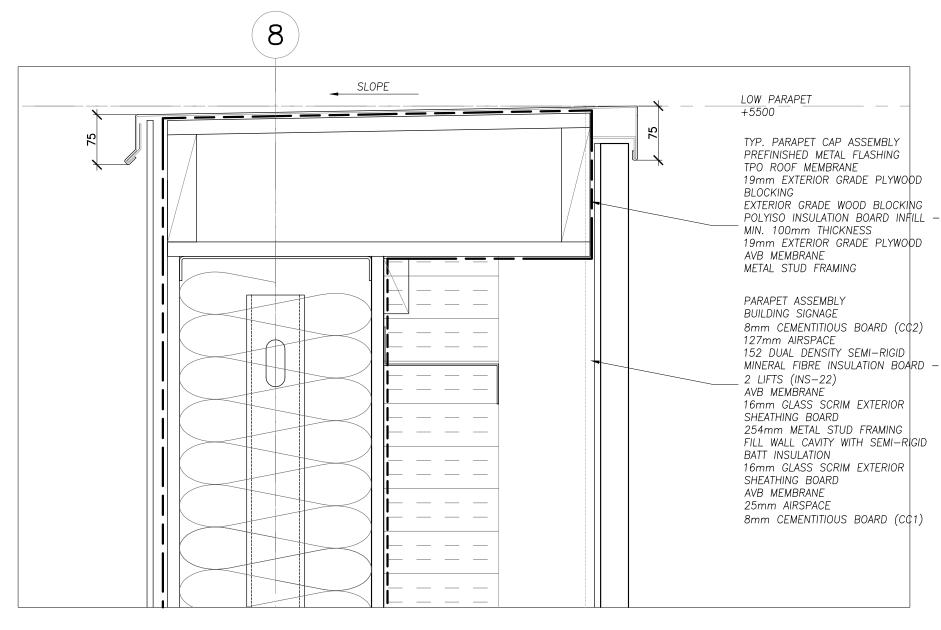

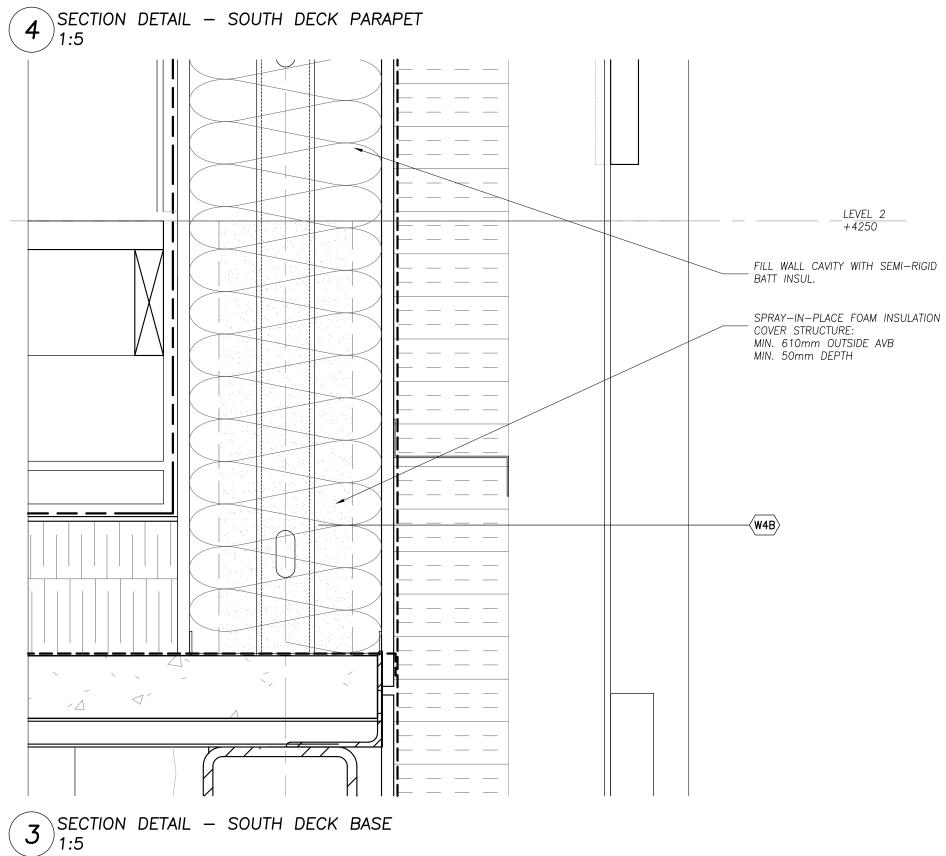

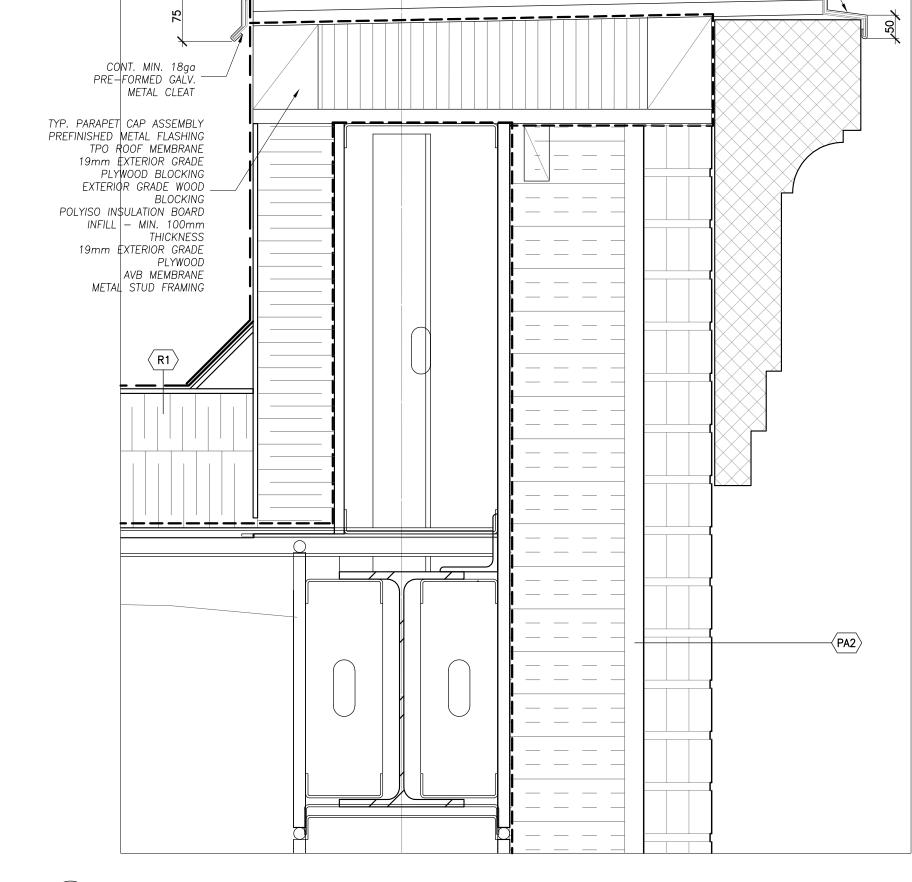

C


HIGH PARAPET

CONT. MIN. 18ga PRE-FORMED ĞALV. ——

METAL CLEAT

SLOPE

SECTION DETAIL - SOUTH BRICK PARAPET 1:5

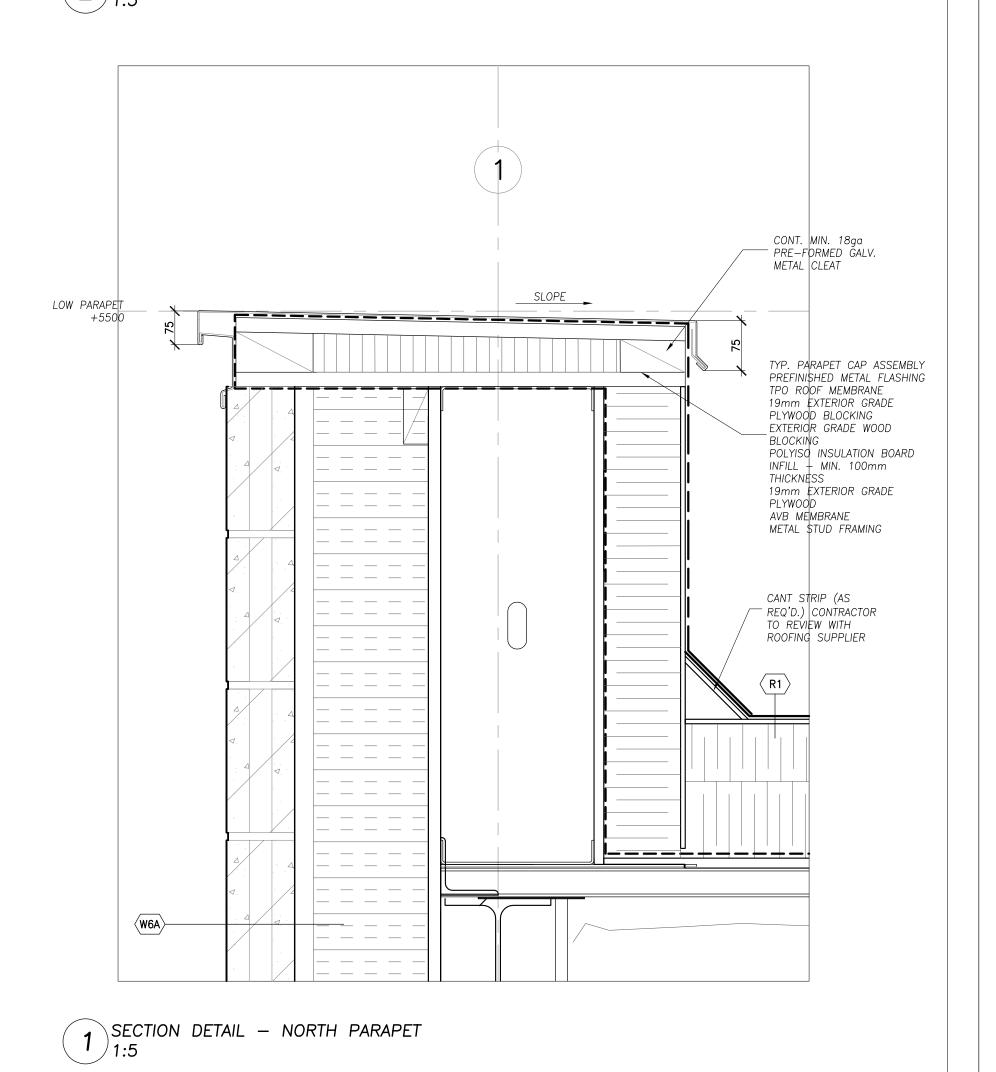

Contractor must check and verify all dimensions on the job, and report any discrepancies to the Architect before proceeding with the work. Do not scale this drawing.

REVISIONS AND ISSUES DESCRIPTION DATE REVISED SPA 210809 ISSUED FOR TENDER 210824 REVISION TO BUILDING PERMIT 220315 220615 SI-01 BLG SET-OUT CAD 220715 ISSUED FOR CONSTRUCTION 220715

MJMA

maclennan jaunkalns miller architects 425 adelaide street west level 6 toronto ontario m5v 3c1 416 593 6796 www.mjmarchitects.com

TRITON ENGINEERING SERVICES LTD

CIVIL ENGINEERS 229 BROADWAY, UNIT 1 ORANGEVILLE, ONTARIO, L9W 1K4

TEL 519 941 0330 FAX 519 941 1830 BLACKWELL

STRUCTURAL ENGINEERS

134 PETER STREET, SUITE 1301 TORONTO, ONTARIO, M5V 2H2
TEL 416.593.5300 FAX 416.593.4840


SMITH + ANDERSON MECHANICAL AND ELECTRICAL ENGINEERS

1100 - 100 SHEPPARD AVENUE EAST TORONTO, ONTARIO, M2N 6N5 TEL 416.487.8151 -

## SAYERS FOOD LIMITED

132 BURLEIGH STREET t: 705.656.4531 e: sayers@apsley.ca

NORTH ARROW

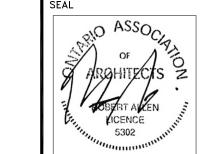

PROJECT TITLE

NEW SAYERS FOOD STORE BURLEIGH STREET, APSLEY

DRAWING TITLE


SECTION DETAILS

SCALE


JULY 15, 2022


PROJECT NUMBER 2102

DRAWING NUMBER A321

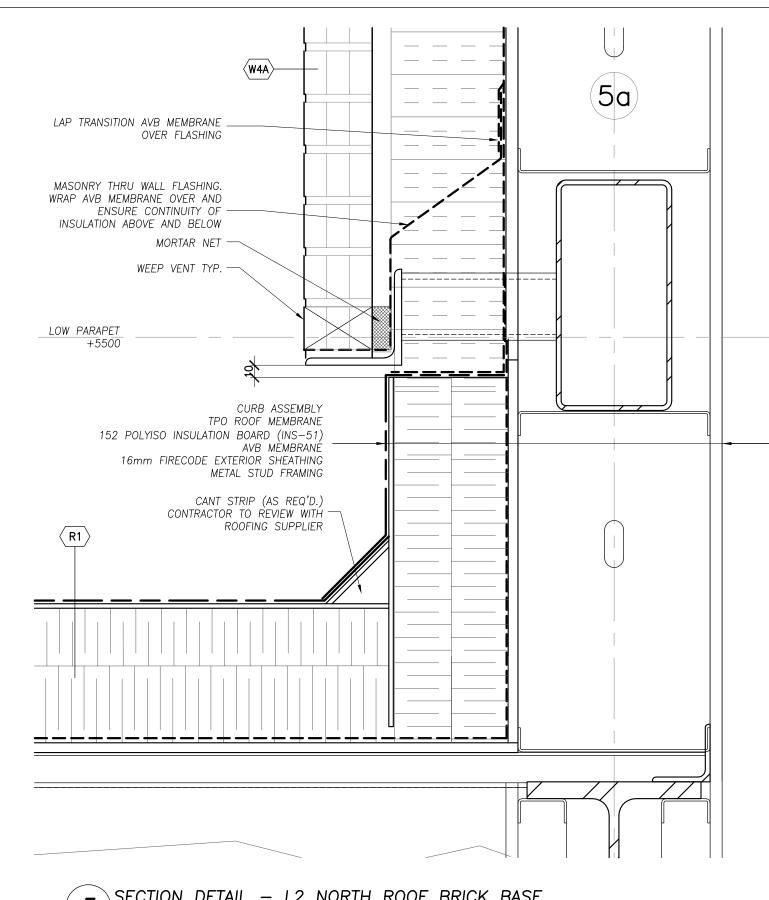


5 SECTION DETAIL - L2 NORTH ROOF BRICK BASE

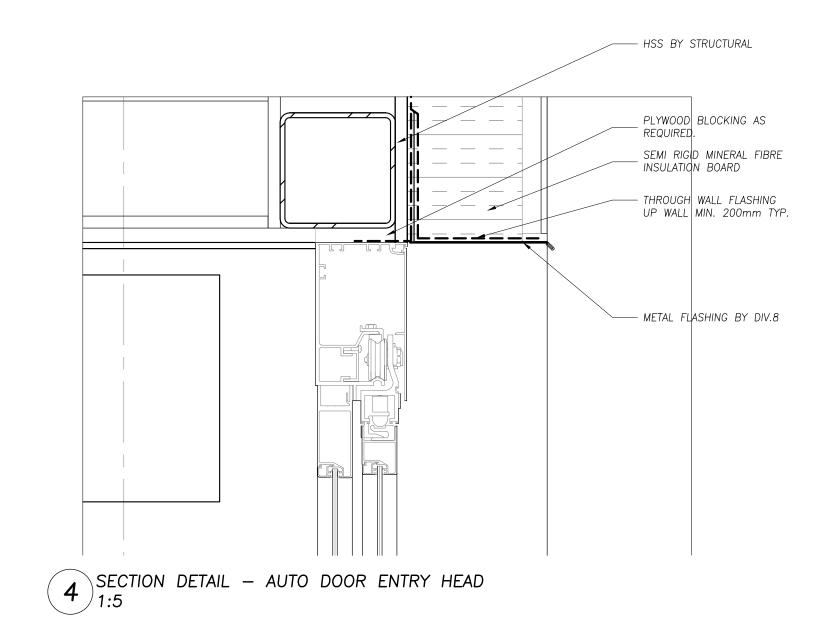

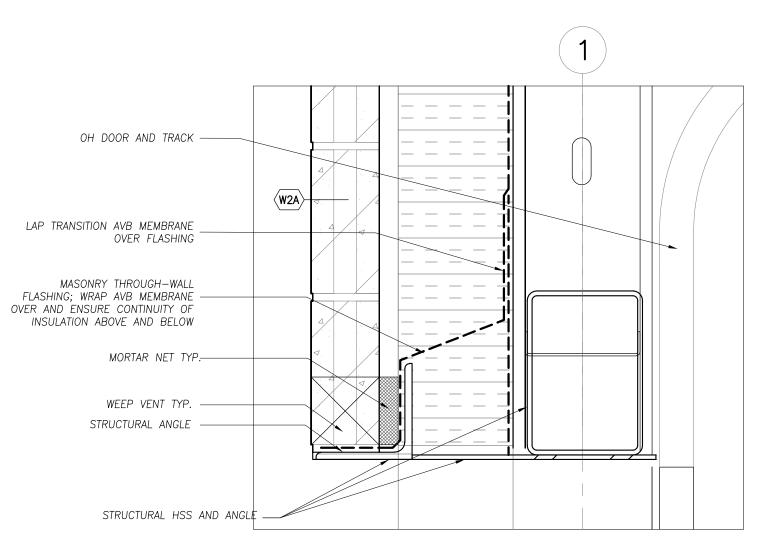


3 SECTION DETAIL - DELIVERY DOOR HEAD DETAIL 1:5



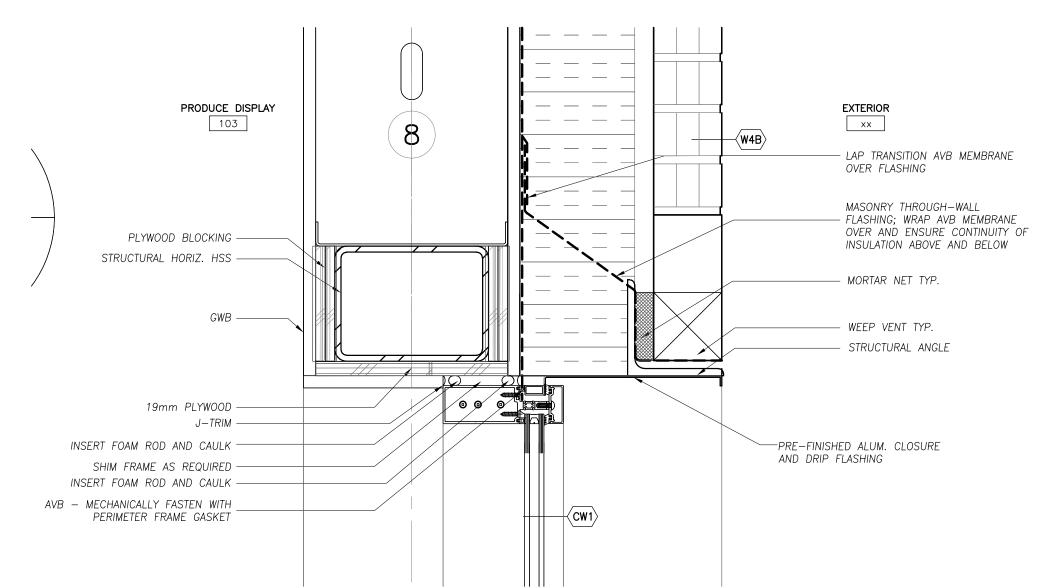

2 SECTION DETAIL - CW1 HEAD 1:5

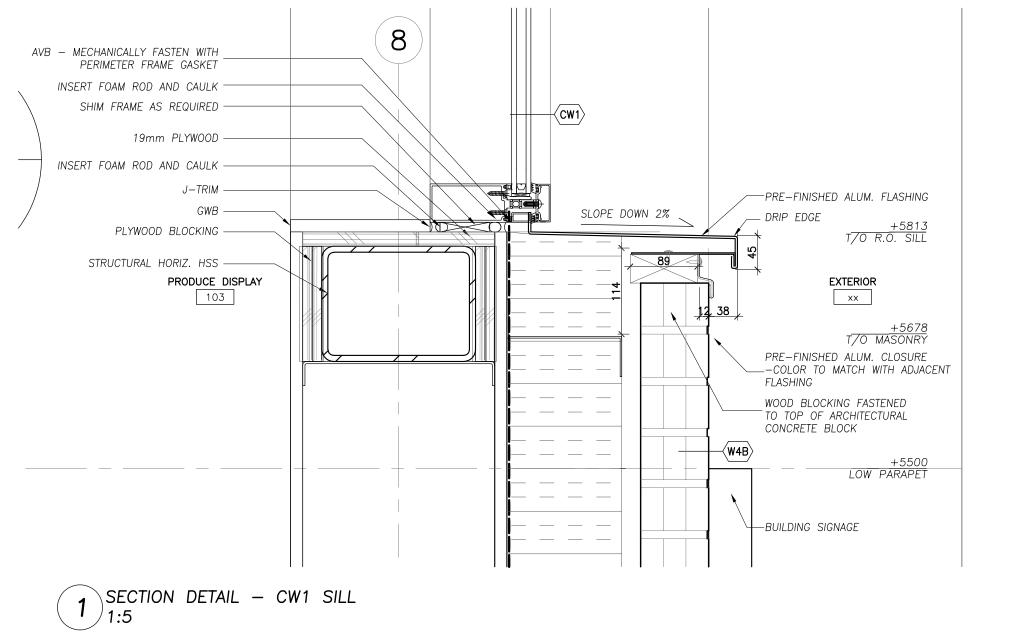

Contractor must check and verify all dimensions on the job, and report any discrepancies to the Architect before proceeding with the work.

Do not scale this drawing.

REV	DESCRIPTION	DATE	B,
1	REVISED SPA	210809	Al
2	ISSUED FOR TENDER	210824	Al
3	REVISION TO BUILDING PERMIT	220315	Al
4	SI-01	220615	Al
5	BLG SET-OUT CAD	220715	Al
6	ISSUED FOR CONSTRUCTION	220715	Al

# **MJMA**

maclennan jaunkalns miller architects

425 adelaide street west level 6
toronto ontario m5v 3c1
416 593 6796
www.mjmarchitects.com

#### TRITON ENGINEERING SERVICES LTD

CIVIL ENGINEERS

229 BROADWAY, UNIT 1

ORANGEVILLE, ONTARIO, L9W 1K4

TEL 519 941 0330 FAX 519 941 1830

# TEL 519 941 0330 FAX 519 941 18 BLACKWELL

134 PETER STREET, SUITE 1301
TORONTO, ONTARIO, M5V 2H2
TEL 416.593.5300 FAX 416.593.4840

#### SMITH + ANDERSON MECHANICAL AND ELECTRICAL ENGINEERS

1100 - 100 SHEPPARD AVENUE EAST
TORONTO, ONTARIO, M2N 6N5


TEL 416.487.8151 -

STRUCTURAL ENGINEERS

## SAYERS FOOD LIMITED

132 BURLEIGH STREET t: 705.656.4531 e: sayers@apsley.ca

NORTH ARROW

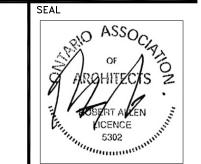

PROJECT TITL

NEW SAYERS FOOD STORE BURLEIGH STREET, APSLEY

DRAWING TITLE

WALL SECTIONS NORTH FACADES


scale 1:25

JULY 15, 2022


PROJECT NUMBER


DRAWING NUMBER


Δ32

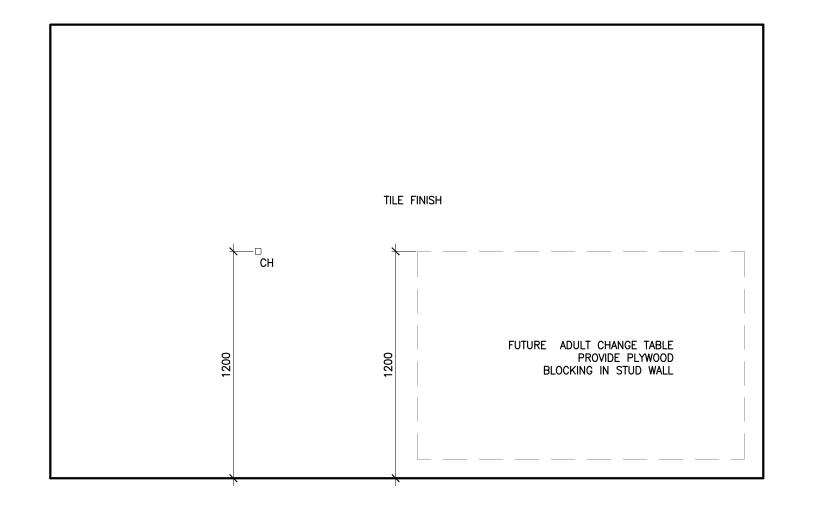

5 INT. ELEVATION – UNI. WC SOUTH

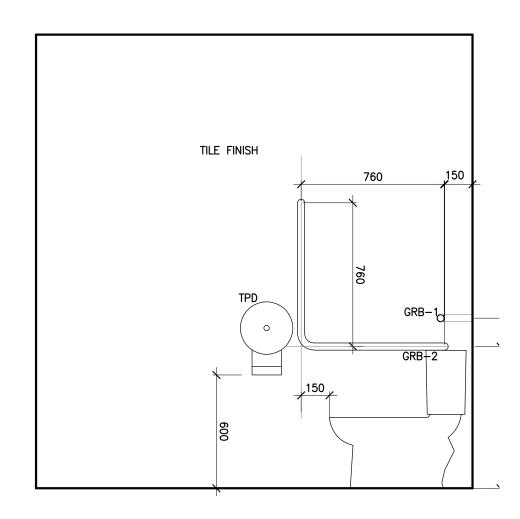


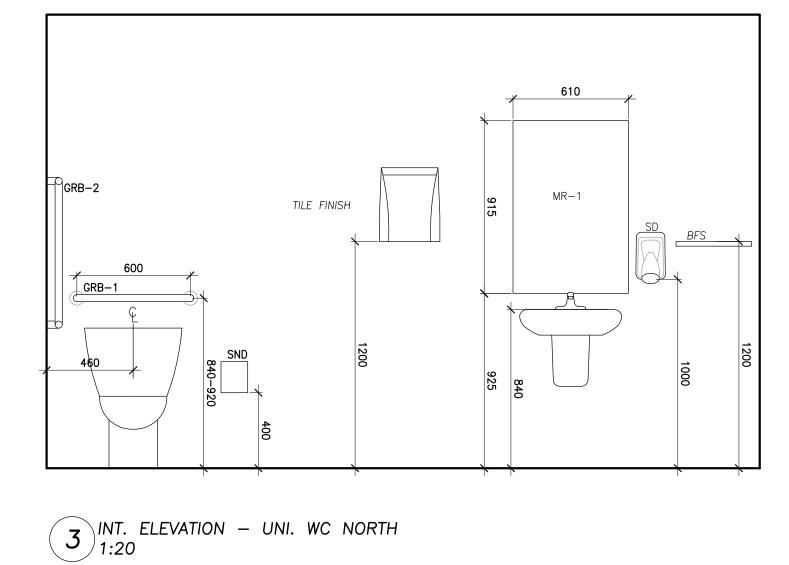

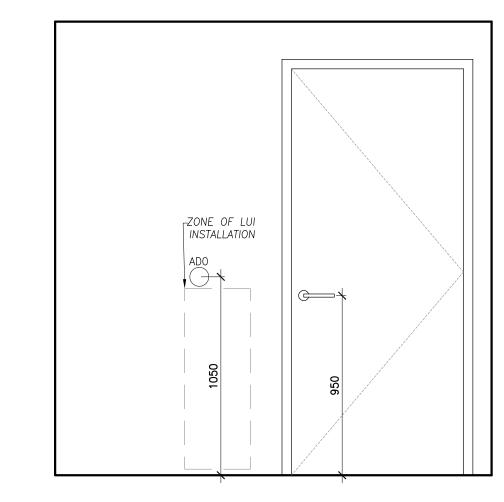


2 INT. ELEVATION - UNI. WC EAST 1:20

4 INT. ELEVATION - UNI. WC WEST

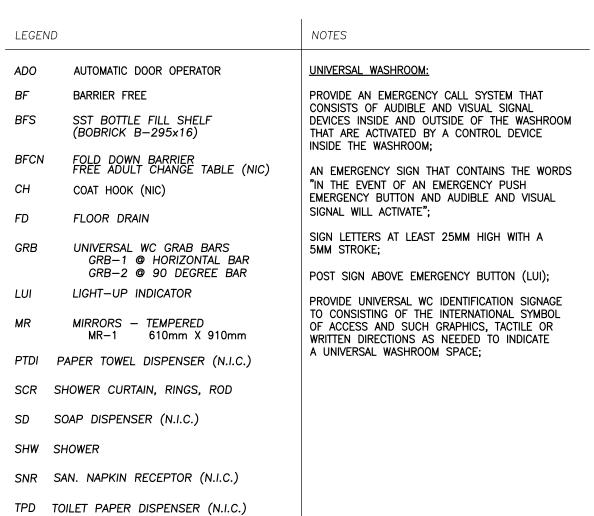

WD WASTE DISPOSAL BIN (N.I.C.)

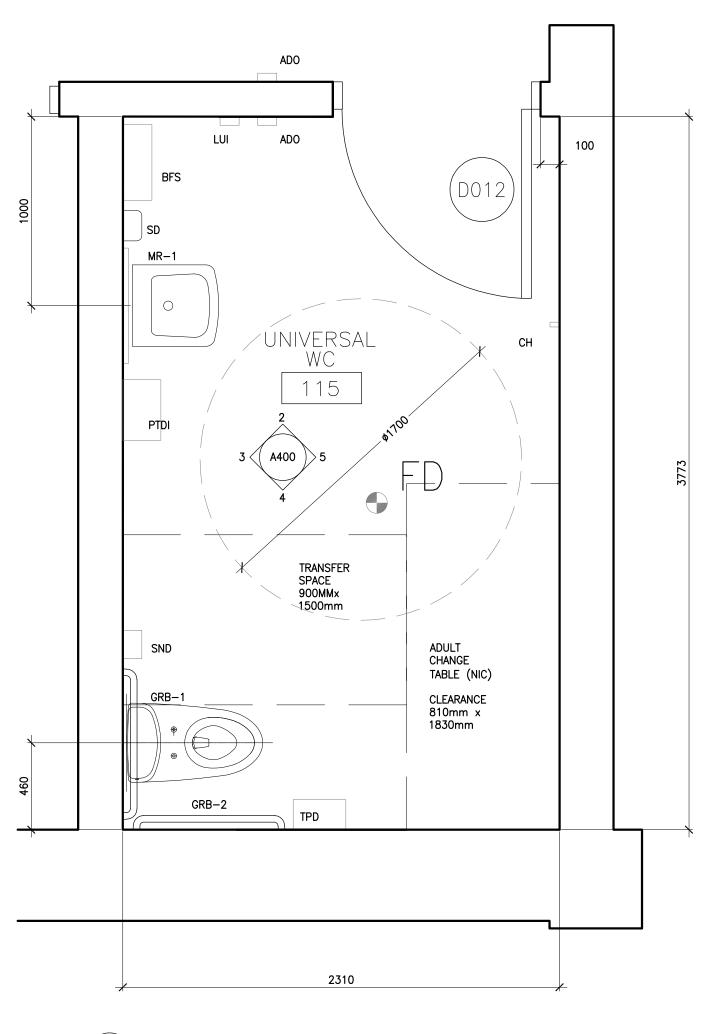

1 PLAN CALLOUT - UNIVERSAL WC 1:20

Contractor must check and verify all dimensions on the job, and report any discrepancies to the Architect before proceeding with the work. Do not scale this drawing.

REVISIONS AND ISSUES DESCRIPTION DATE REVISED SPA 210809 ISSUED FOR TENDER 210824 REVISION TO BUILDING PERMIT 220315 220615 SI-01 BLG SET-OUT CAD 220715 ISSUED FOR CONSTRUCTION 220715

# **MJMA**

maclennan jaunkalns miller architects

425 adelaide street west level 6 toronto ontario m5v 3c1 416 593 6796 www.mjmarchitects.com

#### TRITON ENGINEERING SERVICES LTD CIVIL ENGINEERS

229 BROADWAY, UNIT 1

ORANGEVILLE, ONTARIO, L9W 1K4
TEL 519 941 0330 FAX 519 941 1830

# BLACKWELL

STRUCTURAL ENGINEERS 134 PETER STREET, SUITE 1301 TORONTO, ONTARIO, M5V 2H2
TEL 416.593.5300 FAX 416.593.4840

SMITH + ANDERSON


MECHANICAL AND ELECTRICAL ENGINEERS

1100 - 100 SHEPPARD AVENUE EAST TORONTO, ONTARIO, M2N 6N5
TEL 416.487.8151

# SAYERS FOOD LIMITED

132 BURLEIGH STREET t: 705.656.4531 e: sayers@apsley.ca

NORTH ARROW

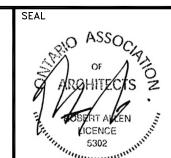

NEW SAYERS FOOD STORE BURLEIGH STREET, APSLEY

DRAWING TITLE

UNIVERSAL WC ENLARGED PLAN


1:100

JULY 15, 2022

PROJECT NUMBER

2102

DRAWING NUMBER

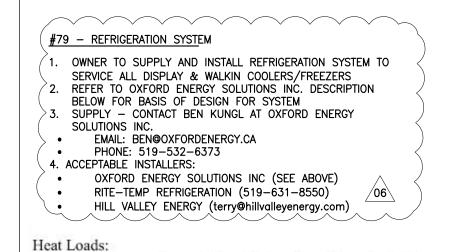

PLease refer to excel spread sheet for load profile and circuits. this system currently has 28 refrigeration circuits in the control sequence.

Total load profile = approx 200,000 @20 deg F SST, 60,000 @ -10 deg F SST, total system

Oxford Refrigeration LPP model 300/70. Complete packaged outdoor unit. Sized based on above mentioned loads. Condenser sized for full store at heat of rejection approximately 320,000 btu/hr based on a 15 degree T/D.

Complete Oxford Sensori Platform with Gatemanager interface included. Secure access with firewall and trend logs.

Lo and Medium Temp comprised of Copeland ZB scroll compressors with oil management and OPTIONAL Oxford Vapour Drive compressor, magnetic drive, oil free compressor.

208/3 phase with 24vac control system.

Boil out suction accumulator with sub-cooling loop, changeable suction and liquid line filters. Isolation valves, floating head pressure control, dual relief valves on receiver. Sub cooled loop and receiver on condenser.

R-513a/POE oil, HFO, LOW GWP refrigerant.

CSA approved.

No disconnect in panel.

Primary med temp compressor vfd driven.

Condenser fans vfd driven.

Low temperature compressor vfd driven Power monitor in cabinet.

All EXV controls shown as separate below for all circuits.

Store layout and distribution of local and remote case controls to be determined. System is PRE-programmed, PRE-charged with 100lbs of refrigerant and all I/O is

PRE-checked. Spare can of POE oil shipped loose.

-Customer responsible for proper installation, piping practices, start up and commissioning with the assistance of Oxford tech.

-Equipment comes pre-programmed/set up based on layout of store provided. -System receiver is exempt from TSSA registration.

-all terms and conditions listed at www.oxfordenergy.ca

-Oxford Energy will not be held responsible for any delays of equipment affected by events that are beyond the control of Oxford Energy Solutions Inc.

-Oxford Energy will not be held accountable for any issues resulting in loss of product or damage to product. The accountability of the food stuff in storage is the sole responsibility of the facility owner.

-Oxford listed equipment has a free 2nd year compressor warranty when trained personnel submits start up report on compressors. This can be done electronically.

-3rd year warranty on compressors is available upon discussion and is an extra charge that is not -All installation, permits, structural, engineering, etc all the responsibility of the customer.

-Unloading equipment at site is responsibility of customer. -Location of internal 15" HMI screen to be discussed and connected to Internet system.

-All cases/fixtures supplied by Arneg. This estimate only covers the equipment listed in it. -All low temperature display cases will have high temp interlock relay installed by Arneg for automatic shut off of all door anti sweat heaters to be controlled via automation system. If case is being re-used then electrical of case will be re-done with EXV kit and relays.

-All power for evaporator fans and defrost heaters to be supplied from the facility power distribution and controlled via low voltage signals to each case. Each case has the isolation relays for evaporator fans and defrost heaters in the case.

Evaperators listed for all walk in coolers/freezers on excel sheet. All evaporators will have ECM fan motors, insulated drain pans, electric defrost where

Evaperator Ref Plus LSA/E series with insulated drain pans, ECM motors and electric defrost heaters where applicable.

Listing of evaporator models on excel sheet and quantity.

4 walk in cooler evaporators, 2 walk in freezer evaporators. 1 cut room evap.


Room and evaporator coil sensors and all transducers and cables required.


7 evaporators in total. Shipped directly to site.

230vac single phase Oxford Refrigeration stand alone Sensori Circuit control with VEV integrated driver.


1 REFRIGERATION SYSTEM

Includes EXV sized as per Excel sheet. 220/120/24vac/dc voltages

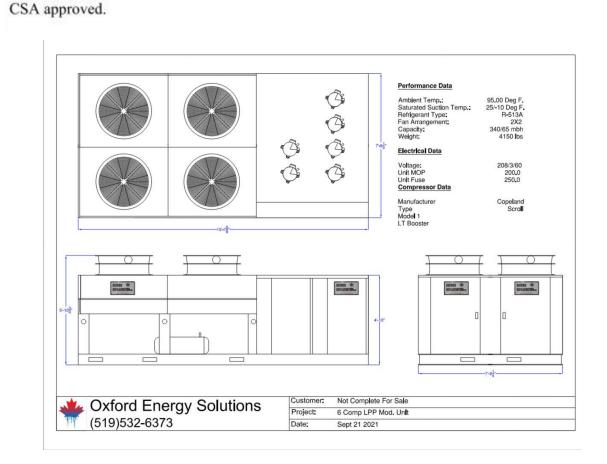

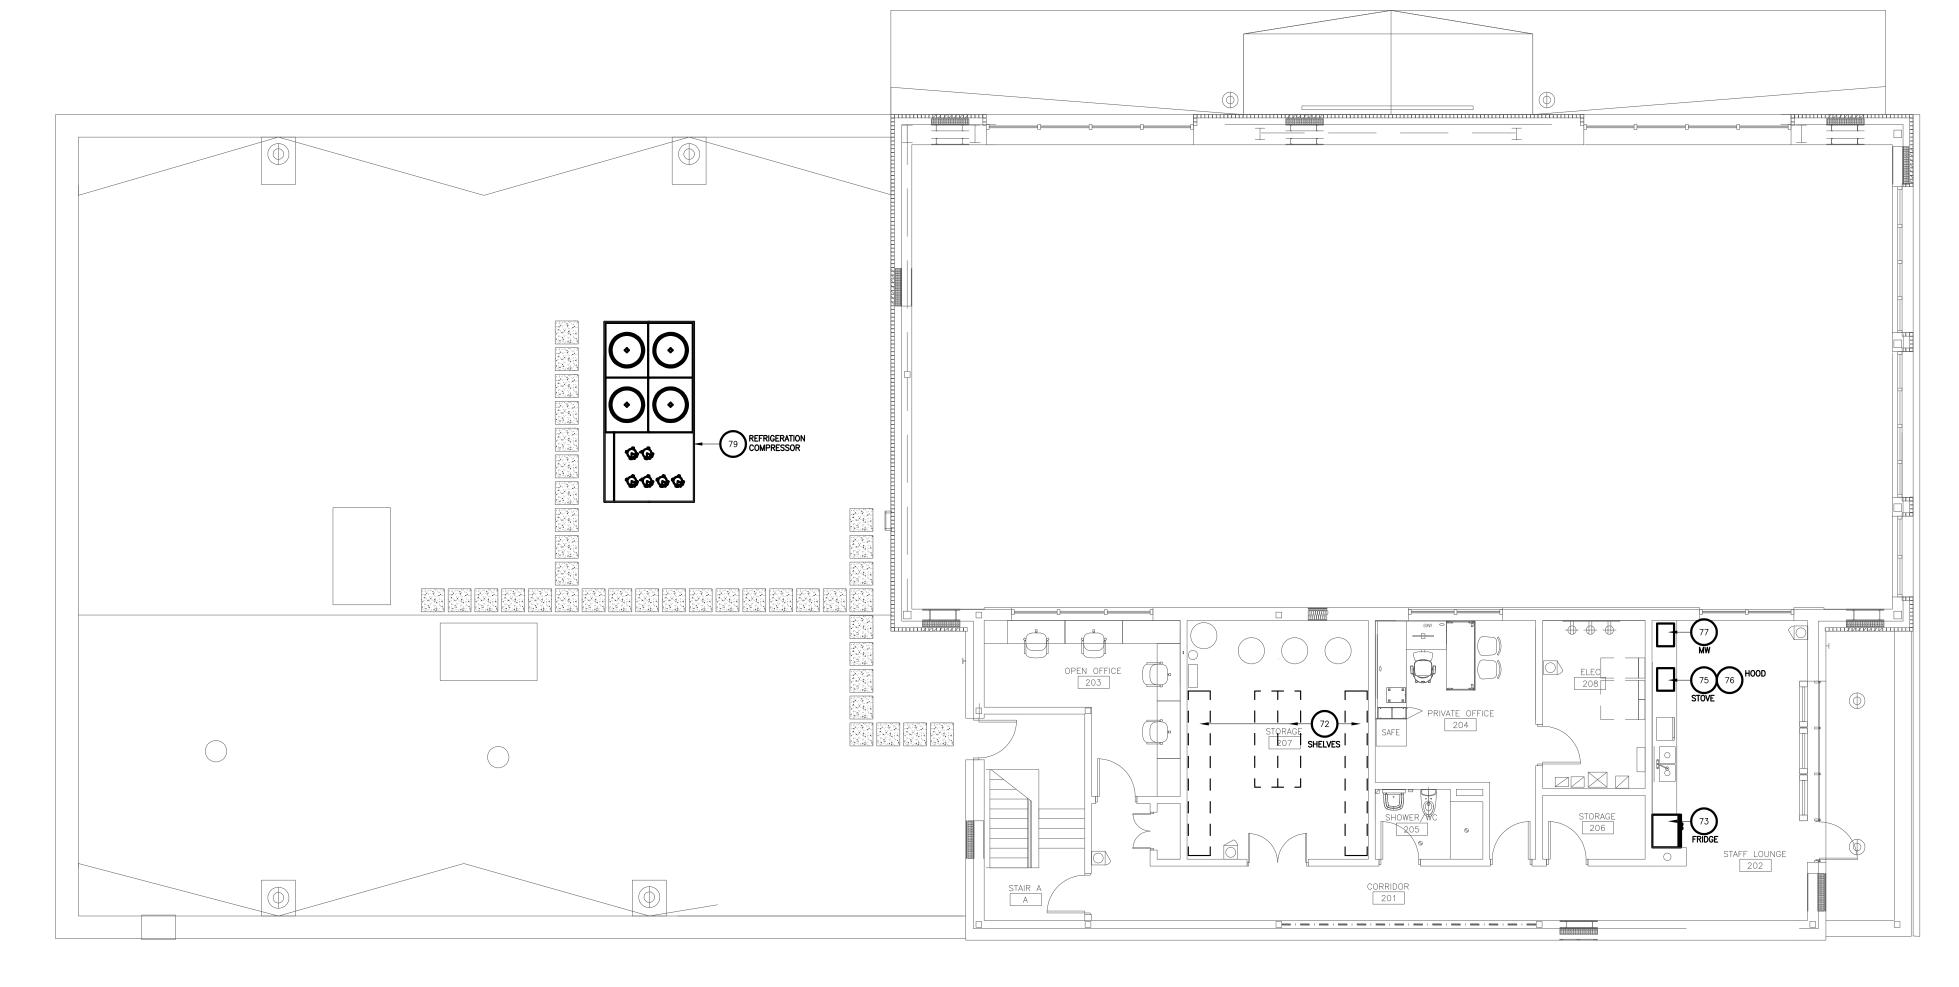

3 LEVEL 2 EQUIPMENT PLAN

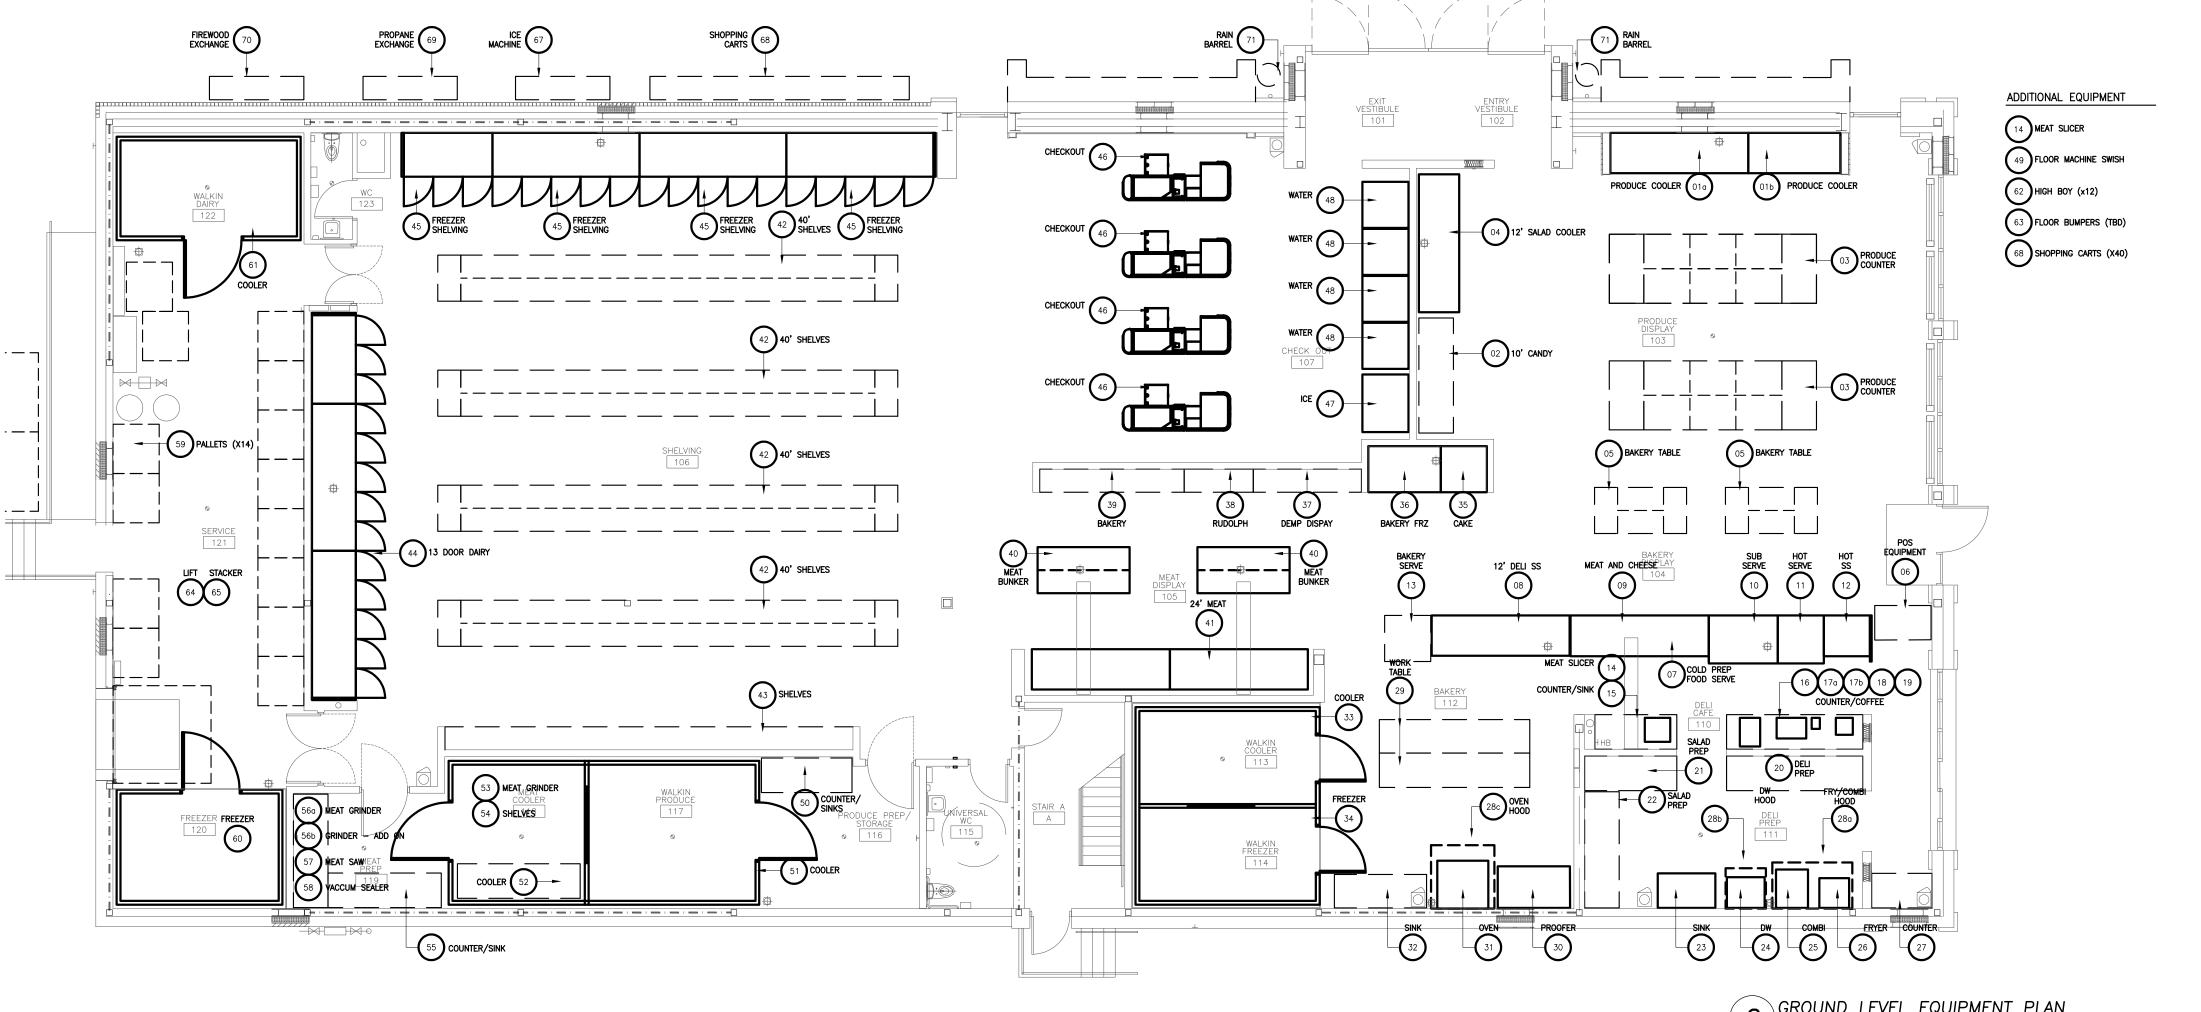

Contractor must check and verify all dimensions on the job, and report any discrepancies to the Architect before proceeding with the work. Do not scale this drawing.

REVISIONS AND ISSUES DESCRIPTION REVISED SPA 210809 ISSUED FOR TENDER 210824 REVISION TO BUILDING PERMIT 220315 220615 BLG SET-OUT CAD 220715 ISSUED FOR CONSTRUCTION 220715

**MJMA** 

maclennan jaunkalns miller architects

425 adelaide street west level 6 toronto ontario m5v 3c1 416 593 6796 www.mjmarchitects.com

TRITON ENGINEERING SERVICES LTD CIVIL ENGINEERS

229 BROADWAY, UNIT 1 ORANGEVILLE, ONTARIO, L9W 1K4

TEL 519 941 0330 FAX 519 941 1830

BLACKWELL STRUCTURAL ENGINEERS

134 PETER STREET, SUITE 1301 TORONTO, ONTARIO, M5V 2H2
TEL 416.593.5300 FAX 416.593.4840


SMITH + ANDERSON MECHANICAL AND ELECTRICAL ENGINEERS

1100 - 100 SHEPPARD AVENUE EAST TORONTO, ONTARIO, M2N 6N5 TEL 416.487.8151

SAYERS FOOD LIMITED

132 BURLEIGH STREET t: 705.656.4531 e: sayers@apsley.ca

NORTH ARROW

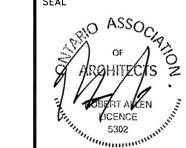

NEW SAYERS FOOD STORE BURLEIGH STREET, APSLEY

DRAWING TITLE

EQUIPMENT FLOOR PLANS

1:100

JULY 15, 2022

PROJECT NUMBER 2102

DRAWING NUMBER A450

2 GROUND LEVEL EQUIPMENT PLAN 1:100

					GENERAL					MECHANICAL				I				ELECTRICA				
ITEM NO.		LOCATION  103 - PRODUCE DISPLAY	DESCRIPTION  12' PRODUCE COOLER	BRAND Arneg	BASIS OF DESIGN LISBONA	DIMENSIONS (WxDxH)  3657mm x 1067mm x 1892mm	SPEC COMMENTS  OWNER SUPPLIED - CONTRACTOR INSTALLED;	COLD WATER (mm)	HOT WATER (mm)	FILTERED H2O		GAS NA	Mech Notes	CONNECTION Hardwired	AFF(mm) Floor Supplied	VOLTS 120v	CYCLE 60hz	PHASE 1	AMPS 3 Fans (0.57) + LED Lights 1E (0.24 +	HP NA		LECTRICAL REMARKS  Io Night Curtain
					VF04_LS LSB TA56 105-162 HF B25 2019-10-24		12' UNIT, GANG TOGETHER WITH 8' UNIT												2E 0.48)			Io Electric Defrost Black Interior
001	1	103 - PRODUCE DISPLAY	8' PRODUCE COOLER	Arneg	LISBONA VF04_LS LSB TA56 105-162 HF B25 2019-10-24	2438mm x 1067mm x 1892mm	OWNER SUPPLIED - CONTRACTOR INSTALLED; 8' UNIT, GANG TOGETHER WITH 12' UNIT	NA	NA	NA	1 1/2" ABS	NA	NA	Hardwired	Floor Supplied	120v	60hz		2 Fans (0.38) + LED Lights 1E (0.16) + 2E 0.32)	NA		lo Night Curtain Io Electric Defrost
02		402 PRODUCE DICRUM	dal campy	6			OWARTS CHON UP	NA.	NA.	NA.	No	210	No Mark Day	NA.	NA.	***	NA.	NA.	NA.	NA.	100	llack Interior
02	1	103 - PRODUCE DISPLAY	10' CANDY	Cayuga			OWNER SUPPLIED;	NA	NA	NA	NA	NA	No Mech Req	NA	NA	NA	NA	NA	NA		NA I	ło Elec. Req.
03	2	103 - PRODUCE DISPLAY	PRODUCE COUNTER	Cayuga			OWNER SUPPLIED;	NA	NA	NA	NA	NA	No Mech Req	NA	NA	NA NA	NA	NA	NA	NA	NA I	lo Elec. Req.
04	1	103 - PRODUCE DISPLAY	12' SALAD COOLER	Arneg	LISBONA PL05-2_LS LSB TA76 105-191 LF MF HF B16 2016-06-14	3657mm x 1067mm x 2089mm	OWNER SUPPLIED - CONTRACTOR INSTALLED;	NA	NA	NA	1 1/2" ABS	NA	NA	Hardwired	Floor Supplied	120v	60hz		3 Fans (0.57) + LED Canopy = 1 + LED 5 rows Shelves 1.25	NA		lo Electric Defrost black Interior
05	2 :	104 - BAKERY DISPLAY	BAKERY TABLE	Cayuga			OWNER SUPPLIED;	NA	NA	NA	NA	NA	No Mech Req	NA	NA NA	NA	NA	NA	TOTAL = 2.82 A NA	NA	NA I	lo Elec. Req.
06	1	104 - BAKERY DISPLAY	POS EQUIPMENT	Howel			OWNER SUPPLIED - CONTRACTOR INSTALLED;	NA	NA	NA	NA	NA	NA	NA	NA	NA	NA	NA	NA	NA	NA -	
07		Reserved						NA	NA	NA	NA	NA	No Mech Req	NA	NA	NA NA	NA	NA	NA	NA	NA I	lo Elec. Req.
08	1	110 - DELI CAFÉ	12' DELI SELF SERVE	Arneg	LISBONA PV03-1 LS LSB TB35 105-136 LF MF B16 2014-05-30	3657mm x 1067mm x 1524mm	OWNER SUPPLIED - CONTRACTOR INSTALLED;	NA	NA	NA	1 1/2" ABS	NA	NA	Hardwired	Floor Supplied	120v	60hz		3 Fans (0.57) + LED Canopy = 1 + LED 3 rows Shelves	NA		lo Electric Defrost Black Interior
09	1	110 - DELI CAFÉ	MEAT & CHEESE	Arneg	GLASGOW 2 V	3658mm x 1083mm x 1372mm	OWNER SUPPLIED - CONTRACTOR INSTALLED;	NA NA	NA	NA	1 1/2" ABS	NA	NA	Hardwired	Floor Supplied	120v	60hz		TOTAL = 2.32 A 12 Fans (1.2) +	NA	NA F	rovide Separate hardwired
																			LED Canopy = 1 + LED 2 rows Shelves .5 TOTAL = 2.7 A			onnection to GFI Plug Supplied vith Case (for scales);
10	1	110 - DELI CAFÉ	SUB SERV	Arneg	KOBE 2 FROID/COLD	1829mm x 1270mm x 1372mm	OWNER SUPPLIED - CONTRACTOR INSTALLED;	NA NA	NA	NA	1 1/2" ABS (x2)	NA	NA	Hardwired	Floor Supplied	120v	60hz		3 Fans (0.48) + LED Canopy = .24+ LED 1 rows	NA	NA I	IA
11	1 1	110 - DELI CAFÉ	HOT SRVC	Arneg	GLASGOW 2 HOT/CHAUD	1219mm v 1083mm v 1372mm	OWNER SUPPLIED - CONTRACTOR INSTALLED;	NΔ	NA	NA .	No Drain	NΔ	NA .	Hardwired	Floor Supplied	120v	60hz		Shelves .12 TOTAL = 0.8 A	NΔ	NA F	Provide Separate hardwired
		SEL ON E		Arneg		13/2mm	CONTINUE OF THE STALLED;				erein	-		Hardwired	Floor Supplied		-5.4		2 Fans (0.20) + LED Canopy = .2 TOTAL = 0.4A Hot Plate = 10.6A	not 1		Provide Separate hardwired onnection to GFI Plug Supplied with Case (for scales);
12	1	110 - DELI CAFÉ	нот ss	Arneg	GLASGOW 2 HOT/CHAUD	1219mm x 1083mm x 1372mm	OWNER SUPPLIED - CONTRACTOR INSTALLED;	NA NA	NA	NA	No Drain	NA	NA	Hardwired	Floor Supplied	120v	60hz	1	2 Fans (0.20) + LED Canopy = .2	NA		rovide Separate hardwired onnection to GFI Plug Supplied
		440 - 200 - 200	DAVERY SEC.				OVALEA-SIRON		NA.		No.	NA .	No. Al	NI-		A10			TOTAL = 0.4A Hot Plate = 10.6A	NA.		vith Case (for scales);
13	1	110 - DELI CAFÉ	BAKERY SERVE				OWNER SUPPLIED;	NA -	NA	NA	NA .		No Mech Req	NA	NA	IVA	NA	NA	NA		NA I	ło Elec. Req.
14	2	110 - DELI CAFÉ	MEAT SLICER	Hobart	H59-1 MEAT SLICER	673mm x 635mm x 788mm	OWNER SUPPLIED; Note: Inc. Removable Knife Option	NA	NA	NA	NA	NA	NA	Nema 5-15R	6' Cord	120v	60hz	1	5.6A	1/2 HP	672w -	
15	1	110 - DELI CAFÉ	MEAT SLICER COUNTER/SINK	GBS			OWNER SUPPLIED;															
16	1 :	110 - DELI CAFÉ	TURBO CHEF	Hendrix	Turbochef - Bullet	538mm x 761mm x 585mm	OWNER SUPPLIED;	NA	NA	NA	NA	NA	Not to be used for Fatty Protiens - ie.	Nema 6-30P	6' Cord	208/240vac	60hz	1	30A	NA	3.5 kW -	
							Note: Ventless						no hood req.									
17a	1	110 - DELI CAFÉ	ESPRESSO MACHINE	Simonelli	Simonelli Appia Life 2-Group Full-Size	788mm x 546mm x 508mm	OWNER SUPPLIED; Inc. RWV ko chute 01 (03080201) - The Coffee Knock Drawer Compay	1/2"	NA	No	Yes - 1" min.	NA	Inc. Dedicated Cold Water Line with Shutoff value & 3/8" compression fitting; Inc.BWT in-line water softener	Nema 6-20R	Below Counter	220v	60hz	1	20A	-		
17b	1 :	110 - DELI CAFÉ	Coffee Grinder	Simonelli	MDJ On Demand	216mm x 292mm x 610mm	OWNER SUPPLIED;	NA	NA	NA	NA	NA	NA	Nema 5-15R		115V	60hz	1	5	N/A	575W -	
18	1 :	110 - DELI CAFÉ	COFFEE MAKER	Bunn	Axiom DVAPS.A32a_c AXIOM-DV APS	229mm x 554mm x 654mm	OWNER SUPPLIED;	1/4"		÷		-	Supplied with 1/4" male flare fitting	Hardwired		120v	60hz	1	12.5A	-	1475W -	
19	1	110 - DELI CAFÉ	ESPRESSO COUNTER	GBS			OWNER SUPPLIED;	-									-	2				
20	1 :	111 - DELI PREP.	12' DELI PREP	GBS			OWNER SUPPLIED;			-	-					-	-			-	-	
21		444 DELLOPED	OL CALAD DOED	CDS			OWARTS SUPPLIED															
21	1	111 - DELI PREP.	8' SALAD PREP	GBS			OWNER SUPPLIED;	-						-	•	-						
22	1	111 - DELI PREP.	10' SALAD PREP	GBS			OWNER SUPPLIED;		-		-	-		-		-	-	-	-		-	
23	1	111 - DELI PREP.	SINK	GBS			OWNER SUPPLIED - CONTRACTOR INSTALLED;	-	-	-		-		-	-		-	-	-	-		
24	1	111 - DELI PREP.	DISHWASHER	HOBART	AM16VLT-BAS	1000mm x 813mm x1718mm	OWNER SUPPLIED - CONTRACTOR INSTALLED;				5/8" Barb Fitting with	NA		Hardwired	E1 -12 11/16" AFF	E1 -208-240	60hz		E1 - 50			lefer to Spec Sheet For E1, E2,
							Note: No Vent Hood, Review OH and Opening Clearances	(6' length)	hose (6' length) 11-15/16" AFF	hose (6' length) 9-5/16" AFF	hose (6' length) 34 13/16" AFF				E1 - 14 11/16" AFF E3 - 15 11/16" AFF	E2-208-240 E3 -208-240			E2 - 50 E3 - 60			3 Designations
25	1	111 - DELI PREP.	СОМВІ	Rational	iCombi Pro 1-0half size E/G	851mm x 1016mm x 775mm	OWNER SUPPLIED - CONTRACTOR INSTALLED;	3/4" hose	NA	NA	2" OD	NA	2	Hardwired	65mm AFF	208/240 VAC	60hz	3	60A Breaker	2	18.9 Kw	lectric - Not Gas Option
26	1	111 - DELI PREP.	FRYER	HOBART	2TR45AF-1	787mm x 765mm x 1200mm	OWNER SUPPLIED - CONTRACTOR INSTALLED;	NA NA	NA	NA	NA	Propane	1 1/4" NPT Common Gas Connection	- Hardwired	-	120v	60hz	1 phase	6A	1/3 HP		1
													288mm AFF									
27	1	111 - DELI PREP.	COUNTER	GBS			OWNER SUPPLIED;	-	2	-	-	-	-		-	-		-	-	e)		
28a	1	111 - DELI PREP.	EXHAUST HOOD	GAYLORD	EL-ND-XGS-DCA-300-54	5'-8"	OWNER SUPPLIED - CONTRACTOR INSTALLED;	NA NA	NA	NA	NA	NA	REFER TO MECHANICAL DRAWINGS	Hardwired	-	-	-	-	-			
			COMBI + FRYER		PBW-14 MAKE-UP AIR PLENUM BOX ANSUL-FIRE SUPRESSION-SYSTEM	1727mm x 1727mm x 762mm																
28b	1	111 - DELI PREP.	EXHAUST HOOD OVEN	GAYLORD	EL-ND-XGS-DCA-300-66 PBW-12 MAKE-UP AIR PLENUM BOX	5'-6" 1676mm x 1676mm x 762mm	OWNER SUPPLIED - CONTRACTOR INSTALLED;	NA	NA	NA	NA	NA	REFER TO MECHANICAL DRAWINGS	Hardwired		-	-	-	-	2	-	
					ANSUL-FIRE SUPRESSION-SYSTEM																	
28c	1	111 - DELI PREP.	EXHAUST HOOD	GAYLORD	VH2 -W-42 VENTILATOR	3'-6"	OWNER SUPPLIED - CONTRACTOR INSTALLED;	NA	NA	NA	NA	NA	REFER TO MECHANICAL DRAWINGS	Hardwired		-	-	-	-			
29	1		DISHWASHER		ANSUL-FIRE SUPRESSION-SYSTEM	1067mm x 1067mm x 762mm							1		1		I	1	1		-	
	2	112 - BAKERY	BAKERY WORK TABLE	GBS	ANSUL-FIRE SUPRESSION-SYSTEM	1067mm x 1067mm x 762mm	OWNER SUPPLIED;				-				•	•	-		·	-20		
	2	112 - BAKERY	BAKERY WORK TABLE	GBS	ANSUL-FIRE SUPRESSION-SYSTEM												•					
30	1	112 - BAKERY 112 - BAKERY		GBS	ANSUL-FIRE SUPRESSION-SYSTEM  RPW25-40.5" D-FL		OWNER SUPPLIED;  OWNER SUPPLIED - CONTRACTOR INSTALLED; 94" High Options; Inc. REFRSA Remote Refriguration,	1/2" FNPT 85" AFF	NA	- NA	- 1/2" FNPT 5" AFF	NA	•	Hardwired	85" AFF	240v	- 60hz	3 phase	NA NA	NA		
30			BAKERY WORK TABLE	GBS HOBART		1918mm x 1102mm x 2527mm	OWNER SUPPLIED - CONTRACTOR INSTALLED; 94" High Options; Inc. REFRSA Remote Refriguration,  OWNER SUPPLIED - CONTRACTOR INSTALLED;	85" AFF	NA NA	- NA YES		NA	Inc. Water Filter (PL240)	Hardwired	85" AFF	240v		3 phase		NA		
30		112 - BAKERY	BAKERY WORK TABLE PROOFER		RPW25-40.5" D-FL	1918mm x 1102mm x 2527mm	OWNER SUPPLIED - CONTRACTOR INSTALLED; 94" High Options; Inc. REFRSA Remote Refriguration,	85" AFF	NA NA	- NA		- NA	Inc. Water Filter (PL240)		85" AFF					NA		
30	1 :	112 - BAKERY	BAKERY WORK TABLE PROOFER		RPW25-40.5" D-FL	1918mm x 1102mm x 2527mm	OWNER SUPPLIED - CONTRACTOR INSTALLED; 94" High Options; Inc. REFRSA Remote Refriguration,  OWNER SUPPLIED - CONTRACTOR INSTALLED;	85" AFF	NA NA	- NA YES		NA NA	Inc. Water Filter (PL240)		85" AFF					NA -		
31 32 33	1	112 - BAKERY  112 - BAKERY  112 - BAKERY	BAKERY WORK TABLE PROOFER OVEN		RPW25-40.5" D-FL	1918mm x 1102mm x 2527mm  1353mm x 1264mm x 1854mm	OWNER SUPPLIED - CONTRACTOR INSTALLED; 94" High Options; Inc. REFRSA Remote Refriguration,  OWNER SUPPLIED - CONTRACTOR INSTALLED; Note: Electric Oven	85" AFF	NA NA	- YES		NA NA	Inc. Water Filter (PL240)		85" AFF						- 27kW -	
30 31 32 33	1	112 - BAKERY  112 - BAKERY  112 - BAKERY	BAKERY WORK TABLE  PROOFER  OVEN  COUNTER/SINK	DOYON	RPW25-40.5" D-FL  JA20	1918mm x 1102mm x 2527mm  1353mm x 1264mm x 1854mm	OWNER SUPPLIED - CONTRACTOR INSTALLED; 94" High Options; Inc. REFRSA Remote Refriguration,  OWNER SUPPLIED - CONTRACTOR INSTALLED; Note: Electric Oven  OWNER SUPPLIED - CONTRACTOR INSTALLED;	85" AFF	NA NA			NA NA	Inc. Water Filter (PL240)		85" AFF							
30 31 32 33	1 1	112 - BAKERY  112 - BAKERY  112 - BAKERY	BAKERY WORK TABLE  PROOFER  OVEN  COUNTER/SINK	DOYON	RPW25-40.5" D-FL  JA20	1918mm x 1102mm x 2527mm  1353mm x 1264mm x 1854mm  2168mm x 4877mm x 2743mm	OWNER SUPPLIED - CONTRACTOR INSTALLED; 94" High Options; Inc. REFRSA Remote Refriguration,  OWNER SUPPLIED - CONTRACTOR INSTALLED; Note: Electric Oven  OWNER SUPPLIED - CONTRACTOR INSTALLED;	85" AFF  1/4 NPT	NA NA NA			NA NA NA	Inc. Water Filter (PL240)		85" AFF						27kW -	
30 31 32 33	1 1 1	112 - BAKERY  112 - BAKERY  113 - BAKERY  114 - WALKIN FREEZER	BAKERY WORK TABLE  PROOFER  OVEN  COUNTER/SINK  COOLER  FREEZER	DOYON  GBS  COOL MASTER  COOL MASTER	RPW2S-40.5" D-FL  JA20  4" COOLER PANELS  4" FREEZER PANELS	1918mm x 1102mm x 2527mm  1353mm x 1264mm x 1854mm  2168mm x 4877mm x 2743mm	OWNER SUPPLIED - CONTRACTOR INSTALLED; 94" High Options; Inc. REFRSA Remote Refriguration,  OWNER SUPPLIED - CONTRACTOR INSTALLED; Note: Electric Oven  OWNER SUPPLIED - CONTRACTOR INSTALLED;  OWNER SUPPLIED - CONTRACTOR INSTALLED;  OWNER SUPPLIED - CONTRACTOR INSTALLED;	85" AFF  1/4 NPT  NA	NA NA	- NA	NA	NA NA NA	Inc. Water Filter (PL240)	Hardwired	-	208v		1 phase	130A -	NA NA	-	In Flertric Defroct
30 31 32 33 34	1 1 1	112 - BAKERY  112 - BAKERY  112 - BAKERY  113 - WALKIN COOLER	BAKERY WORK TABLE  PROOFER  OVEN  COUNTER/SINK	DOYON  GBS  COOL MASTER	RPW25-40.5" D-FL  JA20  4" COOLER PANELS	1918mm x 1102mm x 2527mm  1353mm x 1264mm x 1854mm  2168mm x 4877mm x 2743mm	OWNER SUPPLIED - CONTRACTOR INSTALLED; 94" High Options; Inc. REFRSA Remote Refriguration,  OWNER SUPPLIED - CONTRACTOR INSTALLED; Note: Electric Oven  OWNER SUPPLIED - CONTRACTOR INSTALLED;  OWNER SUPPLIED - CONTRACTOR INSTALLED;	85" AFF  1/4 NPT  NA	NA NA NA	- NA	NA	NA NA NA	Inc. Water Filter (PL240)		8S" AFF  Floor Supplied			1 phase	130A  1 Fans (0.19) + 1 ED Canopy = ,17 + LED rows 3 Shelves .24	NA NA		io Electric Defrost Hack Interior
30 31 32 33 34	1 1 1 1 1 1 1 1 1 1 1 1 1 1 1 1 1 1 1 1	112 - BAKERY  112 - BAKERY  113 - BAKERY  114 - WALKIN FREEZER	BAKERY WORK TABLE  PROOFER  OVEN  COUNTER/SINK  COOLER  FREEZER	DOYON  GBS  COOL MASTER  COOL MASTER	RPW2S-40.5" D-FL  JA20  4" COOLER PANELS  4" FREEZER PANELS	1918mm x 1102mm x 2527mm  1353mm x 1264mm x 1854mm  2168mm x 4877mm x 2743mm  2168mm x 4877mm x 2743mm  1219mm x 1067mm x 1,372mm (confirm height)	OWNER SUPPLIED - CONTRACTOR INSTALLED; 94" High Options; Inc. REFRSA Remote Refriguration,  OWNER SUPPLIED - CONTRACTOR INSTALLED; Note: Electric Oven  OWNER SUPPLIED - CONTRACTOR INSTALLED;  OWNER SUPPLIED - CONTRACTOR INSTALLED;  OWNER SUPPLIED - CONTRACTOR INSTALLED;	85" AFF  1/4 NPT  NA  NA	NA NA NA	- NA	5" AFF NA 1 1/2" ABS	NA NA NA NA	Inc. Water Filter (PL240)  NA	Hardwired	-	208v		1 phase	1 Fans (0.19) + LED Canopy = .17 + LED rows 3	- NA		
30 31 32 33 34 35	1 1 1 1 1 1 1 1 1 1 1 1 1 1 1 1 1 1 1 1	112 - BAKERY  112 - BAKERY  113 - BAKERY  114 - WALKIN COOLER  114 - WALKIN FREEZER	BAKERY WORK TABLE  PROOFER  OVEN  COUNTER/SINK  COOLER  FREEZER	DOYON  GBS  COOL MASTER  COOL MASTER  Arneg	RPW2S-40.5" D-FL  JA20  4" COOLER PANELS  4" FREEZER PANELS  PV03-8	1918mm x 1102mm x 2527mm  1353mm x 1264mm x 1854mm  2168mm x 4877mm x 2743mm  2168mm x 4877mm x 2743mm  1219mm x 1067mm x 1,372mm (confirm height)	OWNER SUPPLIED - CONTRACTOR INSTALLED; 94" High Options; Inc. REFRSA Remote Refriguration,  OWNER SUPPLIED - CONTRACTOR INSTALLED; Note: Electric Oven  OWNER SUPPLIED - CONTRACTOR INSTALLED;	85" AFF  1/4 NPT  NA  NA	NA NA NA	- NA	5" AFF NA 1 1/2" ABS		Inc. Water Filter (PL240)  NA	Hardwired - Hardwired	- Floor Supplied	208v		1 phase	130A  1 Fans (0.19) + LED Canopy = .17 + LED rows 3 Shelves .24 TOTAL = 0.6A 2 Fans =1.2A; Door Heat = 1.4A; Frame Heat = 0.96A; LED Lighting = 0.36A;	NA -		
30 31 32 33 34 35	1 1 1 1 1 1 1 1 1 1 1 1 1 1 1 1 1 1 1 1	112 - BAKERY  112 - BAKERY  113 - BAKERY  114 - WALKIN COOLER  114 - WALKIN FREEZER	BAKERY WORK TABLE  PROOFER  OVEN  COUNTER/SINK  COOLER  FREEZER	DOYON  GBS  COOL MASTER  COOL MASTER  Arneg	RPW2S-40.5" D-FL  JA20  4" COOLER PANELS  4" FREEZER PANELS  PV03-8	1918mm x 1102mm x 2527mm  1353mm x 1264mm x 1854mm  2168mm x 4877mm x 2743mm  2168mm x 4877mm x 2743mm  1219mm x 1067mm x 1,372mm (confirm height)	OWNER SUPPLIED - CONTRACTOR INSTALLED; 94" High Options; Inc. REFRSA Remote Refriguration,  OWNER SUPPLIED - CONTRACTOR INSTALLED; Note: Electric Oven  OWNER SUPPLIED - CONTRACTOR INSTALLED;	85" AFF  1/4 NPT  NA  NA	NA NA NA NA	- NA	5" AFF NA 1 1/2" ABS		Inc. Water Filter (PL240)  NA  NA	Hardwired - Hardwired	- Floor Supplied	208v		1 phase	1 Fans (0.19) + LED Canopy = .17 + LED rows 3 Shelves .24 TOTAL = 0.6A 2 Fans = 1.2A; Door Heat = 1.4A; Frame Heat = 0.96A;	NA .		
30 31 32 33 34 35	1 1 1 1 1 1 1 1 1 1 1 1 1 1 1 1 1 1 1 1	112 - BAKERY  112 - BAKERY  113 - BAKERY  114 - WALKIN COOLER  105 - MEAT DISPLAY	BAKERY WORK TABLE  PROOFER  OVEN  COUNTER/SINK  COOLER  FREEZER  CAKE	DOYON  GBS  COOL MASTER  COOL MASTER  Arneg	RPW2S-40.5" D-FL  JA20  4" COOLER PANELS  4" FREEZER PANELS  PV03-8	1918mm x 1102mm x 2527mm  1353mm x 1264mm x 1854mm  2168mm x 4877mm x 2743mm  2168mm x 4877mm x 2743mm  1219mm x 1067mm x 1,372mm (confirm height)	OWNER SUPPLIED - CONTRACTOR INSTALLED; 94" High Options; Inc. REFRSA Remote Refriguration,  OWNER SUPPLIED - CONTRACTOR INSTALLED; Note: Electric Oven  OWNER SUPPLIED - CONTRACTOR INSTALLED;	85" AFF  1/4 NPT  NA  NA	NA NA NA NA	- NA	5" AFF NA 1 1/2" ABS		Inc. Water Filter (PL240)  NA  NA	Hardwired - Hardwired	- Floor Supplied	208v		1 phase	1 Fans (0.19) + LED Canopy = .17 + LED rows 3 Shelves .24 TOTAL = 0.6A 2 Fans = 1.2A; Door Heat = 1.4A; Frame Heat = 0.95A; LED Lighting = 0.36A; Drain Heat = 0.63A;	- NA		
30 31 32 33 34 35 36	1 1 1 1 1 1 1 1 1 1 1 1 1 1 1 1 1 1 1 1	112 - BAKERY  112 - BAKERY  113 - BAKERY  114 - WALKIN COOLER  105 - MEAT DISPLAY	BAKERY WORK TABLE  PROOFER  OVEN  COUNTER/SINK  COOLER  FREEZER  CAKE	DOYON  GBS  COOL MASTER  COOL MASTER  Arneg	RPW2S-40.5" D-FL  JA20  4" COOLER PANELS  4" FREEZER PANELS  PV03-8	1918mm x 1102mm x 2527mm  1353mm x 1264mm x 1854mm  2168mm x 4877mm x 2743mm  2168mm x 4877mm x 2743mm  1219mm x 1067mm x 1,372mm (confirm height)	OWNER SUPPLIED - CONTRACTOR INSTALLED; 94" High Options; Inc. REFR5A Remote Refriguration,  OWNER SUPPLIED - CONTRACTOR INSTALLED; Note: Electric Oven  OWNER SUPPLIED - CONTRACTOR INSTALLED;	85" AFF  1/4 NPT  NA  NA	NA NA NA NA	- NA	5" AFF NA 1 1/2" ABS		Inc. Water Filter (PL240)  NA  NA	Hardwired - Hardwired	- Floor Supplied	208v		1 phase	1 Fans (0.19) + LED Canopy = .17 + LED rows 3 Shelves .24 TOTAL = 0.6A 2 Fans = 1.2A; Door Heat = 1.4A; Frame Heat = 0.95A; LED Lighting = 0.36A; Drain Heat = 0.63A;	NA .		
30 31 32 33 34 35 36 37	1 1 1 1 1 1 1 1 1 1 1 1 1 1 1 1 1 1 1 1	112 - BAKERY  112 - BAKERY  113 - BAKERY  114 - WALKIN COOLER  114 - WALKIN FREEZER  105 - MEAT DISPLAY  105 - MEAT DISPLAY	BAKERY WORK TABLE  PROOFER  OVEN  COUNTER/SINK  COOLER  FREEZER  CAKE  2 DOOR BAKERY FREEZER	DOYON  GBS  COOL MASTER  COOL MASTER  Arneg  HUSSMANN	RPW2S-40.5" D-FL  JA20  4" COOLER PANELS  4" FREEZER PANELS  PV03-8	1918mm x 1102mm x 2527mm  1353mm x 1264mm x 1854mm  2168mm x 4877mm x 2743mm  2168mm x 4877mm x 2743mm  1219mm x 1067mm x 1,372mm (confirm height)	OWNER SUPPLIED - CONTRACTOR INSTALLED; 94" High Options; Inc. REFRSA Remote Refriguration,  OWNER SUPPLIED - CONTRACTOR INSTALLED; Note: Electric Oven  OWNER SUPPLIED - CONTRACTOR INSTALLED;	85" AFF  1/4 NPT  NA  NA	NA NA NA NA	- NA	5" AFF  NA  1 1/2" ABS		Inc. Water Filter (PL240)  NA  NA  -	Hardwired - Hardwired	- Floor Supplied	208v		1 phase	1 Fans (0.19) + LED Canopy = .17 + LED rows 3 Shelves .24 TOTAL = 0.6A 2 Fans = 1.2A; Door Heat = 1.4A; Frame Heat = 0.95A; LED Lighting = 0.36A; Drain Heat = 0.63A;	NA NA		
30 31 32 33 34 35 36 37	1 1 1 1 1 1 1 1 1 1 1 1 1 1 1 1 1 1 1 1	112 - BAKERY  112 - BAKERY  113 - BAKERY  114 - WALKIN COOLER  114 - WALKIN FREEZER  105 - MEAT DISPLAY  105 - MEAT DISPLAY	BAKERY WORK TABLE  PROOFER  OVEN  COUNTER/SINK  COOLER  FREEZER  CAKE  2 DOOR BAKERY FREEZER  DEMP. DISPLAY	DOYON  GBS  COOL MASTER  COOL MASTER  HUSSMANN  Cayuga  Cayuga	RPW2S-40.5" D-FL  JA20  4" COOLER PANELS  4" FREEZER PANELS  PV03-8	1918mm x 1102mm x 2527mm  1353mm x 1264mm x 1854mm  2168mm x 4877mm x 2743mm  2168mm x 4877mm x 2743mm  1219mm x 1067mm x 1,372mm (confirm height)	OWNER SUPPLIED - CONTRACTOR INSTALLED; 94" High Options; Inc. REFR5A Remote Refriguration,  OWNER SUPPLIED - CONTRACTOR INSTALLED; Note: Electric Oven  OWNER SUPPLIED - CONTRACTOR INSTALLED;  OWNER SUPPLIED;	85" AFF  1/4 NPT  NA  NA	NA NA NA NA	- NA	5" AFF  NA  1 1/2" ABS		Inc. Water Filter (PL240)  NA  NA  -	Hardwired - Hardwired	- Floor Supplied	208v		1 phase	1 Fans (0.19) + LED Canopy = .17 + LED rows 3 Shelves .24 TOTAL = 0.6A 2 Fans = 1.2A; Door Heat = 1.4A; Frame Heat = 0.95A; LED Lighting = 0.36A; Drain Heat = 0.63A;	NA		

REVISIONS AND ISSUES

REV	DESCRIPTION	DATE	В
1	REVISED SPA	210809	А
2	ISSUED FOR TENDER	210824	А
3	REVISION TO BUILDING PERMIT	220315	А
4	SI-01	220615	А
5	BLG SET-OUT CAD	220715	А
6	ISSUED FOR CONSTRUCTION	220715	Α
7			
8			
9			
10			

# AMLM

maclennan jaunkalns miller architects

425 adelaide street west level 6 toronto ontario m5v 3c1 416 593 6796 www.mjmarchitects.com

#### TRITON ENGINEERING SERVICES LTD CIVIL ENGINEERS

229 BROADWAY, UNIT 1
ORANGEVILLE, ONTARIO, L9W 1K4
TEL 519 941 0330 FAX 519 941 1830

BLACKWELL STRUCTURAL ENGINEERS

134 PETER STREET, SUITE 1301 TORONTO, ONTARIO, M5V 2H2 TEL 416.593.5300 FAX 416.593.4840

SMITH + ANDERSON MECHANICAL AND ELECTRICAL ENGINEERS

1100 — 100 SHEPPARD AVENUE EAST TORONTO, ONTARIO, M2N 6N5 TEL 416.487.8151 —

## SAYERS FOOD LIMITED

132 BURLEIGH STREET t: 705.656.4531 e: sayers@apsley.ca



NEW SAYERS FOOD STORE BURLEIGH STREET, APSLEY

EQUIPMENT SCHEDULE

JULY 15, 2022

PROJECT NUMBER
2102

DRAWING NUMBER

				GENERAL					MECHANICAL				1				ELECTRICA	L.		
ITEM NO. QTY		DESCRIPTION MEAT BLINKER	BRAND	BASIS OF DESIGN	DIMENSIONS (WxDxH)	SPEC COMMENTS	COLD WATER (mm)			DRAIN	GAS	Mech Notes	CONNECTION	* *	VOLTS	CYCLE	PHASE	AMPS		W ELECTRICAL REMARKS  A Dedicated Circuit
2	105 - MEAT DISPLAY	MEAT BUNKER	Arneg	LAVAL G2 S/C	235mm x 1048mm x 935mm	OWNER SUPPLIED - CONTRACTOR INSTALLED	, 134	NA	nd .	ine)	oro.	130	Hardwired	Floor Supplied	330V	60hz		8.08A	NA N	A Dedicated Circuit
41 2	105 - MEAT DISPLAY	24' MEAT SHELF	Arneg	LISBONA VF06_LS LSB TD76 105-191 HF B16 2016-06-14	3657mm x 1067mm x 2089mr	n OWNER SUPPLIED - CONTRACTOR INSTALLED 12' UNIT, GANG TOGETHER TWO UNITS	; NA	NA	NA	1 1/2" ABS	NA	NA	Hardwired	Floor Supplied	120v	60hz	1	Fans = 1.52A Canopy = 0.5A	NA N	A Dedicated Circuit No Defrost
																		Shelf = 1.25A		
42 4	106 - SHELVING	40' SHELVING	ETALEX			OWNER SUPPLIED - CONTRACTOR INSTALLED PROVIDE FLOOR MONUMENT ELECTRICAL CONNECTIONS;	; -		-				7						-	Provide Floor Outlet Connections
43 1	106 - SHELVING	SHELVES	ETAEX			OWNER SUPPLIED - CONTRACTOR INSTALLED	; -						-			-		-		
44a 2	106 - SHELVING	5 DOOR DAIRY SHELVING	HUSSMANN	RMTM	3896mm x 1162mm x 2261mm	m OWNER SUPPLIED - CONTRACTOR INSTALLED; GANG TOGETHER TWO 5 DOOR AND ONE 3	NA	NA	NA	1 1/2" ABS	NA	NA	Hardwired	Floor Supplied	120v	60hz	1	5 Fans =2.5A Door Heat = NA Frame Heat = 0.37;	-	
44b 1	106 - SHELVING	3 DOOR DAIRY SHELVING	HUSSMANN	RMTM	2350mm x 1162mm x 2261mr	DOOR UNITS  TO OWNER SUPPLIED - CONTRACTOR	NA	NA	NA	1 1/2" ABS	NA	NA	Hardwired	Floor Supplied	120v	60hz	1	LED Lighting = 0.84A; 3 Fans =0.9A		-11
						INSTALLED; GANG TOGETHER TWO 5 DOOR AND ONE 3 DOOR UNITS												Door Heat = NA Frame Heat = 0.22; LED Lighting = 0.53A;		
45 4	106 - SHELVING	5 DOOR FREEZER SHELVING	HUSSMANN	RLTM	3896mm x 1162mm x 2261mr	n OWNER SUPPLIED - CONTRACTOR INSTALLED;	NA	NA	NA	1 1/2" ABS	NA	NA	Hardwired	Floor Supplied	120v Typical; 208v Electric Defrost Heater	60hz	1/3	5 Fans =7.5A; Door Heat = 3.4A;		-
46	107 CHECKOLIT	CHECKOUT	PAN OSTON	1-M-120	3967mm v 1325mm v 1105mm	n OWNER SUPPLIED AND INSTALLED;	NA.	NA.	NA	NA	NA				120			Frame Heat = 2.4A; LED Lighting = 0.84A; Design Heat = 2.57A.		
46	107 - CHECKOUT	CHECKOUT	PAN OSTON	1-141-120	2867IIIII X 1253IIIII X 1103IIII	CONTRACTOR PROVIDE ROUGH-INS	NA	NA	NA	NA .	NA		-	-	120	-	-	2.5A		-
47 1	107 - CHECKOUT	ICE MACHINE	HYLAND ICE	MODEL 65		OWNER SUPPLIED	NA	NA	NA	NA	NA	NA	Nema 5-15p	6' Long Cord	115V	60hz	1 phase	15A	NA N	A Dedicated Circuit
48 4	107 - CHECKOUT	18L WATER	ROCKY RIDGE	47"-1/2" MODEL	1207mm x 1207mm x 1702mr	n OWNER SUPPLIED	NA	NA	NA	NA	NA	NA	NA	NA	NA	NA	NA	NA	NA N	Α -
49 1	A - STAIR A	FLOOR MACHINE SWISH				OWNER SUPPLIED		-		-	-		<del>-</del>	-		÷.	-	-		•
50 1	116 - PRODUCE PREP/STORAGE	COUNTER/SINKS	GBS			OWNER SUPPLIED - CONTRACTOR INSTALL SINK;		-	-	-	-	-	-	-		-0	-	-	-	*
51 1	117 - WALKIN PRODUCE	COOLER	COOL MASTER	4" COOLER PANELS	3810mm x 4573mm x 2743mm	m OWNER SUPPLIED - CONTRACTOR	NA	NA	NA	1"	NA	Coordinate location of drain with	Hardwired	-	OUTDOOR COMPRESSOR	60hz	-	OUTDOOR COMPRESSOR	OUTDOOR -	-1
				- OUTDOOR COMPRESSOR (ASHS9512ZNAFG1); - INTERIOR COILS; - LIGHT;	2. Juliu A 2. 45 mil	INSTALLED;						based on condensate requirements			(ASHS9512ZNAFG1) = 230V - INTERIOR COILS = 115V - LIGHT = 115V			(ASHS9512ZNAFG1) = 20A - INTERIOR COILS = 15A	COMPRESSOR (ASHS9512ZNAFG1) = 1- 1./2 HP	
52 1	118 - MEAT COOLER	COOLER	COOL MASTER	4" COOLER PANELS	3810mm x 3657mm x <b>2743</b> mi	m OWNER SUPPLIED - CONTRACTOR	NA	NA	NA	1"	NA	Coordinate location of drain with	Hardwired	-	OUTDOOR COMPRESSOR	60hz	-	OUTDOOR COMPRESSOR	OUTDOOR -	5.
				- OUTDOOR COMPRESSOR (ASHS9512ZNAFG1); - INTERIOR COILS; - LIGHT;		INSTALLED;						based on condensate requirements			(ASHS9512ZNAFG1) = 230V - INTERIOR COILS = 115V - LIGHT = 115V			(ASHS9512ZNAFG1) = 20A - INTERIOR COILS = 15A	COMPRESSOR (ASHS9512ZNAFG1) = 1- 1./2 HP	
53 1	118 - MEAT COOLER	MEAT GRINDER	HOBART	4146-19	2216mm x 676mm x 1219mm	OWNER SUPPLIED	NA	NA	NA	NA	NA	NA	Hardwired	·	200v	60hz	3 phase	13.29A	5hp2	66kW -
54 1	118 - MEAT COOLER	SHELVES	GBS			OWNER SUPPLIED														
55 1	119 - MEAT PREP	COUNTER/SINKS	GBS			OWNER SUPPLIED - CONTRACTOR INSTALL	-				-		-			-0	-	-	- )-	-
						SINK;														
56a 1	119 - MEAT PREP	MEAT GRINDER	HOBART	MG2032-1 Prime Mixer Grinder	686mm x 1448mm x 1270mm	OWNER SUPPLIED	NA	NA	NA	NA	NA	NA	L15-30	8' Long Cord	208v	60hz	3 phase	30A	7.5 hp - Grind - 1 hp - Mix	
56b 1	119 - MEAT PREP	MEAT GRINDER - TENDERIZER ADD-ON	HOBART	403-1 Tenderizer	510mm x 267mm x 486mm	OWNER SUPPLIED	NA	NA	NA	NA	NA	NA	Nema 5-15p	6' Long Cord	115v	60hz	1 phase	4A	1/2 hp 4	50W
57 1	119 - MEAT PREP	MEAT BONE SAW, ELECTRIC	HOBART	6801-22	400mm x 445mm x 610mm	OWNER SUPPLIED							L15-20p	6' Long Cord	208-240v	60hz	3 phase	7.25	3hp 1	595kW -
				MEAT BONE SAW																
58 1	119 - MEAT PREP	VACCUM SEALER	HOBART			OWNER SUPPLIED								-		-				
59 15	121 - SERVICE	PALLETS RACKING	GRS			OWNER SUPPLIED							_							
		TALLETS HACKING				OWNER SOFT ELES														
60 1	120 - FREEZER	FREEZER																		
			COOL MASTER	4" FREEZER PANELS	3048mm x 4394mm x <b>2743m</b> ı	m OWNER SUPPLIED - CONTRACTOR INSTALLED	; NA	NA	NA		NA		-	-	-	~	-	-		
61 1								NA	NA		NA		-	-	-	-	-			
62 12	121 - WALKIN DAIRY	COOLER		4" FREEZER PANELS  4" COOLER PANELS		m OWNER SUPPLIED - CONTRACTOR INSTALLED  m OWNER SUPPLIED - CONTRACTOR INSTALLED			NA NA		NA NA		-	-		-	-	-		-
	121 - WALKIN DAIRY  000 - MISC INTERIOR												-			-	-	-		
						n OWNER SUPPLIED - CONTRACTOR INSTALLED							-	-		-		-		
63 TBD		HIGH BOYS				n OWNER SUPPLIED - CONTRACTOR INSTALLED							-	-						-
63 TBD	000 - MISC INTERIOR	HIGH BOYS	COOL MASTER TBD			OWNER SUPPLIED - CONTRACTOR INSTALLED     OWNER SUPPLIED														
63 TBD	000 - MISC INTERIOR 000 - MISC INTERIOR	HIGH BOYS	COOL MASTER  TBD  Arneg or Hill Phoenix			OWNER SUPPLIED - CONTRACTOR INSTALLED  OWNER SUPPLIED  OWNER SUPPLIED - CONTRACTOR INSTALLED										-				
63 TBD	000 - MISC INTERIOR 000 - MISC INTERIOR	HIGH BOYS  FLOOR BUMPERS  LIFT	COOL MASTER  TBD  Arneg or Hill Phoenix			OWNER SUPPLIED - CONTRACTOR INSTALLED  OWNER SUPPLIED  OWNER SUPPLIED - CONTRACTOR INSTALLED								-						
63 TBD  64 1  65 1	000 - MISC INTERIOR  000 - MISC INTERIOR  000 - MISC INTERIOR	HIGH BOYS  FLOOR BUMPERS  LIFT	COOL MASTER  TBD  Arneg or Hill Phoenix			OWNER SUPPLIED - CONTRACTOR INSTALLED  OWNER SUPPLIED  OWNER SUPPLIED - CONTRACTOR INSTALLED  OWNER SUPPLIED								-						
63 TBD  64 1  65 1	000 - MISC INTERIOR  000 - MISC INTERIOR  000 - MISC INTERIOR	HIGH BOYS  FLOOR BUMPERS  LIFT	COOL MASTER  TBD  Arneg or Hill Phoenix			OWNER SUPPLIED - CONTRACTOR INSTALLED  OWNER SUPPLIED  OWNER SUPPLIED - CONTRACTOR INSTALLED  OWNER SUPPLIED														
63 TBD  64 1  65 1  66 67 1	000 - MISC INTERIOR  000 - MISC INTERIOR  000 - MISC INTERIOR	HIGH BOYS  FLOOR BUMPERS  LIFT	TBD  Arneg or Hill Phoenix  Prentice  TBD			OWNER SUPPLIED - CONTRACTOR INSTALLED  OWNER SUPPLIED - CONTRACTOR INSTALLED  OWNER SUPPLIED  OWNER SUPPLIED						- NA	Nema 5-15p				1 phase			
64 1 65 1 66 67 1	000 - MISC INTERIOR  000 - MISC INTERIOR  000 - MISC INTERIOR  000 - MISC INTERIOR  Reserved	HIGH BOYS  FLOOR BUMPERS  LIFT  STACKER  - ICE MACHINE	COOL MASTER  TBD  Arneg or Hill Phoenix  Prentice  TBD	4" COOLER PANELS	2745mm x 4876mm x <b>2743m</b> i	OWNER SUPPLIED - CONTRACTOR INSTALLED  OWNER SUPPLIED  OWNER SUPPLIED  OWNER SUPPLIED  OWNER SUPPLIED				NA NA		- NA	Nema 5-15p	- - - 6' Long Cord				- -	NA N	
64 1 65 1 66 67 1	000 - MISC INTERIOR  000 - MISC INTERIOR  000 - MISC INTERIOR  000 - MISC INTERIOR	HIGH BOYS  FLOOR BUMPERS  LIFT  STACKER	COOL MASTER  TBD  Arneg or Hill Phoenix  Prentice  TBD	4" COOLER PANELS	2745mm x 4876mm x <b>2743m</b> i	OWNER SUPPLIED - CONTRACTOR INSTALLED  OWNER SUPPLIED  OWNER SUPPLIED  OWNER SUPPLIED  OWNER SUPPLIED						- NA	- - - Nema 5-15p	- - 6' Long Cord		- - - -		- 15A	NA N	
64 1 65 1 66 67 1	000 - MISC INTERIOR  000 - MISC INTERIOR  000 - MISC INTERIOR  000 - MISC INTERIOR  Reserved	HIGH BOYS  FLOOR BUMPERS  LIFT  STACKER  - ICE MACHINE	COOL MASTER  TBD  Arneg or Hill Phoenix  Prentice  TBD	4" COOLER PANELS	2745mm x 4876mm x <b>2743m</b> i	OWNER SUPPLIED - CONTRACTOR INSTALLED  OWNER SUPPLIED  OWNER SUPPLIED  OWNER SUPPLIED  OWNER SUPPLIED				NA		- NA	- Nema 5-15p	- - - 6' Long Cord			- I phase			
64 1 65 1 66 67 1	000 - MISC INTERIOR  000 - MISC INTERIOR  000 - MISC INTERIOR  000 - MISC INTERIOR  000 - EXTERIOR	HIGH BOYS  FLOOR BUMPERS  LIFT  STACKER  - ICE MACHINE  SHOPPING CARTS	COOL MASTER  TBD  Arneg or Hill Phoenix  Prentice  TBD	4" COOLER PANELS	2745mm x 4876mm x <b>2743m</b> i	OWNER SUPPLIED				NA NA		- NA	- Nema 5-15p	- - - 6' Long Cord			- I phase			
64 1 65 1 66 67 1	000 - MISC INTERIOR  000 - MISC INTERIOR  000 - MISC INTERIOR  000 - MISC INTERIOR  000 - EXTERIOR	HIGH BOYS  FLOOR BUMPERS  LIFT  STACKER  - ICE MACHINE  SHOPPING CARTS	COOL MASTER  TBD  Arneg or Hill Phoenix  Prentice  TBD	4" COOLER PANELS	2745mm x 4876mm x <b>2743m</b> i	OWNER SUPPLIED				- NA		- NA	- Nema 5-15p							- Exterior, Dedicated Circuit
64 1 65 1 66 67 1	000 - MISC INTERIOR  000 - MISC INTERIOR  000 - MISC INTERIOR  000 - MISC INTERIOR  000 - EXTERIOR  000 - EXTERIOR	HIGH BOYS  FLOOR BUMPERS  LIFT  STACKER  -  ICE MACHINE  SHOPPING CARTS  PROPANE EXCHANGE	COOL MASTER  TBD  Arneg or Hill Phoenix  Prentice  TBD	4" COOLER PANELS	2745mm x 4876mm x <b>2743m</b> i	OWNER SUPPLIED						NA .	- Nema 5-15p	- 6' Long Cord	- 115V		- I phase			A Exterior, Dedicated Circuit
64 1 65 1 66 67 1	000 - MISC INTERIOR  000 - MISC INTERIOR  000 - MISC INTERIOR  000 - MISC INTERIOR  000 - EXTERIOR  000 - EXTERIOR  000 - EXTERIOR	HIGH BOYS  FLOOR BUMPERS  LIFT  STACKER  ICE MACHINE  SHOPPING CARTS  PROPANE EXCHANGE	COOL MASTER  TBD  Arneg or Hill Phoenix  Prentice  TBD	4" COOLER PANELS	2745mm x 4876mm x <b>2743m</b> i	OWNER SUPPLIED						NA .	- Nema 5-15p				- I phase			- Exterior, Dedicated Circuit
64 1 1 65 1 66 67 1 68 40 69 1 70 1 71 2	000 - MISC INTERIOR  000 - MISC INTERIOR  000 - MISC INTERIOR  000 - MISC INTERIOR  000 - EXTERIOR  000 - EXTERIOR  000 - EXTERIOR	HIGH BOYS  FLOOR BUMPERS  LIFT  STACKER  ICE MACHINE  SHOPPING CARTS  PROPANE EXCHANGE	COOL MASTER  TBD  Arneg or Hill Phoenix  Prentice  TBD	4" COOLER PANELS	2745mm x 4876mm x <b>2743m</b> i	OWNER SUPPLIED						- NA	- Nema 5-15p	- G' Long Cord	- 115V		- I phase			Exterior, Dedicated Circuit
64 1 65 1 66 67 1 68 40 69 1 70 1	000 - MISC INTERIOR  000 - MISC INTERIOR  000 - MISC INTERIOR  000 - MISC INTERIOR  000 - EXTERIOR	HIGH BOYS  FLOOR BUMPERS  LIFT  STACKER  ICE MACHINE  SHOPPING CARTS  PROPANE EXCHANGE  FIREWOOD EXCHANGE  RAIN BARRELS  STORAGE SHELVES	TBD  Arneg or Hill Phoenix  Prentice  TBD  TBD  TBD  TBD  TBD  TBD	4" COOLER PANELS	2745mm x 4876mm x 2743mm  2388mm x 902mm x 3012mm	OWNER SUPPLIED				NA NA		NA NA						-		- Exterior, Dedicated Circuit
64 1 1 65 1 66 67 1 68 40 69 1 70 1 71 2	000 - MISC INTERIOR  000 - MISC INTERIOR  000 - MISC INTERIOR  000 - MISC INTERIOR  000 - EXTERIOR  000 - EXTERIOR  000 - EXTERIOR  000 - EXTERIOR	HIGH BOYS  FLOOR BUMPERS  LIFT  STACKER  ICE MACHINE  SHOPPING CARTS  PROPANE EXCHANGE  FIREWOOD EXCHANGE  RAIN BARRELS  STORAGE SHELVES	TBD  Arneg or Hill Phoenix  Prentice  TBD  TBD  TBD  TBD  TBD	4" COOLER PANELS	2745mm x 4876mm x <b>2743m</b> i	OWNER SUPPLIED				NA NA		min. psi = 30 max psi = 100	- Nema 5-15p	- 6' Long Cord				- 15A or 20A		Exterior, Dedicated Circuit
64 1 65 1 66 67 1 68 40 69 1 70 1 71 2 72 TBD	000 - MISC INTERIOR  000 - MISC INTERIOR  000 - MISC INTERIOR  000 - MISC INTERIOR  000 - EXTERIOR	HIGH BOYS  FLOOR BUMPERS  LIFT  STACKER  ICE MACHINE  SHOPPING CARTS  PROPANE EXCHANGE  FIREWOOD EXCHANGE  RAIN BARRELS  STORAGE SHELVES	TBD  Arneg or Hill Phoenix  Prentice  TBD  TBD  TBD  TBD  TBD  TBD	4" COOLER PANELS	2745mm x 4876mm x 2743mm  2388mm x 902mm x 3012mm	OWNER SUPPLIED				NA NA				- 6' Long Cord	- 115V			-	-	Exterior, Dedicated Circuit
64 1 65 1 66 67 1 68 40 69 1 70 1 71 2 72 TBD	000 - MISC INTERIOR  000 - MISC INTERIOR  000 - MISC INTERIOR  000 - MISC INTERIOR  000 - EXTERIOR  000 - EXTERIOR  000 - EXTERIOR  000 - EXTERIOR  207 - STORAGE  202 - STAFF LOUNGE	HIGH BOYS  FLOOR BUMPERS  LIFT  STACKER  -  ICE MACHINE  SHOPPING CARTS  PROPANE EXCHANGE  FIREWOOD EXCHANGE  RAIN BARRELS  STORAGE SHELVES  RESIDENTIAL FRIDGE	TBD  Arneg or Hill Phoenix  Prentice  TBD  TBD  TBD  TBD  TBD  TBD  TBD  TB	4" COOLER PANELS	2745mm x 4876mm x 2743mm  2388mm x 902mm x 3012mm	OWNER SUPPLIED				NA NA								-	-	A Exterior, Dedicated Circuit
64 1 65 1 66 67 1 68 40 69 1 70 1 71 2 72 TBD	000 - MISC INTERIOR  000 - MISC INTERIOR  000 - MISC INTERIOR  000 - MISC INTERIOR  000 - EXTERIOR  000 - EXTERIOR  000 - EXTERIOR  000 - EXTERIOR  207 - STORAGE  202 - STAFF LOUNGE	HIGH BOYS  FLOOR BUMPERS  LIFT  STACKER  -  ICE MACHINE  SHOPPING CARTS  PROPANE EXCHANGE  FIREWOOD EXCHANGE  RAIN BARRELS  STORAGE SHELVES  RESIDENTIAL FRIDGE	TBD  Arneg or Hill Phoenix  Prentice  TBD  TBD  TBD  TBD  TBD  TBD  TBD  TB	4" COOLER PANELS	2745mm x 4876mm x 2743mm  2388mm x 902mm x 3012mm	OWNER SUPPLIED				NA NA					115V			-		Exterior, Dedicated Circuit
64 1 65 1 66 67 1 68 40 69 1 70 1 71 2 72 TBD 73 1	000 - MISC INTERIOR  000 - MISC INTERIOR  000 - MISC INTERIOR  000 - MISC INTERIOR  000 - EXTERIOR  000 - EXTERIOR  000 - EXTERIOR  000 - EXTERIOR  207 - STORAGE  207 - STORAGE  Reserved	HIGH BOYS  FLOOR BUMPERS  LIFT  STACKER  -  ICE MACHINE  SHOPPING CARTS  PROPANE EXCHANGE  FIREWOOD EXCHANGE  RAIN BARRELS  STORAGE SHELVES  RESIDENTIAL FRIDGE  -  STOVE - STANDARD ELECTRIC	COOL MASTER  TBD  Arneg or Hill Phoenix  Prentice  TBD  TBD  TBD  TBD  TBD  TBD  TBD  TB	4" COOLER PANELS	2745mm x 4876mm x 2743mm  2745mm x 4876mm x 2743mm	OWNER SUPPLIED	NA  NA  1/4"			NA NA								-	-	Exterior, Dedicated Circuit
64 1 65 1 66 67 1 68 40 69 1 70 1 71 2 72 TBD 73 1	000 - MISC INTERIOR  000 - MISC INTERIOR  000 - MISC INTERIOR  000 - MISC INTERIOR  000 - EXTERIOR  000 - EXTERIOR  000 - EXTERIOR  000 - EXTERIOR  207 - STORAGE  207 - STORAGE  Reserved	HIGH BOYS  FLOOR BUMPERS  LIFT  STACKER  -  ICE MACHINE  SHOPPING CARTS  PROPANE EXCHANGE  FIREWOOD EXCHANGE  RAIN BARRELS  STORAGE SHELVES  RESIDENTIAL FRIDGE  -  STOVE - STANDARD ELECTRIC RANGE/OVEN	COOL MASTER  TBD  Arneg or Hill Phoenix  Prentice  TBD  TBD  TBD  TBD  TBD  TBD  TBD  TB	4" COOLER PANELS  - Model 100  RVRF3361 - 36"  - CFEH3054U S/W	2745mm x 4876mm x 2743mm  2745mm x 4876mm x 2743mm	DWNER SUPPLIED  OWNER SUPPLIED	NA  NA  1/4"							- 6' Long Cord				-	-	A Exterior, Dedicated Circuit
64 1 65 1 66 67 1 68 40 69 1 70 1 71 2 72 TBD 73 1	000 - MISC INTERIOR  000 - MISC INTERIOR  000 - MISC INTERIOR  000 - MISC INTERIOR  000 - EXTERIOR  000 - EXTERIOR  000 - EXTERIOR  000 - EXTERIOR  207 - STORAGE  207 - STORAGE  Reserved	HIGH BOYS  FLOOR BUMPERS  LIFT  STACKER  -  ICE MACHINE  SHOPPING CARTS  PROPANE EXCHANGE  FIREWOOD EXCHANGE  RAIN BARRELS  STORAGE SHELVES  RESIDENTIAL FRIDGE  -  STOVE - STANDARD ELECTRIC RANGE/OVEN	COOL MASTER  TBD  Arneg or Hill Phoenix  Prentice  TBD  TBD  TBD  TBD  TBD  TBD  TBD  TB	4" COOLER PANELS  - Model 100  RVRF3361 - 36"  - CFEH3054U S/W	2745mm x 4876mm x 2743mm  2745mm x 4876mm x 2743mm	DWNER SUPPLIED  OWNER SUPPLIED	NA  NA  1/4"			NA NA				- 6' Long Cord					-	A Exterior, Dedicated Circuit
64 1 65 1 66 67 1 68 40 69 1 70 1 71 2 72 TBD 73 1	000 - MISC INTERIOR  000 - MISC INTERIOR  000 - MISC INTERIOR  000 - MISC INTERIOR  000 - EXTERIOR  000 - EXTERIOR  000 - EXTERIOR  000 - EXTERIOR  207 - STORAGE  207 - STORAGE  207 - STORAGE  208 - STAFF LOUNGE  209 - STAFF LOUNGE	HIGH BOYS  FLOOR BUMPERS  LIFT  STACKER  .  ICE MACHINE  SHOPPING CARTS  PROPANE EXCHANGE  FIREWOOD EXCHANGE  RAIN BARRELS  STORAGE SHELVES  RESIDENTIAL FRIDGE  .  STOVE - STANDARD ELECTRIC RANGE/OVEN  STOVE - HOOD	TBD  Arneg or Hill Phoenix  Prentice  TBD  TBD  TBD  TBD  TBD  TBD  TBD  TB	4" COOLER PANELS	2745mm x 4876mm x 2743mm  2745mm x 4876mm x 2743mm  2388mm x 902mm x 3012mm  914mm x 750mm x 1765mm	OWNER SUPPLIED	NA  NA  1/4"			NA NA			- Nema 5-15p	- 6' Long Cord	115V  120V	- - - -	- I phase		-	
64 1 65 1 66 66 67 1 68 40 69 1 70 1 71 2 72 TBD 73 1	000 - MISC INTERIOR  000 - MISC INTERIOR  000 - MISC INTERIOR  000 - MISC INTERIOR  000 - EXTERIOR  000 - EXTERIOR  000 - EXTERIOR  000 - EXTERIOR  200 - EXTERIOR  207 - STORAGE  202 - STAFF LOUNGE  203 - STAFF LOUNGE	HIGH BOYS  FLOOR BUMPERS  LIFT  STACKER  -  ICE MACHINE  SHOPPING CARTS  PROPANE EXCHANGE  FIREWOOD EXCHANGE  RAIN BARRELS  STORAGE SHELVES  RESIDENTIAL FRIDGE  -  STOVE - STANDARD ELECTRIC RANGE/OVEN  STOVE - HOOD	TBD  Arneg or Hill Phoenix  Prentice  TBD  TBD  TBD  TBD  TBD  TBD  TBD  TB	4" COOLER PANELS	2745mm x 4876mm x 2743mm  2745mm x 4876mm x 2743mm  2388mm x 902mm x 3012mm  914mm x 750mm x 1765mm	DWNER SUPPLIED  OWNER SUPPLIED	NA  NA  1/4"			NA NA			- Nema 5-15p	- 6' Long Cord	115V  120V	- - - -	- I phase		-	
64 1 65 1 66 67 1 68 40 69 1 70 1 71 2 72 TBD 73 1	000 - MISC INTERIOR  000 - MISC INTERIOR  000 - MISC INTERIOR  000 - MISC INTERIOR  000 - EXTERIOR  000 - EXTERIOR  000 - EXTERIOR  000 - EXTERIOR  207 - STORAGE  207 - STORAGE  207 - STORAGE  208 - STAFF LOUNGE  209 - STAFF LOUNGE	HIGH BOYS  FLOOR BUMPERS  LIFT  STACKER  .  ICE MACHINE  SHOPPING CARTS  PROPANE EXCHANGE  FIREWOOD EXCHANGE  RAIN BARRELS  STORAGE SHELVES  RESIDENTIAL FRIDGE  .  STOVE - STANDARD ELECTRIC RANGE/OVEN  STOVE - HOOD	COOL MASTER  TBD  Arneg or Hill Phoenix  Prentice  TBD  TBD  TBD  TBD  TBD  TBD  TBD  TB	4" COOLER PANELS	2745mm x 4876mm x 2743mm 2745mm x 4876mm x 2743mm 2388mm x 902mm x 3012mm 2388mm x 902mm x 3012mm	OWNER SUPPLIED	NA  NA  1/4"			NA NA			- Nema 5-15p	- 6' Long Cord		- - - -	- I phase		-	

REVISIONS AND ISSUES

REV	DESCRIPTION	DATE	BY
1	REVISED SPA	210809	AB
2	ISSUED FOR TENDER	210824	AB
3	REVISION TO BUILDING PERMIT	220315	AB
4	SI-01	220615	AB
5	BLG SET-OUT CAD	220715	AB
6	ISSUED FOR CONSTRUCTION	220715	AB
7			
8			
9			

# **MJMA**

maclennan jaunkalns miller architects

425 adelaide street west level 6 toronto ontario m5v 3c1 416 593 6796 www.mjmarchitects.com

#### TRITON ENGINEERING SERVICES LTD CIVIL ENGINEERS

229 BROADWAY, UNIT 1
ORANGEVILLE, ONTARIO, L9W 1K4
TEL 519 941 0330 FAX 519 941 1830

BLACKWELL STRUCTURAL ENGINEERS


134 PETER STREET, SUITE 1301 TORONTO, ONTARIO, M5V 2H2 TEL 416.593.5300 FAX 416.593.4840

SMITH + ANDERSON MECHANICAL AND ELECTRICAL ENGINEERS

1100 — 100 SHEPPARD AVENUE EAST TORONTO, ONTARIO, M2N 6N5 TEL 416.487.8151 —

## SAYERS FOOD LIMITED

132 BURLEIGH STREET t: 705.656.4531 e: sayers@apsley.ca

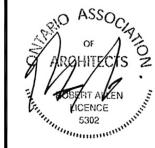


NEW SAYERS FOOD STORE BURLEIGH STREET, APSLEY

EQUIPMENT SCHEDULE

JULY 15, 2022

PROJECT NUMBER
2102

DRAWING NUMBER

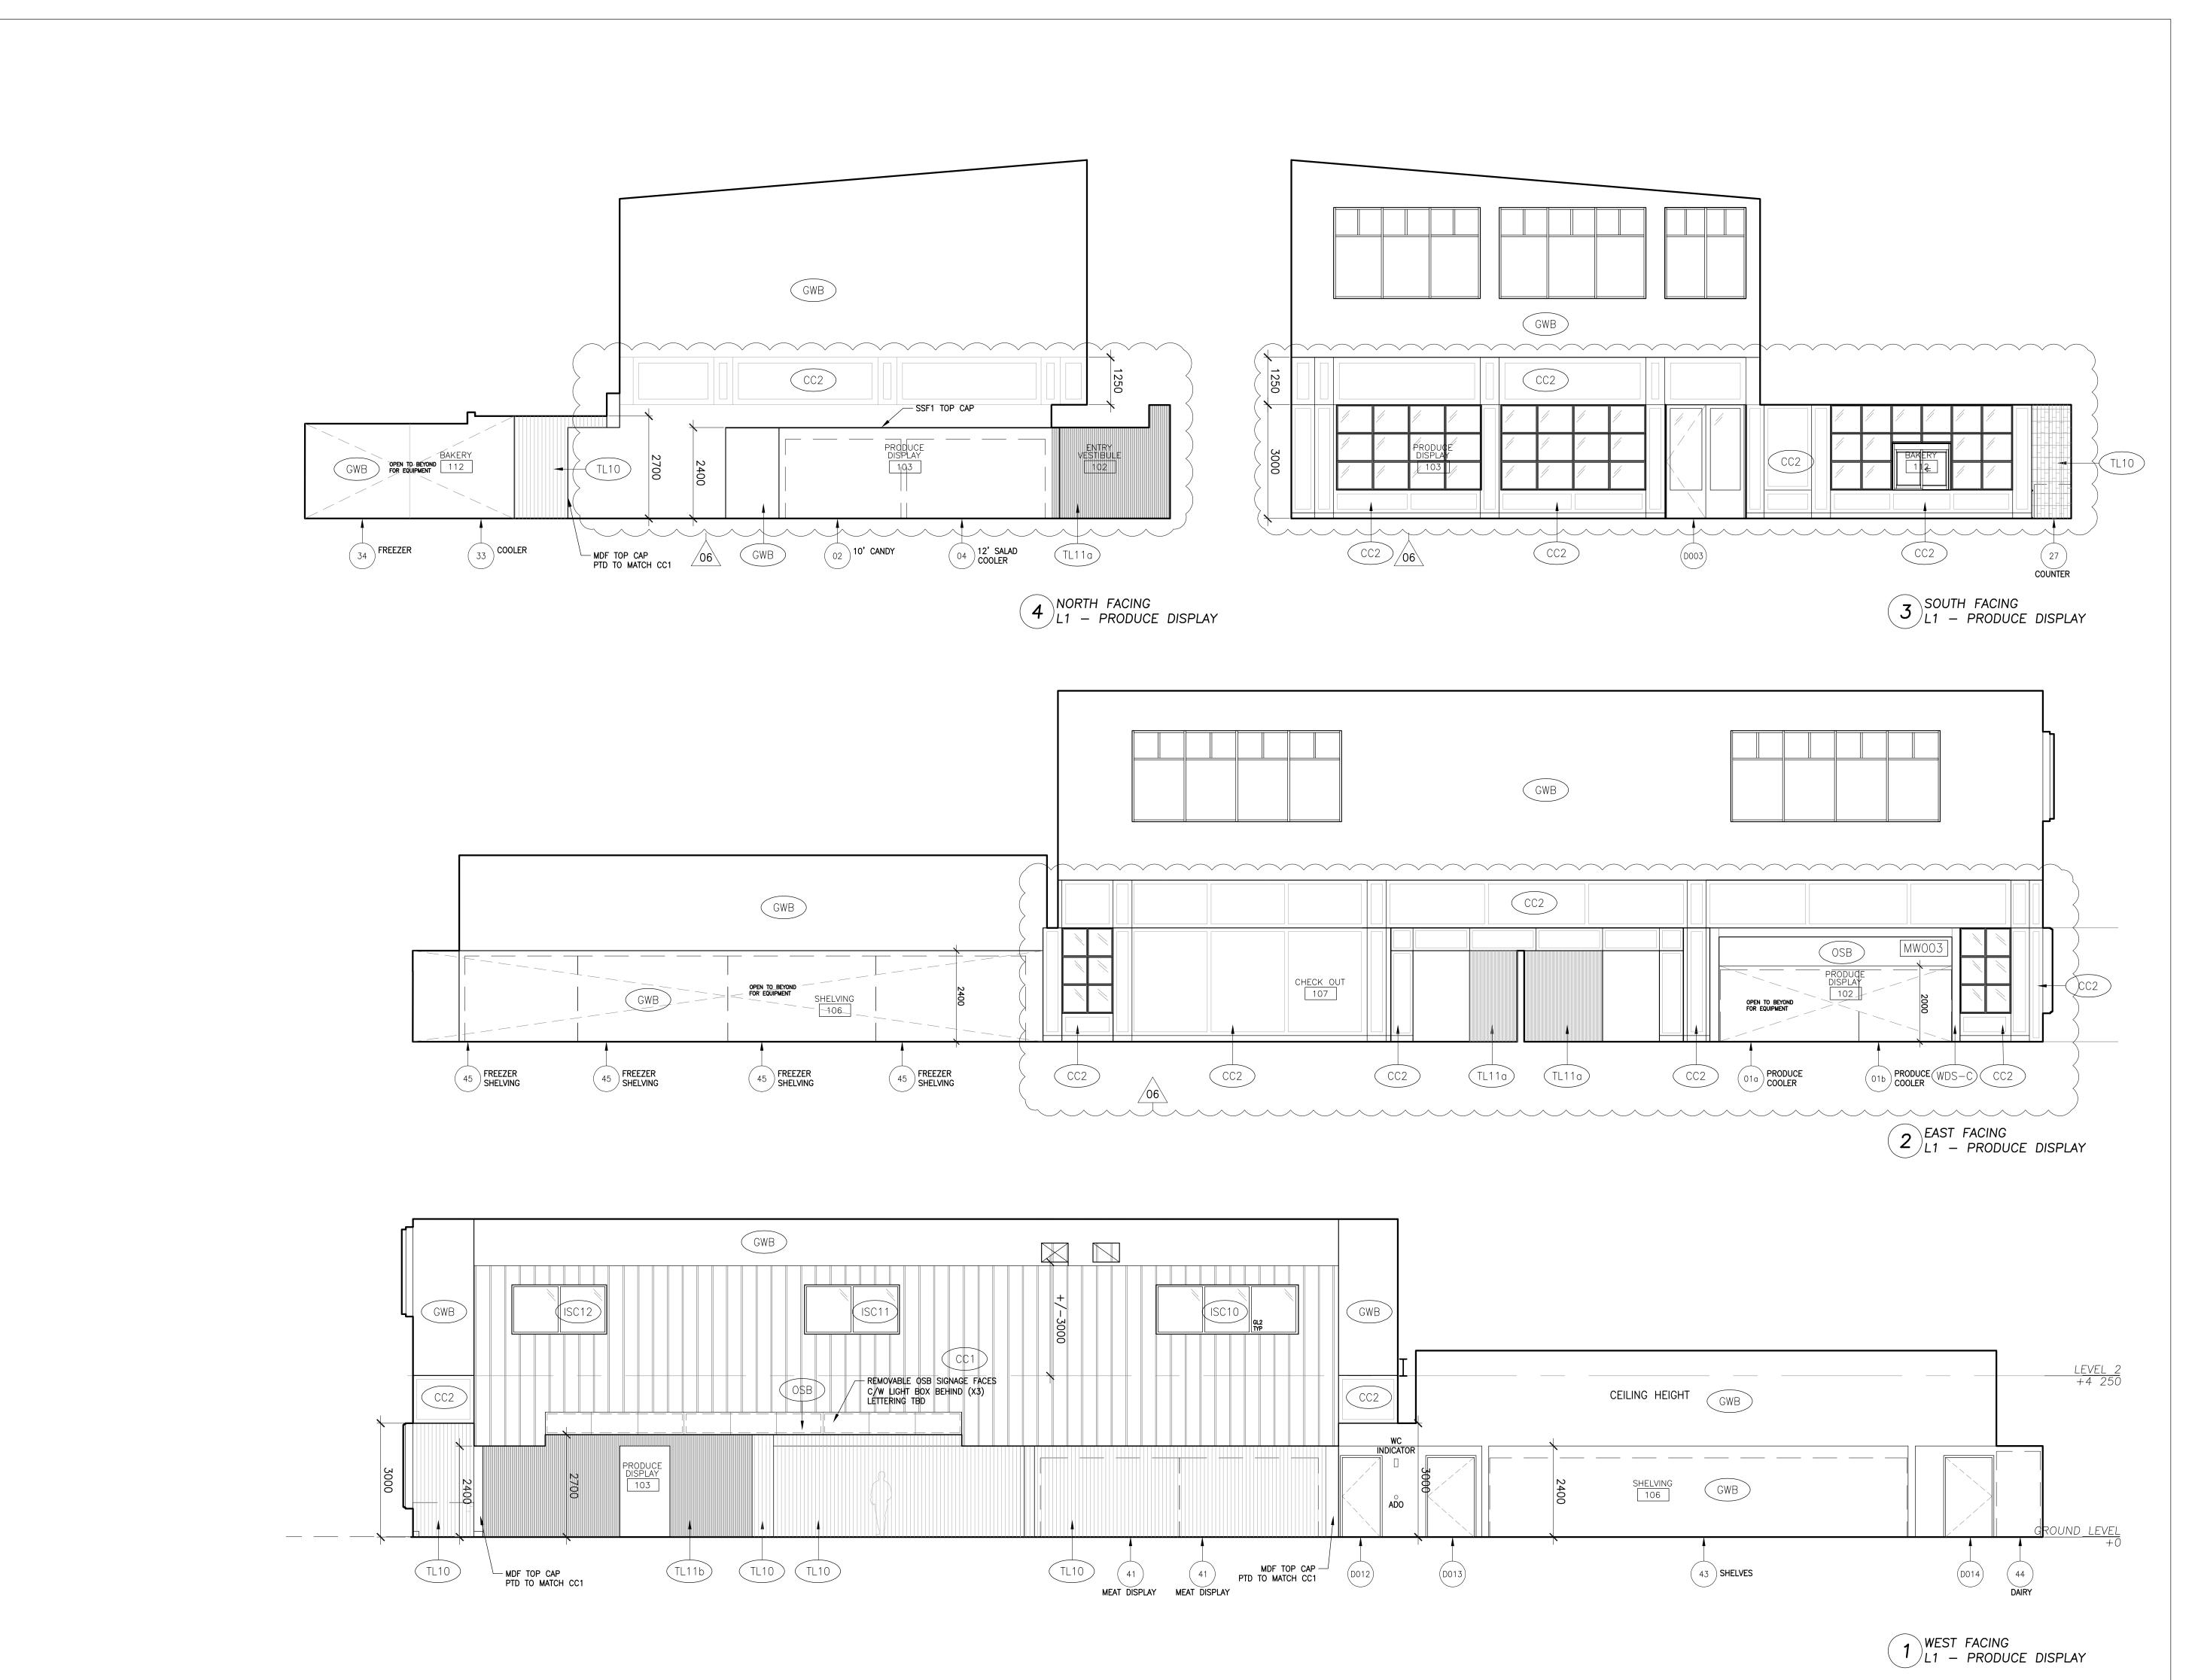

 REVISIONS AND ISSUES

 REV
 DESCRIPTION
 DATE

 1
 REVISED SPA
 210809

 2
 ISSUED FOR TENDER
 210824

 3
 REVISION TO BUILDING PERMIT
 220315

 4
 SI-01
 220615

BLG SET-OUT CAD

ISSUED FOR CONSTRUCTION 220715

220715

9 10

MJMA

maclennan jaunkalns miller architects
425 adelaide street west level 6

toronto ontario m5v 3c1 416 593 6796 www.mjmarchitects.com

TRITON ENGINEERING SERVICES LTD CIVIL ENGINEERS

229 BROADWAY, UNIT 1
ORANGEVILLE, ONTARIO, L9W 1K4
TEL 519 941 0330 FAX 519 941 1830

TEL 519 941 0330 FAX 519 941

BLACKWELL

134 PETER STREET, SUITE 1301
TORONTO, ONTARIO, M5V 2H2
TEL 416.593.5300 FAX 416.593.4840

STRUCTURAL ENGINEERS


SMITH + ANDERSON MECHANICAL AND ELECTRICAL ENGINEERS

1100 - 100 SHEPPARD AVENUE EAST TORONTO, ONTARIO, M2N 6N5 TEL 416.487.8151 -

## SAYERS FOOD LIMITED

132 BURLEIGH STREET t: 705.656.4531 e: sayers@apsley.ca

NORTH ARROW

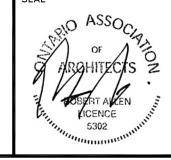

ROJECT TITLE

NEW SAYERS FOOD STORE BURLEIGH STREET, APSLEY

DRAWING TITLE


INTERIOR ELEVATIONS

1:100

JULY 15, 2022

PROJECT NUMBER

2102
DRAWING NUMBER

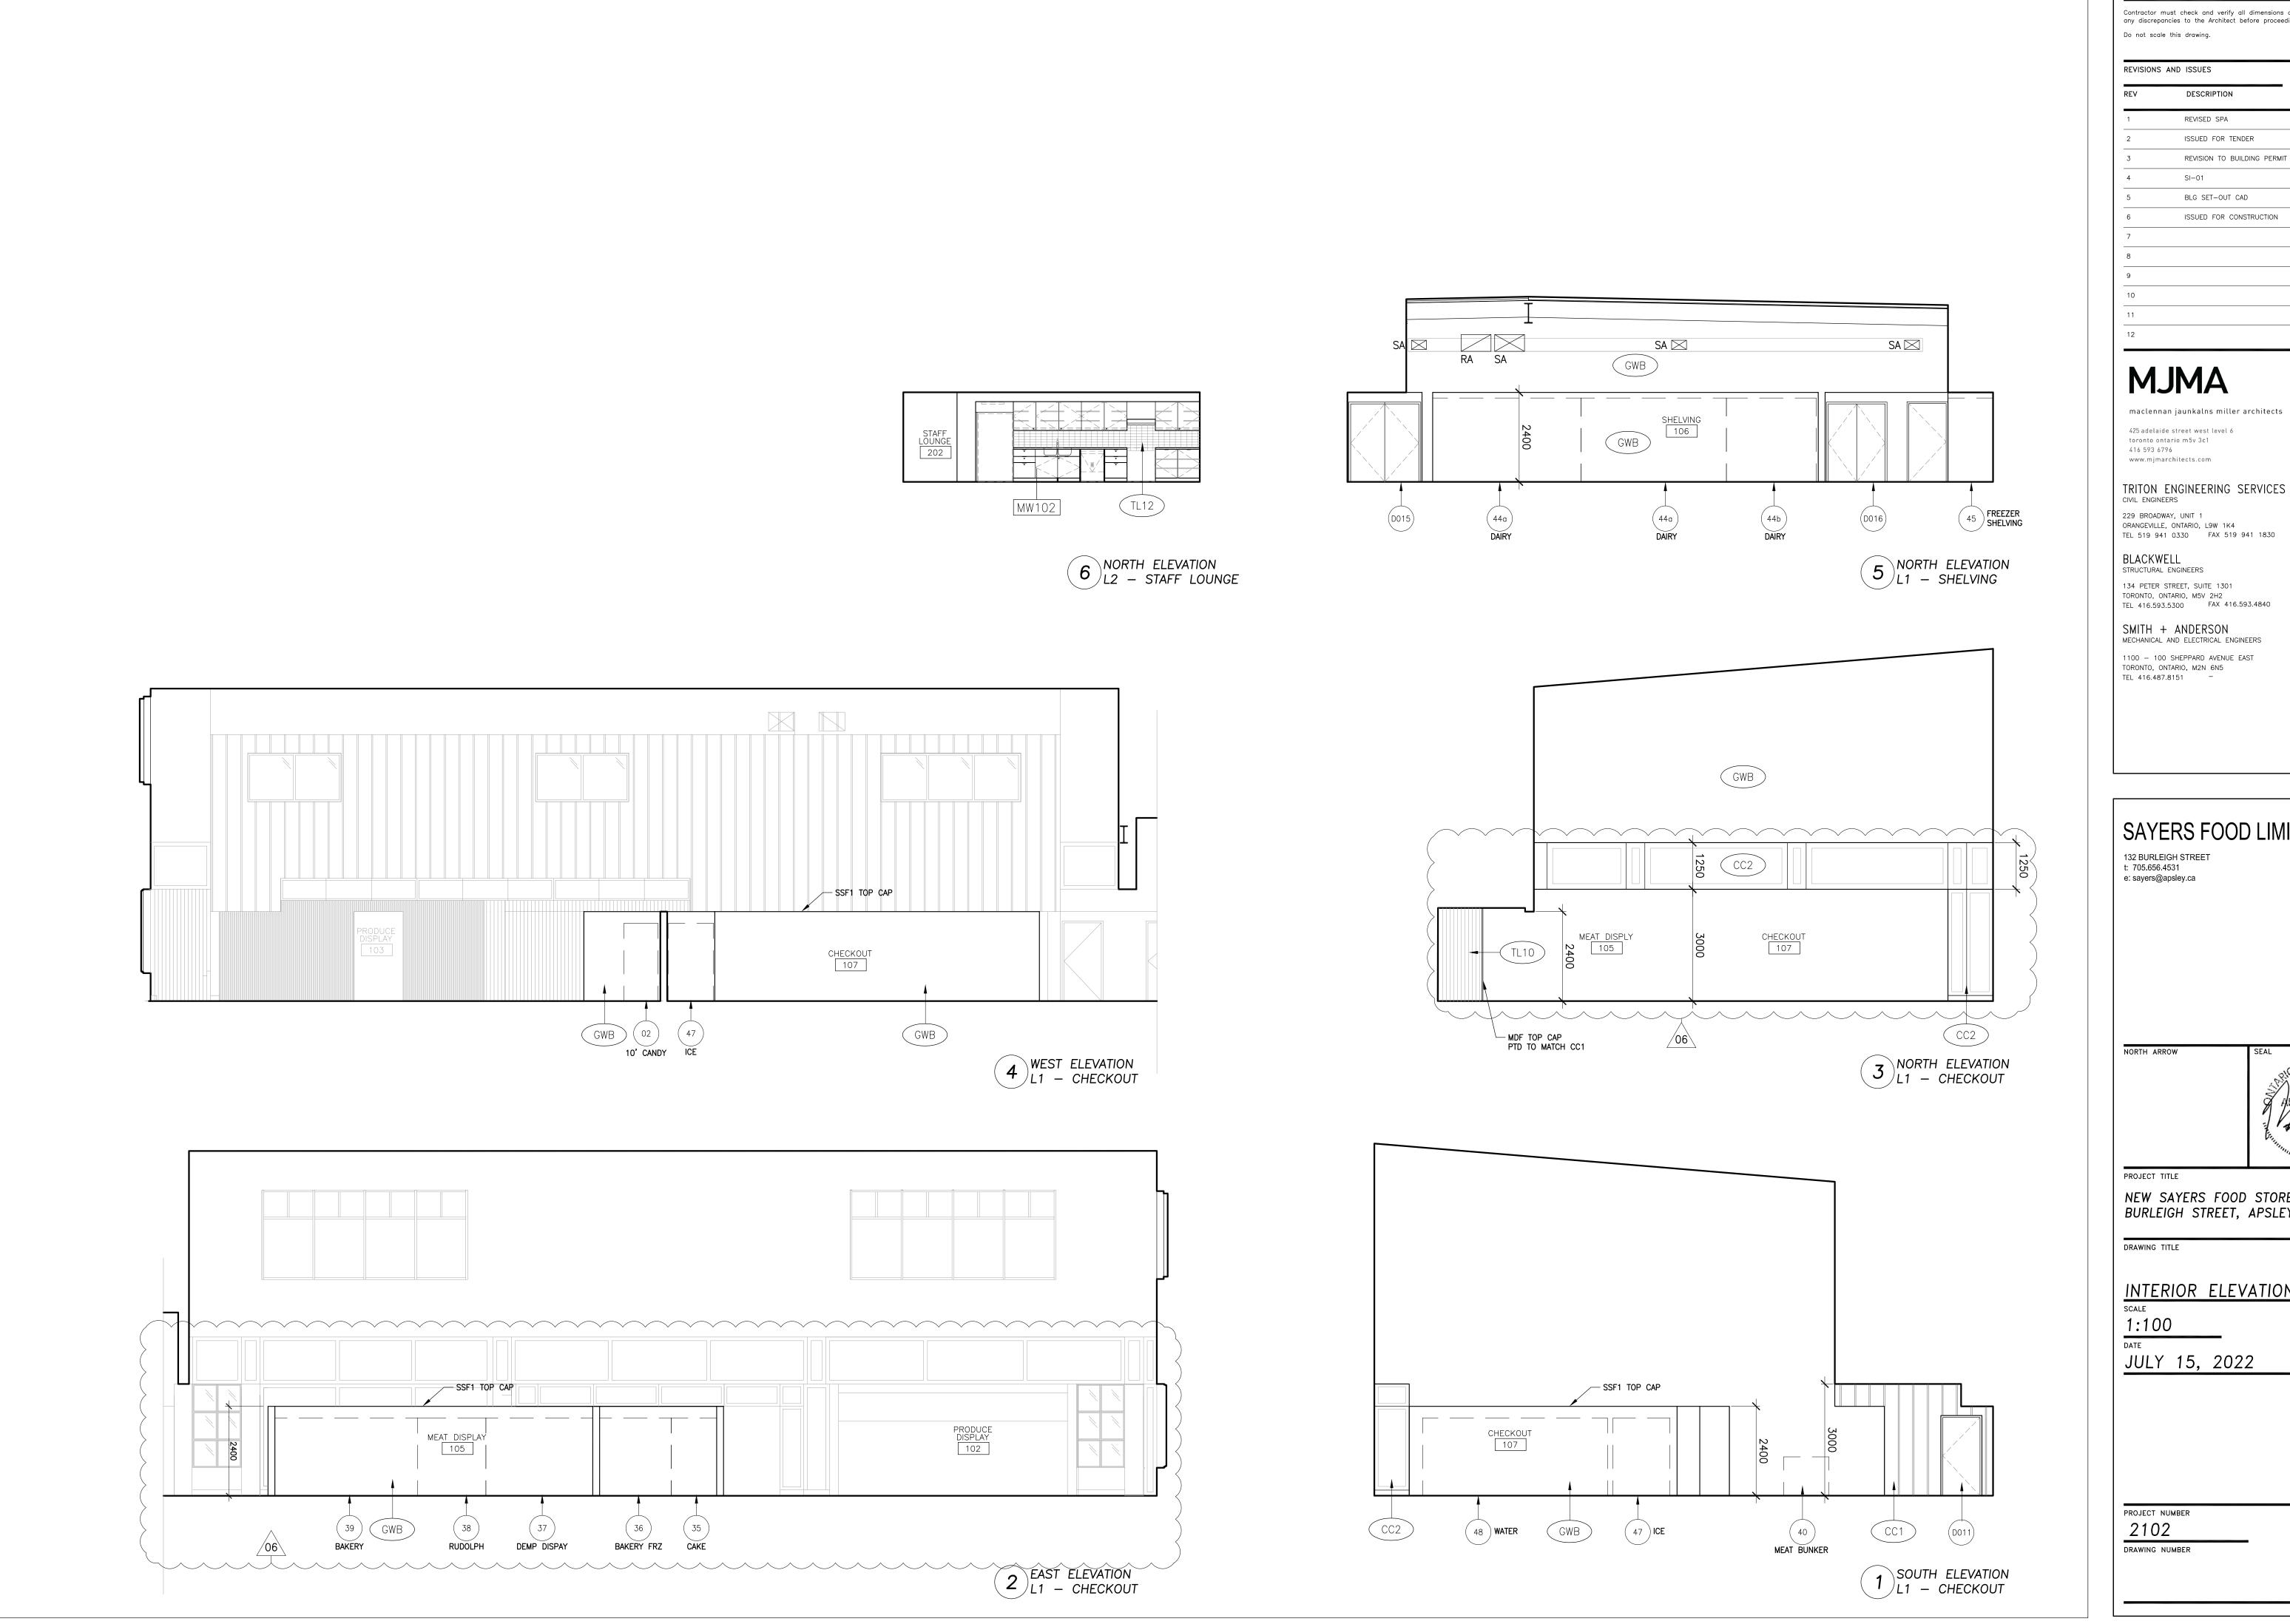

REV	DESCRIPTION	DATE	B
1	REVISED SPA	210809	AE
2	ISSUED FOR TENDER	210824	AE
3	REVISION TO BUILDING PERMIT	220315	AB
4	SI-01	220615	AB
5	BLG SET-OUT CAD	220715	AB
6	ISSUED FOR CONSTRUCTION	220715	AB

**MJMA** 

425 adelaide street west level 6 toronto ontario m5v 3c1 416 593 6796 www.mjmarchitects.com

TRITON ENGINEERING SERVICES LTD CIVIL ENGINEERS

229 BROADWAY, UNIT 1 ORANGEVILLE, ONTARIO, L9W 1K4
TEL 519 941 0330 FAX 519 941 1830

BLACKWELL

STRUCTURAL ENGINEERS 134 PETER STREET, SUITE 1301 TORONTO, ONTARIO, M5V 2H2
TEL 416.593.5300 FAX 416.593.4840


SMITH + ANDERSON MECHANICAL AND ELECTRICAL ENGINEERS

1100 — 100 SHEPPARD AVENUE EAST TORONTO, ONTARIO, M2N 6N5 TEL 416.487.8151 —

# SAYERS FOOD LIMITED

132 BURLEIGH STREET t: 705.656.4531 e: sayers@apsley.ca

NORTH ARROW

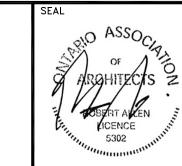

NEW SAYERS FOOD STORE BURLEIGH STREET, APSLEY

DRAWING TITLE


INTERIOR ELEVATIONS

1:100

JULY 15, 2022

PROJECT NUMBER

2102 DRAWING NUMBER

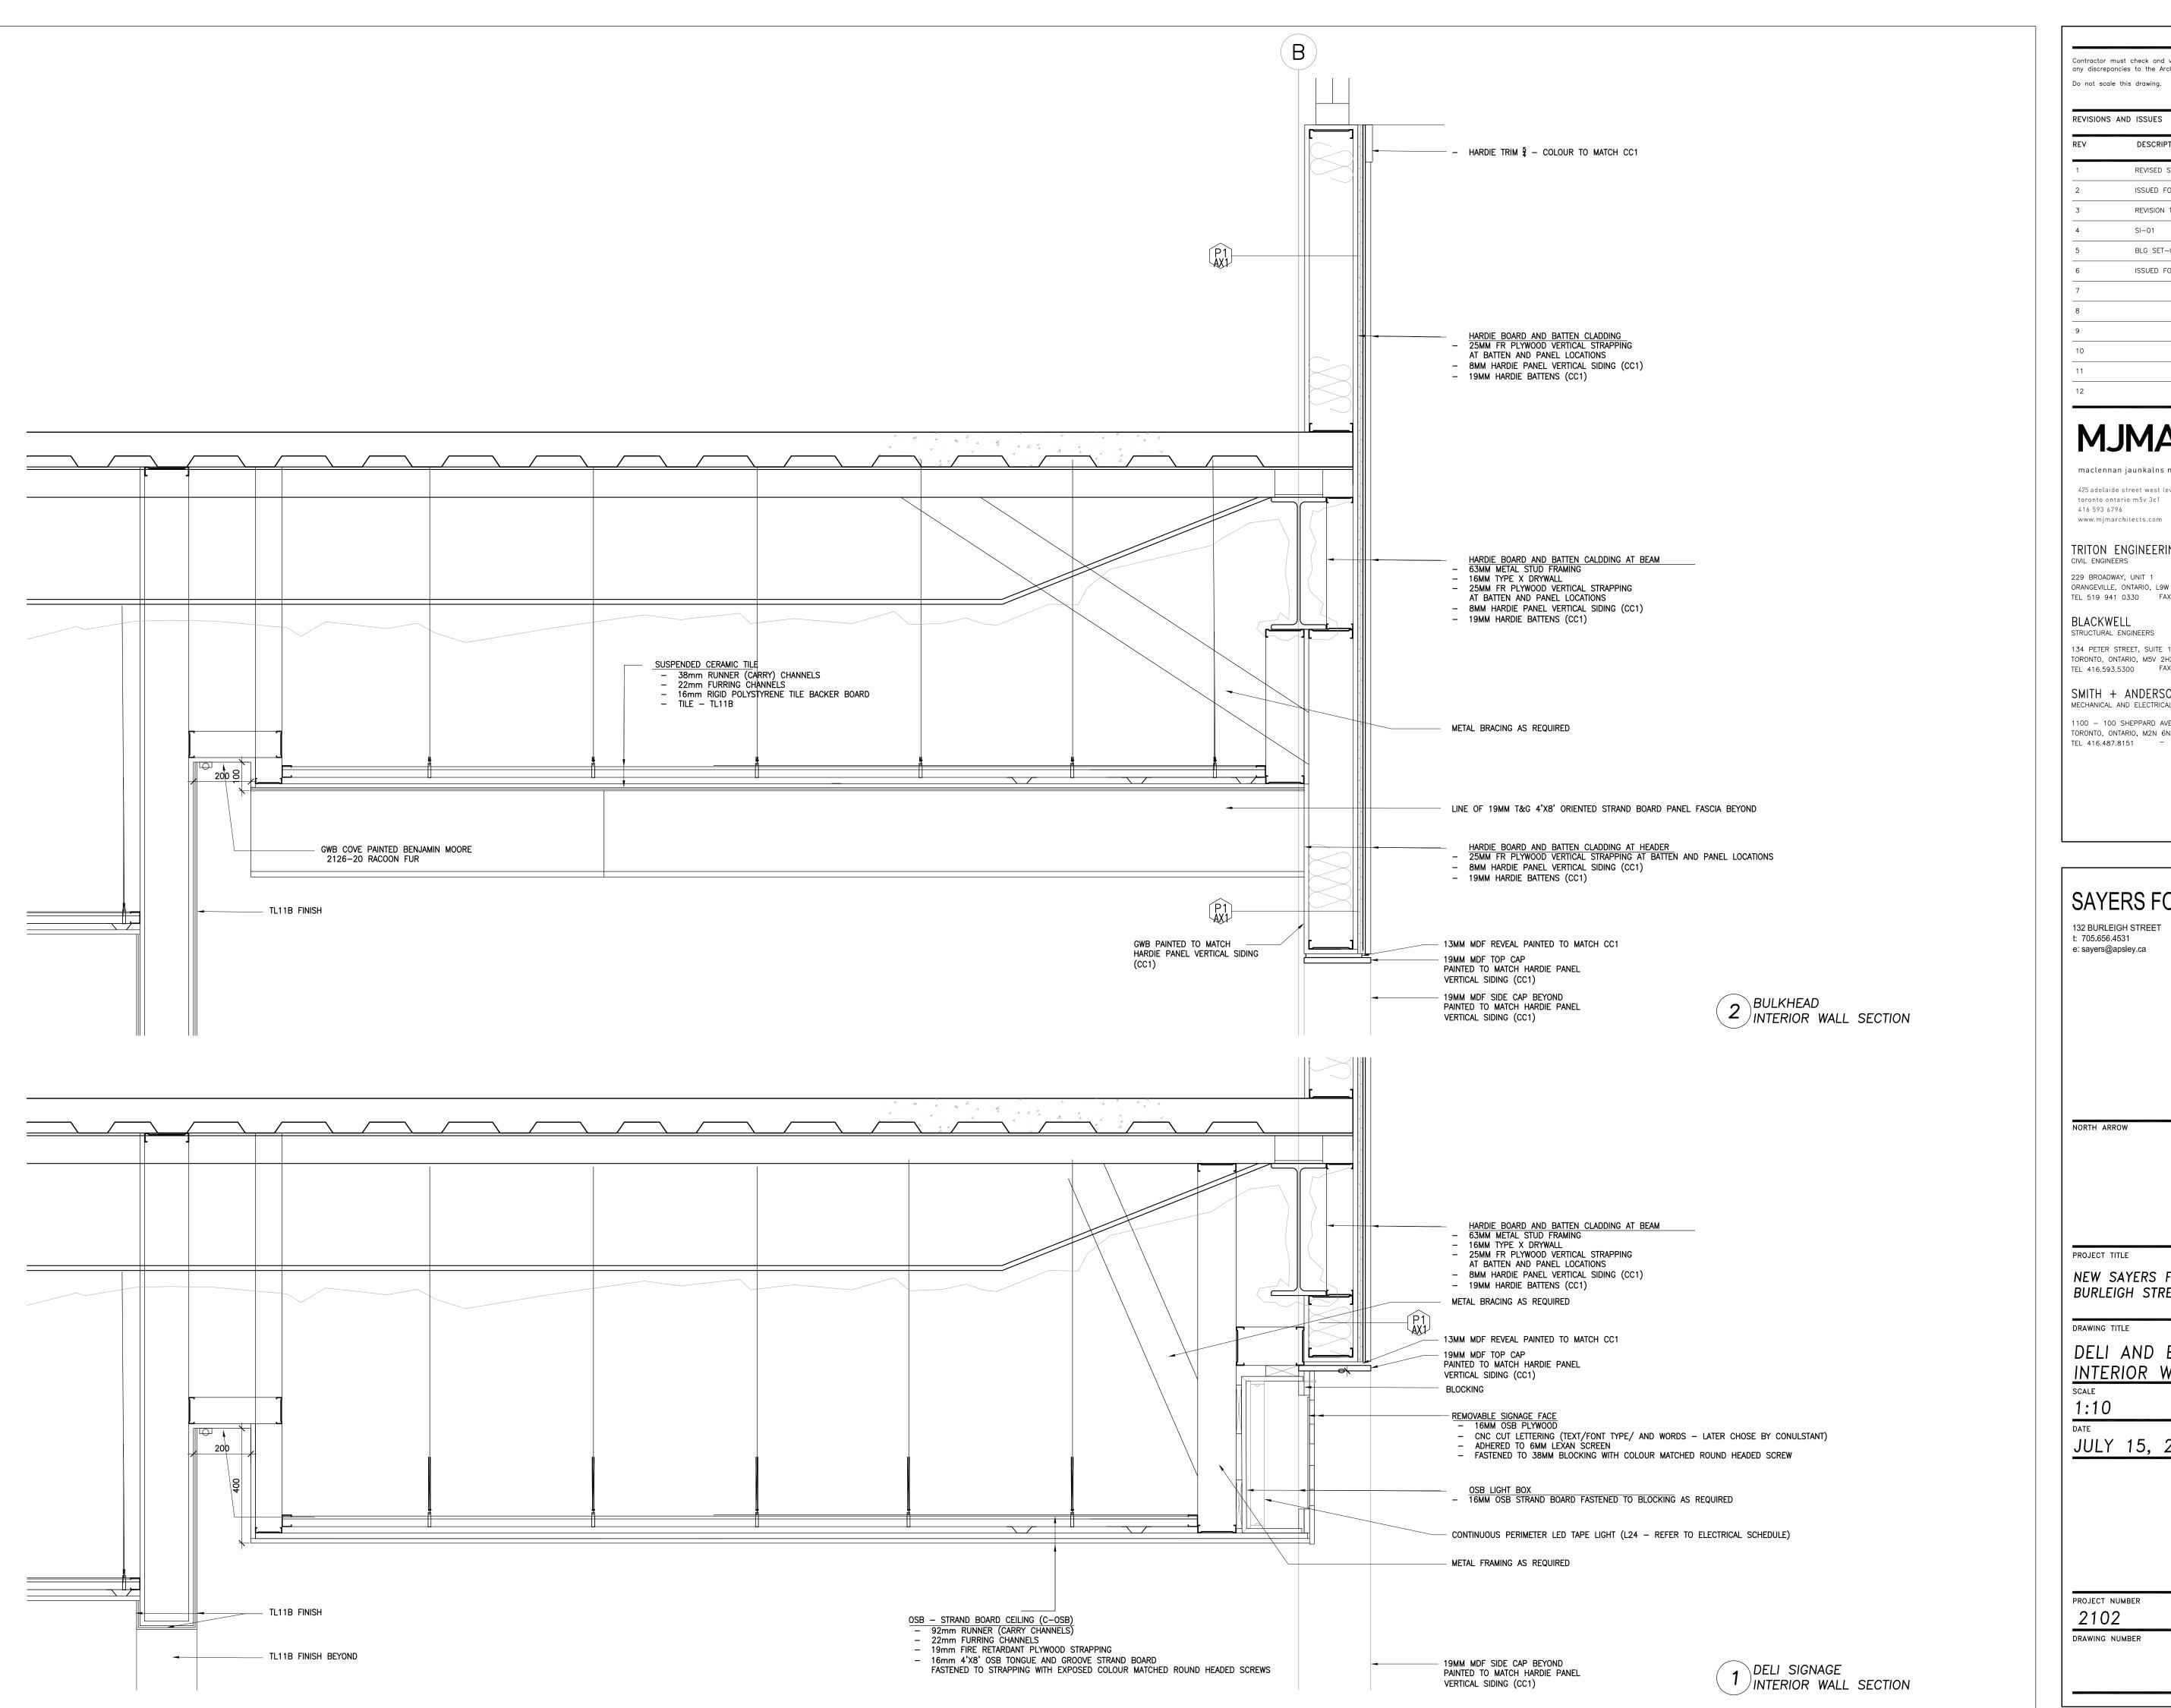

REVISIONS AND ISSUES

REV	DESCRIPTION	DATE	BY
1	REVISED SPA	210809	AB
2	ISSUED FOR TENDER	210824	AB
3	REVISION TO BUILDING PERMIT	220315	AB
4	SI-01	220615	AB
5	BLG SET-OUT CAD	220715	AB
6	ISSUED FOR CONSTRUCTION	220715	AB
7			
8			
9			

# **MJMA**

maclennan jaunkalns miller architects

425 adelaide street west level 6 toronto ontario m5v 3c1 416 593 6796

#### TRITON ENGINEERING SERVICES LTD

229 BROADWAY, UNIT 1 ORANGEVILLE, ONTARIO, L9W 1K4
TEL 519 941 0330 FAX 519 941 1830

134 PETER STREET, SUITE 1301 TORONTO, ONTARIO, M5V 2H2
TEL 416.593.5300 FAX 416.593.4840

SMITH + ANDERSON MECHANICAL AND ELECTRICAL ENGINEERS

1100 - 100 SHEPPARD AVENUE EAST TORONTO, ONTARIO, M2N 6N5

## SAYERS FOOD LIMITED

132 BURLEIGH STREET t: 705.656.4531 e: sayers@apsley.ca




NEW SAYERS FOOD STORE BURLEIGH STREET, APSLEY

DRAWING TITLE

DELI AND BAKERY INTERIOR WALL SECTIONS

JULY 15, 2022

PROJECT NUMBER

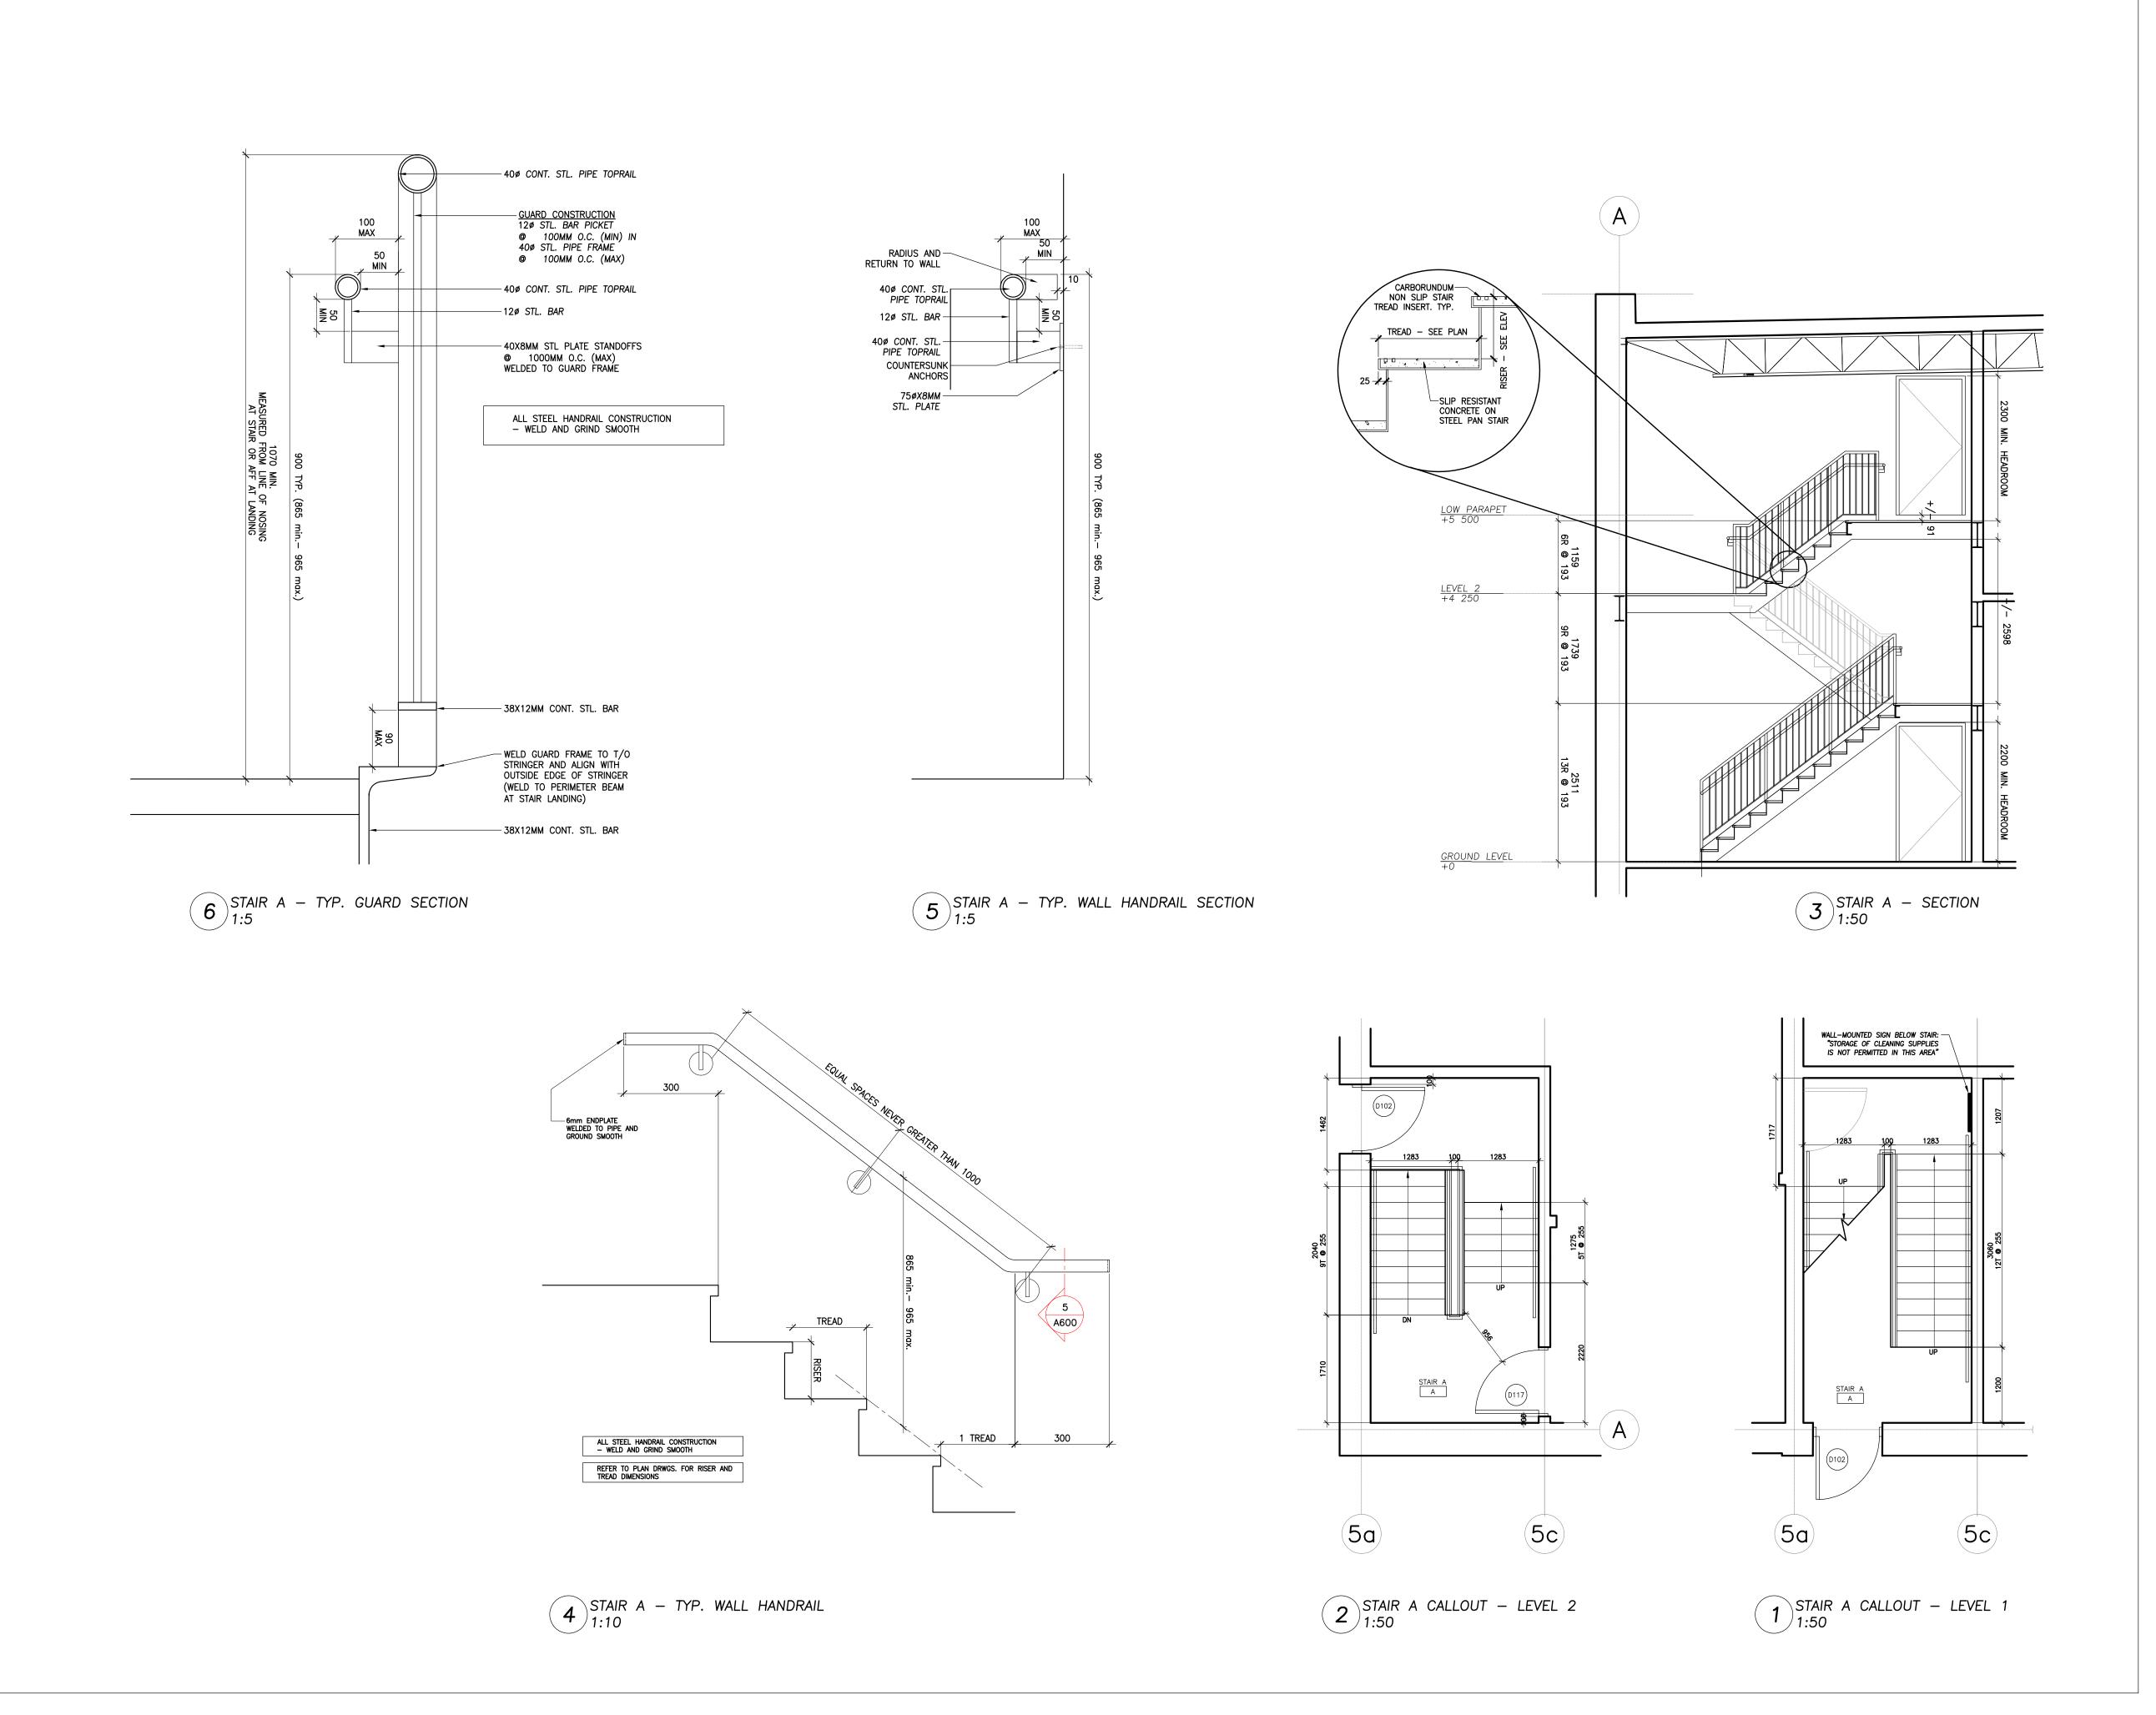

 REVISIONS AND ISSUES
 DESCRIPTION
 DATE
 BY

 1
 REVISED SPA
 210809
 AB

 2
 ISSUED FOR TENDER
 210824
 AB

 3
 REVISION TO BUILDING PERMIT
 220315
 AB

 4
 SI-01
 220615
 AB

 5
 BLG SET-OUT CAD
 220715
 AB

 6
 ISSUED FOR CONSTRUCTION
 220715
 AB

# **AMLM**

maclennan jaunkalns miller architects
425 adelaide street west level 6

425 adelaide street west leve toronto ontario m5v 3c1 416 593 6796 www.mjmarchitects.com

## TRITON ENGINEERING SERVICES LTD CIVIL ENGINEERS

229 BROADWAY, UNIT 1
ORANGEVILLE, ONTARIO, L9W 1K4
TEL 519 941 0330 FAX 519 941 1830

# BLACKWELL

STRUCTURAL ENGINEERS

134 PETER STREET, SUITE 1301
TORONTO, ONTARIO, M5V 2H2
TEL 416.593.5300 FAX 416.593.4840


#### SMITH + ANDERSON MECHANICAL AND ELECTRICAL ENGINEERS


1100 - 100 SHEPPARD AVENUE EAST TORONTO, ONTARIO, M2N 6N5

TEL 416.487.8151 -

## SAYERS FOOD LIMITED

132 BURLEIGH STREET t: 705.656.4531 e: sayers@apsley.ca

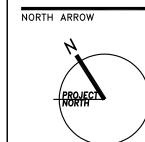

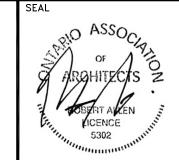

PROJECT TITLE

NEW SAYERS FOOD STORE BURLEIGH STREET, APSLEY

DRAWING TITLE

#### STAIR DRAWINGS

AS NOTED

JULY 15, 2022

PROJECT NUMBE

2102
DRAWING NUMBER

#### DO06 - LOADING DOCK LEVELER, SEAL, ACCESSORIES, DOOR

#### Loading Dock Specifications - Sayer's Grocery Store in Aspley, Ontario

<u>Item:</u> Model: Serco Hydraulic Dock Leveler

Serco Model HL830 Hydraulic Dock Leveler Featuring:

Nominal size 6' wide x 8' long

30,000 lbs. capacity per ANSI MH 14.1 1992

Pour in pan style dock leveler

20" long, high tensile steel lip plate 5/8" thick

Power in/Power out lip control Regenerative hydraulic system

4 ½" diameter main cylinder, 2 ½" diameter lip cylinder

Safety tread deck plate 1/4" thick Full range telescoping toe guards Hinged maintenance post Below dock control

Fall Safe

Grease fittings on hinge tube

Minimum lip crown set at 4" above dock

15 degree leading edge lip bevel

Clean frame subframe designed to minimize pit floor obstructions and

enhance pit clean-up operations VB42011F Laminated rubber bumpers per unit

10 year structural warranty, 5 year hydraulic warranty

Serco Dock Seal

Serco Model S-600 Fixed header dock seal Featuring:

Head pad 120" wide x 12" face x 12" projection

Side pad 108" long x 12" face x 12" backboard x 12" projection

Designed to suit door opening 8' wide x 9' high and dock height 48"

Base fabric: 40 oz.

40 oz. Wear pleats with 4" exposure

Full length 4" wide yellow guide stripe on vertical pads

One year warranty

<u>Item:</u> Featuring: Serco Loading Light 62" flexible arm extension

2" diameter LED light

Serco Wheel Chock <u>Item:</u> Featuring:

Heavy Duty molded rubber Chock

15' of galvanized chain Steel wall-mount bracket

Serco Overhead Door <u>Items:</u> Model:

Garaga G-5000 Door size 8'0" wide x 9'0" high Features:


Foam Injected

R-16 rating 3" track and hardware


Weatherseal package Continuous angle One window per door

Option: Electric operator c/w chain hoist

EX	(ERI	OR DOOR S	SCH	EDU	LE																
LEVEL	ROOM#	ROOM NAME	DOOR#	WIDTH	HEIGHT	DOOR TYPE	MAT'L	FIN.	GLZING	JAMB TYPE		RAME MAT'L	FIN.	INSUL	FIRE RAT'G	HINGE	LOCK	PANIC HARDWARE	CLOSER	STOP	REMARKS
1	101	EXIT VESTIBULE	D001	3188	2600	SED1	ALUM	-	TG	_	SEE S	CREEN	SCH'D	YES	NO	Y	Υ	Υ	-	-	AUTOMATIC SLIDING DOOR W/ BREAKOUT PANELS REFER TO ESCO2 ON A710 — SCREEN SCHEDULE
1	102	ENTRY VESTIBULE	D002	3188	2600	SED1	ALUM	_	TG	_	SEE S	SCREEN	SCH'D	YES	NO	Y	Υ	Y	-	_	AUTOMATIC SLIDING DOOR W/ BREAKOUT PANELS REFER TO ESCO2 ON A710 — SCREEN SCHEDULE
1	104	BAKERY DISPLAY	D003	2140	3000	D-03	WD	_	TG	_	_	_	_	_	NO	Y	Υ	Y	Υ	Υ	REFER TO WED1 IN OUTLINE SPEC.
1	А	STAIR A	D004	1000	2150	D-01	НМ	PT	_	_	F-01	НМІ	PT	YES	NO	Y	Υ	Y	Υ	Υ	-
1	121	SERVICE	D005	1220	2150	D-01	НМІ	PT	_	_	F-01	НМІ	PT	YES	NO	Y	Υ	Y	Υ	Υ	-
1	122	SERVICE - DOCK	D006	2440	2743	_	_	_	_	_	_	_	_	_	_	_	Υ	_	_	_	REFER TO DOO6 – LOADING DOCK LEVELER, SEAL, ACCESSORIES, DOOR SPECIFICATION AND DETAILS
2	202	STAFF LOUNGE	D101	1000	2350	D-01		PT	TG	_	SEE S	SCREEN	SCH'D	YES	NO	Y	Υ	_	Υ	_	REFER TO SCREEN SCHEDULE - THERMAPORTE 7700
2	А	STAIR A	D102	1000	2150	D-01	НМІ	PT	_	_	F-01	НМІ	PTD	YES	NO	Y	Υ	_	Υ	_	-
INT	ERIC	R DOOR S	СНЕ	EDUI	E		1	l													
1.57.51	D0014//	500W NAME	D00D#			DOOR				JAMB	Fi	RAME		Meri	FIRE		1 0 0 14	PANIC	01.0055	CTOD.	DEMOKO
LEVEL	ROOM#	ROOM NAME	DOOR#	WIDTH	HEIGHT	TYPE	MAT'L	FIN.	GLZING	TYPE	TYPE	MAT'L	FIN.	INSUL	RAT'G	HINGE	LOCK	HARDWARE	CLOSER	STOP	REMARKS
1	А	STAIR A	D011	1000	2150	D-01	НМ	PT	NO	_	F1	НМ	PT	NO	1HR	Υ	-	Υ	Υ	-	-
1	115	UNIVERSAL WC	D012	1000	2150	D-01	НМ	PT	NO	_	F1	НМ	PT	NO	NO	Y	Υ	-	Υ	_	INC. ADO (X2) SYSTEM
1	116	PRODUCE PREP/STOR.	D013	1220	2150	D-04	_	-	YES	_	_	_	1	_	_	-	_	_	-	_	INTERIOR TRAFFIC DOOR
1	119	MEAT PREP	D014	1220	2150	D-04	_	- 1	YES	_	_	_	-	_	_	-	_	_	-	_	INTERIOR TRAFFIC DOOR
1	121	SERVICE	D015	1600	2150	D-05	_	-	YES	_	_	_	_	_	_	-	_	_	-	_	INTERIOR TRAFFIC DOOR - NOTE 1625mm RO
1	121	SERVICE	D016	1830	2150	D-05	_	- 1	YES	_	_	_	_	-	_	-	_	-	-	_	INTERIOR TRAFFIC DOOR
1	113	WALKIN COOLER	D020	1220	2150	_	_	-	_	_	_	_	_	_	_	-	_	-	-	_	PROVIDED BY COOLER/FREEZER SUPPLIER
1	114	WALKIN FREEZER	D021	1220	2150	_	-	- 1	_	_	_	_	-	-	_	-	-	_	-	-	PROVIDED BY COOLER/FREEZER SUPPLIER
1	117	WALKIN PRODUCE	D022	1524	2150	_	-	- 1	_	_	_	-	_	_	_	-	-	_	-	-	PROVIDED BY COOLER/FREEZER SUPPLIER
1	118	MEAT COOLER	D023	1524	2150	_	_	- 1	_	_	_	_	_	_	_	-	_	_	_	_	PROVIDED BY COOLER/FREEZER SUPPLIER
1	120	FREEZER	D024	1524	2150	_	_	- 1	_	_	_	_	_	_	_	_	_	_	_	_	PROVIDED BY COOLER/FREEZER SUPPLIER
1	122	WALKIN DAIRY	D025	1524	2150	_	_	- 1	_	_	_	_	-	_	_	_	_	_	_	_	PROVIDED BY COOLER/FREEZER SUPPLIER
1	123	WC	D026	1000	2150	D-01	НМ	PT	NO	_	F1	НМ	PT	NO	NO	Υ	Υ	_	Υ	_	-
2	208	ELEC	D110	1000	2150	D-01	НМ	PT	NO	_	F1	НМ	PT	_	1HR	Υ	Υ	-	Υ	_	-
2	206	STORAGE	D111	1000	2150	D-01	НМ	PT	NO	_	F1	НМ	PT	_	_	Y	Υ	_	Y	_	-
2	204	PRIVATE OFFICE	D112	1000	2150	D-01	НМ	PT	NO	_	F1	НМ	PT	_	_	Υ	Υ	_	Υ	_	-
2	205	SHOWER/WC	D113	1000	2150	D-01	НМ	PT	NO	_	F1	НМ	PT	_	_	Y	Υ	_	Υ	_	-
2	207	STORAGE	D114	2000	2150	D-02	НМ	PT	NO	_	F2	НМ	PT	-	_	Y	Υ	_	Y	Υ	-
2	201	CORRIDOR	D115	900	2150	D-02	НМ	PT	NO	_	F2	НМ	PT	-	-	Y	Υ	-	Y	_	-
2	203	OPEN OFFICE	D116	1000	2150	D-01	НМ	PT	NO	_	F1	НМ	PT	_	_	Y	Y	_	Υ	Υ	-
2	А	STAIR A	D117	1000	2150	D-01	НМ	PT	NO	_	F1	НМ	PT	_	1HR	Y	Y	_	Y	_	-
DOOR LE ALUM ANOD CL HM INSUL	ALUMIN ANODIZ CLEAR HOLLOV INSULA	ZED TO FINISH WI N METAL SI	T G D ST	WOOD VI SOLID P STAINLES	D GLASS ENEER HENOLIC SS STEEL		HARDV AR CH S/W H/W FB	Ci Si Hi	DAMS RI ONTINUO TANDARD EAVY WE	TE US HING WEIGHT IGHT BU DLT (INAC	BUTT H	Ε	CL DL ML PP RIM SVR	MC MC PU RIN	ORTISE L ORTISE L ISH/PUL M EXIT	LL DEVICE	K	DEVICE WITH	H EXTERIO	OR TRIM	***REFER TO A700 FOR ALUMINUM SCREENS AND GLAZING CVR CONCEALED VERTICAL ROD EXIT DEVICE CONC CONCEALED DOOR CLOSER REGU SURFACE DOOR CLOSER COHS CONCEALED OVERHEAD STOP SOHS SURFACE OVERHEAD STOP

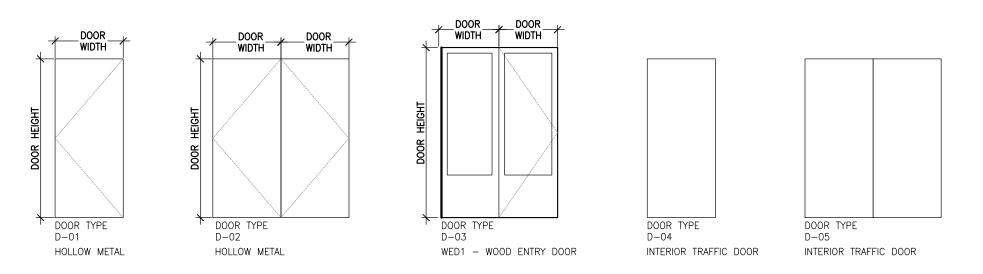

01 DOOR TYPE (N.T.S)

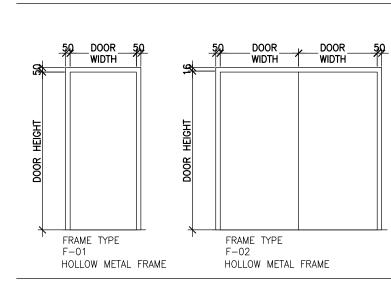

02 FRAME TYPES (N.T.S)

Contractor must check and verify all dimensions on the job, and report any discrepancies to the Architect before proceeding with the work.

210809

210824

220615

220715

220715

Do not scale this drawing.

REVISIONS AND ISSUES

MJMA

425 adelaide street west level 6 toronto ontario m5v 3c1

416 593 6796 www.mjmarchitects.com

229 BROADWAY, UNIT 1

134 PETER STREET, SUITE 1301

SMITH + ANDERSON

TEL 416.487.8151

BLACKWELL

maclennan jaunkalns miller architects

TRITON ENGINEERING SERVICES LTD

ORANGEVILLE, ONTARIO, L9W 1K4
TEL 519 941 0330 FAX 519 941 1830

TORONTO, ONTARIO, M5V 2H2
TEL 416.593.5300 FAX 416.593.4840

MECHANICAL AND ELECTRICAL ENGINEERS

1100 - 100 SHEPPARD AVENUE EAST TORONTO, ONTARIO, M2N 6N5

DESCRIPTION

REVISED SPA

ISSUED FOR TENDER

BLG SET-OUT CAD

ISSUED FOR CONSTRUCTION

REVISION TO BUILDING PERMIT 220315

SAYERS FOOD LIMITED 132 BURLEIGH STREET t: 705.656.4531

e: sayers@apsley.ca

NORTH ARROW



NEW SAYERS FOOD STORE BURLEIGH STREET, APSLEY

DRAWING TITLE


DOOR SCHEDULE AND DETAILS

NTS

JULY 15, 2022

PROJECT NUMBER 2102

DRAWING NUMBER

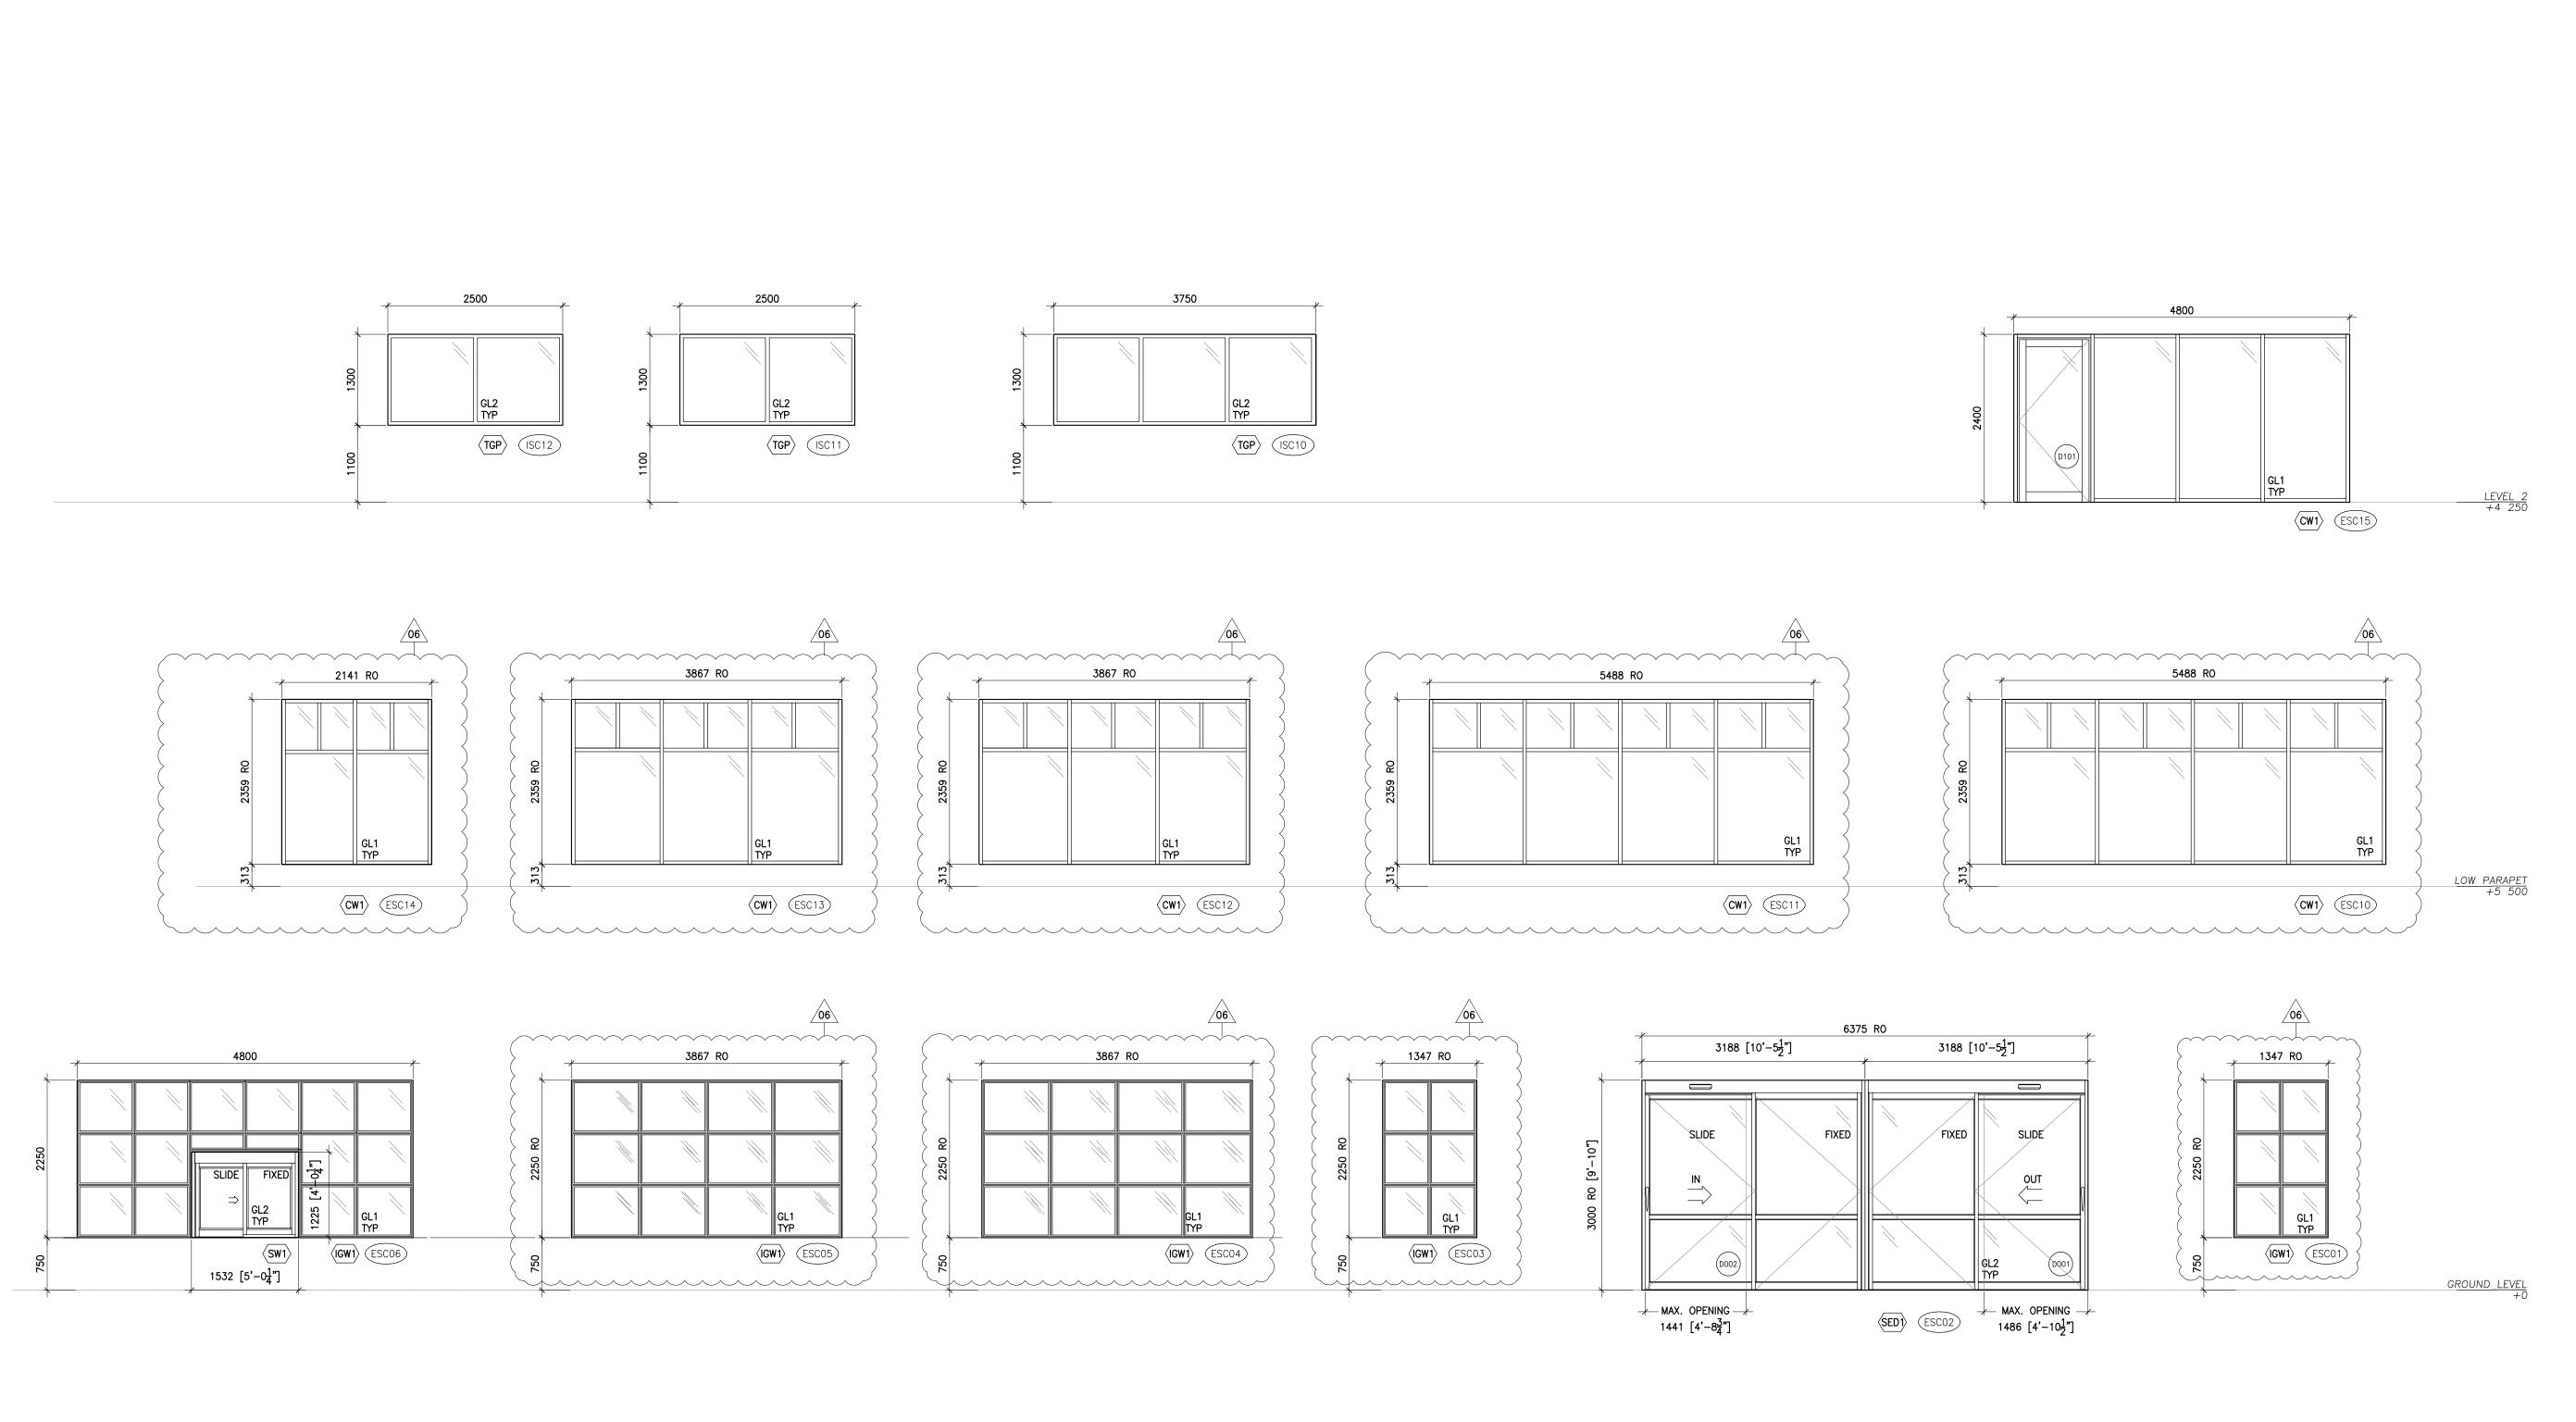

		GLAZI	NG SCHEDULE				
	LITE TYPE A	ND THICKNESS	LOW E COATIN	G	CERAMIC	COATING	GLAZING NOTE
GLASS TYPE	OUTER	INNER	TYPE	SURFACE	Esc-Frit TYPE	Esc-Frit SURFACE	
GL1	FT 6mm	FT 6mm	DOUBLE SILVER	<b>#</b> 2			TYPICAL EXTERIOR IGU, ARGON—FILLED, DESSICANT—FILLED WARM—EDGE SPACER BAR.
GL2	FIRE—RATED CERAMIC GALZING	-	-	-			SEE OUTLINE SPEC

FRAME TYPE IGW1 INTERIOR GLAZED WINDOW ALUMICOR SHADOWLINE 970 — THERMALLY BROKEN 19mmx133mm PREPAINTED ALUM. SECTIONS GLASS: GL1 COLOUR: CUSTOM (TBD)

CW1 CURTAIN WALL ALUMICOR THERMAWAIL TW2200 — THERMALLY BROKEN 50.8mmx101.8mm PREPAINTED ALUM. BACK SECTIONS PERIMETER MULLIONS AT TOP AND BOTTOM: 19mm CAPPED PERIMETER MULLIONS AT JAMBS: 19mm CAPPED INTERMEDIATE VERTICAL MULLIONS: 19mm CAPPED GLASS: GL1 COLOUR: CUSTOM (TBD)

SED1 AUTOMATIC SLIDING ENTRANCE DOORS HORTON AUTOMATICS — PROSLIDE SERIES 2021
SLIDING DOOR SYSTEM WITH ELECTRIC BELT DRIVE OPERATOR
DOOR TYPE: 310 — SX & SO
OPTEXT I—ONEXT MOTION/PRESENCE DETECTORS AND
M/S MANUAL LOCKING
PREPAINTED COLOUR = CUSTOM (TBD)

SW1 SLIDING SERVICE WINDOW HORTON AUTOMATICS - SERIES 8900
DOOR TYPE = X-0
HEADER = 64mm LOW-PROFILE
OPERATOR = RECESSED MANUAL PULL
LOCK = THUMB LOCK
PREPAINTED COLOUR = CUSTOM (TBD)

TGP FIRE RATED GLASS AND FRAMING FIRE-RATED METAL FRAME AND GLAZING (45MIN. WALL FFR)

GLAZING SCHEDULE LEGEND GLASS TYPE: LOW'E' COATING: FT FULLY TEMPERED DS DOUBLE SILVER

**GLAZING NOTES:** 

**CURTAINWALL NOTES:** PROVIDE REINFORCING IN ALUM SECTION AS NECESSARY TO MAINTAIN SECTIONS AS SHOWN. REFER TO PROJECT MANUAL.
 SEE PROJECT MANUAL AND DOOR SCHEDULE FOR GLAZED ALUM DOORS.
 DIMENSIONS INDICATED ARE NOMINAL. ALL DIMENSIONS TO BE SITE VERIFIED.
 ALL FRAMES TO RECEIVE DURANAR XL PTD FINISH UNLESS OTHERWISE NOTED. Contractor must check and verify all dimensions on the job, and report any discrepancies to the Architect before proceeding with the work. Do not scale this drawing.

REVISIONS AND ISSUES DESCRIPTION DATE REVISED SPA 210809 ISSUED FOR TENDER 210824 REVISION TO BUILDING PERMIT 220315 SI-01 220615 BLG SET-OUT CAD 220715 ISSUED FOR CONSTRUCTION 220715

# **MJMA**

maclennan jaunkalns miller architects

425 adelaide street west level 6 toronto ontario m5v 3c1 416 593 6796 www.mjmarchitects.com

#### TRITON ENGINEERING SERVICES LTD

CIVIL ENGINEERS 229 BROADWAY, UNIT 1 ORANGEVILLE, ONTARIO, L9W 1K4
TEL 519 941 0330 FAX 519 941 1830

BLACKWELL STRUCTURAL ENGINEERS

134 PETER STREET, SUITE 1301 TORONTO, ONTARIO, M5V 2H2
TEL 416.593.5300 FAX 416.593.4840


SMITH + ANDERSON MECHANICAL AND ELECTRICAL ENGINEERS

1100 - 100 SHEPPARD AVENUE EAST TORONTO, ONTARIO, M2N 6N5 TEL 416.487.8151 -

# SAYERS FOOD LIMITED

132 BURLEIGH STREET t: 705.656.4531 e: sayers@apsley.ca

NORTH ARROW

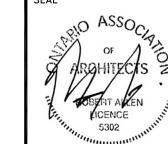

NEW SAYERS FOOD STORE BURLEIGH STREET, APSLEY

DRAWING TITLE

EXTERIOR & INTERIOR SCREEN SCHEDULES


SCALE 1:50

DATE

JULY 15, 2022

PROJECT NUMBER

DRAWING NUMBER

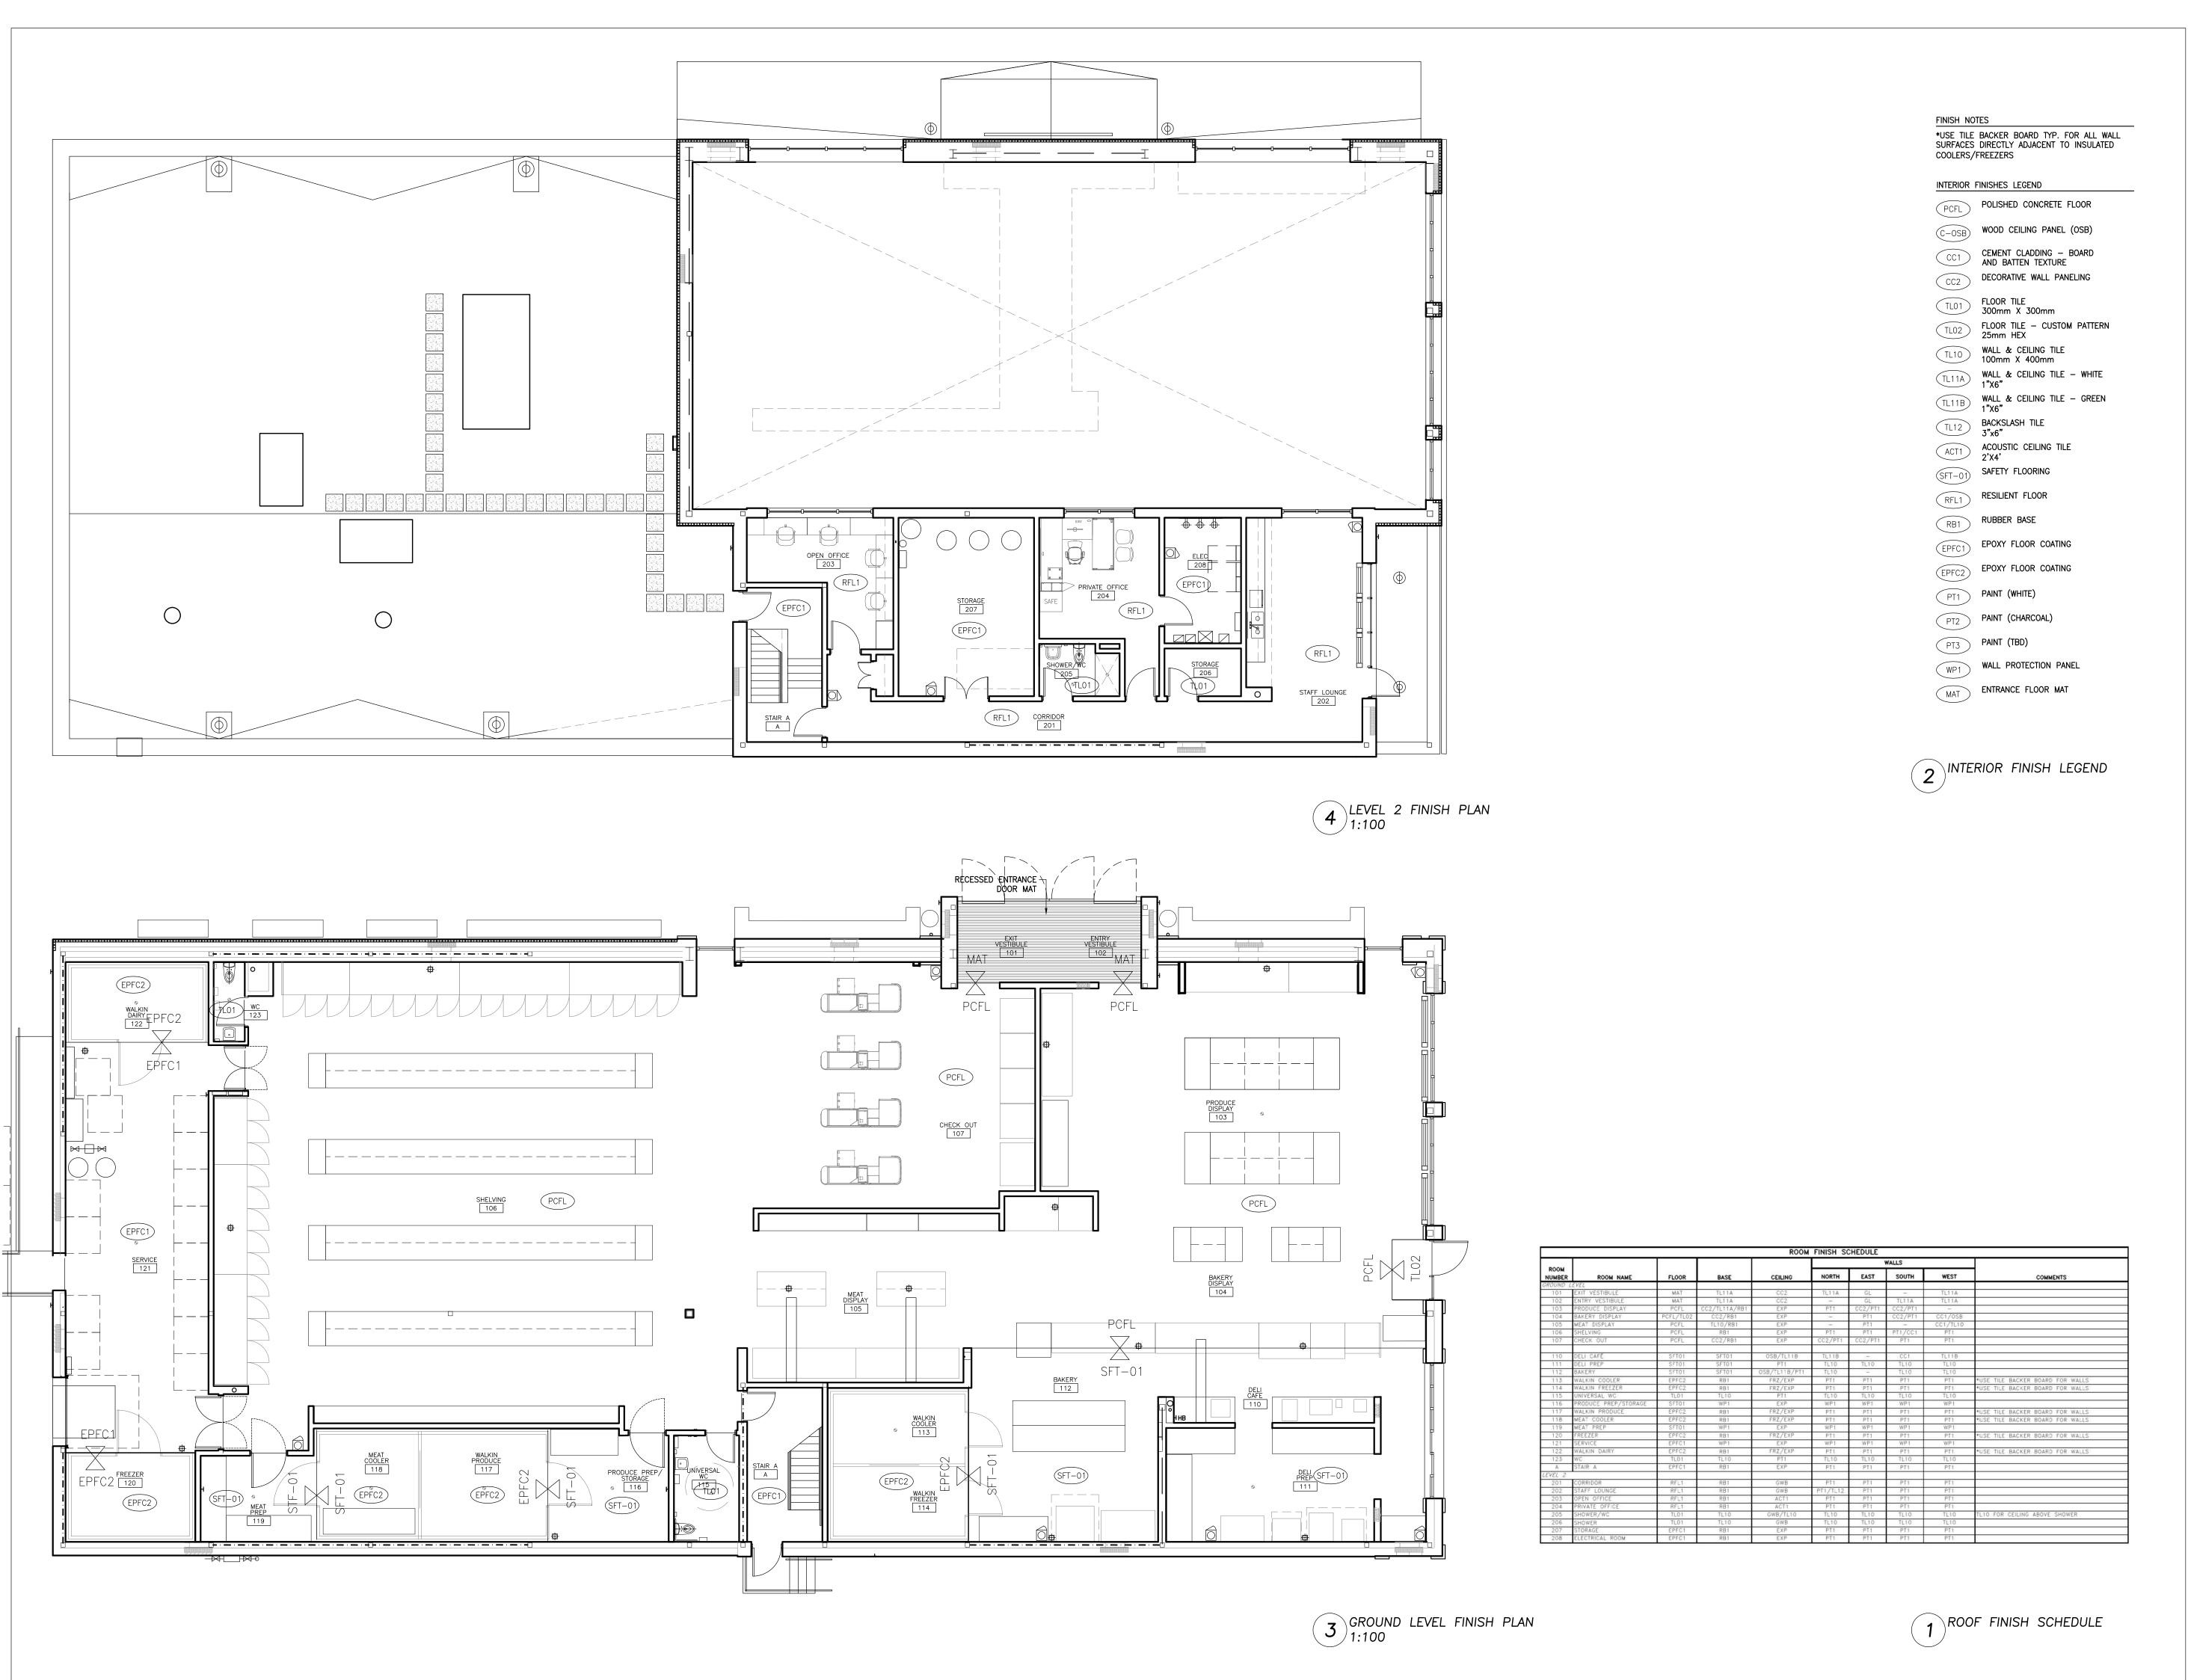

REVISIONS AND ISSUES DESCRIPTION DATE REVISED SPA 210809 ISSUED FOR TENDER 210824 REVISION TO BUILDING PERMIT 220315 220615 SI-01

220715

220715

ISSUED FOR CONSTRUCTION

BLG SET-OUT CAD

**MJMA** 

maclennan jaunkalns miller architects

425 adelaide street west level 6 toronto ontario m5v 3c1 416 593 6796 www.mjmarchitects.com

TRITON ENGINEERING SERVICES LTD CIVIL ENGINEERS

229 BROADWAY, UNIT 1 ORANGEVILLE, ONTARIO, L9W 1K4
TEL 519 941 0330 FAX 519 941 1830

BLACKWELL

STRUCTURAL ENGINEERS 134 PETER STREET, SUITE 1301 TORONTO, ONTARIO, M5V 2H2
TEL 416.593.5300 FAX 416.593.4840


SMITH + ANDERSON

MECHANICAL AND ELECTRICAL ENGINEERS 1100 - 100 SHEPPARD AVENUE EAST TORONTO, ONTARIO, M2N 6N5

TEL 416.487.8151 -

## SAYERS FOOD LIMITED

132 BURLEIGH STREET t: 705.656.4531 e: sayers@apsley.ca

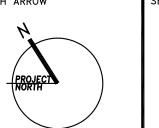

NEW SAYERS FOOD STORE BURLEIGH STREET, APSLEY


FINISH FLOOR PLANS AND SCHEDULE


1:100


JULY 15, 2022

PROJECT NUMBER

2102 DRAWING NUMBER

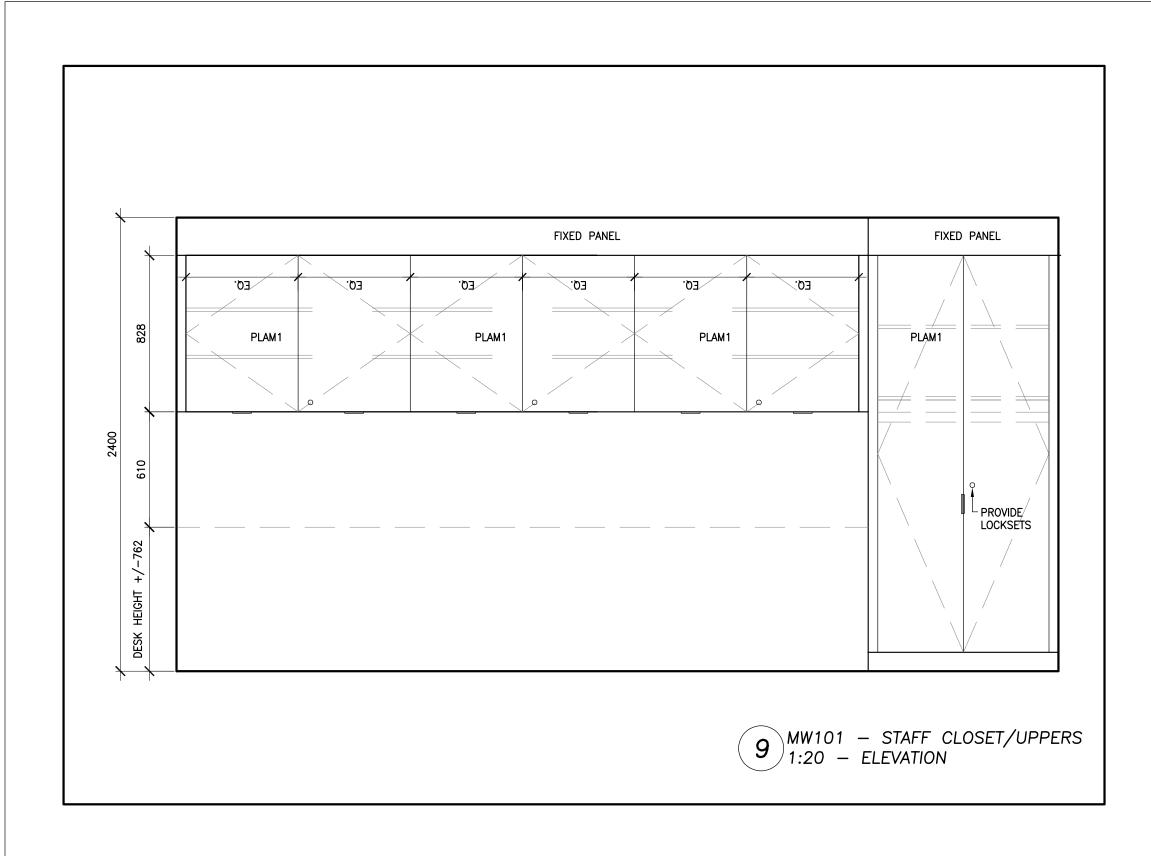

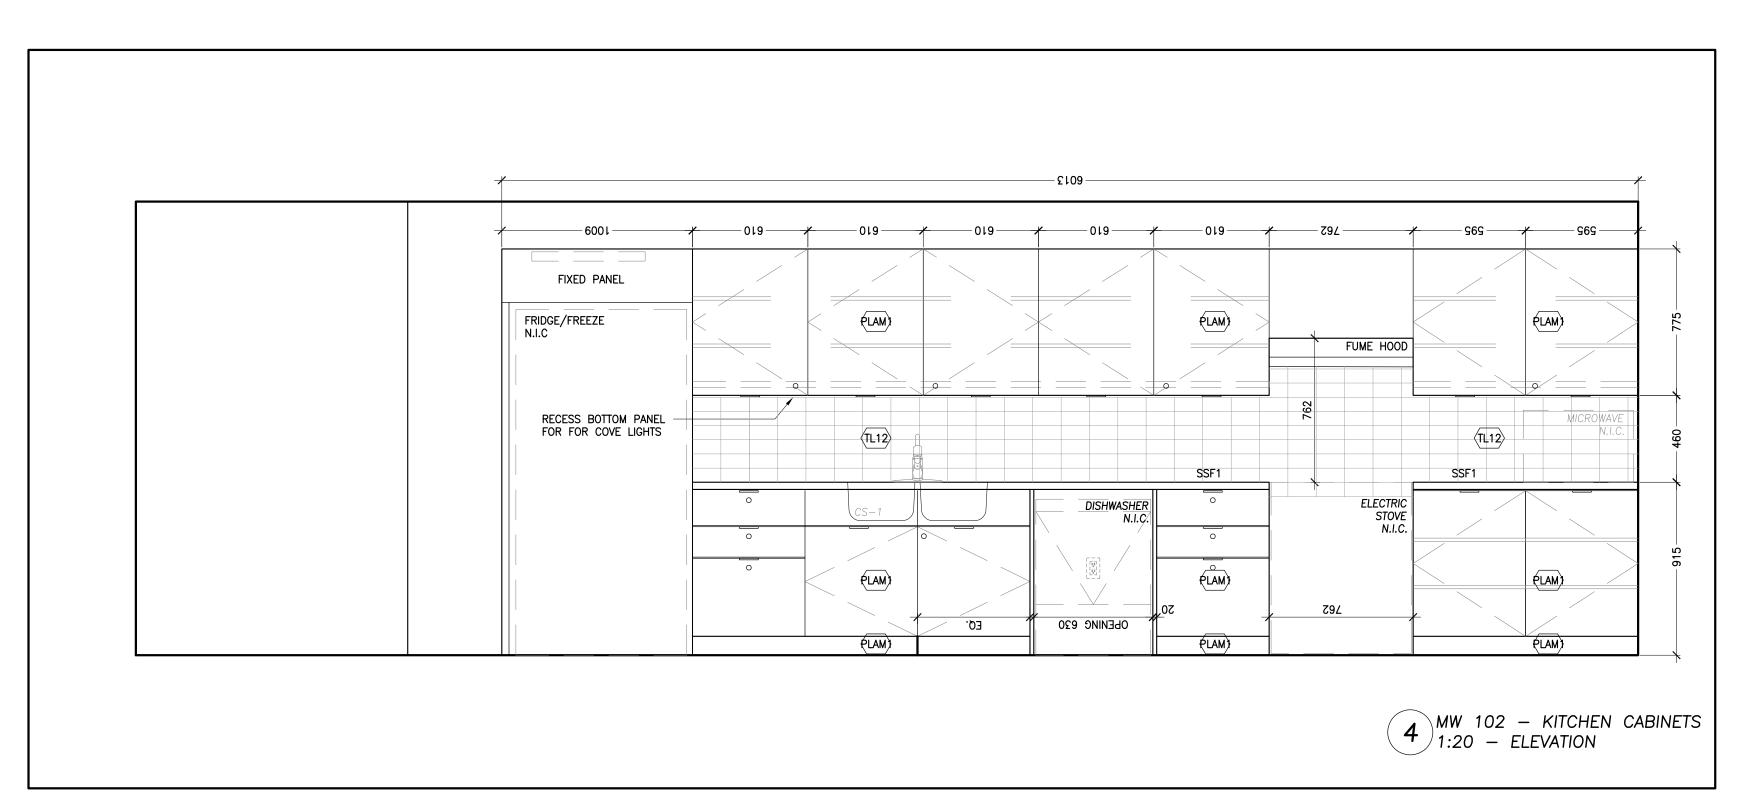

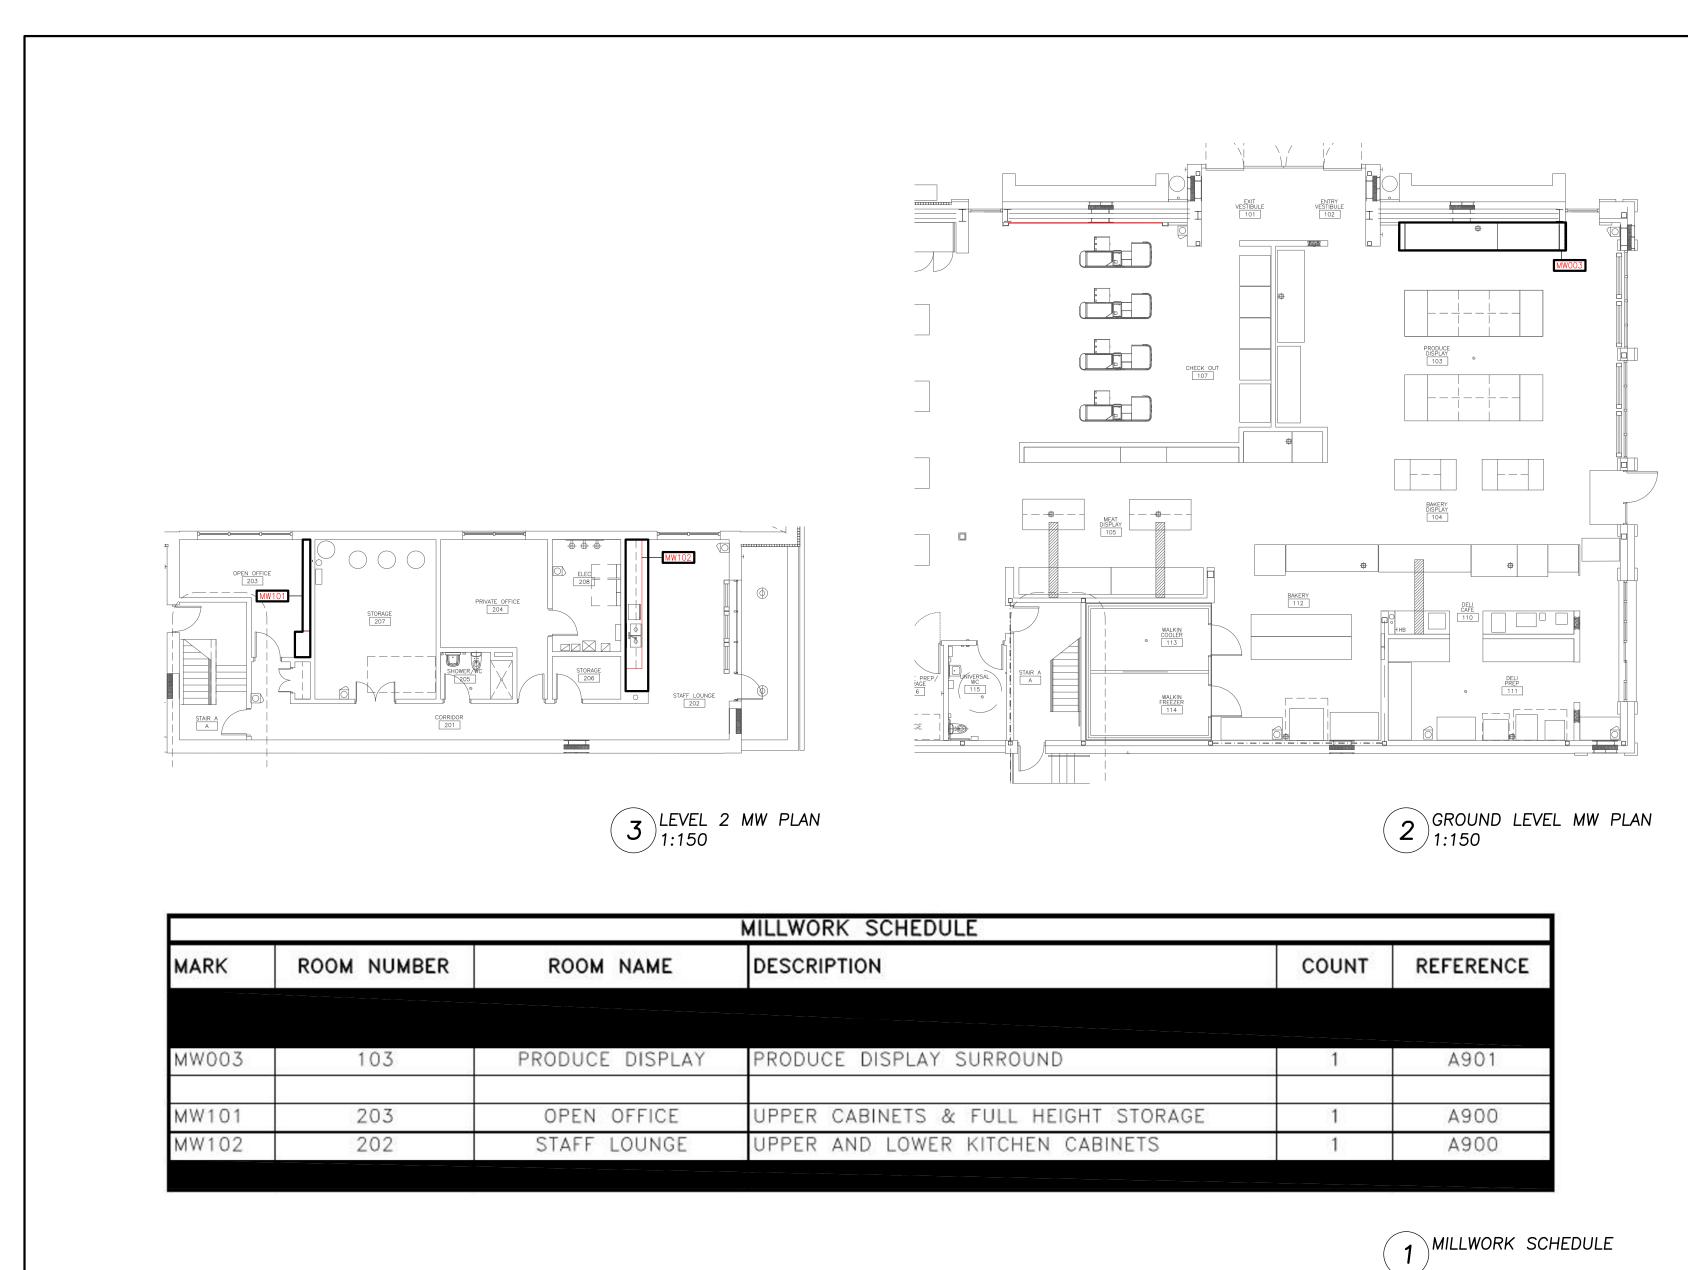

 REV
 DESCRIPTION
 DATE

 1
 REVISED SPA
 210809

 2
 ISSUED FOR TENDER
 210824

 3
 REVISION TO BUILDING PERMIT
 220315

 4
 SI-01
 220615

 5
 BLG SET-OUT CAD
 220715

 6
 ISSUED FOR CONSTRUCTION
 220715

 7
 8

11 12

416 593 6796 www.mjmarchitects.com

**MJMA** 

maclennan jaunkalns miller architects

425 adelaide street west level 6
toronto ontario m5v 3c1

TRITON ENGINEERING SERVICES LTD

CIVIL ENGINEERS

229 BROADWAY, UNIT 1

ORANGEVILLE, ONTARIO, L9W 1K4

TEL 519 941 0330 FAX 519 941 1830

BLACKWELL STRUCTURAL ENGINEERS

134 PETER STREET, SUITE 1301 TORONTO, ONTARIO, M5V 2H2 TEL 416.593.5300 FAX 416.593.4840

TORONTO, ONTARIO, M2N 6N5
TEL 416.487.8151 -


SMITH + ANDERSON
MECHANICAL AND ELECTRICAL ENGINEERS

1100 - 100 SHEPPARD AVENUE EAST

SAYERS FOOD LIMITED

132 BURLEIGH STREET t: 705.656.4531 e: sayers@apsley.ca

NORTH ARROW

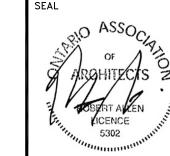

PROJECT TITL

NEW SAYERS FOOD STORE BURLEIGH STREET, APSLEY

DRAWING TITLE


MILLWORK DRAWINGS

AS NOTED

JULY 15, 2022

PROJECT NUMBER

DRAWING NUMBER

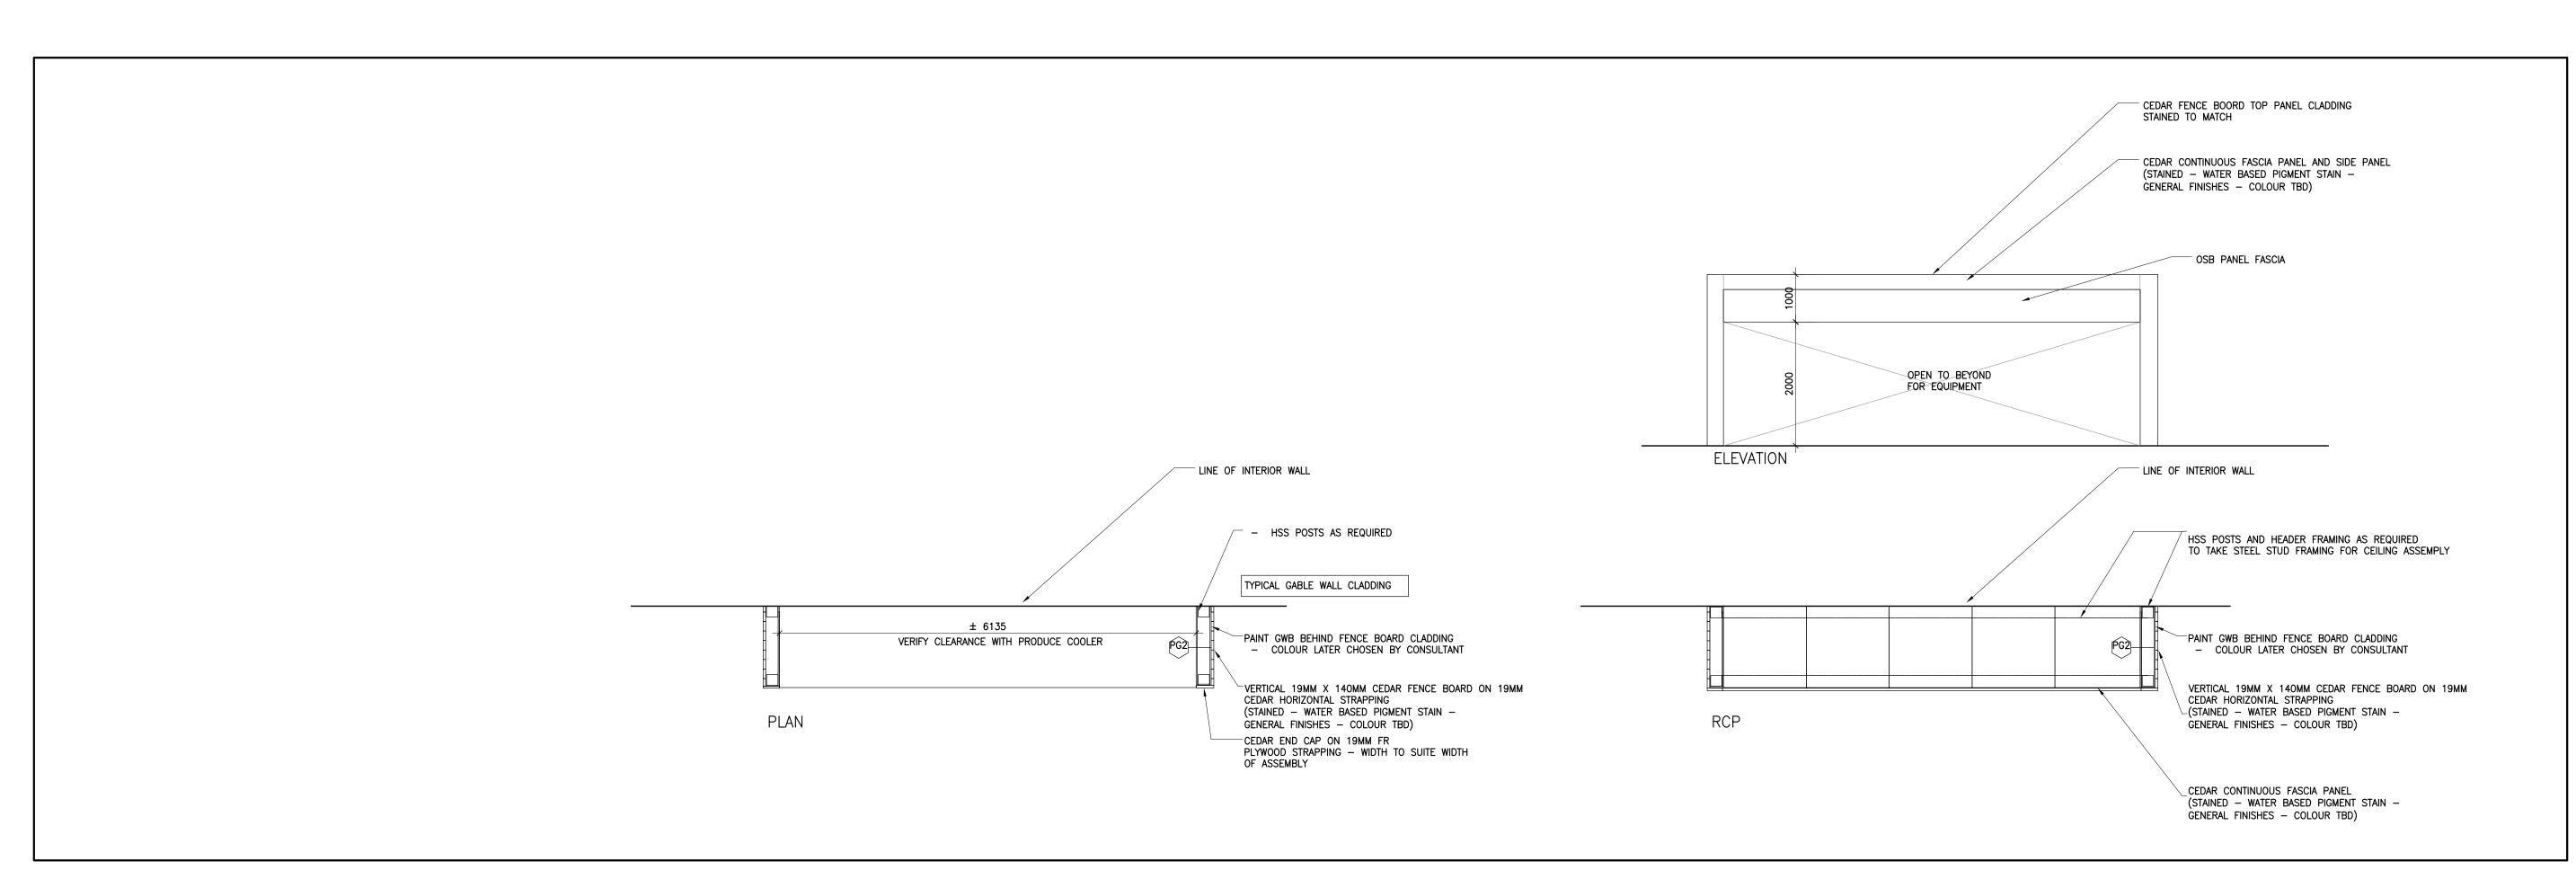

2 MW 003 - PRODUCE COOLER KIOSK 1:50 Contractor must check and verify all dimensions on the job, and report any discrepancies to the Architect before proceeding with the work.

Do not scale this drawing.

REV	DESCRIPTION	DATE	ВҮ
INL V	DESCRIPTION	DATE	D1
1	REVISED SPA	210809	AB
2	ISSUED FOR TENDER	210824	AB
3	REVISION TO BUILDING PERMIT	220315	AB
4	SI-01	220615	AB
5	BLG SET-OUT CAD	220715	AB
6	ISSUED FOR CONSTRUCTION	220715	AB
7			

# MJMA

maclennan jaunkalns miller architects

425 adelaide street west level 6 toronto ontario m5v 3c1 416 593 6796 www.mjmarchitects.com

#### TRITON ENGINEERING SERVICES LTD CIVIL ENGINEERS

229 BROADWAY, UNIT 1
ORANGEVILLE, ONTARIO, L9W 1K4
TEL 519 941 0330 FAX 519 941 1830

BLACKWELL STRUCTURAL ENGINEERS

134 PETER STREET, SUITE 1301 TORONTO, ONTARIO, M5V 2H2 TEL 416.593.5300 FAX 416.593.4840


SMITH + ANDERSON MECHANICAL AND ELECTRICAL ENGINEERS

1100 - 100 SHEPPARD AVENUE EAST TORONTO, ONTARIO, M2N 6N5 TEL 416.487.8151 -

# SAYERS FOOD LIMITED

132 BURLEIGH STREET t: 705.656.4531 e: sayers@apsley.ca

NORTH ARROW

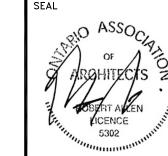

PROJECT TITL

NEW SAYERS FOOD STORE BURLEIGH STREET, APSLEY

DRAWING TITLE

MILLWORK DRAWINGS

AS NOTED


JULY 15, 2022

PROJECT NUMBER 2102

DRAWING NUMBER

ΛΩΛ



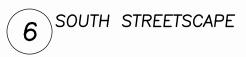













1 PRODUCE DISPLAY

Contractor must check and verify all dimensions on the job, and report any discrepancies to the Architect before proceeding with the work.

Do not scale this drawing.

REV	DESCRIPTION	DATE	
1	REVISED SPA	210809	
2	ISSUED FOR TENDER	210824	
3	REVISION TO BUILDING PERMIT	220315	
4	SI-01	220615	
5	BLG SET-OUT CAD	220715	
6	ISSUED FOR CONSTRUCTION	220715	
7			
8			
9			
10			
11			

# AMLM

maclennan jaunkalns miller architects

425 adelaide street west level 6 toronto ontario m5v 3c1 416 593 6796 www.mjmarchitects.com

# TRITON ENGINEERING SERVICES LTD CIVIL ENGINEERS

229 BROADWAY, UNIT 1
ORANGEVILLE, ONTARIO, L9W 1K4
TEL 519 941 0330 FAX 519 941 1830

## BLACKWELL

STRUCTURAL ENGINEERS

134 PETER STREET, SUITE 1301
TORONTO, ONTARIO, M5V 2H2
TEL 416.593.5300 FAX 416.593.4840

### SMITH + ANDERSON MECHANICAL AND ELECTRICAL ENGINEERS

1100 - 100 SHEPPARD AVENUE EAST TORONTO, ONTARIO, M2N 6N5 TEL 416.487.8151 -

## SAYERS FOOD LIMITED

132 BURLEIGH STREET t: 705.656.4531 e: sayers@apsley.ca

NORTH ARROW



#### PROJECT TITL

NEW SAYERS FOOD STORE BURLEIGH STREET, APSLEY

DRAWING TITLE

#### <u>RENDERINGS</u>

AS NOTED

JULY 15, 2022

PROJECT NUMBER 2102

Z I U Z

DRAWING NUMBER