SYMBOL	DESCRIPTION	SYMBOL	DESCRIPTION
\bowtie	GATE OR ISOLATION VALVE (REFER TO SPECIFICATION)	_=_	PIPE GUIDE
	GLOBE VALVE		PIPE SLEEVE
ιΦι	BALL VALVE		ANCHOR
\boxtimes	LOCKSHIELD VALVE		STRAINER
FBV	FLOW BALANCING VALVE	——————————————————————————————————————	UNION
PIFBV	PRESSURE INDEPENDENT FLOW BALANCING VALVE	——————————————————————————————————————	FLANGE FITTING
\Diamond	PLUG VALVE		ECCENTRIC FITTING
PRV	PRESSURE REDUCING VALVE		CONCENTRIC FITTING
\overrightarrow{Z}	CHECK VALVE	$ \bowtie$ - \bowtie -	PRESSURE GAUGE
	SOLENOID VALVE	T T	THERMOMETER
A h SRV	SAFETY RELIEF VALVE	├ Ф⊘	PRESSURE GAUGE COCK ASSEMBLY
FMS	FLOW METERING STATION	TW ————————————————————————————————————	THERMOMETER WELL
BP	BACKFLOW PREVENTOR	EJ	EXPANSION JOINT
×	ANGLE VALVE		MANUAL AIR VENT
100	BUTTERFLY VALVE	Av	AUTOMATIC AIR VENT
<u>√</u> <u>₹</u>	2-WAY BUTTERFLY VALVE	——————————————————————————————————————	AIR SEPARATOR
- 	TEMPEDED MINING VALVE	——————————————————————————————————————	SIGHT GLASS
	TEMPERED MIXING VALVE	-55	PUMP
M	FLEXIBLE JOINT	-M-K-M-	P.R.V. C/W SHUT-OFF VALVE
VB	VACUUM BREAKER		
BWV	BACK WATER VALVE	₩HA	WATER HAMMER ARRESTOR

7 VALVES AND APPURTENANCES

SYMBOL	DESCRIPTION	SYMBOL	DESCRIPTION	
—— F ——	FIRE LINE	•	PENDANT SPRINKLER HEAD	
FS	FLOW SWITCH	● ^{DP}	DRY PENDANT SPRINKLER HEAD	
S.V.	SUPERVISED VALVE	0	UPRIGHT SPRINKLER HEAD	
F.V.	FIRE VALVE	•	CONCEALED SPRINKLER HEAD	
F.S.P.	FIRE STANDPIPE	O ^{NF}	NON-FREEZE SPRINKLER HEAD	
	DELUGE SYSTEM VALVE	O ^{HT}	HIGH TEMPERATURE SPRINKLER HEAD	
 	WET PIPE VALVE	0*	CHEMICAL SPRINKLER HEAD	
•	DRY SYSTEM VALVE	4	SIDEWALL SPRINKLER HEAD	
P	PREACTION SYSTEM VALVE	∢w	WINDOW SPRINKLER HEAD	
	FIRE HYDRANT	SR	SEMI RECESSED SPRINKLER HEAD	
FG	FIRE GONG			
~,	FIRE DEPARTMENT CONNECTION			
SP	WET SPRINKLER LINE			
— DSP——	DRY SPRINKLER LINE			
— F(WET) —	WET FIRE LINE			
— F(DRY) —	DRY FIRE LINE			
H.Cx	FIRE HOSE CABINET AND TYPE	F.V.C.−x	FIRE VALVE CABINET AND TYPE	
V.Cx	SPRINKLER SHUT-OFF VALVE CABINET AND TYPE			
E.−x ⊗	FIRE EXTINGUISHER AND TYPE			
E.Cx	FIRE EXTINGUISHER CABINET AND TYPE	F.R.	FIRE REEL AND TYPE	

NOTE: NOT ALL SYMBOLS APPLY, REFER TO FLOOR PLANS AND DRAWINGS

FIRE PROTECTION (MSD-012.07)

SYMBOL	DESCRIPTION	SYMBOL	DESCRIPTION
	REFER TO SPECIFICATION FOR DETAILS AND ELOW)	ADDITIONAL TYPES	NOT LISTED
⊕ WC−	WATER CLOSET	ВТ	BATHTUB
] U-	URINAL	^-2-^ _{SH−}	SHOWER
٠- ا	COUNTERTOP LAVATORY	e-Ø DF−	DRINKING FOUNTAIN
₽ L−	WALL HUNG LAVATORY	⇒ EW	EMERGENCY EYEWASH
S-	SINGLE COMPARTMENT SINK	p EW/SH	EMERGENCY EYEWASH/SHOWER
JS-	JANITOR SINK	ρ ESH 	EMERGENCY SHOWER
<mark>ತ</mark> ಿ−s−	DOUBLE COMPARTMENT SINK	FT FT	FLUSH TANK
	DOMESTIC COLD WATER (DOM. COLD WATER) (D.C.W.)	RRW	
- · -(B) ·	BURIED DOMESTIC COLD WATER (DOM. COLD WATER) (D.C.W.)	——P(GW)——	
	DOMESTIC HOT WATER (DOM. HOT WATER) (D.H.W.)		
	DOMESTIC HOT WATER RECIRCULATION (DOM. HOT WATER RECIRC.) (D.H.W.R.)	— — GV— —	
т —	- TEMPERED WATER	—ЭН НВ	HOSE BIBB
NP	NON-POTABLE WATER	-⊃-□ WH (NFWH)	WALL HYDRANT (OR NON FREEZE WALL HYDRANT)
WM]	WATER METER	GH (NFGH)	GROUND HYDRANT (OR NON FREEZE GROUND HYDRANT)
5-1Φ 1-1 1-1-1-1-1-1-1-1-1-1-1-1-1-1-1-1-1-1	TEMPEDED MINING MANY ASSESSED.	[라 NFPH	NON FREEZE POST HYDRANT
¹² γ	TEMPERED MIXING VALVE ASSEMBLY		
SHΦH√H9 SHΦH√H9	TEMPERED MIXING VALVE CABINET	н/с ss-ф ss-ф	HOT AND COLD HOSE BIBB

5 PLUMBING SYMBOLS AND ABBREVIATIONS

SYMBOL	DESCRIPTION	SYMBOL	DESCRIPTION COMPRESSED AIR	
DW	DISTILLED WATER (DI.W.)	CA		
DEW	DEMINERALIZED WATER (DE.W)	VA	VACUUM	
—— 	REVERSE OSMOSIS VALVE		NON-POTABLE COLD WATER	
RO	REVERSE OSMOSIS LINE	CDW	CHILLED DRINKING WATER	
H	MEDICAL GAS SHUT-OFF VALVE	AV	ACID RESISTANT VENT	
RW G	RECESSED WALL OUTLET	A	ACID RESISTANT DRAINAGE ABOVE GRA	
02 <i></i>	MEDICAL OXYGEN ABOVE GRADE	— — A(B) — —	ACID RESISTANT DRAINAGE BELOW GRA	
— 02(B) —	MEDICAL OXYGEN BELOW GRADE MEDICAL AIR MEDICAL NITROUS OXIDE MEDICAL CARBON DIOXIDE MEDICAL NITROGEN MEDICAL HELIUM MEDICAL VACUUM HOSPITAL (MEDICAL) GRADE AIR	ACO AFD AMH — AGSS — LVA— LA — LG — DA — DA —	ACID RESISTANT CLEANOUT ACID RESISTANT FLOOR DRAIN ACID RESISTANT MANHOLE ANAESTHETIC GAS SCAVENGING SYSTEM LABORATORY VACUUM LABORATORY AIR LABORATORY GAS DENTAL AIR	
—— МА ———				
N20				
CO2				
N2				
MHE				
MV				
—— HGA ———				
— CHL —	CHLORINE LINE	DV	DENTAL VACUUM	
— CHLV —	CHLORINE VENT	MRA	MURIATIC ACID LINE MURIARIC ACID VENT	
LN	LIQUID NITROGEN	MRAV		
C O ₂ −3 C MA−2 C CO2−1 C N20−1 C N2−1 C AGSS−1 MV−2	GAS OUTLET COUNTS ON HEADWALL/ MEDICAL SERVICE UNIT. UP TO 7 GASSES AS APPLICABLE, FROM LEFT TO RIGHT WHEN FACING OUTLETS: 02, MA, N20, C02, N2, AGSS, MV	ZVAP/ZVAAP	MEDICAL GAS ZONE VALVE AND AREA ALARM PANEL. UP TO 7 GASSES AS APPLICABLE: O2, MA, N2O, CO2, N2, AGSS, MV	

NOTE: NOT ALL SYMBOLS APPLY, REFER TO FLOOR PLANS AND DRAWINGS

6 PLUMBING PIPING (MSD-012.05)


SYMBOL	DESCRIPTION	SYMBOL	DESCRIPTION
⊕ CFRD	CONTROL FLOW ROOF DRAIN SIZE AS NOTED REFER TO SPECIFICATION FOR TYPES		CONTROL FLOW ROOF DRAIN FROM ABOVE
⊕ RD	ROOF DRAIN SIZE AS NOTED REFER TO SPECIFICATION FOR TYPES		ROOF DRAIN FROM ABOVE
DRAIN: (REFER	R TO SPECIFICATION FOR DETAILS AND ADDI	TIONAL TYPES NOT	LISTED BELOW)
₽ FD	FLOOR DRAIN SIZE AS NOTED REFER TO SPECIFICATION FOR TYPES	─ •	FLOOR DRAIN FROM ABOVE WITH TRAP
⊕ FFD	FUNNEL FLOOR DRAIN SIZE AS NOTED REFER TO SPECIFICATION FOR TYPES		FUNNEL FLOOR DRAIN FROM ABOVE WITH TRAP
⊕ HD	HUB DRAIN SIZE AS NOTED REFER TO SPECIFICATION FOR TYPES	 &	HUB DRAIN FROM ABOVE WITH TRAP
₽ PD	PROMENADE DRAIN SIZE AS NOTED REFER TO SPECIFICATION FOR TYPES		PLANTER DRAIN FROM ABOVE WITH TRAI
⇔ PFD	PLENUM DRAIN SIZE AS NOTED REFER TO SPECIFICATION FOR TYPES		PLENUM FLOOR DRAIN FROM ABOVE WITH TRAP
SD	CORNER SCUPPER DRAIN SIZE AS NOTED REFER TO SPECIFICATION FOR TYPES		
SD	WALL SCUPPER DRAIN SIZE AS NOTED REFER TO SPECIFICATION FOR TYPES		
⊗ мн	MAINTENANCE HOLE		
₩ мнсв	MAINTENANCE HOLE CATCH BASIN		
ШСВ	CATCH BASIN		
⊕ AD	CIRCULAR EXTERIOR AREA DRAIN		
⊞ AD	SQUARE EXTERIOR AREA DRAIN		
NOTE: NOT AL	L SYMBOLS APPLY, REFER TO FLOOR PI	LANS AND DRAWI	NGS

SANITARY AND STORM SYMBOLS AND ABBREVIATIONS
(MSD-012 02)

SYMBOL	DESCRIPTION	SYMBOL	DESCRIPTION
v	VENT	_ <u>> co</u> _	, HORIZONTAL CLEANOUT ABOVE GRADE
SAN	SANITARY ABOVE GRADE OR FLOOR	<u>_</u>	, HORIZONTAL CLEANOUT BELOW GRADE
-SAN(B)	SANITARY BELOW GRADE OR FLOOR	—— GI ——	GREASE INTERCEPTOR ABOVE GRADE
ST	STORM ABOVE GRADE OR FLOOR	——GI(B)——	GREASE INTERCEPTOR BELOW GRADE
	STORM BELOW GRADE OR FLOOR	D	' INDIRECT DRAIN (CONDENSATE, ETC.)
— P(ST)——	PUMP STORM DISCHARGE		
P(SAN)	PUMP SANITARY DISCHARGE	→₹~	RUNNING TRAP ABOVE GRADE OR FLOOP
GW	GROUND WATER WEEPING TILE (SOLID PIPE)	<u> </u>	RUNNING TRAP BELOW GRADE OR FLOO
- -GW(P)	GROUND WATER BELOW WEEPING TILE (PERFORATED — DASH PIPE)	——p ^{co}	UPTURNED CLEANOUT
	CLEANOUT IN RISER	———II ^{CO}	HORIZONTAL CLEANOUT
N	BACKWATER VALVE		
STV	STACK VENT	VST	VENT STACK
RWL	RAIN WATER LEADER	WST	WASTE STACK
SST	SANITARY STACK	SS	STAINLESS STEEL
BWV	BACKWATER VALVE		

NOTE: NOT ALL SYMBOLS APPLY, REFER TO FLOOR PLANS AND DRAWINGS

SANITARY AND STORM SYMBOLS AND ABBREVIATIONS (MSD-012.03)

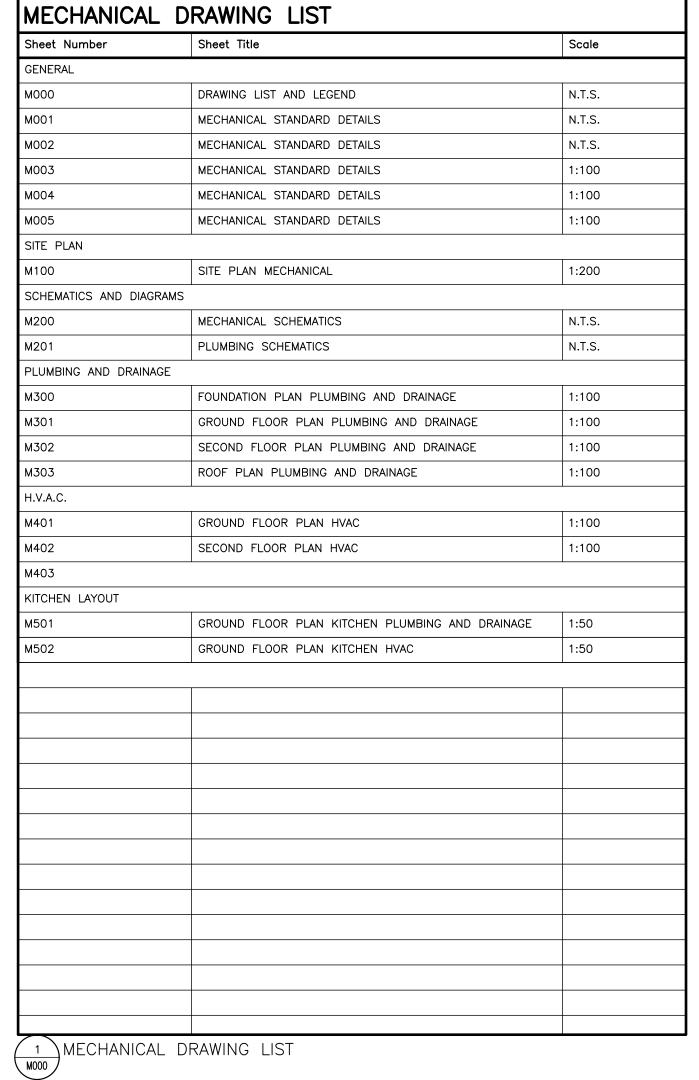

SYMBOL	DESCRIPTION	SYMBOL	DESCRIPTION
6 M-01	— DETAIL NUMBER — DRAWING NUMBER	12 M-01	— SECTION NUMBER — DRAWING NUMBER
4	REVISION NUMBER		REVISION BUBBLE
R.I.O.	ROUGH IN ONLY	N.O.	NORMALLY OPEN
R.I.C.	ROUGH IN AND CONNECT	N.C.	NORMALLY CLOSED
A/D	ACCESS DOOR	S.S.	STAINLESS STEEL
U/C	UNDERTCUT		
─	PIPING SERVICE CONTINUES	-OR-	ELBOWS
	REFER TO STANDARD DETAIL DRAWINGS FOR ADDITIONAL REQUIREMENTS OF EQUIPMENT NOTED	, <u>+</u> ,	TEE
	EQUIPMENT/PIPING/DUCTWORK SHOWN DASHED BELOW	 	BRANCH OFF BOTTOM OF MAIN
	PIPING INTERSECTS PIPING BELOW		BRANCH OFF TOP OF MAIN
	PIPE DROP OR FROM BELOW	\longrightarrow	DIRECTION OF FLOW
	PIPE UP OR FROM ABOVE	СТЕ	CONNECT TO EXISTING
CAP	CAPPED CONNECTION	EX. NEW	CONNECT TO EXISTING
T.B.	THRUST BLOCK		
GM	GAS METER		

GENERAL AND SITE PLAN SYMBOLS AND ABBREVIATIONS (MSD-012.01)

Contractor must check and verify all dimensions on the job, and report any discrepancies to the Architect before proceeding with the work.

REVISIONS AND ISSUES

DATE DESCRIPTION ISSUED FOR TENDER 2021.08.25 ISSUED FOR PERMIT 2021.09.09 3 RE-ISSUED FOR TENDER AND PERMIT 2022.01.31

MJMA

maclennan jaunkalns miller architects

425 adelaide street west level 6 toronto ontario m5v 3c1 416 593 6796 www.mjmarchitects.com

TRITON ENGINEERING SERVICES LTD CIVIL ENGINEERS

18 ROBB BOULEVARD - UNIT 8 ORANGEVILLE, ONTARIO TEL 519 941 0330 FAX 519 941 1830

BLACKWELL STRUCTURAL ENGINEERS

134 PETER STREET, SUITE 1301 TORONTO, ONTARIO, M5V 2H2
TEL 416.593.5300 FAX 416.593.4840

SMITH + ANDERSON MECHANICAL AND ELECTRICAL ENGINEERS 1100 - 100 SHEPPARD AVENUE EAST TORONTO, ONTARIO, M2N 6N5
TEL 416.487.8151 —




Smith + Andersen

1100 — 100 Sheppard Ave. East, Toronto On, M2N 6N5 416 487 8151 f 416 487 9104 smithandandersen.com

SAYERS FOOD LIMITED

132 BURLEIGH STREET t: 705.656.4531 e: sayers@apsley.ca

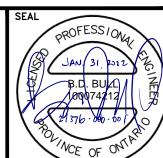

PROJECT TITLE


NEW SAYERS FOOD STORE BURLEIGH STREET, APSLEY

DRAWING LIST AND LEGEND

JUNE 16, 2021

PROJECT NUMBER

21076

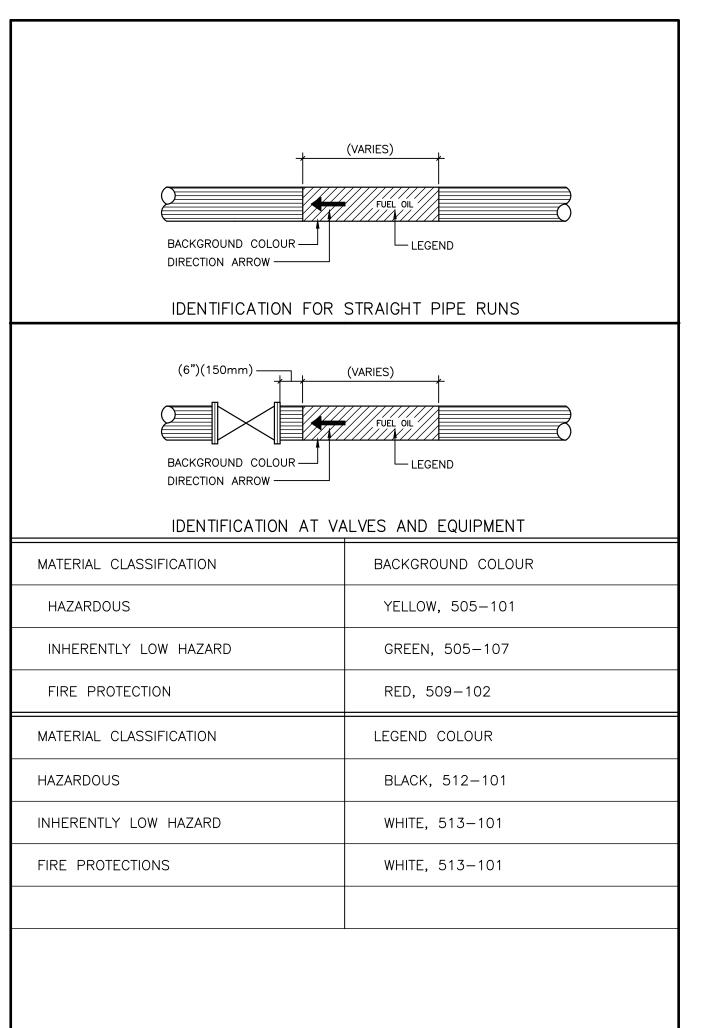


7 PIPE IDENTIFICATION (MSD-058.01)

PIPE MARKER LEGEND	VALVE TAG LEGEND	BACKGROUND COLOUR	LEGEND COLOUR
DOMESTIC COLD WATER	DCW	GREEN	WHITE
DISTILLED WATER	DI.W.	GREEN	WHITE
DEMINERALIZED WATER	DE.W.	GREEN	WHITE
CONDENSER WATER SUPPLY	CS	GREEN	WHITE
CONDENSER WATER RETURN	CR	GREEN	WHITE
CHILLED WATER SUPPLY	CHS	GREEN	WHITE
CHILLED WATER RETURN	CHR	GREEN	WHITE
CHILLED DRINKING WATER	CDW	GREEN	WHITE
DOMESTIC HOT WATER	DHW	GREEN	WHITE
DOMESTIC HOT WATER RECIRCULATION	DHWR	GREEN	WHITE
HOT WATER HEATING SUPPLY UP TO 250°F (120°C)	HWS	YELLOW	BLACK
HOT WATER HEATING RETURN UP TO 250°F (120°C)	HWR	YELLOW	BLACK
HIGH TEMPERATURE WATER SUPPLY ABOVE 250°F (120°C)	HTWS	YELLOW	BLACK
HIGH TEMPERATURE WATER RETURN ABOVE 250°F (120°C)	HTWR	YELLOW	BLACK
BOILER FEED WATER	BFW	YELLOW	BLACK
STEAM 15 PSI (100 KPA) AND LOWER	S-15	YELLOW	BLACK
STEAM ABOVE 15 PSI (100 KPA)	S-#(PSI)	YELLOW	BLACK
VENT (STEAM, ETC.)		YELLOW	BLACK
NATURAL GAS	N.G.	YELLOW	BLACK
DEIONIZED WATER	D.I.W.	GREEN	WHITE
R.O. WATER	R.O.W.	GREEN	WHITE
NITROGEN	N	BLUE	WHITE

		EQUIPMENT DESIGNATION		DESIGNATION
		FLOOR NUMBER		FOLIDMENT DESIGNATION
FC-12-01 -		SEQUENTIAL NUMBER TYPICAL EQUIPMENT DESIGNATION	SL-Al	HU12-01-S01 SILENCER TAG
UH-01		SEQUENTIAL NUMBER		
AC	SI	PLIT SYSTEM AIR CONDITIONING UNIT	RF	RETURN FAN
	(F	REFER TO CU BELOW)	RP	RADIANT PANEL
ACH	A	IR CURTAIN HEATER	RTU	ROOF TOP UNIT
AFS	Α	IR FLOW STATION	SCAC	SELF CONTAINED AIR CONDITIONING UN
AHU	A	IR HANDLING UNIT	SF	SUPPLY
SL	SI	LENCERS (TO BE READ IN CONJUNCTION	TF	TRANSFER FAN
		TH ASSOCIATED AIR HANDLING UNIT)	UH	UNIT HEATER
В	В	OILER	VHP	VERTICAL HEAT PUMP
СН	С	HILLER	VFC	VERTICAL FAN COIL
CRU	С	OMPUTER ROOM AIR CONDITIONING UNIT		
СТ	С	OOLING TOWER		
CUH	C.	ABINET UNIT HEATER		
CU	С	ONDENSING UNIT		
DHWT	D	OMESTIC HOT WATER TANK		
DHWH	D	OMESTIC HOT WATER HEATER		
EF	E:	XHAUST FAN		
ET	E)	XPANSION TANK		
EV	E,	VAPORATOR		
EW	EI	NTHALPY WHEEL		
FC	FI	LUID COOLER		
FCU	F/	AN COIL UNIT		
FFH	F	DRCE FLOW HEATER		
HE	Н	EAT EXCHANGER		
HHP	Н	ORIZONTAL HEAT PUMP		
HU	Н	UMIDIFIER		
MUA	М	AKEUP AIR UNIT		
P-	Р	UMP (GENERAL)		
P-HTG		HEATING WATER PUMP,		
P-CLG		COOLING WATER PUMP,		
P-FSP/FIRE		FIRE STANDPIPE PUMP/FIRE PUMP		
P-DW		DOMESTIC WATER PUMP		
P-SAN		SANITARY PUMP		
P-STM	₹	STORM PUMP		
P-SMP	기ê	SUMP PUMP		
P-DHWR	∏. Pi	STORM PUMP SUMP PUMP DOMESTIC HOT WATER RECIRC PUMP		
P-F0		FUEL OIL PUMP		
P-CHEM		CHEMICAL FEED PUMP		
P-CHW		CHILLED WATER PUMP,		
P-CON		CONDENSER WATER PUMP,		

MECHANICAL EQUIPMENT NOMENCLATURE CONVENTION (MSD-012.12)

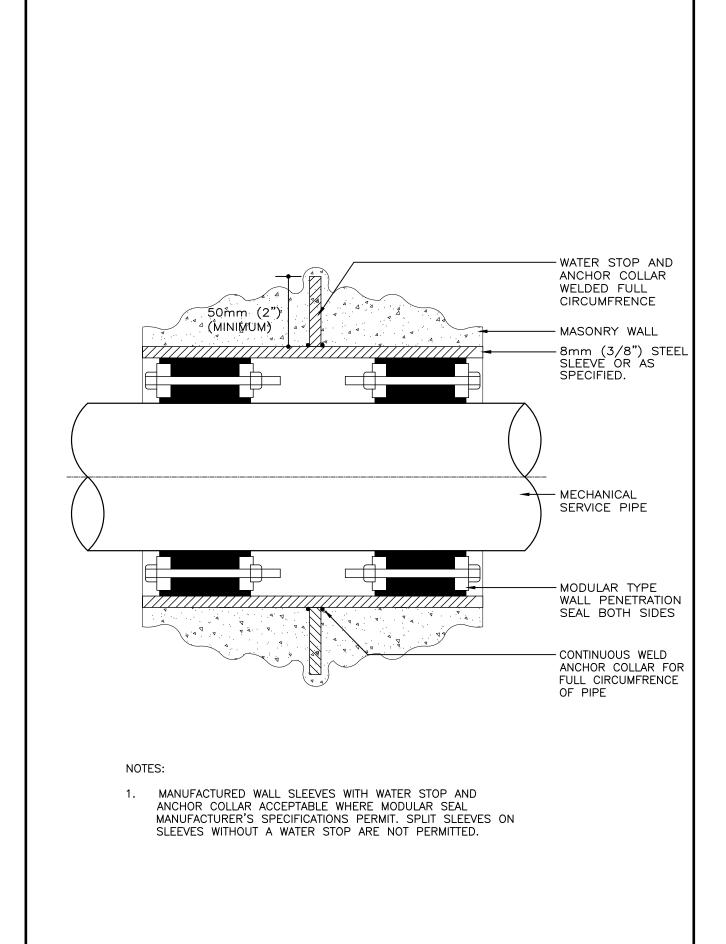

SYMBOL	DESCRIPTION	SYMBOL	DESCRIPTION
	SUPPLY DUCT UP OR FROM ABOVE	ZIZ	ACOUSTICALLY LINED TRANSFER AIR DUC
	SUPPLY DUCT DOWN OR FROM BELOW		SILENCER
	RETURN OR EXHAUST DUCT UP OR FROM ABOVE	CTS	CROSSTALK SILENCER
	RETURN OR EXHAUST DUCT DOWN OR FROM BELOW		DUCT WITH MINIMUM CLEARANCE FIRE RATED ENCLOSURE
	ROUND DUCT UP OR FROM ABOVE	F/D	DUCT WITH SLEEVE, INSULATION AND DAMPER
	ROUND DUCT DOWN OR FROM BELOW	CAP	CAPPED CONNECTION
	ACOUSTIC LINED DUCT		INSULATION DUCT
#	FLEXIBLE CONNECTION	RISE UP—-	RISE IN DUCT
CC	SQUARE ELBOW DUCT WITH TURNING VANE	SLOPE DN	DROP IN DUCT
	RADIUS ELBOW WITH TURNING VANES	■ S.B.	SOUND BAFFLE
	AXIAL FAN/INLINE FAN	MOD MOD	PROPELLER FAN WITH PROTECTIVE SCREEN
	MIXED FLÓW OR CENTRIFUG	\bigcup	CENTRIFUGAL FAN (ONLY IN SCHEMATIC)
DIFFUSER GRILLE OR REGISTER TYP IMPERIAL: CFM,[IN METRIC: L/s,[mm	PE 150¢ SIZE (MM) NS.] AIR FLOW (L/S)	LINEAR SLOT DIFFUSER — AIR FLOW (L/S) —	IMPERIAL: CFM,[INS.] METRIC: L/s,[mm] NECK SIZE AND LINEAR DIFFUSER LENGTH (MM)
<u>(○)</u> →	ROUND SUPPLY DIFFUSER		LINEAR SUPPLY AIR DIFFUSER C/W FLEXIBLE DUCT
	DUCTED RETURN OR EXHAUST REGISTER OR GRILLE		LIGHT TROFFER DIFFUSER TOP INLET C/W FLEXIBLE DUCT
[⊗]-+→	SQUARE OR RECTANGULAR DIFFUSER		LIGHT TROFFER DIFFUSER SIDE INLET C/W FLEXIBLE DUCT
→ [NON DUCTED RETURN OR EXHAUST GRILLE		DUCT MOUNTED SUPPLY OR RETURN GRILLE
→)	NON DUCTED ROUND RETURN OR EXHAUST GRILLE		LINEAR SUPPLY OR RETURN GRILLE
·	SQUARE PLAQUE DIFFUSER		SPIN-IN CONNECTION C/W BALANCING DAMPER AND FLEX DUCT
	DIFFUSERS WITH BLANK-OFF PORTION		SPIN-IN CONNECTION C/W BALANCING

SYMBOL	DESCRIPTION	SYMBOL	DESCRIPTION
200W	POWER REQUIREMENT FOR ELECTRIC TRACING	P.E.	PNEUMATIC-ELECTRIC
(((((((((((((((((((((((((((((((((((((ELECTRIC PIPE DEVICE FOR SINGLE LINE PIPES	С	CONTROLLER
	ELECTRIC PIPE DEVICE FOR DOUBLE LINE PIPES	TS	TEMPERATURE SENSOR
M.C.C.	MOTOR CONTROL CENTRE	HS	HUMIDITY SENSOR
D.S.	DISCONNECT SWITCH	BAS	POWER OUTLET FOR B.A.S.
	SWITCH (MANUAL STARTER)		AIR FLOW MONITORING STATION
H.O.A.	HAND-OFF-AUTO	S	STATIC
FZ	LOW TEMPERATURE THERMOSTAT	VFD	VARIABLE FREQUENCY DRIVE
FS	HIGH TEMPERATURE THERMOSTAT	СО	CARBON MONOXIDE SENSOR
Т	ELECTRIC THERMOSTAT/SENSOR	RS	REFRIGERANT SENSOR
T	PNEUMATIC THERMOSTAT/SENSOR	C02	CARBON DIOXIDE SENSOR
BAS	BASE BUILDING AUTOMATION SYSTEM	NO2	NITROGEN OXIDE SENSOR
Fs	FLOW SWITCH	A.F.S.	AIR FLOW STATION
S	SPEED SWITCH	PS	PRESSURE SENSOR
	FLOW MONITORING WATER		

SYMBOL	DESCRIPTION	SYMBOL	DESCRIPTION
—— HWS ——	HEATING WATER SUPPLY	FOS	FUEL OIL SUPPLY
— — HWR — —	HEATING WATER RETURN	— — FOR — —	FUEL OIL RETURN
—— CHS ——	CHILLED WATER SUPPLY	— — EFOV — —	EMERGENCY FUEL OIL VENT
— — CHR — —	CHILLED WATER RETURN	— — FOV — —	FUEL OIL VENT
—— GLS ——	GLYCOL SUPPLY	—— FOF ——	FUEL OIL FILL
— — GLR — —	GLYCOL RETURN	——РС——	PUMPED STEAM CONDENSATE
GLHS-	GLYCOL HEATING SUPPLY	RS	REFRIGERATION SUCTION
— — GLHR— —	GLYCOL HEATING RETURN	—— RL——-	REFRIGERATION LIQUID
GLCS	GLYCOL COOLING SUPPLY GLYCOL COOLING RETURN	RHG	REFRIGERATION HOT GAS DUAL TEMPERATURE SUPPLY
— — GLCR— —		—— DTS ——	
CDS	CONDENSER WATER SUPPLY	— — DTR — —	DUAL TEMPERATURE RETURN
— — CDR — —	CONDENSER WATER RETURN		BUCKET TYPE STEAM TRAP
	LOW PRESSURE STEAM	 ⊠	FLOAT AND THERMOSTAT TYPE STEAM TRAP
-//-//	MEDIUM PRESSURE STEAM	₹ ^{S.V.B.}	STEAM VACUUM BREAKER
	HIGH PRESSURE STEAM	——⊗ ^{TEV}	REFRIGERATION THERMAL EXPANSION VALVE
	LOW PRESSURE CONDENSATE	SLV	REFRIGERATION SOLENOID LIQUID VALVE
	MEDIUM PRESSURE CONDENSATE	RFD RFD	REFRIGERATION FILTER DRYER
- #/ ##	HIGH PRESSURE CONDENSATE	→ → → →	6 WAY CONTROL VALVE ELECTRIC
	2 WAY CONTROL VALVE		6 WAY CONTROL VALVE TYPE 1
	3 WAY CONTROL VALVE		

MECHANICAL PIPING

AIR HANDLING SYMBOLS (MSD-012.09)

SYMBOL	DESCRIPTION	SYMBOL	DESCRIPTION
F/D	FIRE DAMPER	SM/D	SMOKE DAMPER
M.O.D.	MOTOR OPERATED DAMPER	P.S.D.	POSITIVE SEAL DAMPER
M.D.	MANUAL DAMPER	B.D.D.	GRAVITY OR BACKDRAFT DAMPER
B.D.	BALANCING DAMPER	SP/D	SPLITTER DAMPER
C.S.F/[COMBINATION SMOKE AND FIRE DAMPER	R.B.D.	REMOTE OPERATED BALANCING DAM
*	VOLUME EXTRACTOR		
		OW (L/s) METRIC	
	WERED V.A.V. FE 120/1000 SECONDA	MARY FLOW (L/s) RY FLOW (L/s)	<pre>IMPERIAL: CFM,[INS.] METRIC: L/s,[mm]</pre>
FAN PO	WERED V.A.V. FE 120/1000 SECONDA RHC - REHEAT	RY FLOW (L/s) COIL CAPACITY (IMPERIAL: CFM,[INS.] METRIC: L/s,[mm] KW) FAN POWERED BOX C/W RETURN A
FAN PO	WERED V.A.V. FE 120/1000 SECONDA	RY FLOW (L/s)	IMPERIAL: CFM,[INS.] METRIC: L/s,[mm] KW)
FAN PO	WERED V.A.V. FE 120/1000 SECONDA RHC - REHEAT	RY FLOW (L/s) COIL CAPACITY (IMPERIAL: CFM,[INS.] METRIC: L/s,[mm] KW) FAN POWERED BOX C/W RETURN A SILENCER OR ACOUSTICALLY LINED
FAN PO BOX TY	WERED V.A.V. PE 120/1000 SECONDA RHC → REHEAT V.A.V. BOX (VARIABLE AIR VOLUME)	RY FLOW (L/s) COIL CAPACITY (IMPERIAL: CFM,[INS.] METRIC: L/s,[mm] KW) FAN POWERED BOX C/W RETURN A SILENCER OR ACOUSTICALLY LINED RETURN AIR INDUCTION V.A.V. BOX
FAN PO BOX TY	WERED V.A.V. PE 120/1000 SECONDA RHC REHEAT V.A.V. BOX (VARIABLE AIR VOLUME) V.A.V. BOX WITH ATTENTUATOR	RY FLOW (L/s) COIL CAPACITY (IMPERIAL: CFM,[INS.] METRIC: L/s,[mm] KW) FAN POWERED BOX C/W RETURN A SILENCER OR ACOUSTICALLY LINED RETURN AIR
FAN PO BOX TY	WERED V.A.V. PE 120/1000 RHC → REHEAT V.A.V. BOX (VARIABLE AIR VOLUME) V.A.V. BOX WITH ATTENTUATOR V.A.V. BOX WITH REHEAT COIL V.A.V. BOX WITH REHEAT COIL AND ATTENTUATOR ELEMENT TAG	RY FLOW (L/s) COIL CAPACITY (IMPERIAL: CFM,[INS.] METRIC: L/s,[mm] KW) FAN POWERED BOX C/W RETURN A SILENCER OR ACOUSTICALLY LINED RETURN AIR INDUCTION V.A.V. BOX
FAN PO BOX TY	WERED V.A.V. PE 120/1000 RHC REHEAT V.A.V. BOX (VARIABLE AIR VOLUME) V.A.V. BOX WITH ATTENTUATOR V.A.V. BOX WITH REHEAT COIL V.A.V. BOX WITH REHEAT COIL AND ATTENTUATOR ELEMENT TAG DOW HEATING CAPACITY ACTIVE ELEMENT LENGTH	RY FLOW (L/s) COIL CAPACITY (IMPERIAL: CFM,[INS.] METRIC: L/s,[mm] KW) FAN POWERED BOX C/W RETURN A SILENCER OR ACOUSTICALLY LINED RETURN AIR INDUCTION V.A.V. BOX
FAN PO BOX TY	WERED V.A.V. PE 120/1000 RHC	RY FLOW (L/s) COIL CAPACITY (IMPERIAL: CFM,[INS.] METRIC: L/s,[mm] KW) FAN POWERED BOX C/W RETURN A SILENCER OR ACOUSTICALLY LINED RETURN AIR INDUCTION V.A.V. BOX PRESSURE INDEPENDENT AIR VALVE DUCT COIL
FAN PO BOX TY	WERED V.A.V. PE 120/1000 RHC	RY FLOW (L/s) COIL CAPACITY (IMPERIAL: CFM,[INS.] METRIC: L/s,[mm] KW) FAN POWERED BOX C/W RETURN A SILENCER OR ACOUSTICALLY LINED RETURN AIR INDUCTION V.A.V. BOX PRESSURE INDEPENDENT AIR VALVE DUCT COIL RADIATION HEATING RISER NUMBERS

REVISIONS AND ISSUES DATE DESCRIPTION ISSUED FOR TENDER 2021.08.25 ISSUED FOR PERMIT 2021.09.09 3 RE-ISSUED FOR TENDER AND PERMIT 2022.01.31

Contractor must check and verify all dimensions on the job, and report any discrepancies to the Architect before proceeding with the work.

MJMA

416 593 6796

maclennan jaunkalns miller architects toronto ontario m5v 3c1

www.mjmarchitects.com TRITON ENGINEERING SERVICES LTD

CIVIL ENGINEERS 18 ROBB BOULEVARD — UNIT 8

ORANGEVILLE, ONTARIO TEL 519 941 0330 FAX 519 941 1830

BLACKWELL STRUCTURAL ENGINEERS

134 PETER STREET, SUITE 1301 TORONTO, ONTARIO, M5V 2H2
TEL 416.593.5300 FAX 416.593.4840

SMITH + ANDERSON MECHANICAL AND ELECTRICAL ENGINEERS

1100 - 100 SHEPPARD AVENUE EAST TORONTO, ONTARIO, M2N 6N5 TEL 416.487.8151 —



Smith + Andersen

1100 — 100 Sheppard Ave. East, Toronto On, M2N 6N5 416 487 8151 f 416 487 9104 smithandandersen.com

SAYERS FOOD LIMITED

132 BURLEIGH STREET	Γ
t: 705.656.4531	
e: sayers@apsley.ca	

NORTH ARROW

PROJECT TITLE

NEW SAYERS FOOD STORE BURLEIGH STREET, APSLEY

DRAWING TITLE

MECHANICAL STANDARD DETAILS

SCALE N.T.S.

JUNE 16, 2021


PROJECT NUMBER 21076


DRAWING NUMBER


8 PIPE IDENTIFICATION (MSD-058.02)


PENETRATION THROUGH FOUNDATION WALL (MSD-052.02)


4 ELECTRICAL AND CONTROLS SYMBOLS AND ABBREVIATIONS (MSD-012.11)

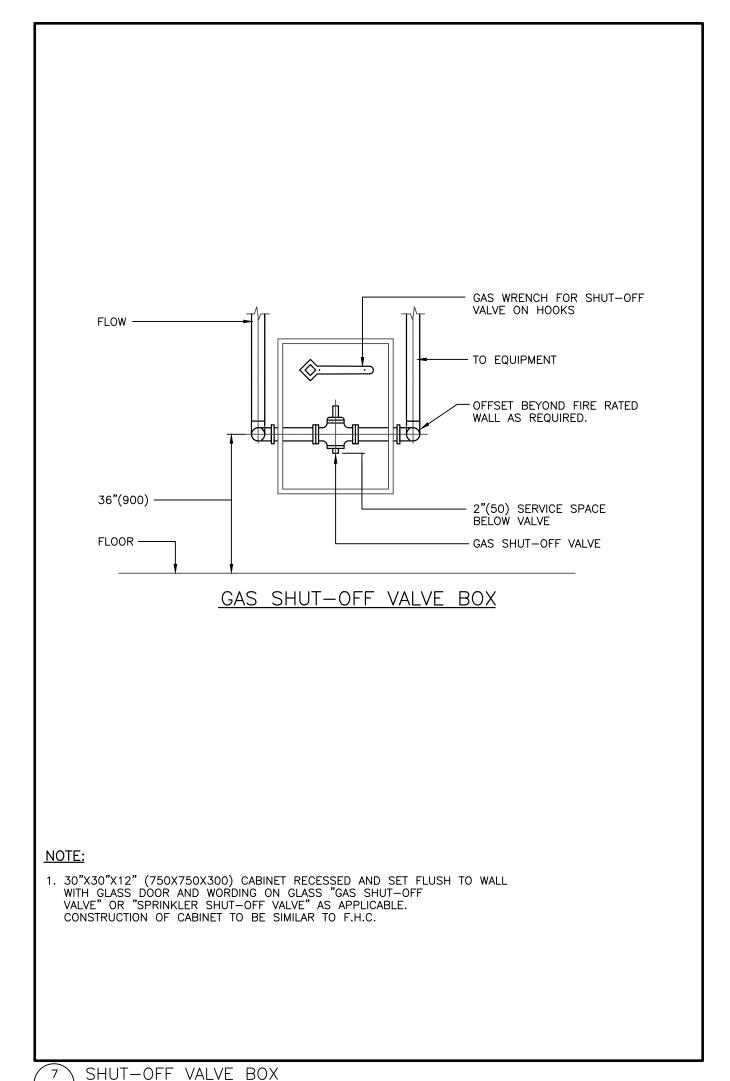

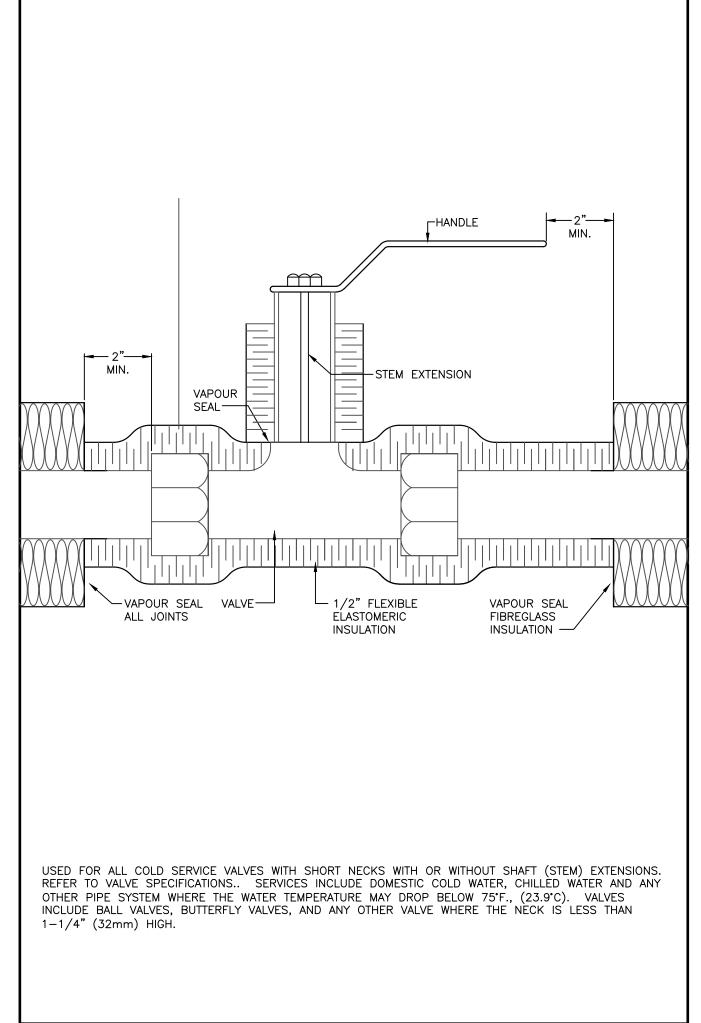

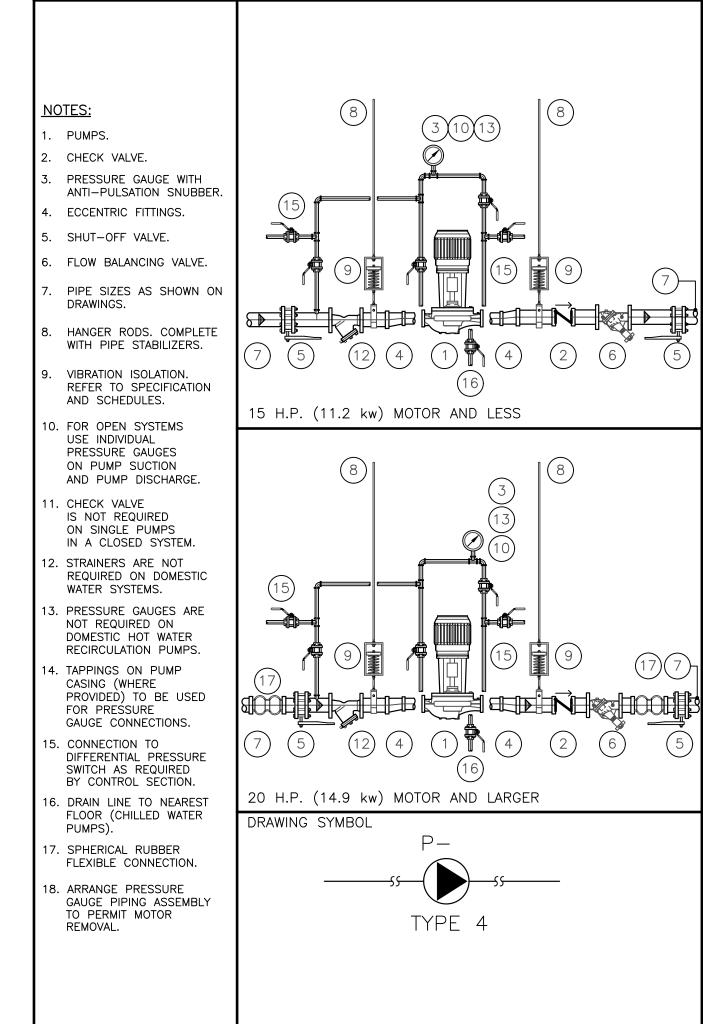


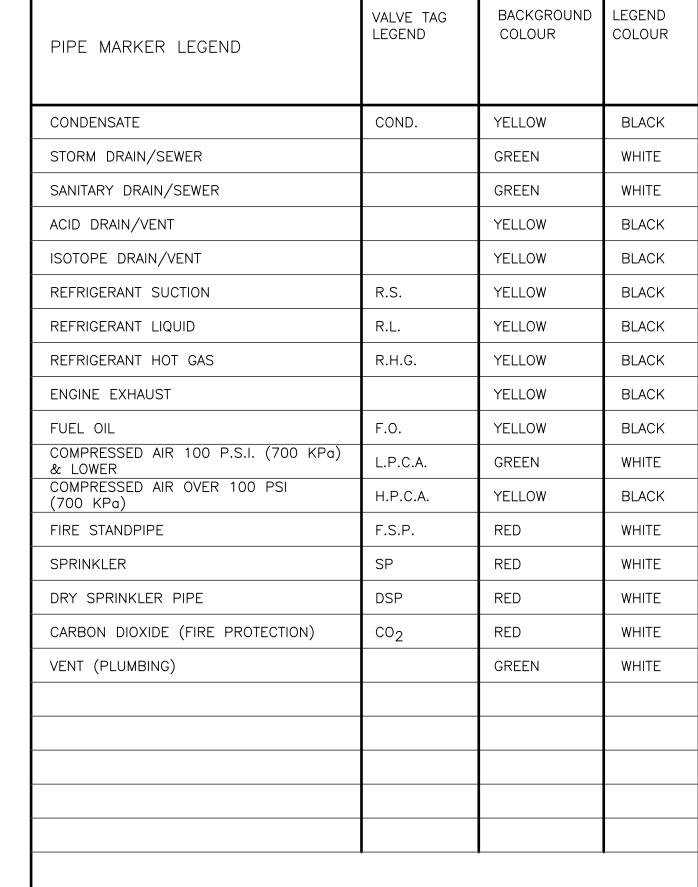

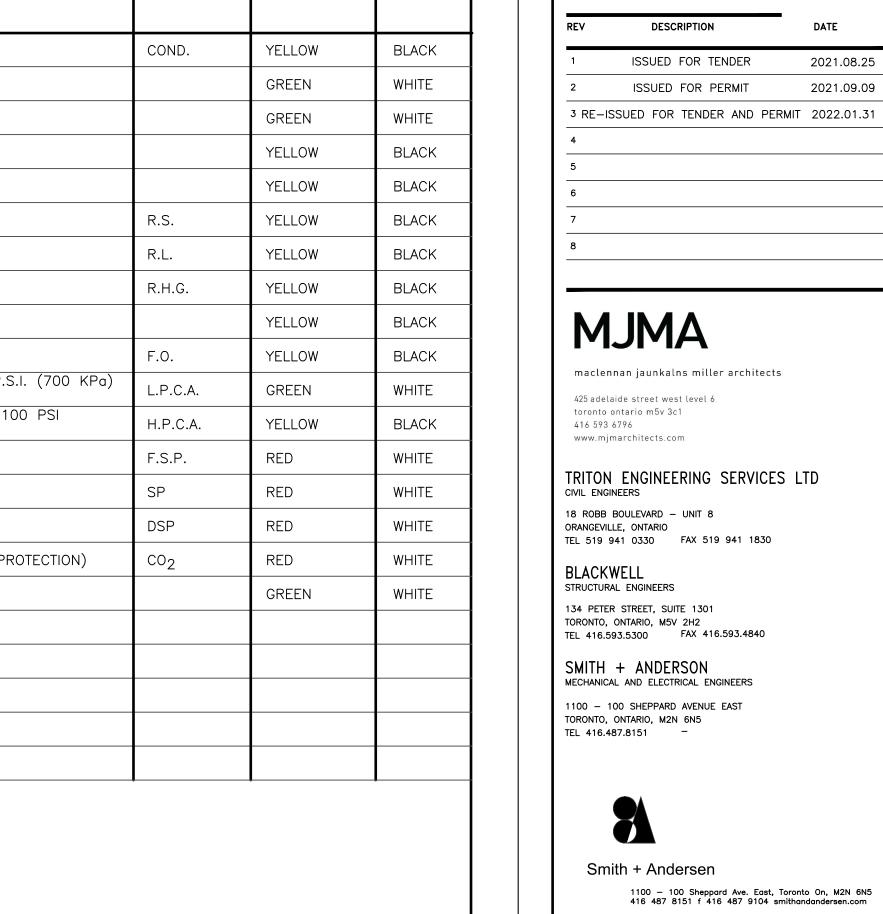


Contractor must check and verify all dimensions on the job, and report any discrepancies to the Architect before proceeding with the work.


REVISIONS AND ISSUES

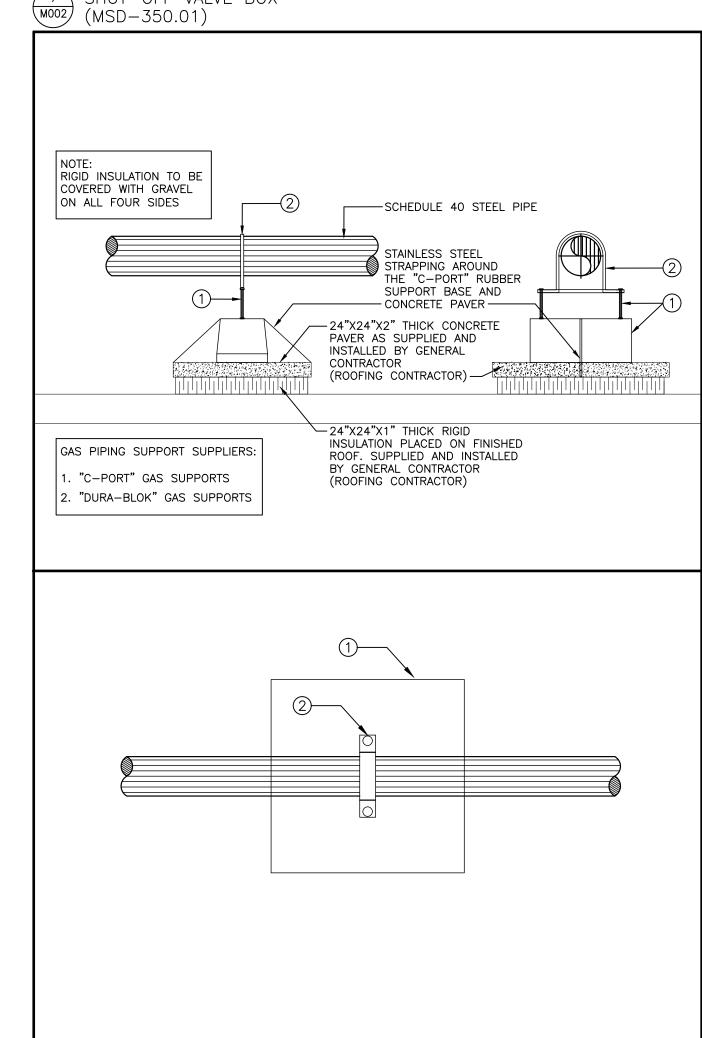


8 GAS PIPING ON ROOF

M002 (MSD-350.02)

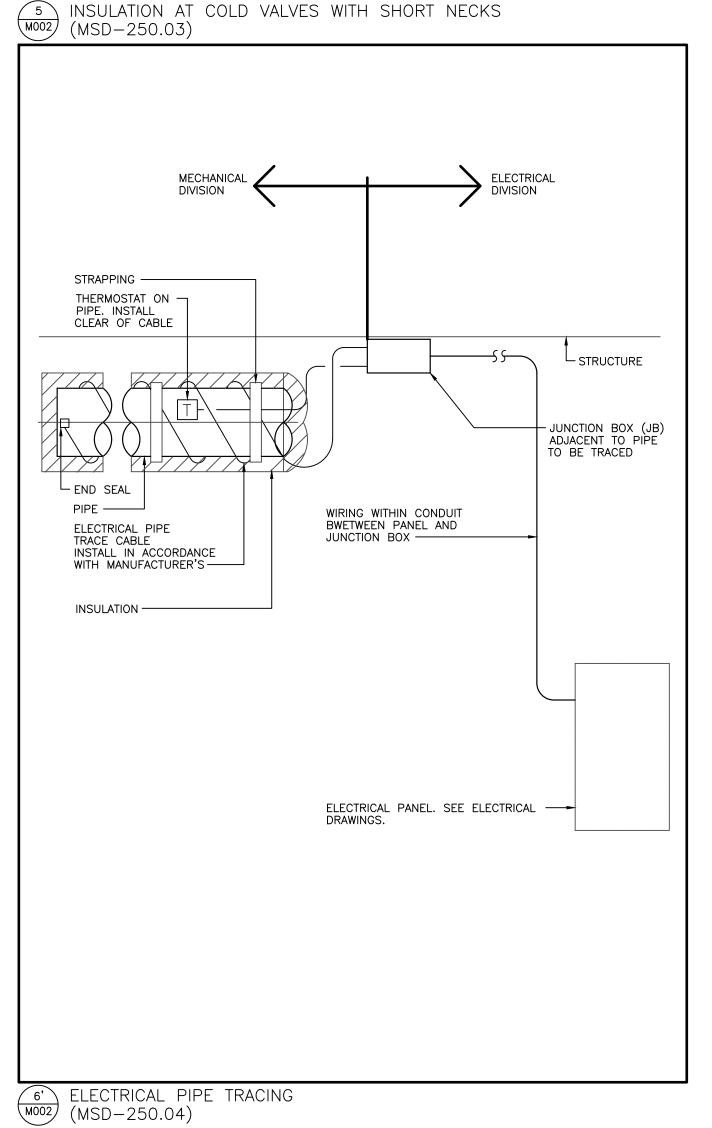


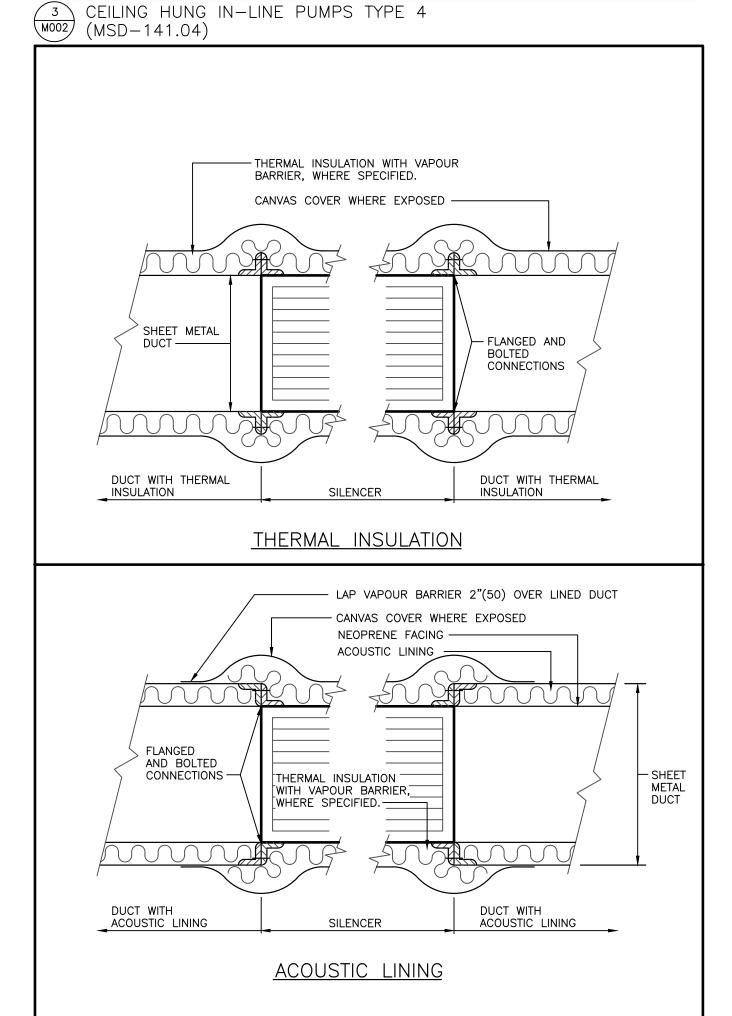

SILENCER INSULATION (MSD-250.01)

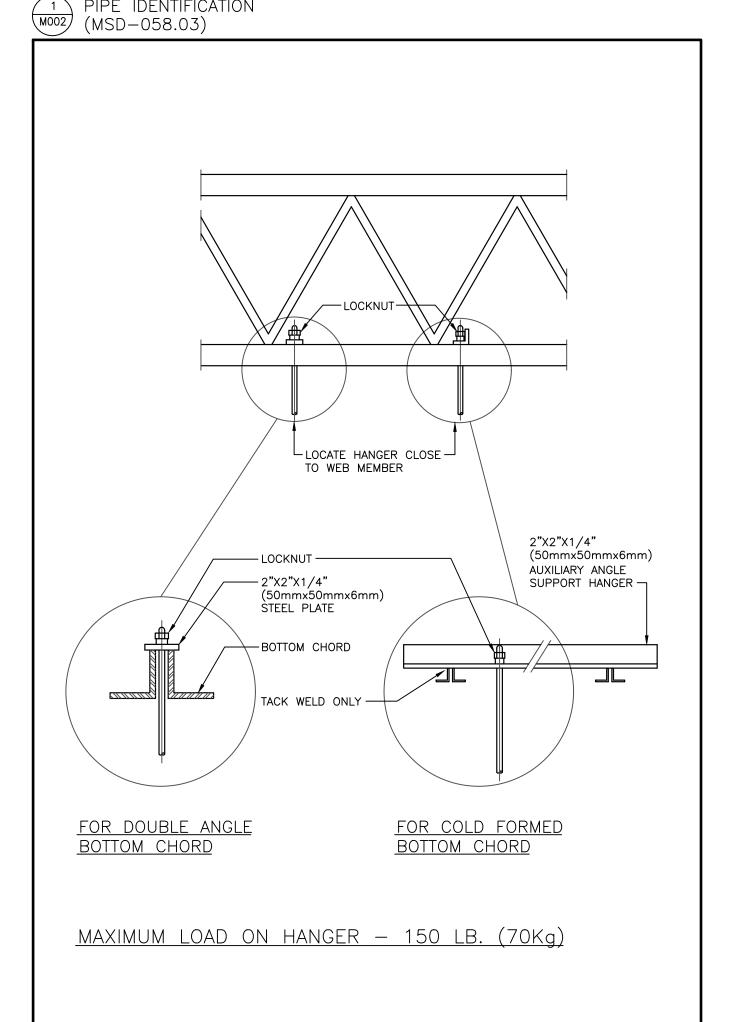



JOIST HANGERS (MSD-094.01)

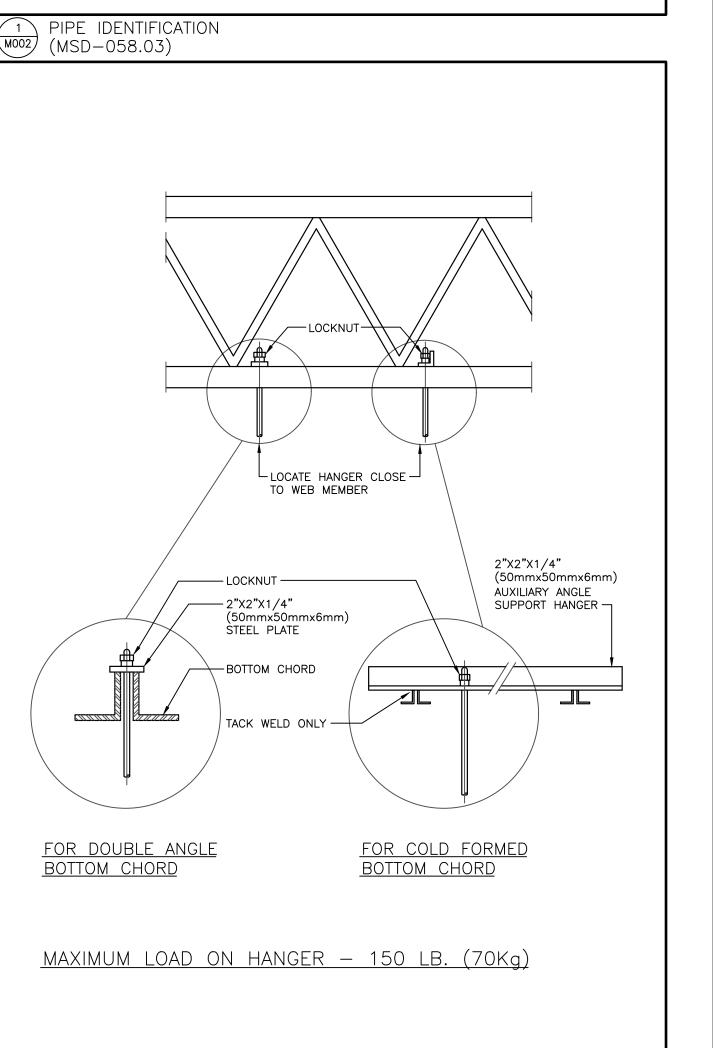






PROJECT NUMBER 21076

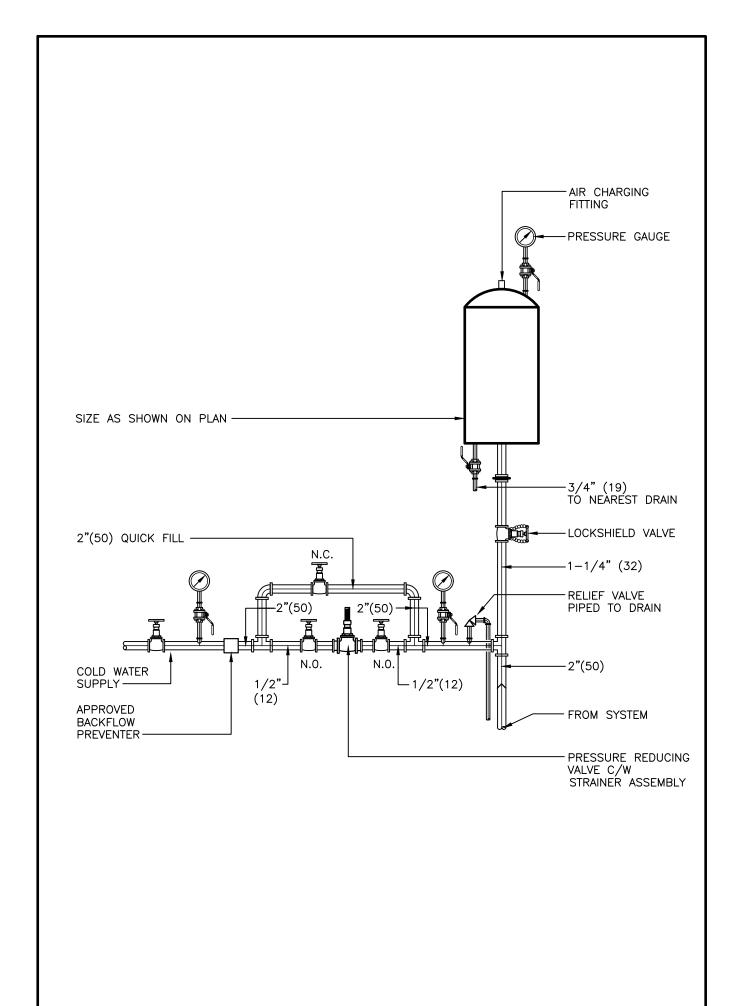


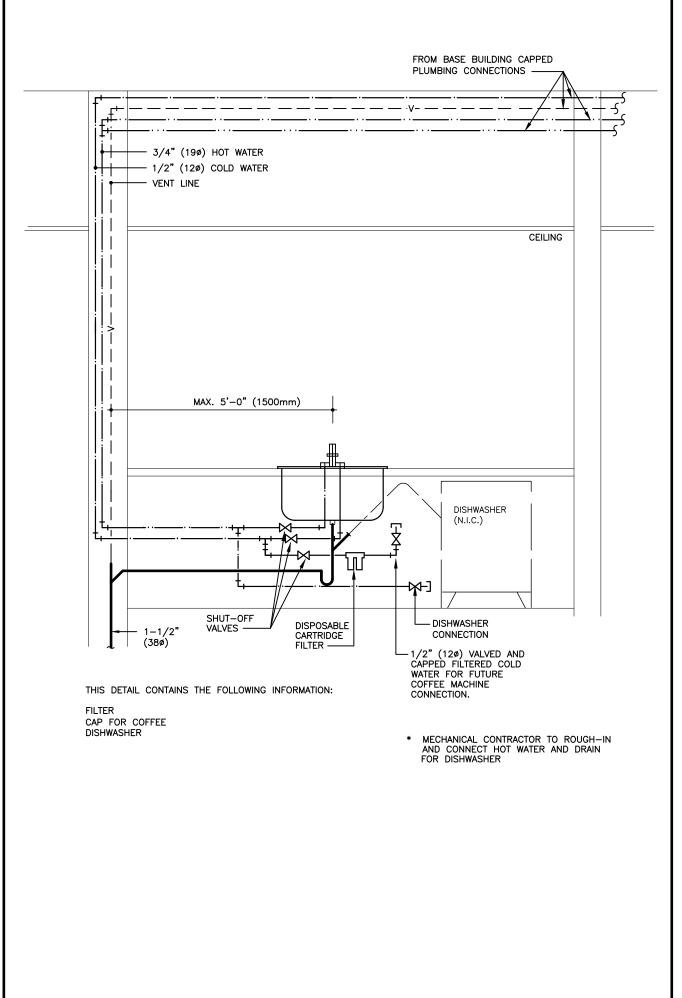

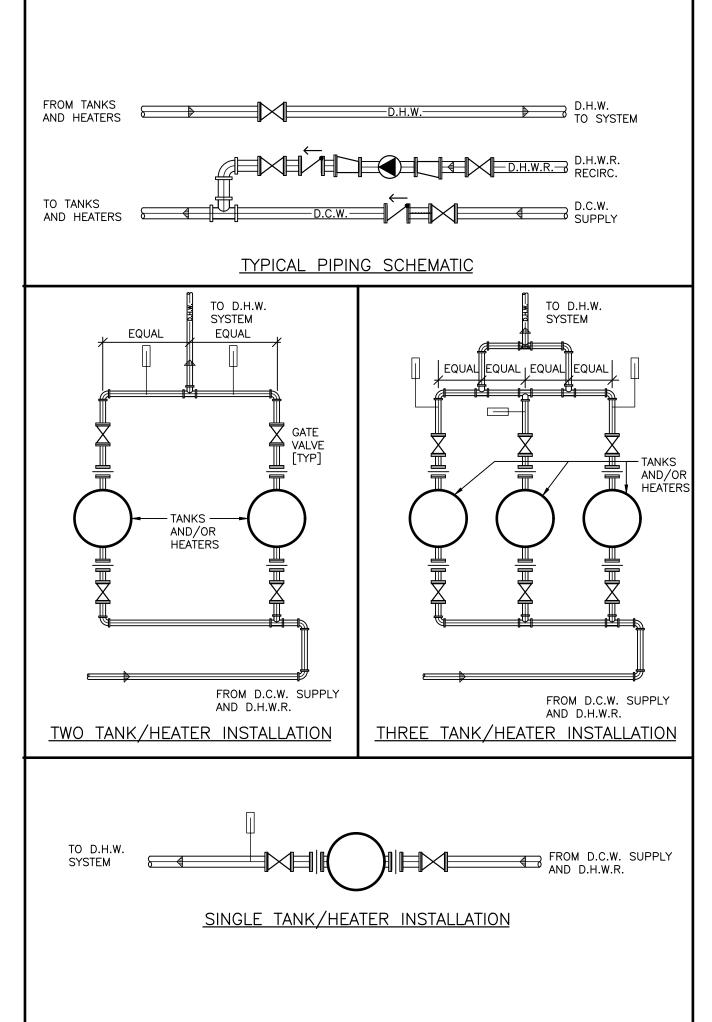

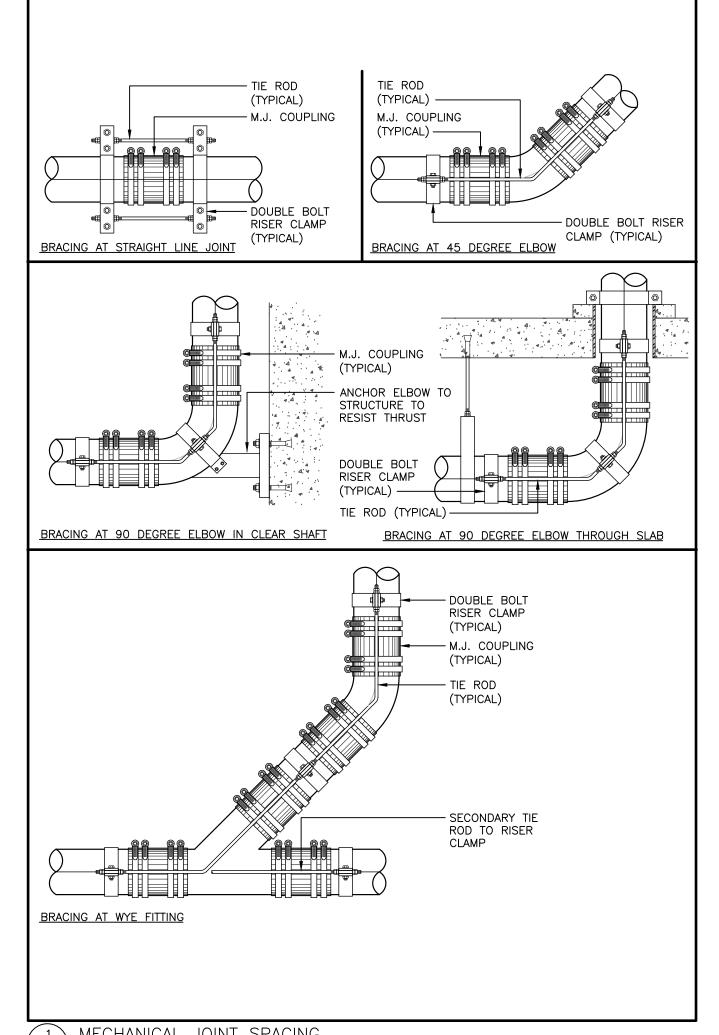


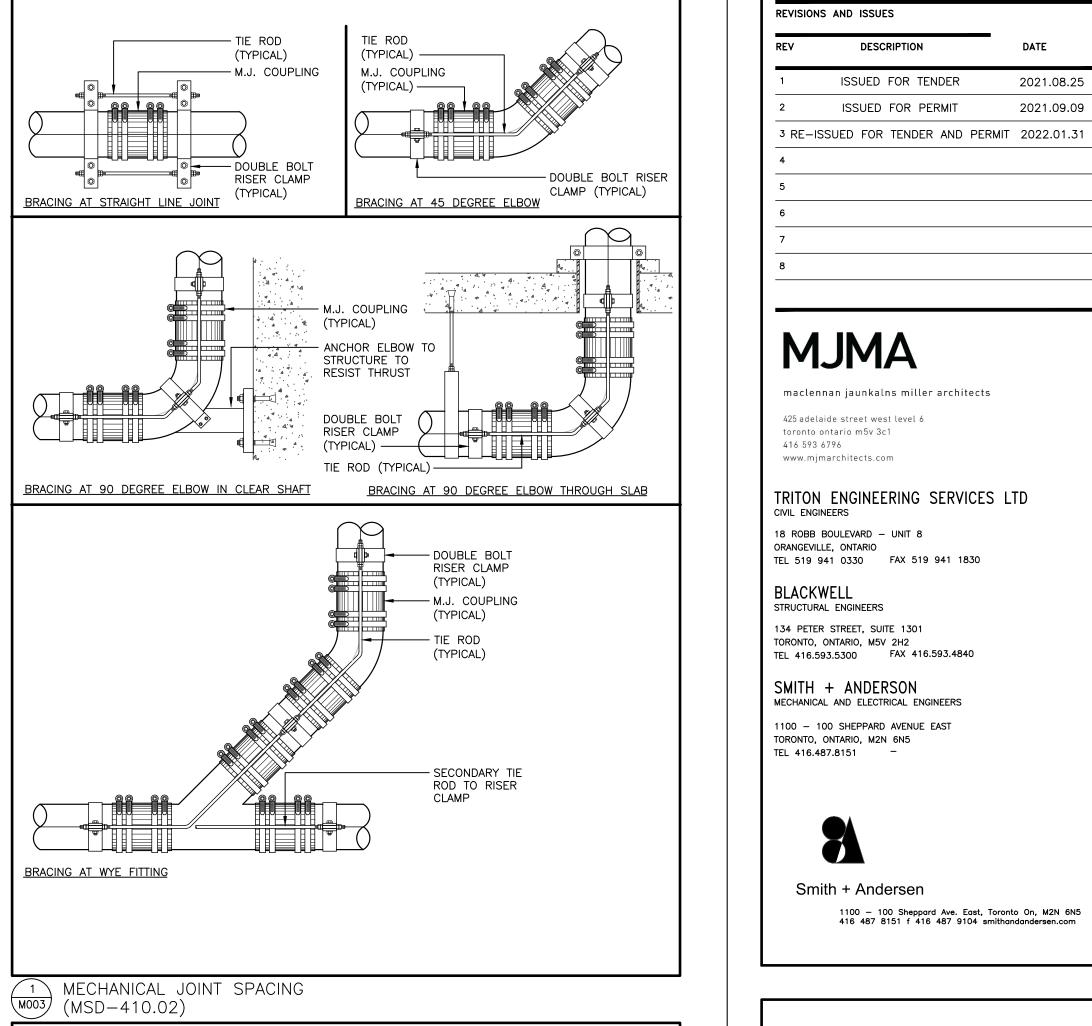

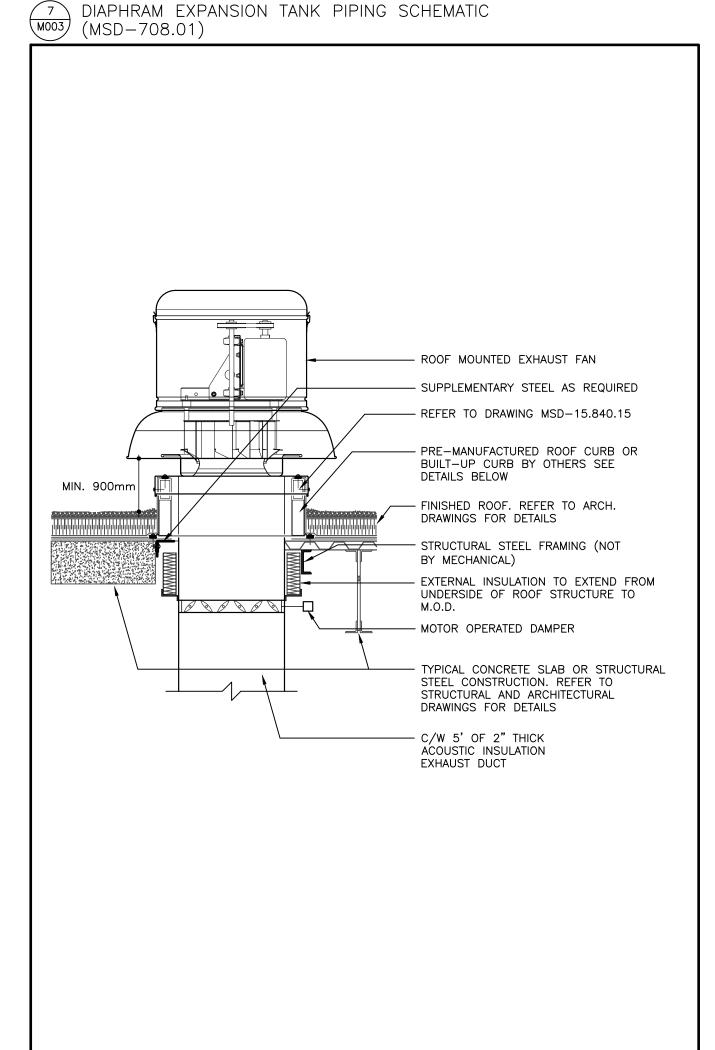


8 ROOF MOUNTED EXHAUST FAN


(MSD-824.01)

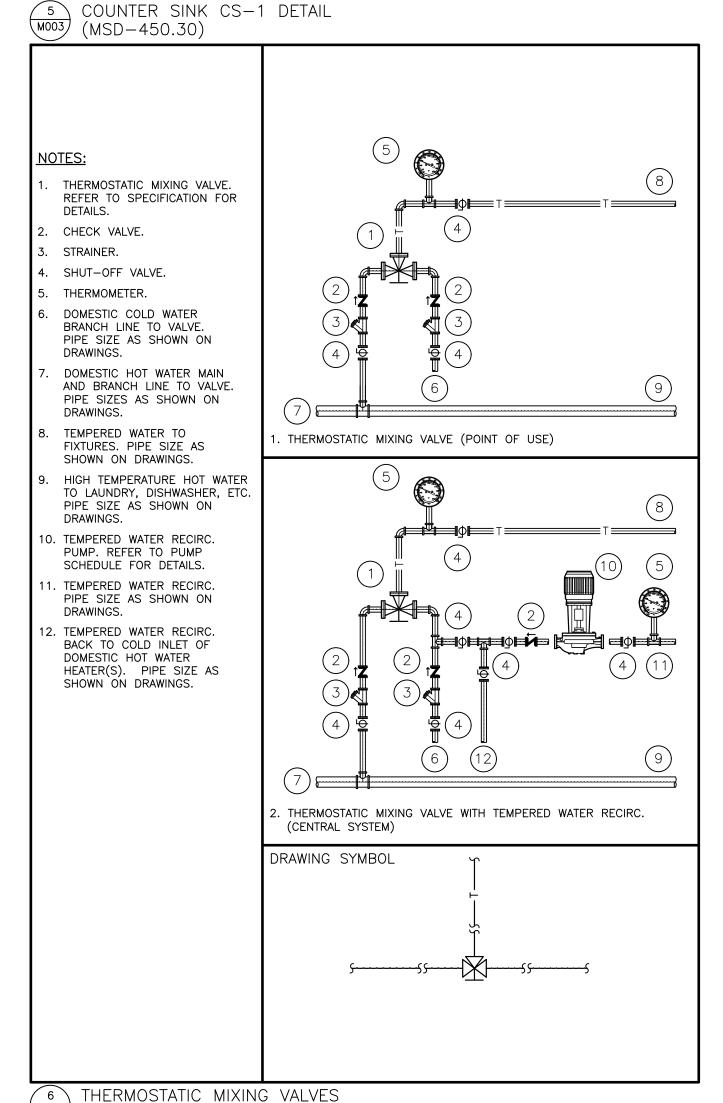


M003 (MSD-450.31)

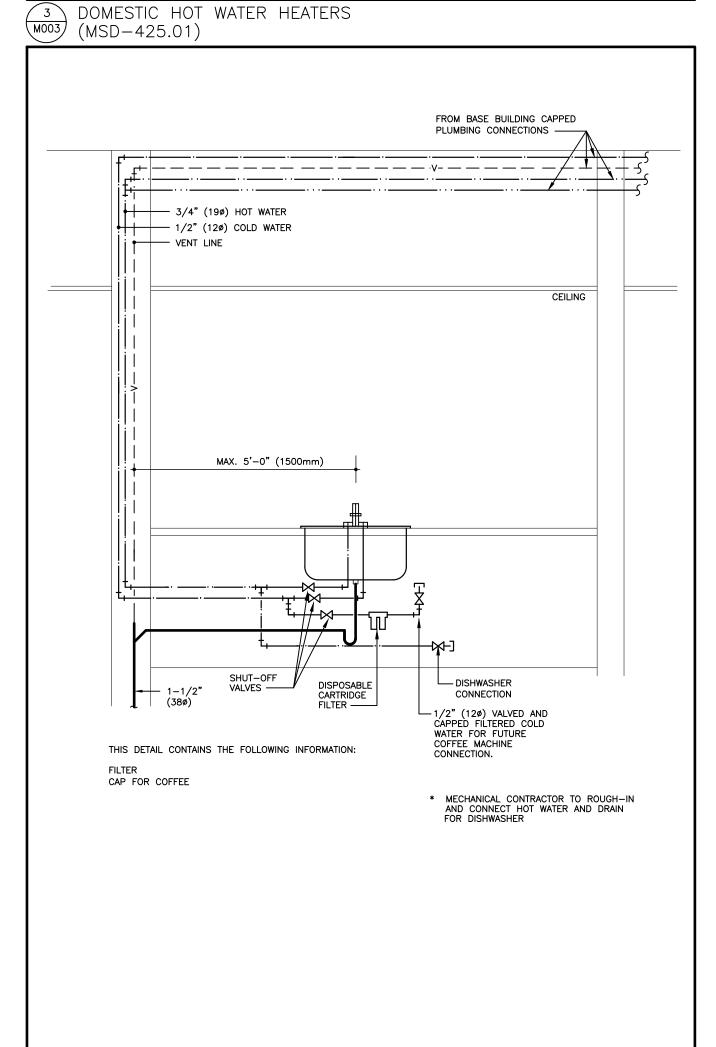


COUNTER SINK CS-1 DETAIL (MSD-450.30)

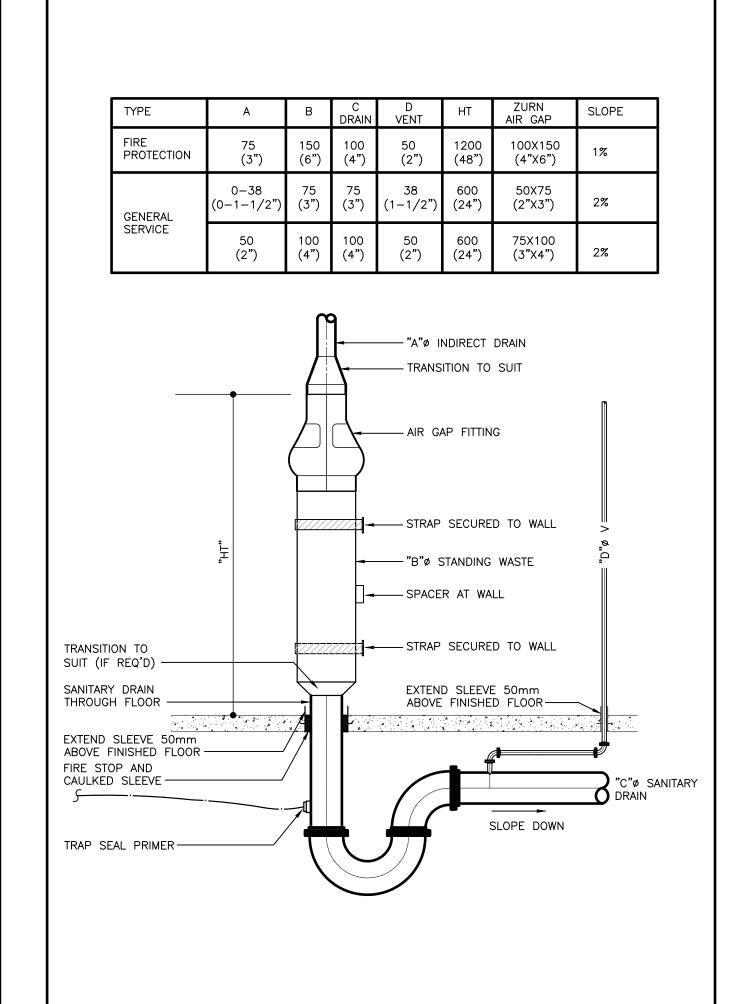


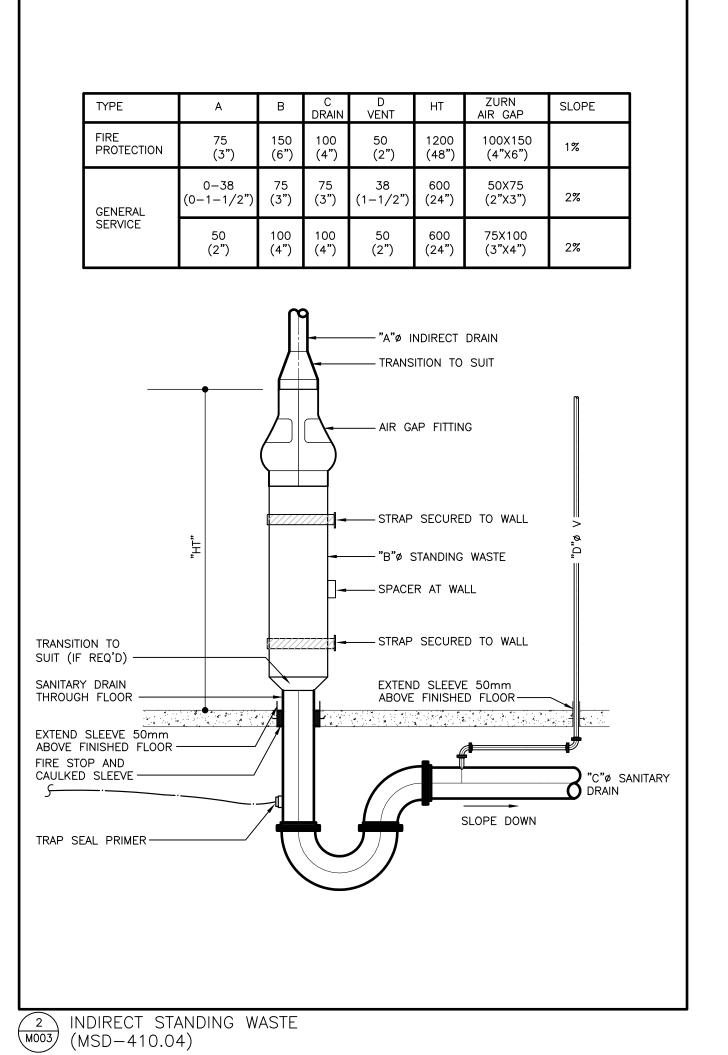






Contractor must check and verify all dimensions on the job, and report any discrepancies to the Architect before proceeding with the work.

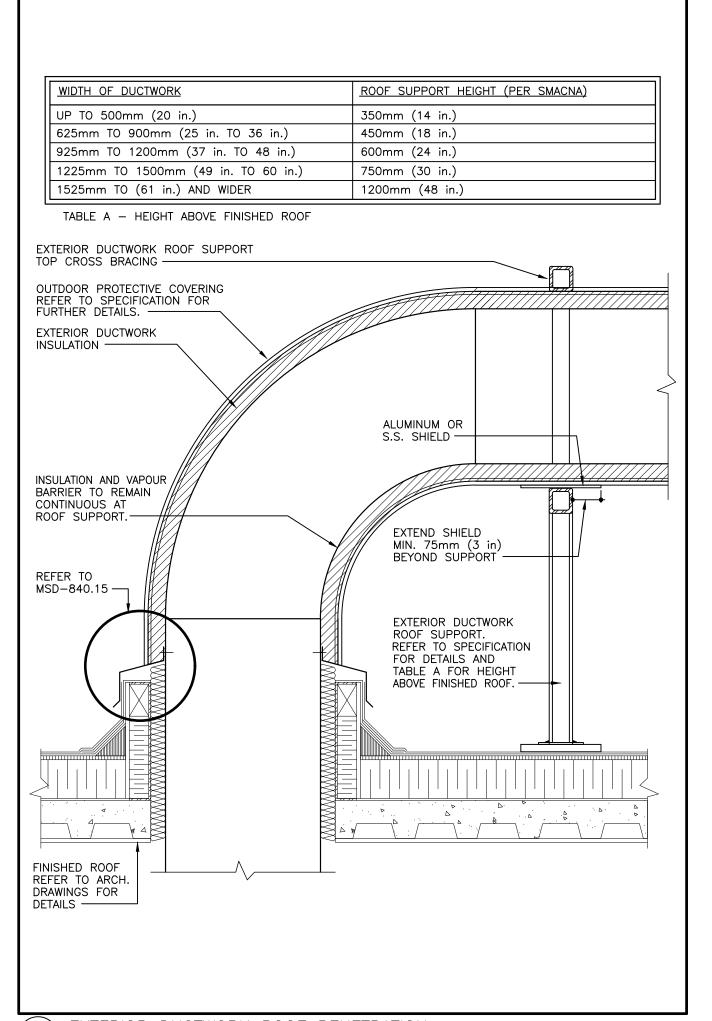


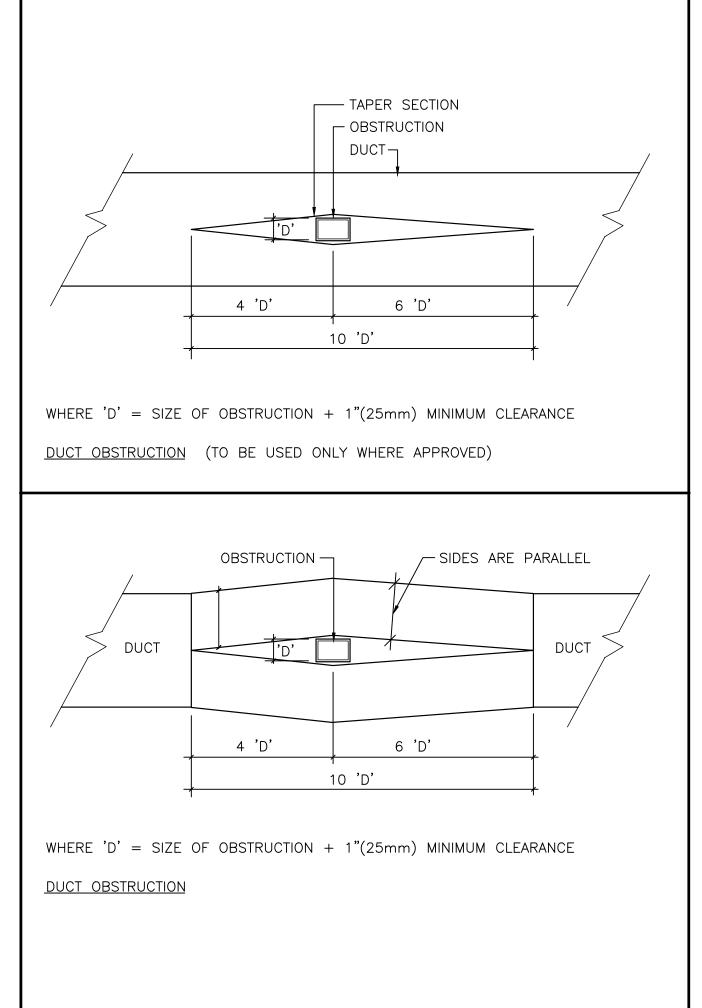

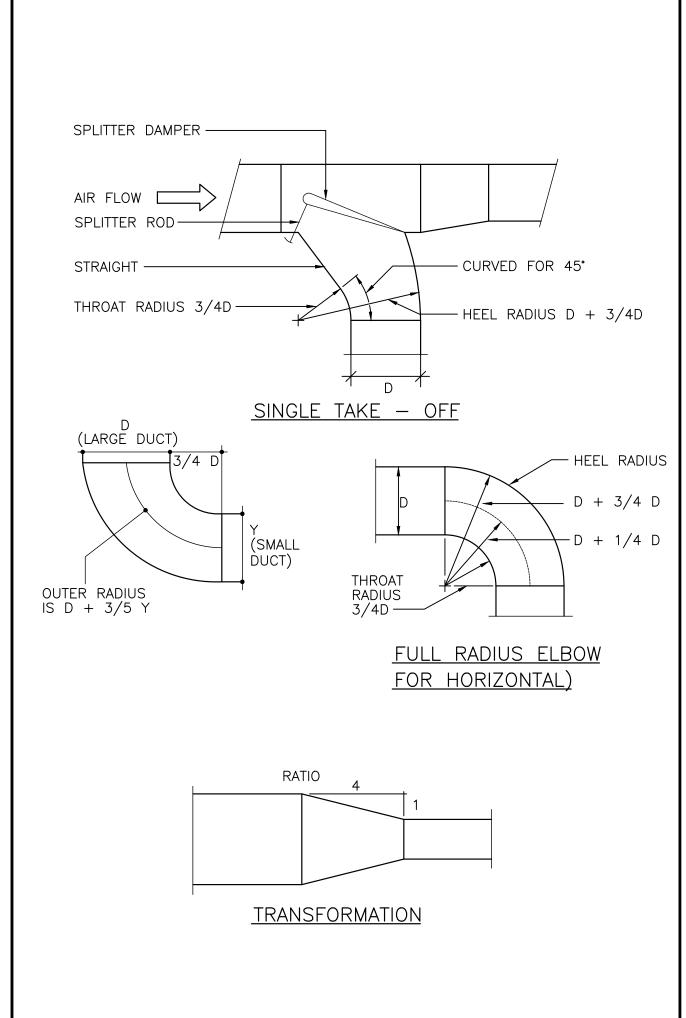

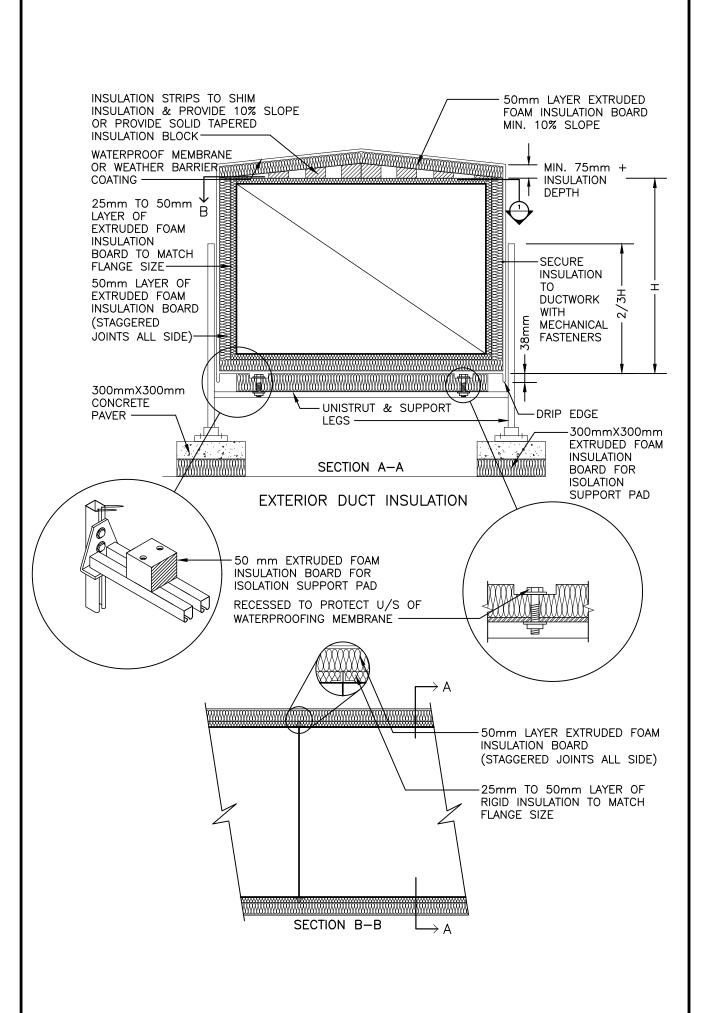


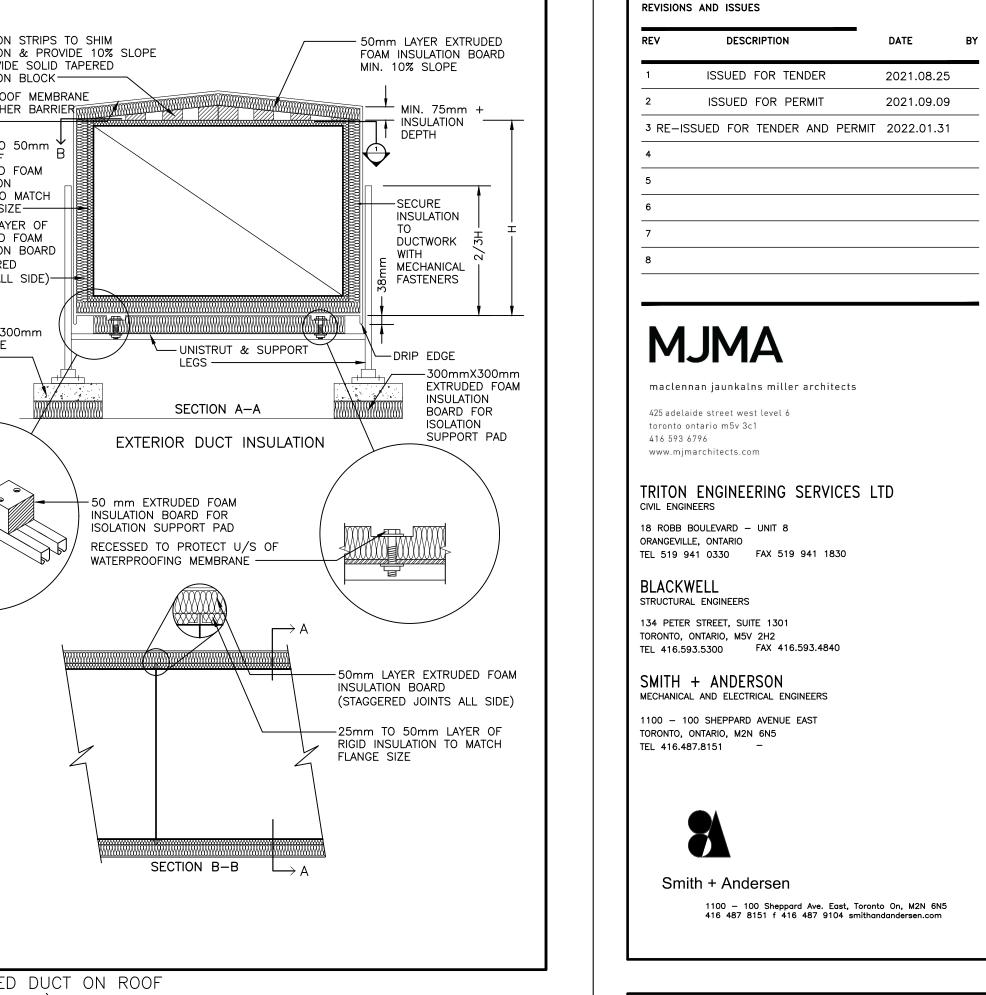

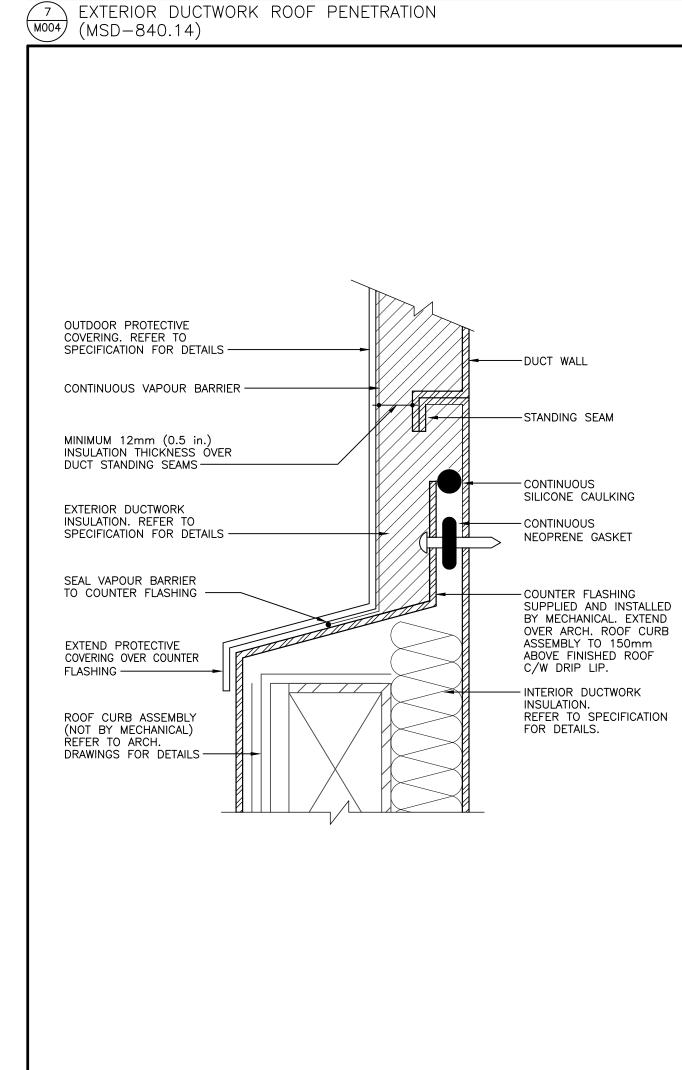


8 COUNTER FLASHING AT EXTERIOR DUCTWORK ROOF PENETRATION

(MSD-840.15)

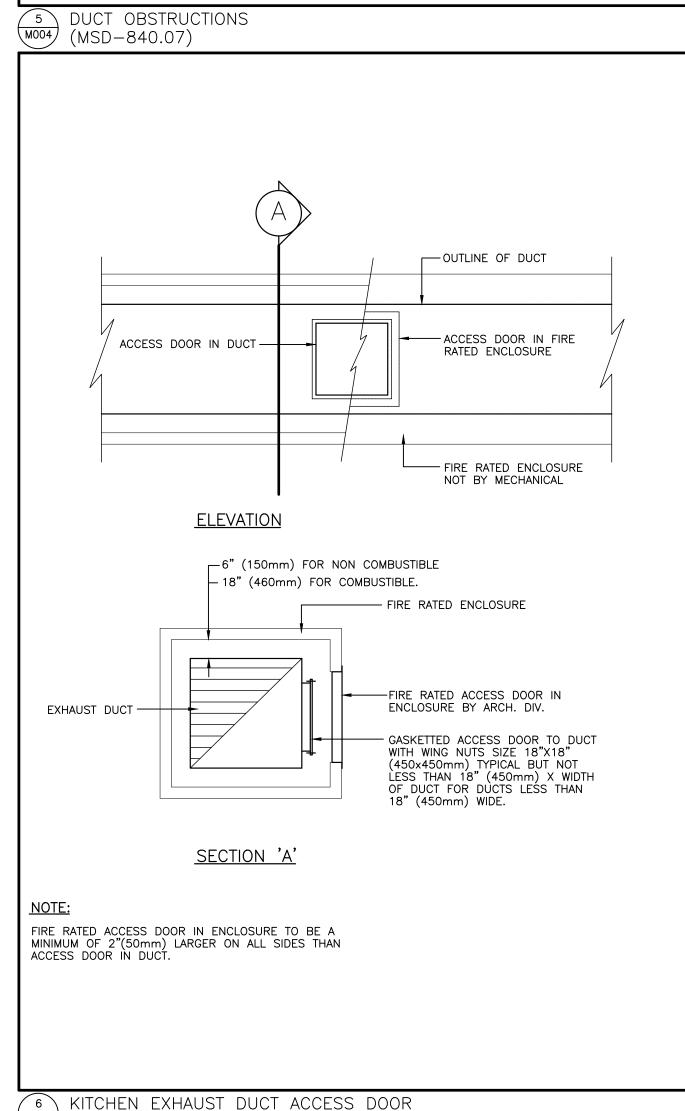


M004 (MSD-840.10)

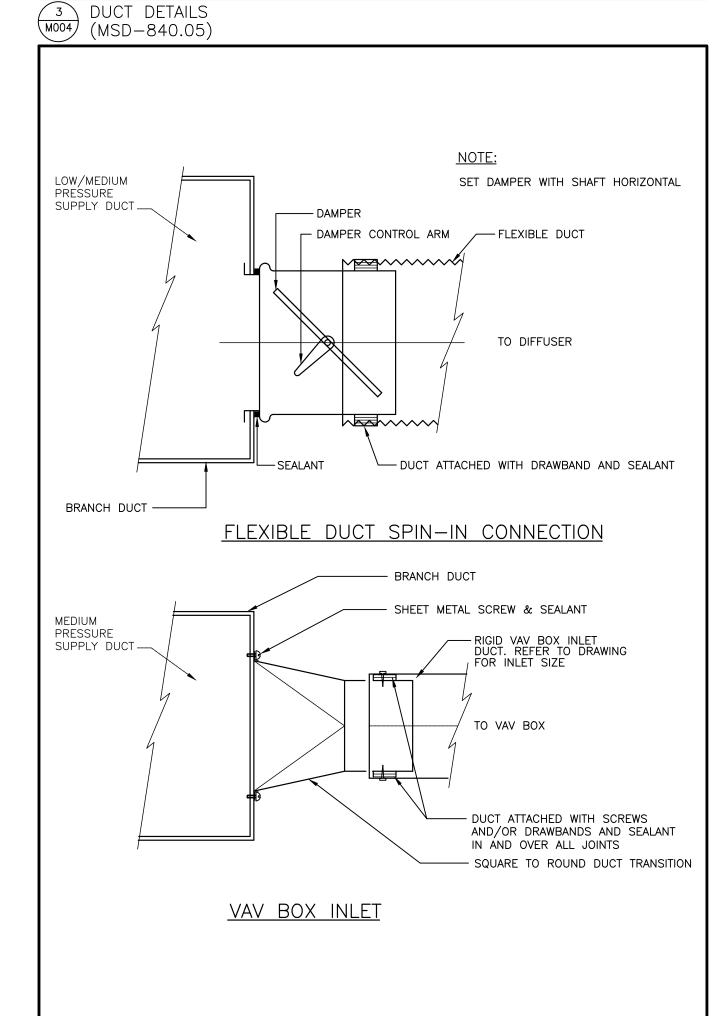


4 FLEXIBLE DUCT CONNECTIONS

(MSD-840.06)

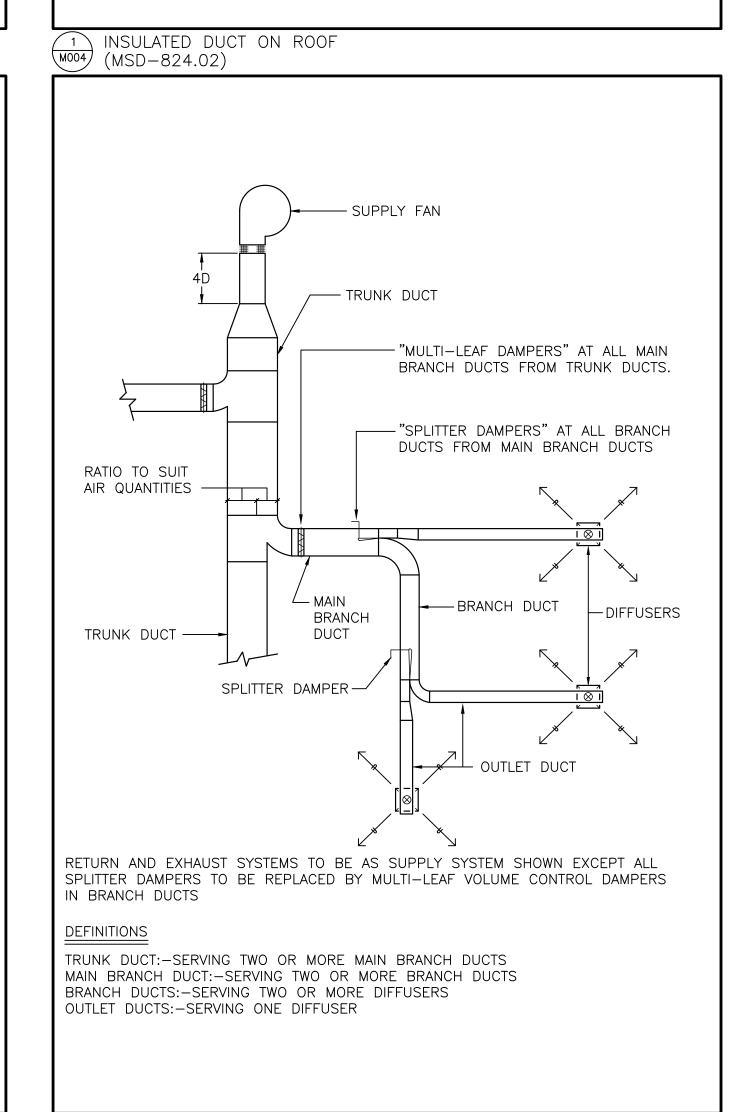

BALANCING DAMPERS (MSD-840.03)

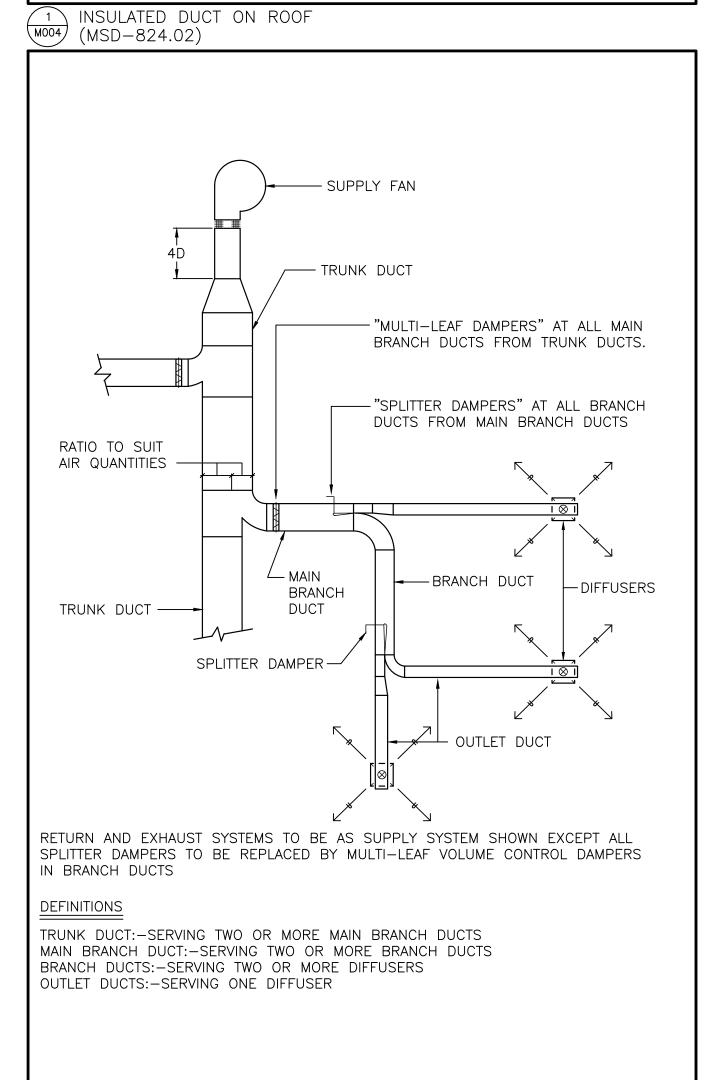





DATE

PROJECT NUMBER 21076

DRAWING NUMBER

Contractor must check and verify all dimensions on the job, and report any discrepancies to the Architect before proceeding with the work.

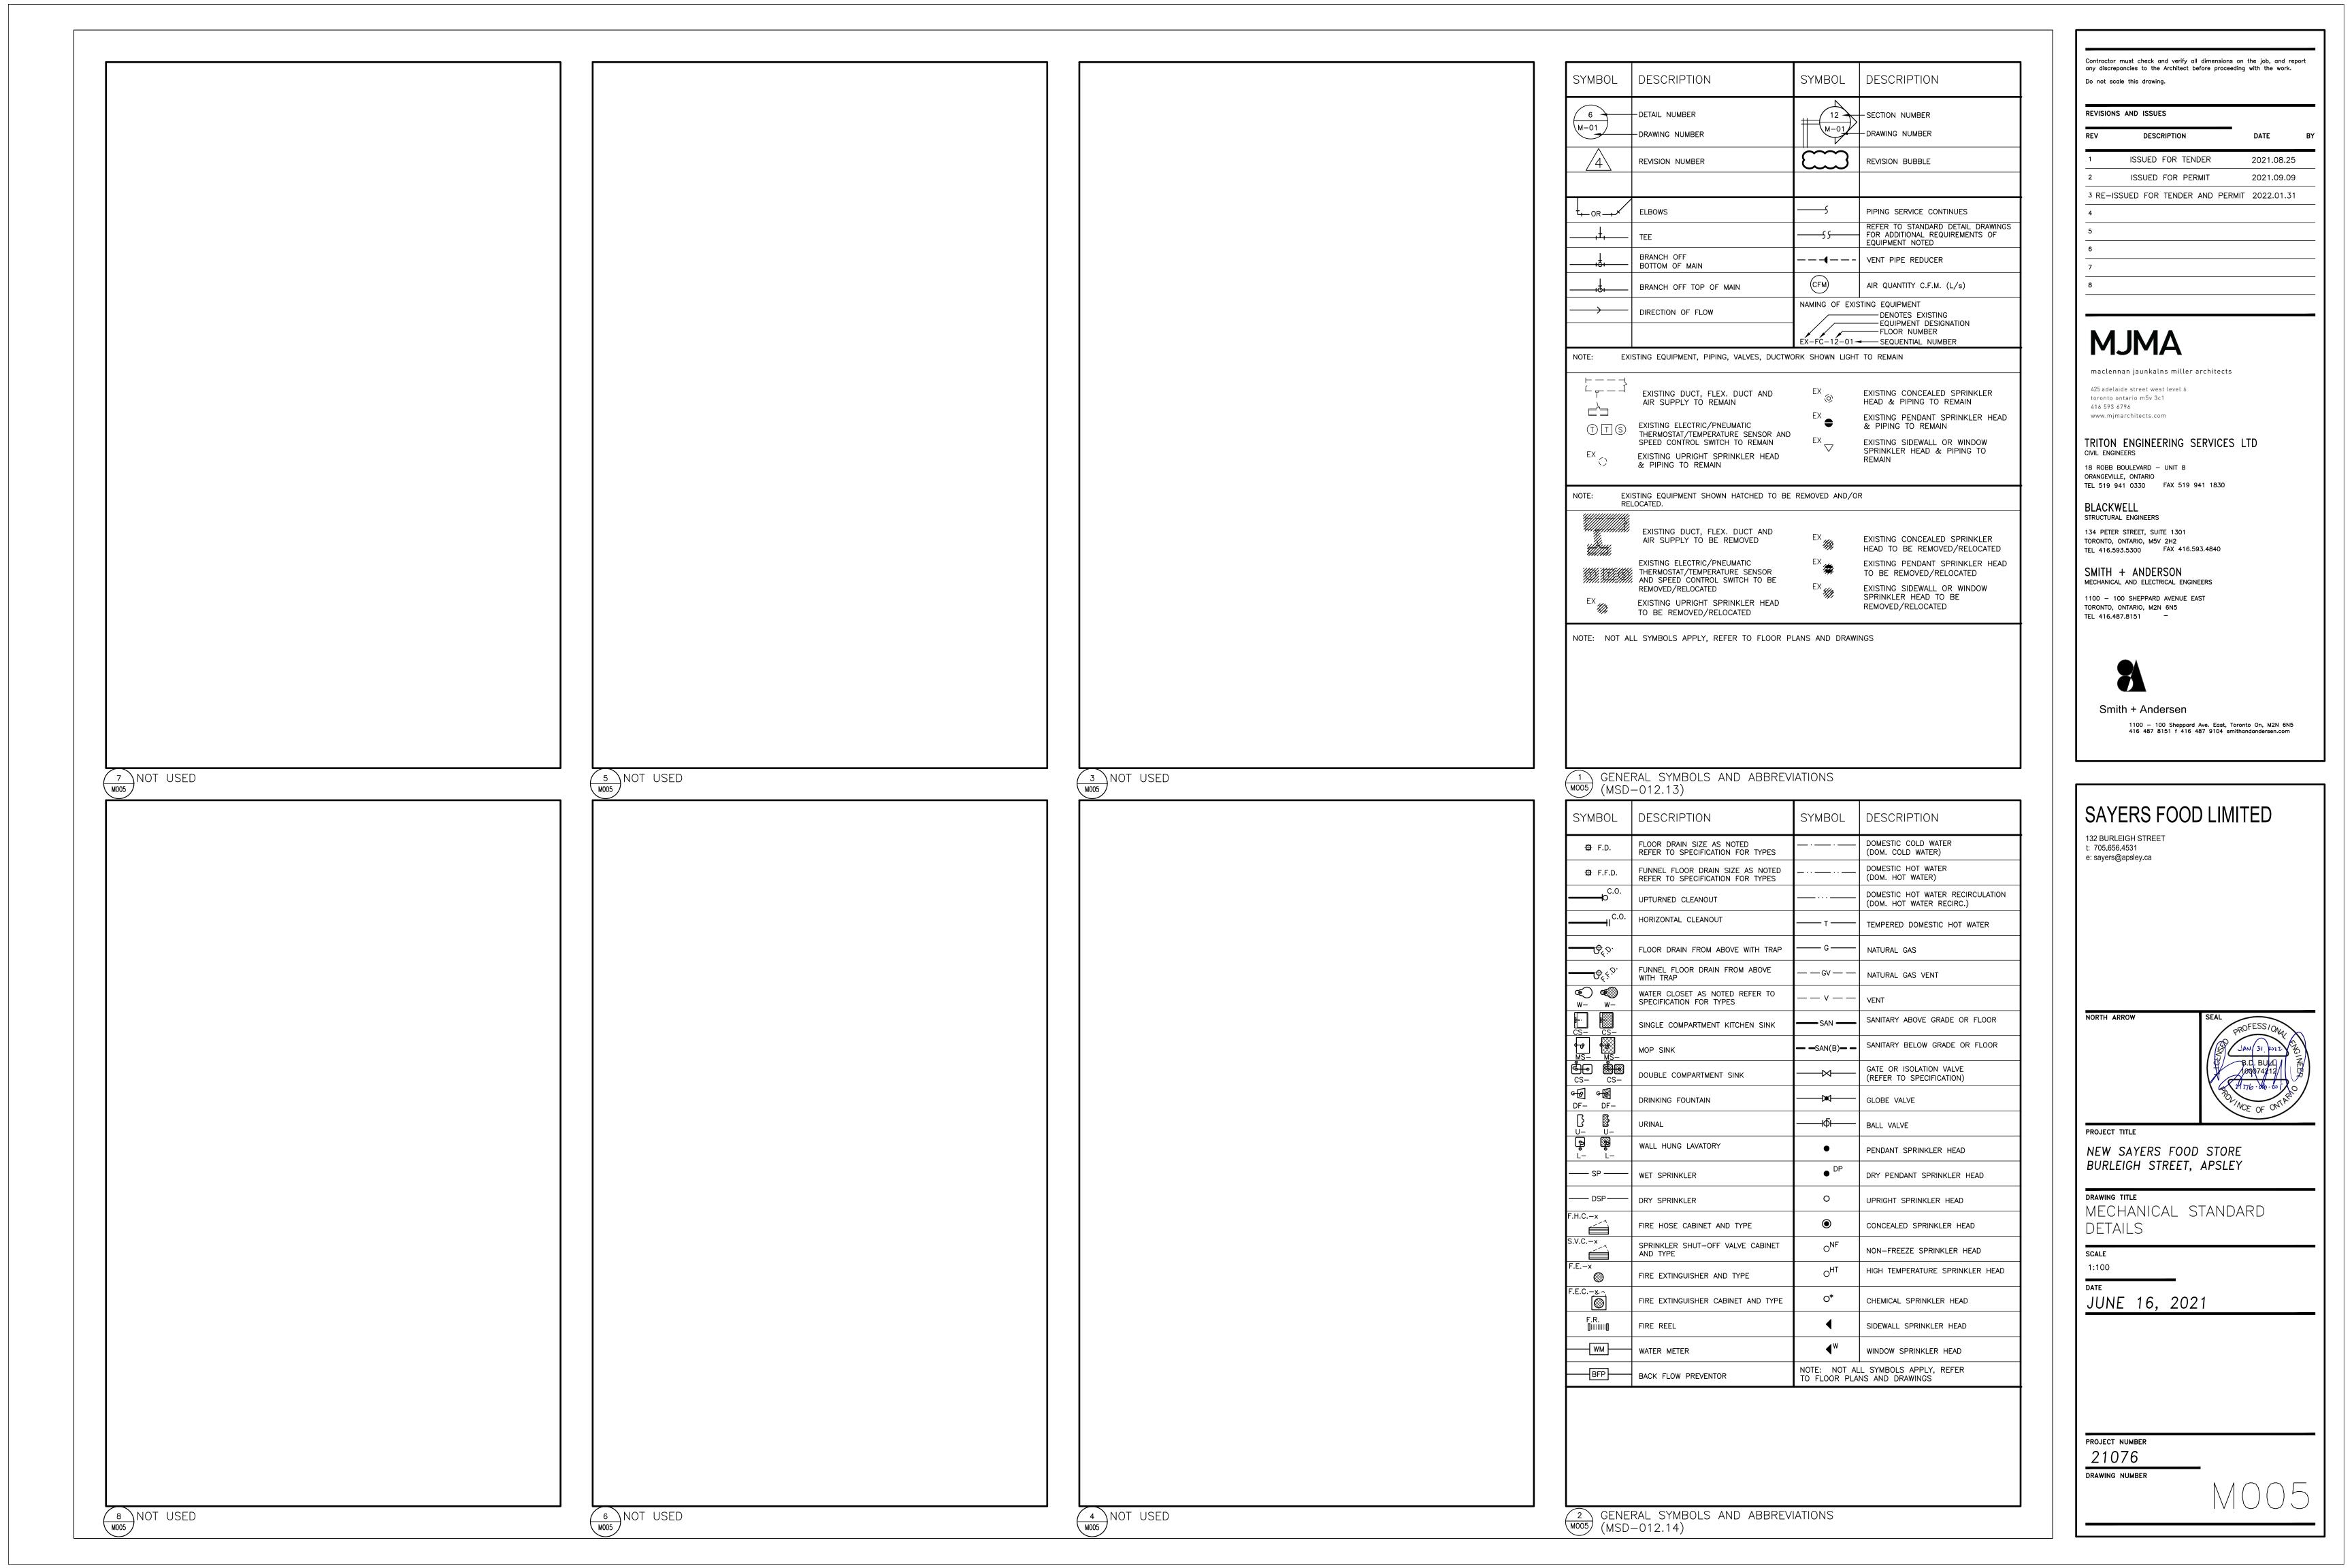

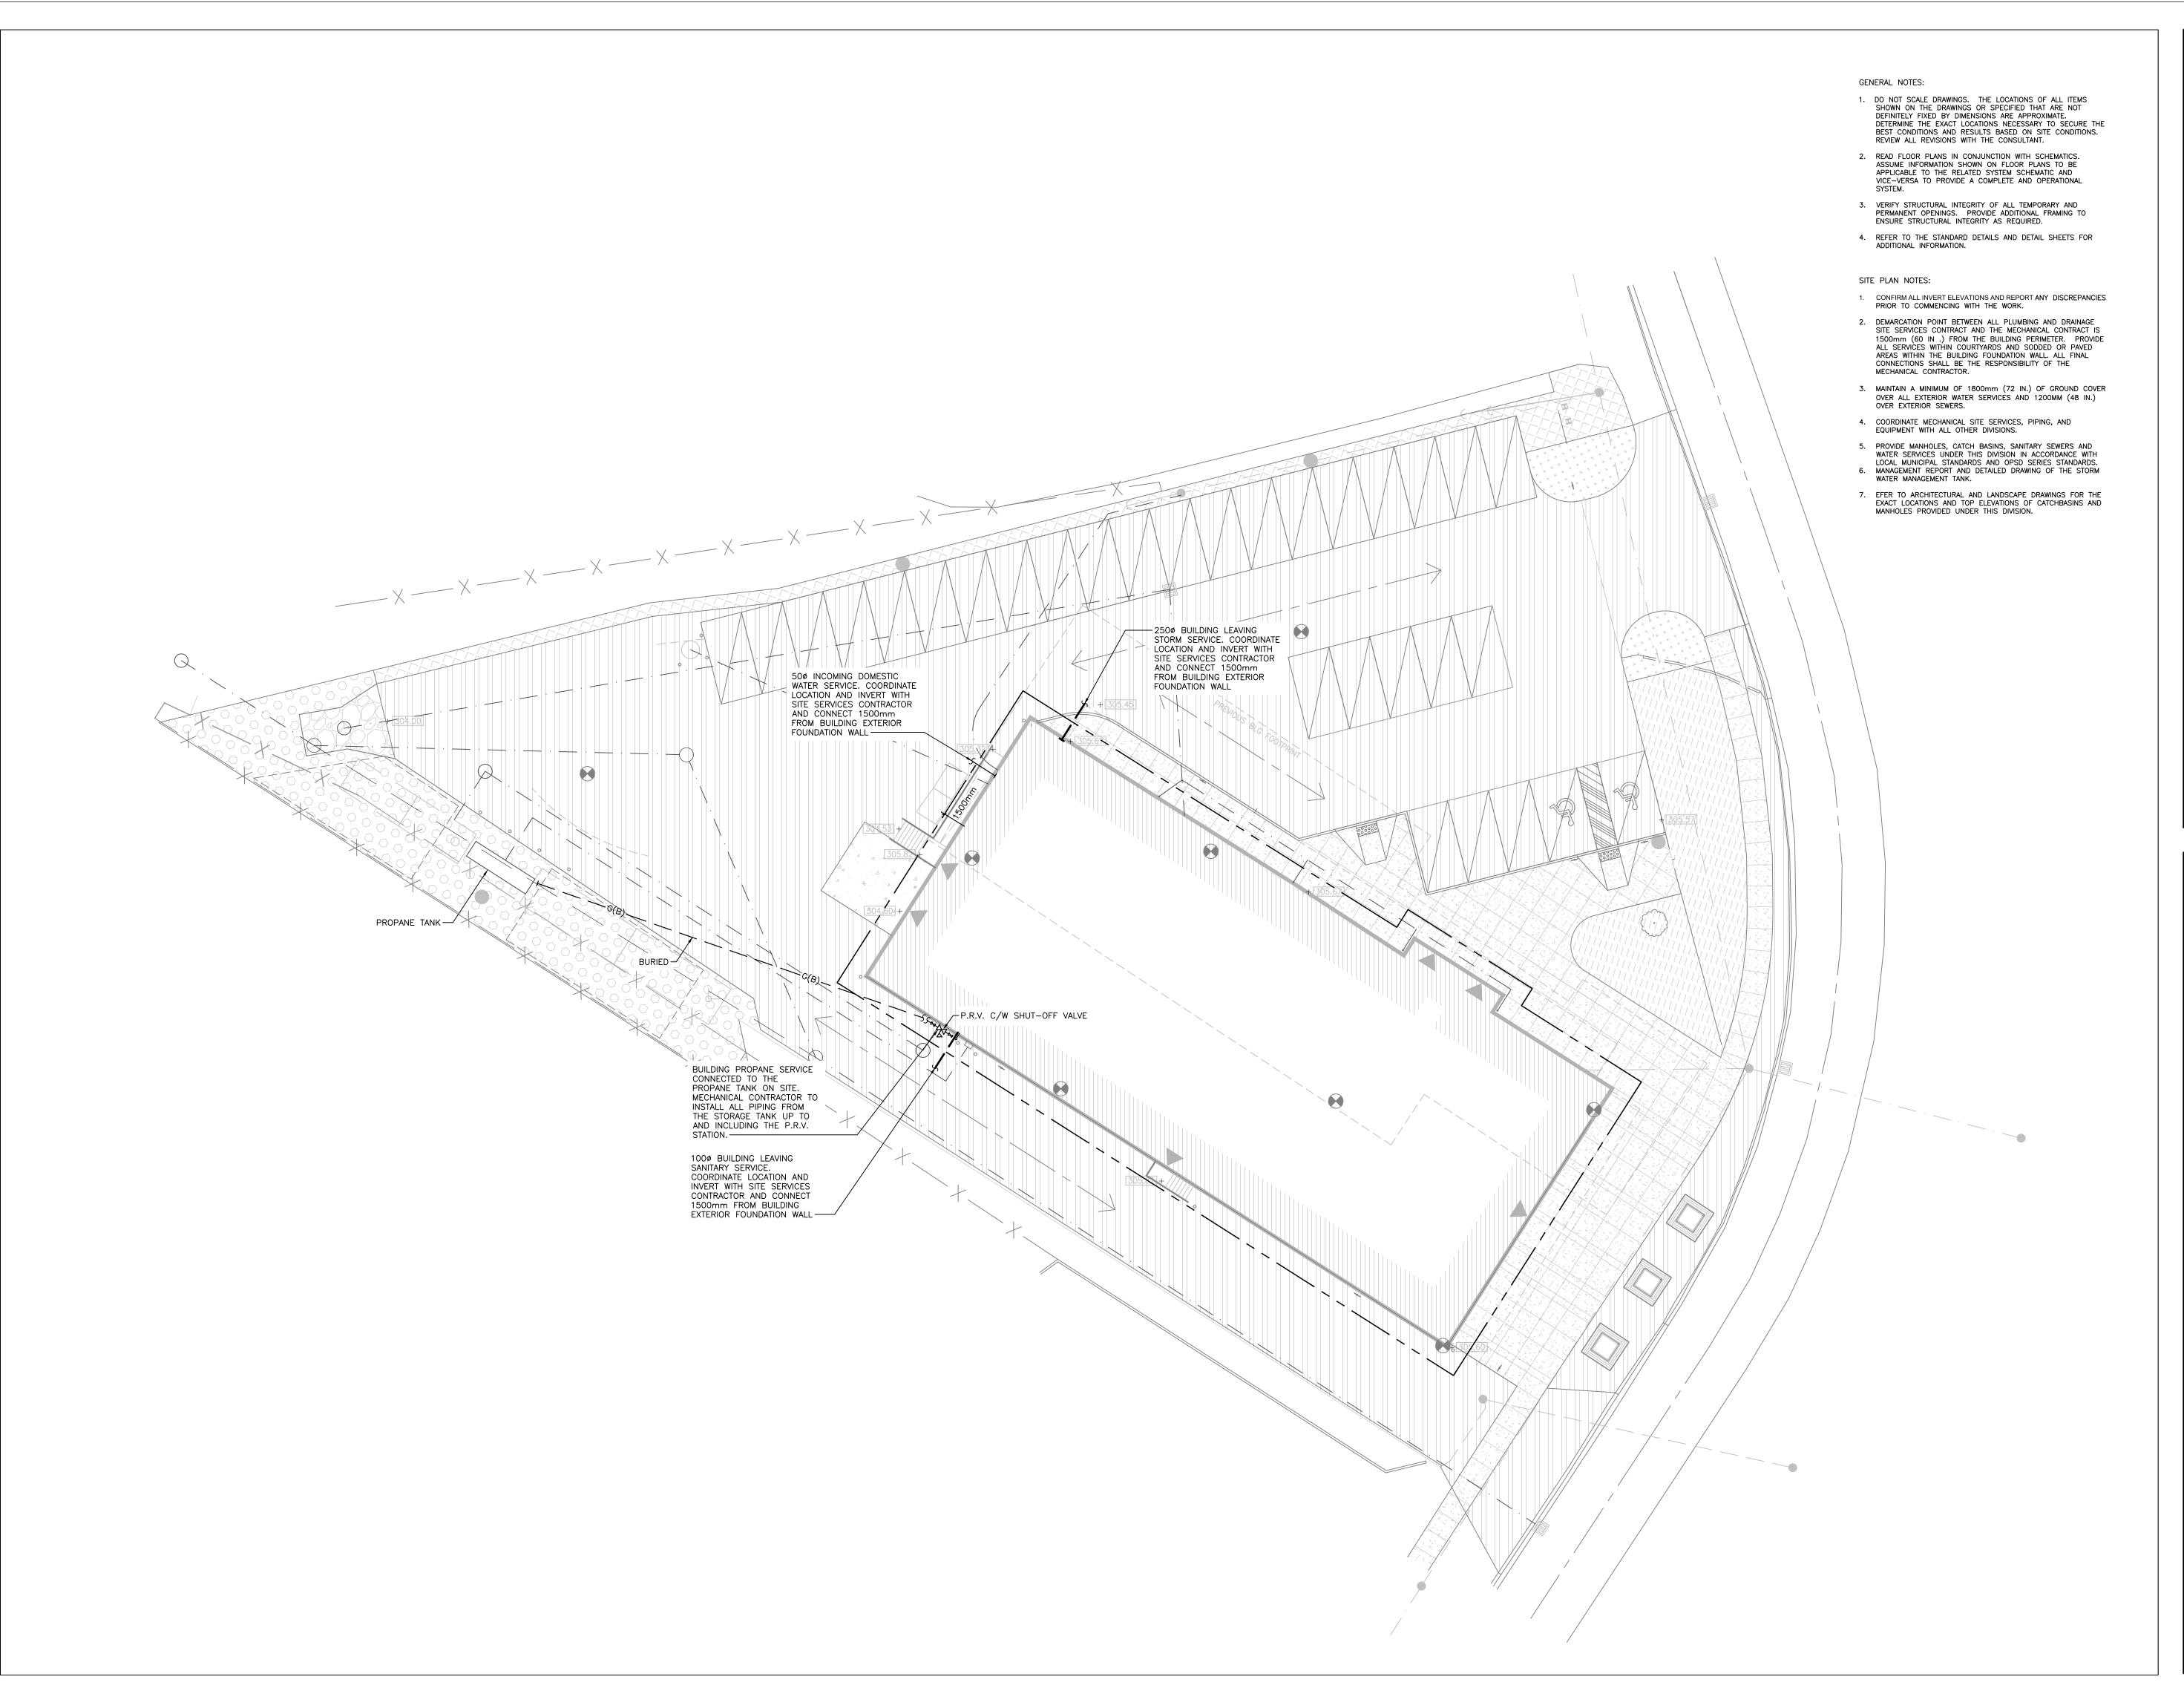

Contractor must check and verify all dimensions on the job, and report any discrepancies to the Architect before proceeding with the work. Do not scale this drawing.

REVISIONS AND ISSUES

DESCRIPTION DATE ISSUED FOR TENDER 2021.08.25

ISSUED FOR PERMIT 2021.09.09 ISSUED FOR ADDENDUM #1 2021.09.15

4 RE-ISSUED FOR TENDER AND PERMIT 2022.01.31

MJMA

maclennan jaunkalns miller architects

425 adelaide street west level 6 toronto ontario m5v 3c1 416 593 6796 www.mjmarchitects.com

TRITON ENGINEERING SERVICES LTD CIVIL ENGINEERS

18 ROBB BOULEVARD - UNIT 8

ORANGEVILLE, ONTARIO TEL 519 941 0330 FAX 519 941 1830

BLACKWELL STRUCTURAL ENGINEERS

134 PETER STREET, SUITE 1301 TORONTO, ONTARIO, M5V 2H2
TEL 416.593.5300 FAX 416.593.4840

SMITH + ANDERSON MECHANICAL AND ELECTRICAL ENGINEERS

1100 - 100 SHEPPARD AVENUE EAST TORONTO, ONTARIO, M2N 6N5 TEL 416.487.8151 -



Smith + Andersen

1100 — 100 Sheppard Ave. East, Toronto On, M2N 6N5 416 487 8151 f 416 487 9104 smithandandersen.com

SAYERS FOOD LIMITED

132 BURLEIGH STREET t: 705.656.4531 e: sayers@apsley.ca

NORTH ARROW



PROJECT TITLE

NEW SAYERS FOOD STORE BURLEIGH STREET, APSLEY


SITE PLAN MECHANICAL

SCALE 1:200

JUNE 16, 2021

PROJECT NUMBER

21076

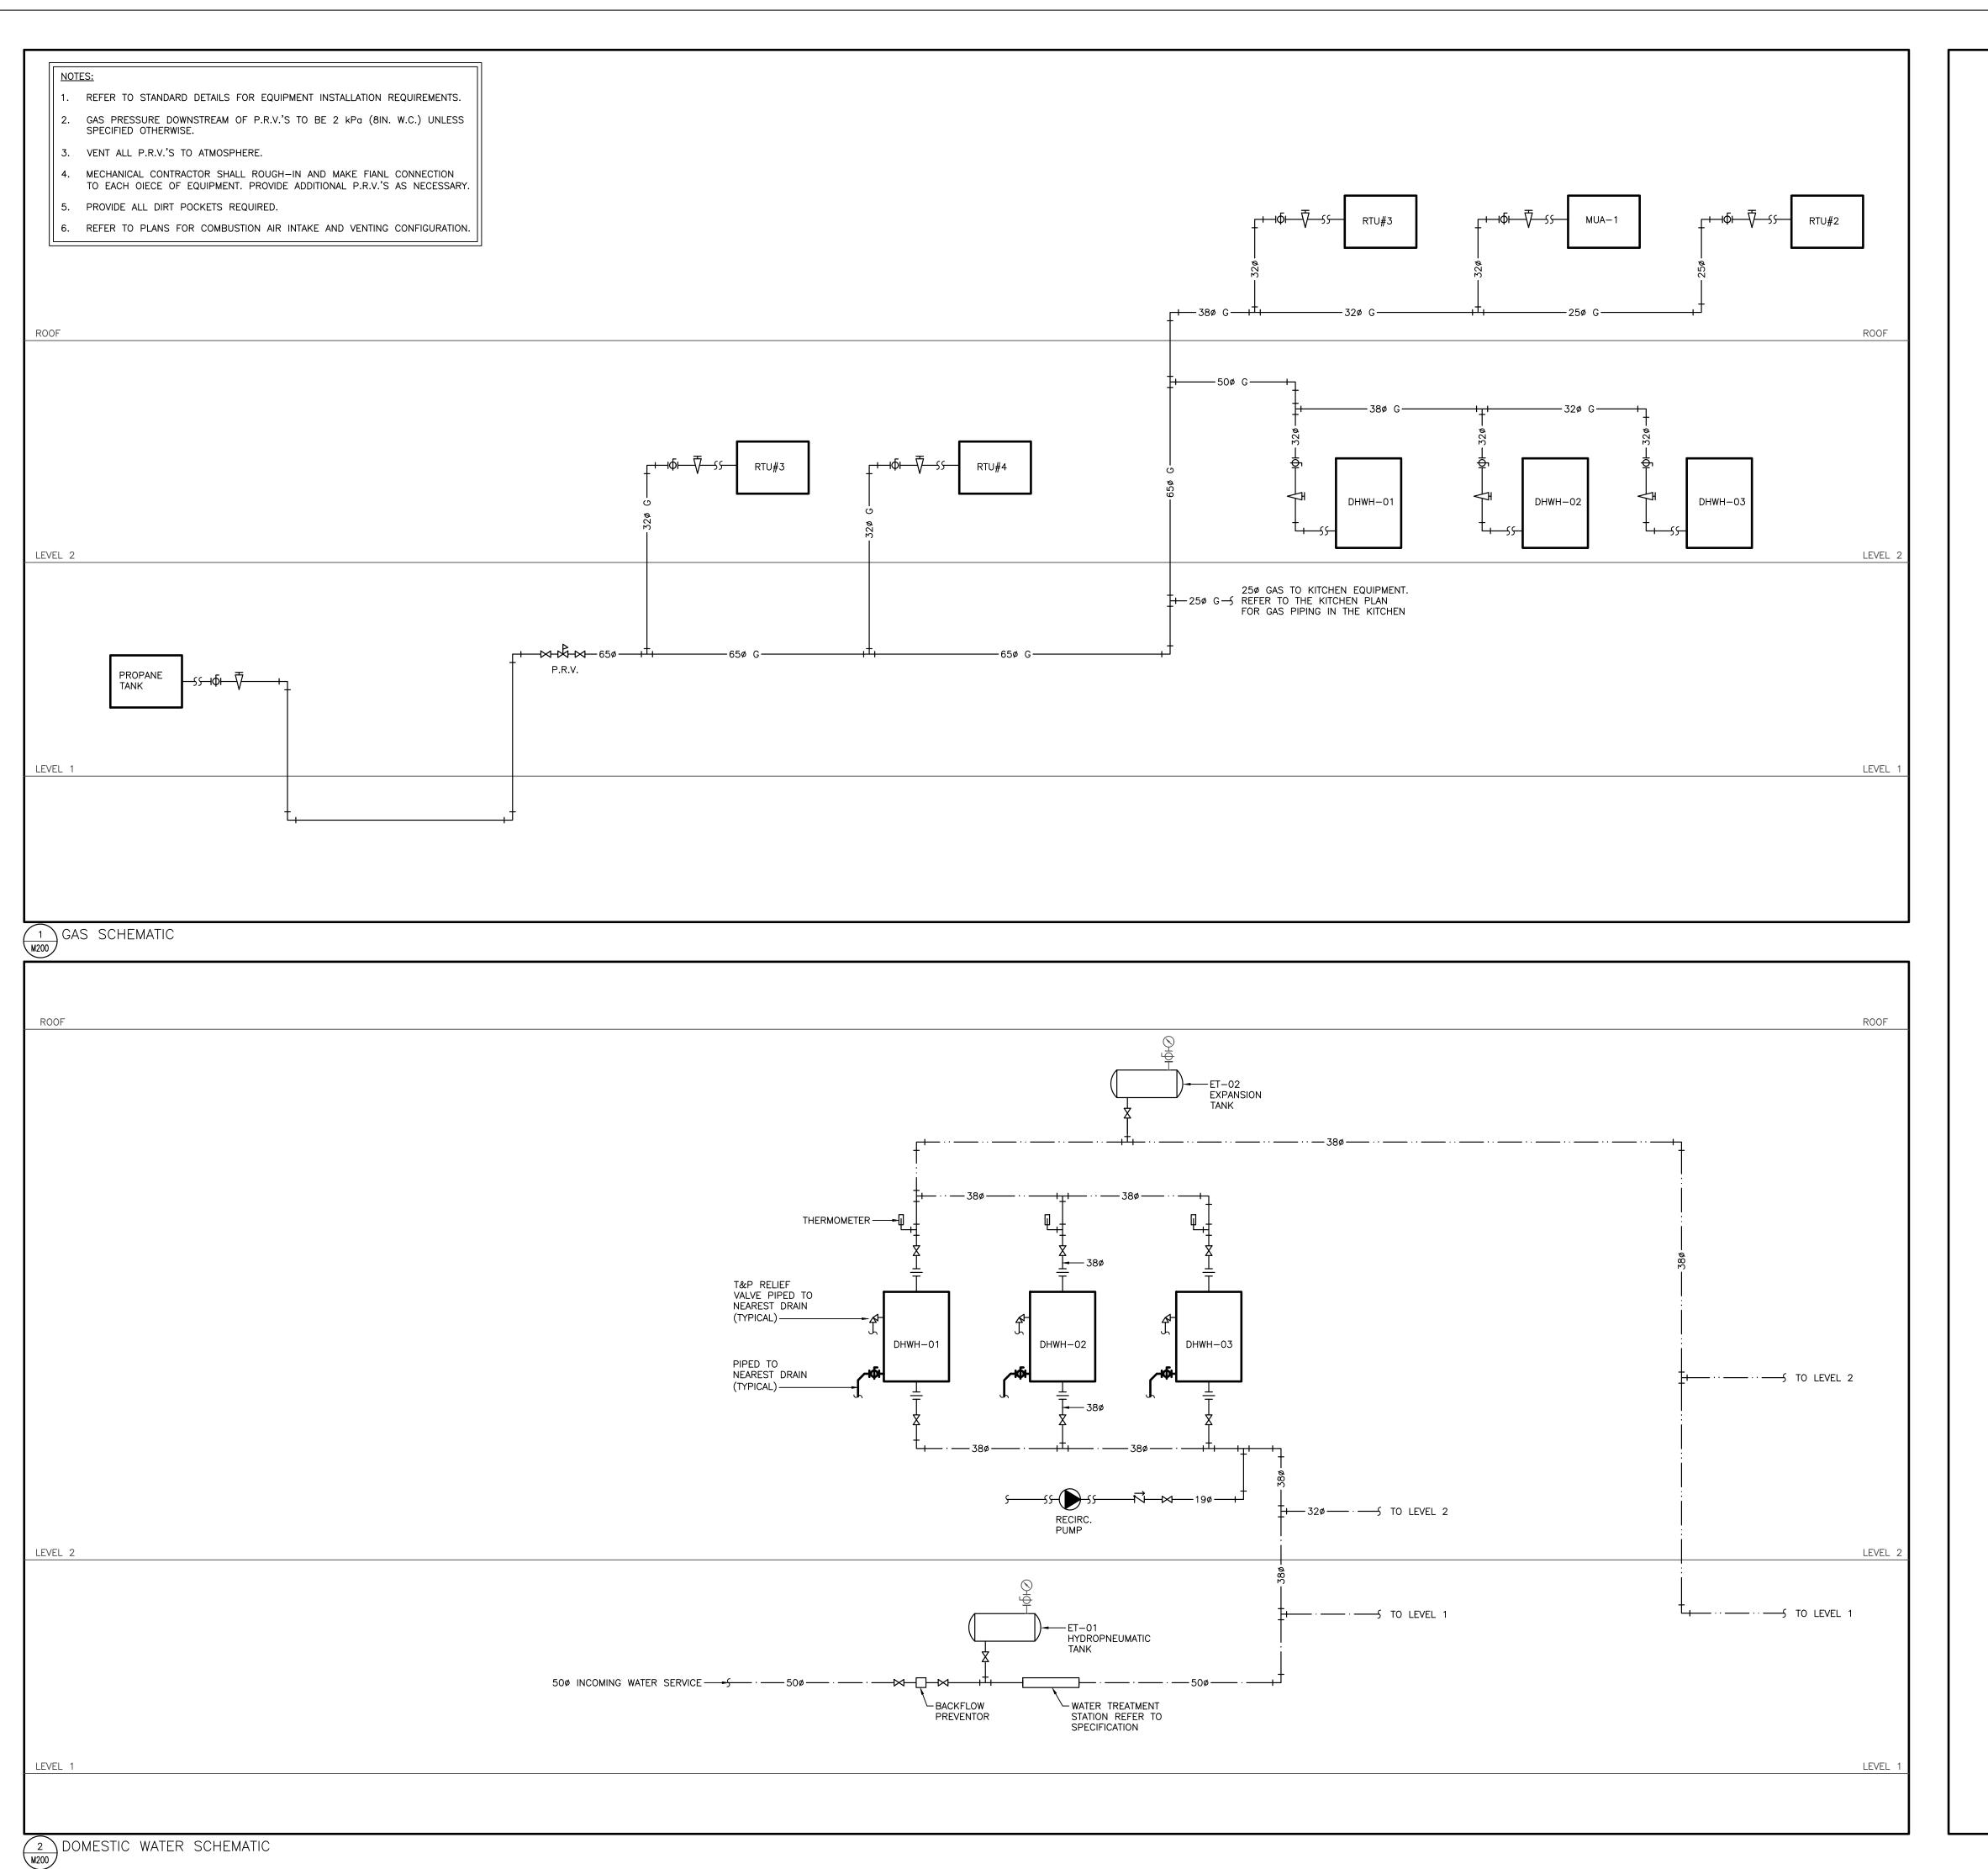

- 1. DO NOT SCALE DRAWINGS. THE LOCATIONS OF ALL ITEMS SHOWN ON THE DRAWINGS OR SPECIFIED THAT ARE NOT DEFINITELY FIXED BY DIMENSIONS ARE APPROXIMATE. DETERMINE THE EXACT LOCATIONS NECESSARY TO SECURE THE BEST CONDITIONS AND RESULTS BASED ON SITE CONDITIONS. REVIEW ALL REVISIONS WITH THE CONSULTANT.
- 2. READ FLOOR PLANS IN CONJUNCTION WITH SCHEMATICS.
 ASSUME INFORMATION SHOWN ON FLOOR PLANS TO BE
 APPLICABLE TO THE RELATED SYSTEM SCHEMATIC AND
 VICE-VERSA TO PROVIDE A COMPLETE AND OPERATIONAL
- VERIFY STRUCTURAL INTEGRITY OF ALL TEMPORARY AND PERMANENT OPENINGS. PROVIDE ADDITIONAL FRAMING TO ENSURE STRUCTURAL INTEGRITY AS REQUIRED.
- REFER TO THE STANDARD DETAILS AND DETAIL SHEETS FOR ADDITIONAL INFORMATION.

SCHEMATIC NOTES:

- READ SCHEMATICS IN CONJUNCTION WITH FLOOR PLANS. ASSUME INFORMATION SHOWN ON FLOOR PLANS TO BE APPLICABLE TO THE RELATED SYSTEM SCHEMATIC AND VICE-VERSA TO PROVIDE A COMPLETE AND OPERATIONAL SYSTEM
- VERIFY STATIC AND OPERATING PRESSURES AT ALL POINTS IN THE SYSTEMS AND ENSURE PIPING, FITTINGS, COMPONENTS, ETC. ARE SUITABLE FOR THESE CONDITIONS.
- 3. HANGERS, SUPPORTS, ANCHORS, GUIDES AND RESTRAINTS, WHERE INDICATED, ARE SHOWN FOR GUIDANCE ONLY. ENSURE ALL COMPONENTS ARE LOCATED AND DESIGNED TO WITHSTAND ALL STATIC AND DYNAMIC FORCES. PROVIDE SHOP DRAWINGS SEALED BY A PROFESSIONAL ENGINEER. REFER TO THE SPECIFICATION FOR DETAILS. PROVIDE INTERMEDIATE GUIDES AS
- PROVIDE TYPE CV-1 CONTROL VALVES UNLESS INDICATED OTHERWISE.

Contractor must check and verify all dimensions on the job, and report any discrepancies to the Architect before proceeding with the work.

Do not scale this drawing.

REVISIONS AND ISSUES

REV	DESCRIPTION	DATE
1	ISSUED FOR TENDER	2021.08.25

2 ISSUED FOR PERMIT 2021.09.09

3 RE-ISSUED FOR TENDER AND PERMIT 2022.01.31

 4

 5

 6

MJMA

maclennan jaunkalns miller architects

425 adelaide street west level 6 toronto ontario m5v 3c1 416 593 6796 www.mjmarchitects.com

TRITON ENGINEERING SERVICES LTD CIVIL ENGINEERS

18 ROBB BOULEVARD — UNIT 8
ORANGEVILLE, ONTARIO
TEL 519 941 0330 FAX 519 941 1830

BLACKWELL

STRUCTURAL ENGINEERS

134 PETER STREET, SUITE 1301
TORONTO, ONTARIO, M5V 2H2

TEL 416.593.5300 FAX 416.593.4840

SMITH + ANDERSON MECHANICAL AND ELECTRICAL ENGINEERS

1100 – 100 SHEPPARD AVENUE EAST TORONTO, ONTARIO, M2N 6N5



TEL 416.487.8151 -


Smith + Andersen

1100 — 100 Sheppard Ave. East, Toronto On, M2N 6N5 416 487 8151 f 416 487 9104 smithandandersen.com

SAYERS FOOD LIMITED

132 BURLEIGH STREET t: 705.656.4531 e: sayers@apsley.ca

NORTH ARROW

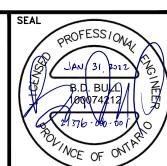

PROJECT TITLE

NEW SAYERS FOOD STORE BURLEIGH STREET, APSLEY

WING TITLE

MECHANICAL SCHEMATICS

SCALE N.T.S.


JUNE 16, 2021


PROJECT NUMBER

21076

DRAWING NUMBER

M200

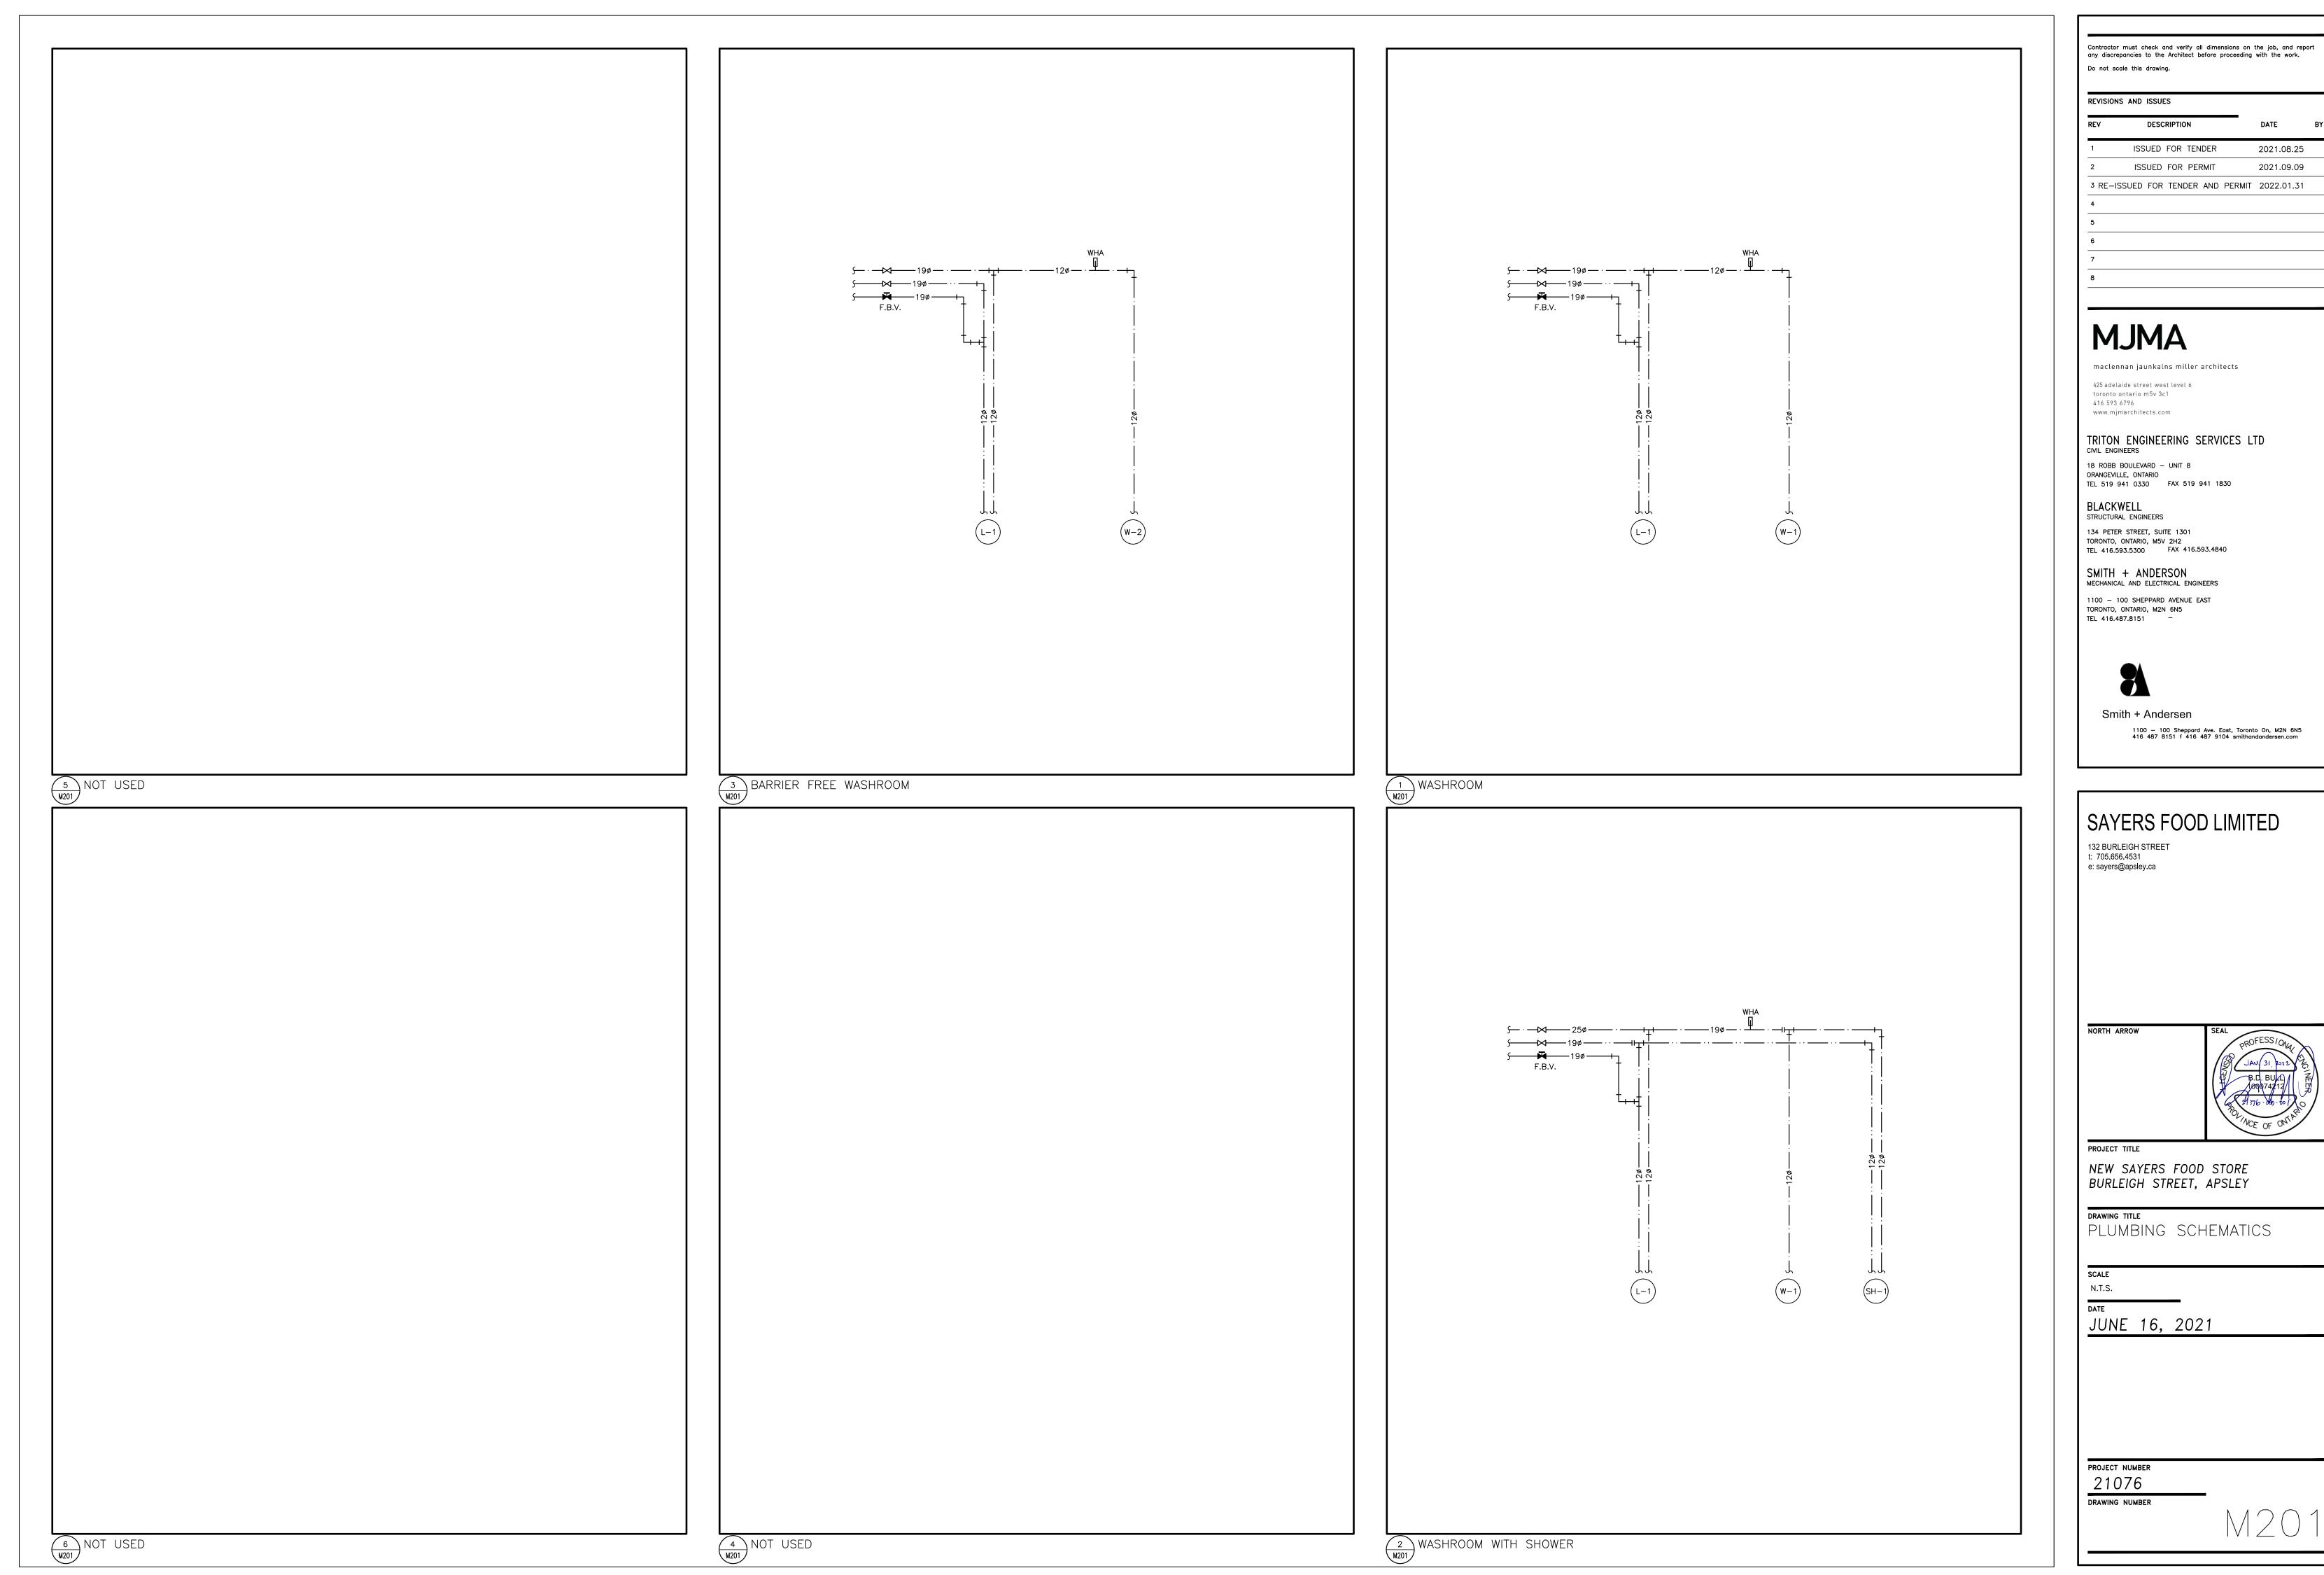

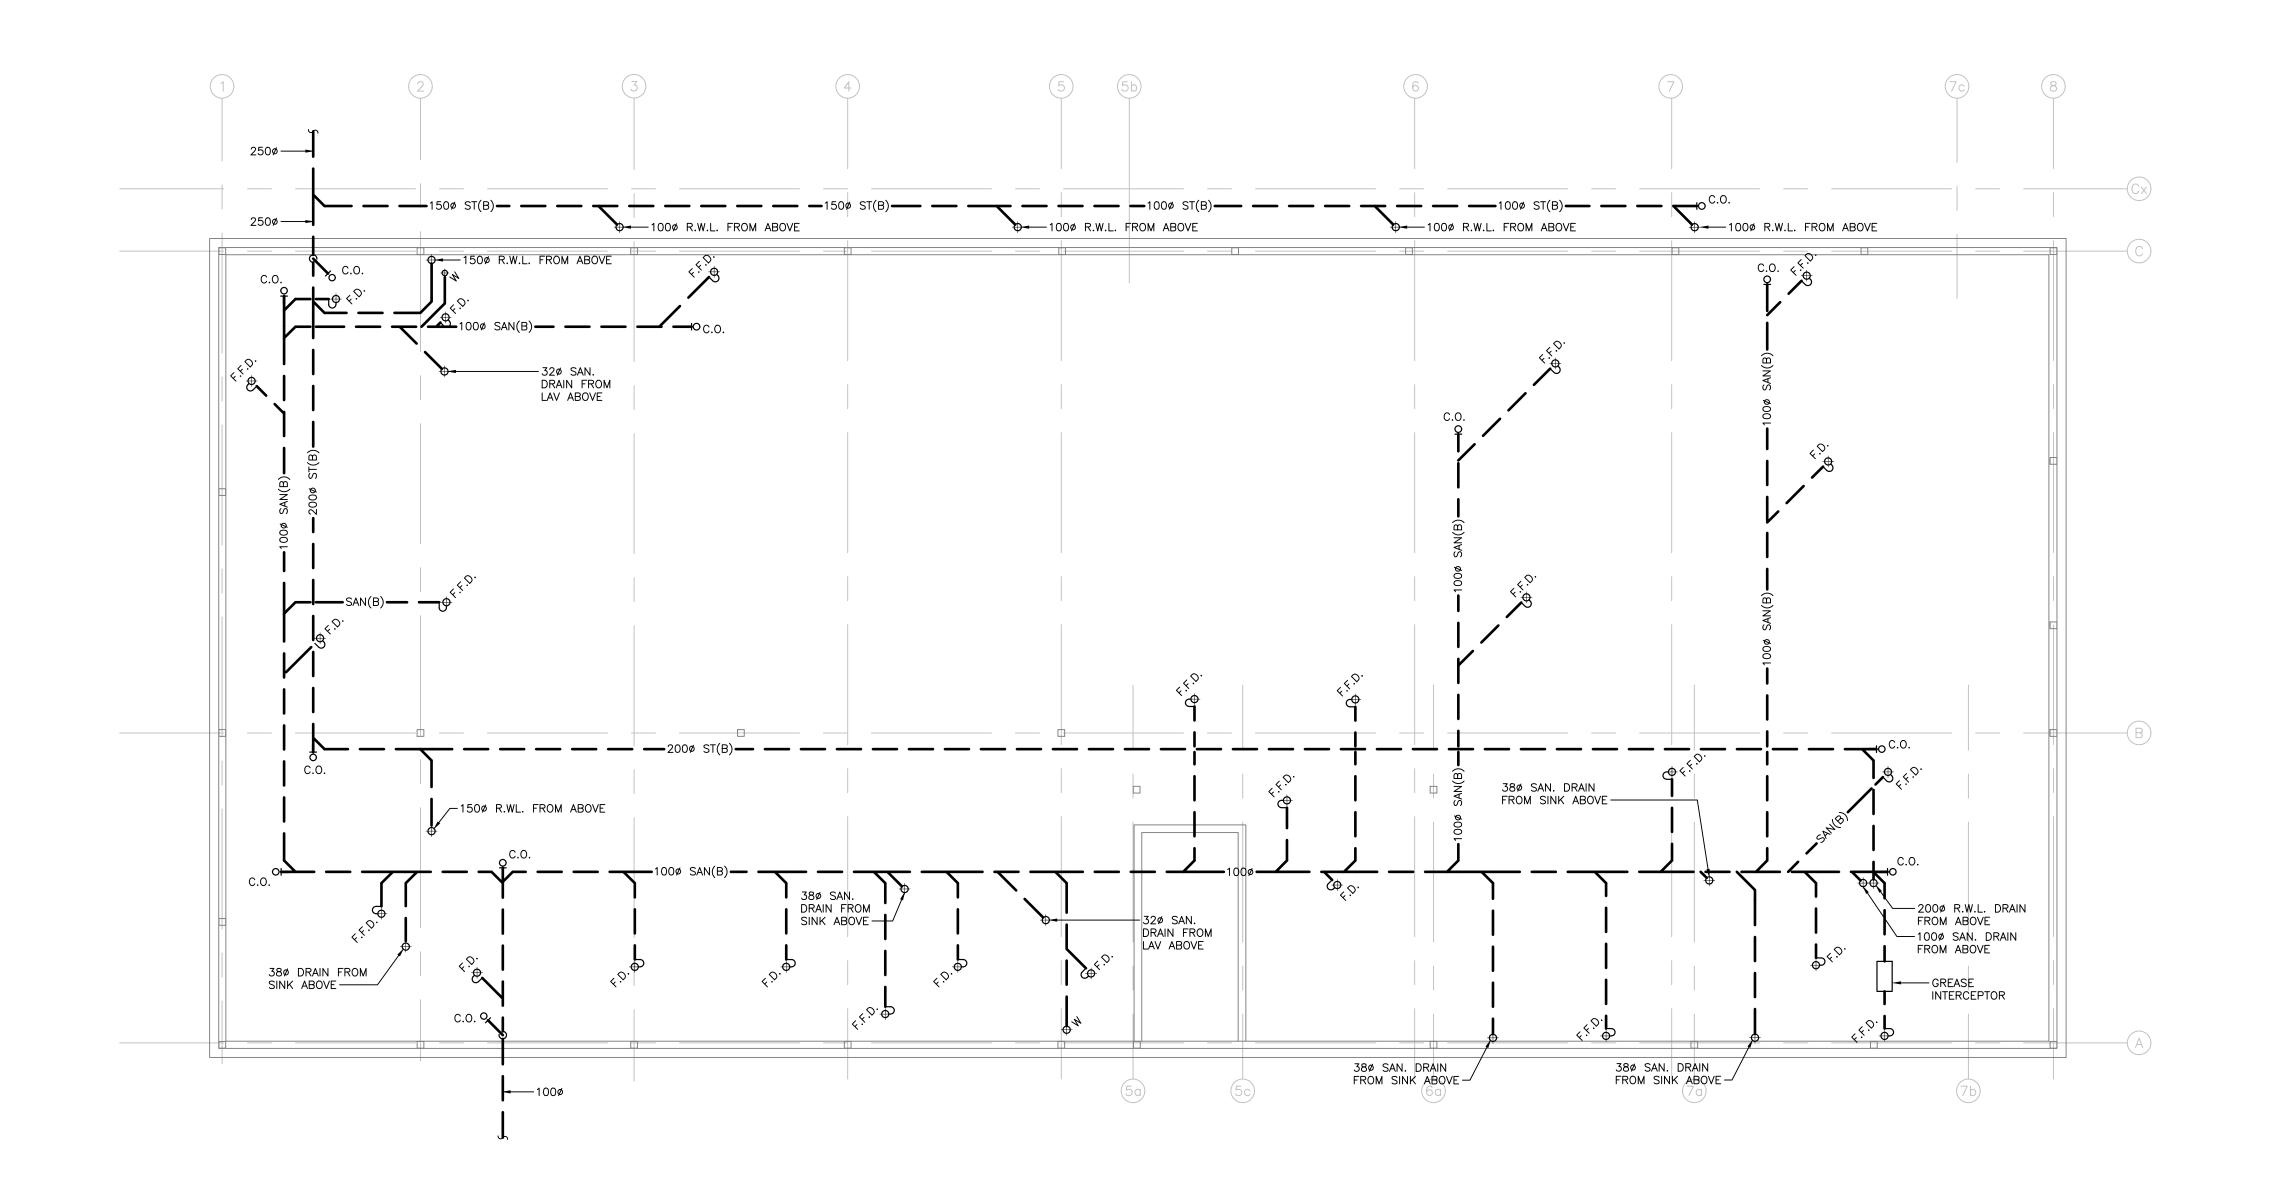

- DO NOT SCALE DRAWINGS. THE LOCATIONS OF ALL ITEMS SHOWN ON THE DRAWINGS OR SPECIFIED THAT ARE NOT DEFINITELY FIXED BY DIMENSIONS ARE APPROXIMATE. DETERMINE THE EXACT LOCATIONS NECESSARY TO SECURE THE BEST CONDITIONS AND RESULTS BASED ON SITE CONDITIONS. REVIEW ALL REVISIONS WITH THE CONSULTANT.
- APPLICABLE TO THE RELATED SYSTEM SCHEMATIC AND VICE-VERSA TO PROVIDE A COMPLETE AND OPERATIONAL SYSTEM.

PLUMBING AND DRAINAGE NOTES:

- PROVIDE MINIMUM 75mm (3 IN.) FOR UNDER GROUND SANITARY DRAINAGE UNLESS INDICATED OTHERWISE.
 PROVIDE APPROVED BACK FLOW PREVENTION FOR ALL TRAP PRIMER SYSTEMS.
- PROVIDE MINIMUM 100mm (4 IN.) FOR UNDER GROUND STORM DRAINAGE UNLESS INDICATED OTHERWISE.
- 4. PROVIDE MINIMUM 19mm (3/4 IN.) DOMESTIC COLD WATER AND DOMESTIC HOT WATER PIPES UNLESS INDICATED
- 5. INSTALL ALL PIPING OVERHEAD, TIGHT TO UNDERSIDE OF THE STRUCTURE WITH SUFFICIENT ROOM FOR INSULATION UNLESS INDICATED OTHERWISE. ROUTE PIPING WITHIN STRUCTURAL STEEL STRATA OR THROUGH CONCRETE BEAMS WHERE
- 6. HEAT TRACE THE ENTIRE SERVICE TO BE PROTECTED FROM FREEZING IN ALL AREAS INDICATED ON THE DRAWINGS AND NOTED IN THE SPECIFICATIONS. PROVIDE HEAT TRACING TO ACCOMMODATE ALTERATIONS IN THE PIPE LAYOUT DUE TO INTERFERENCES OR OTHER INSTALLATION REQUIREMENTS.
 CONNECT HEAT TRACING CIRCUIT TO THE ELECTRICAL POWER
 LOCATIONS INDICATED ON THE DRAWINGS OR THE NEAREST CIRCUIT AVAILABLE. COORDINATE WITH ELECTRICAL DIVISION.

 7. PROVIDE SHUT—OFF VALVES ON ALL MAIN RISERS AND AT EACH CONNECTION TO EQUIPMENT.
- 8. PROVIDE COMPLETE VENTING SYSTEMS IN ACCORDANCE WITH

THE PLUMBING OR BUILDING CODE.

9. HEAT TRACE ALL PIPING WITHIN UNHEATED SPACES SUCH AS PARKING LEVELS, SOFFITS AND WITHIN WALLS WHERE FREEZING MAY OCCUR.

- 2. READ FLOOR PLANS IN CONJUNCTION WITH SCHEMATICS. ASSUME INFORMATION SHOWN ON FLOOR PLANS TO BE
- VERIFY STRUCTURAL INTEGRITY OF ALL TEMPORARY AND PERMANENT OPENINGS. PROVIDE ADDITIONAL FRAMING TO ENSURE STRUCTURAL INTEGRITY AS REQUIRED.
- REFER TO THE STANDARD DETAILS AND DETAIL SHEETS FOR ADDITIONAL INFORMATION.

Do not scale this drawing.

REVISIONS AND ISSUES

DESCRIPTION

ISSUED FOR TENDER

ISSUED FOR PERMIT

ISSUED FOR ADDENDUM #1

ISSUED FOR ADDENDUM #2 2021.09.27

5 RE-ISSUED FOR TENDER AND PERMIT 2022.01.31

maclennan jaunkalns miller architects

toronto ontario m5v 3c1 416 593 6796 www.mjmarchitects.com

TRITON ENGINEERING SERVICES LTD CIVIL ENGINEERS

Contractor must check and verify all dimensions on the job, and report any discrepancies to the Architect before proceeding with the work.

DATE

2021.08.25

2021.09.09

2021.09.15

18 ROBB BOULEVARD - UNIT 8

ORANGEVILLE, ONTARIO TEL 519 941 0330 FAX 519 941 1830

BLACKWELL STRUCTURAL ENGINEERS

134 PETER STREET, SUITE 1301 TORONTO, ONTARIO, M5V 2H2 TEL 416.593.5300 FAX 416.593.4840

SMITH + ANDERSON MECHANICAL AND ELECTRICAL ENGINEERS

1100 - 100 SHEPPARD AVENUE EAST TORONTO, ONTARIO, M2N 6N5



TEL 416.487.8151 -


Smith + Andersen

1100 — 100 Sheppard Ave. East, Toronto On, M2N 6N5 416 487 8151 f 416 487 9104 smithandandersen.com

SAYERS FOOD LIMITED

132 BURLEIGH STREET t: 705.656.4531 e: sayers@apsley.ca

NORTH ARROW

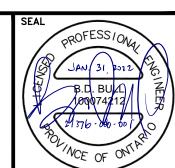

PROJECT TITLE


NEW SAYERS FOOD STORE BURLEIGH STREET, APSLEY

DRAWING TITLE

FOUNDATION PLAN PLUMBING AND DRAINAGE

JUNE 16, 2021

PROJECT NUMBER 21076

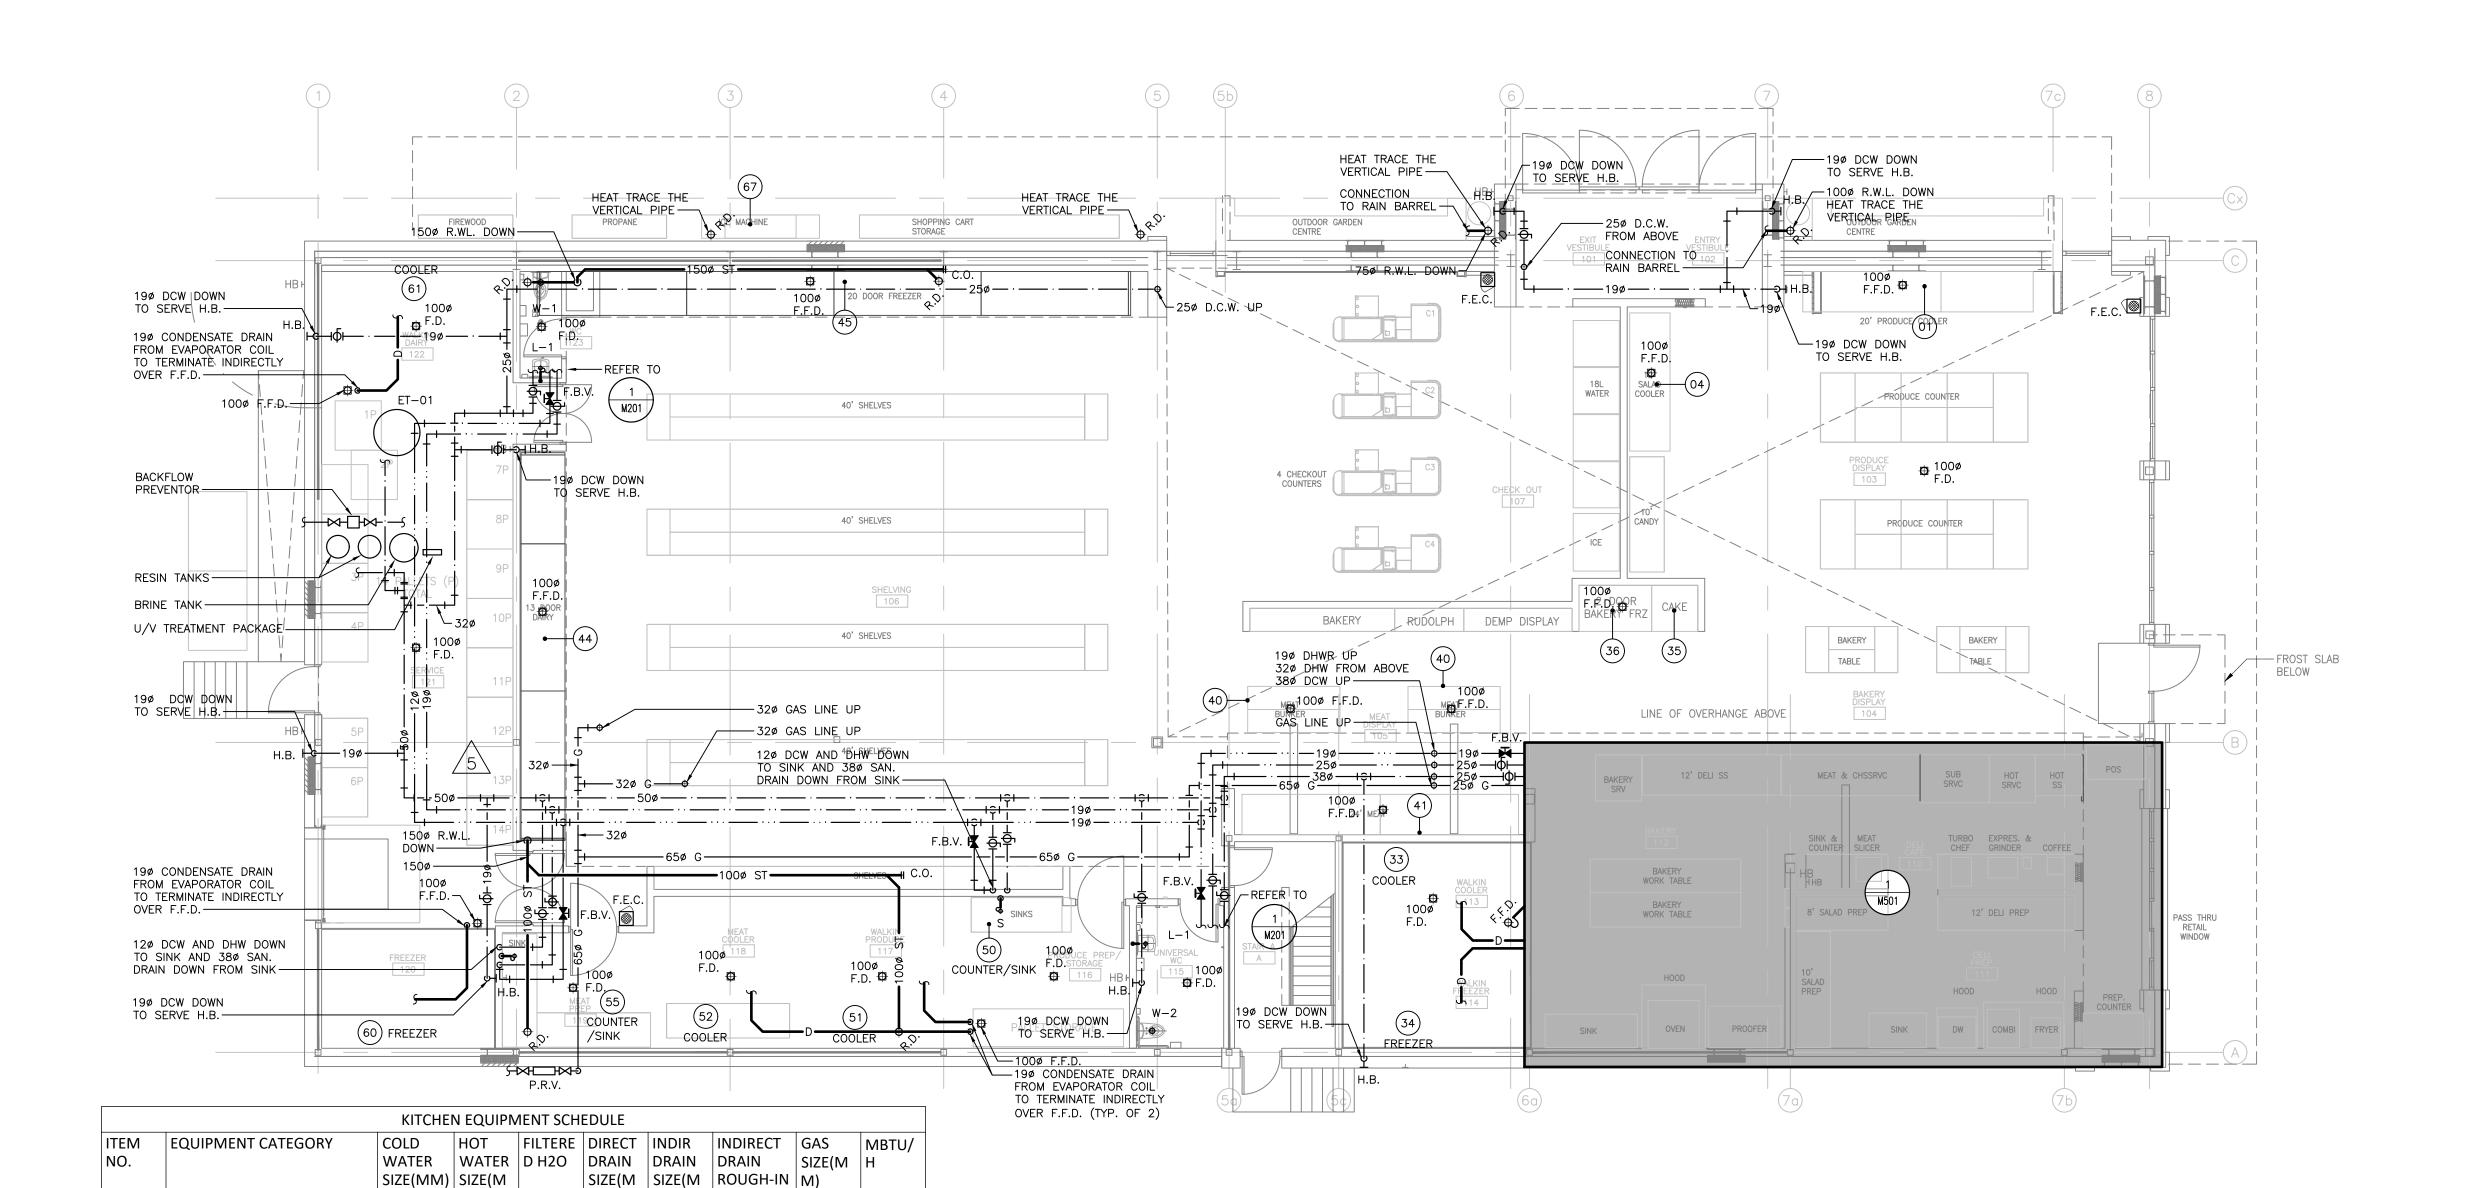

12' PRODUCE COOLER

8' PRODUCE COOLER

2 DOOR BAKERY FREEZER

5 DOOR DAIRY SHELVING

3 DOOR DAIRY SHELVING

5 DOOR FREEZER SHELVING

12

12

12

12

12' SALAD COOLER

24' MEAT SHELF

COUNTER/SINK

COUNTER/SINKS

COOLER

COOLER

FREEZER

COOLER

CAKE

FFD

FFD

FD

FD

FD

FD

38

38

25

25

38

38

38

GENERAL NOTES:

- 1. DO NOT SCALE DRAWINGS. THE LOCATIONS OF ALL ITEMS SHOWN ON THE DRAWINGS OR SPECIFIED THAT ARE NOT DEFINITELY FIXED BY DIMENSIONS ARE APPROXIMATE. DETERMINE THE EXACT LOCATIONS NECESSARY TO SECURE THE BEST CONDITIONS AND RESULTS BASED ON SITE CONDITIONS. REVIEW ALL REVISIONS WITH THE CONSULTANT.
- READ FLOOR PLANS IN CONJUNCTION WITH SCHEMATICS. ASSUME INFORMATION SHOWN ON FLOOR PLANS TO BE APPLICABLE TO THE RELATED SYSTEM SCHEMATIC AND VICE-VERSA TO PROVIDE A COMPLETE AND OPERATIONAL SYSTEM.
- VERIFY STRUCTURAL INTEGRITY OF ALL TEMPORARY AND PERMANENT OPENINGS. PROVIDE ADDITIONAL FRAMING TO ENSURE STRUCTURAL INTEGRITY AS REQUIRED.
- 4. REFER TO THE STANDARD DETAILS AND DETAIL SHEETS FOR ADDITIONAL INFORMATION.

PLUMBING AND DRAINAGE NOTES:

- PROVIDE MINIMUM 75mm (3 IN.) FOR UNDER GROUND SANITARY DRAINAGE UNLESS INDICATED OTHERWISE.
 PROVIDE APPROVED BACK FLOW PREVENTION FOR ALL TRAP
- PROVIDE MINIMUM 100mm (4 IN.) FOR UNDER GROUND STORM DRAINAGE UNLESS INDICATED OTHERWISE.
- PROVIDE MINIMUM 19mm (3/4 IN.) DOMESTIC COLD WATER
 AND DOMESTIC HOT WATER PIPES UNLESS INDICATED
- 5. INSTALL ALL PIPING OVERHEAD, TIGHT TO UNDERSIDE OF THE STRUCTURE WITH SUFFICIENT ROOM FOR INSULATION UNLESS INDICATED OTHERWISE. ROUTE PIPING WITHIN STRUCTURAL STEEL STRATA OR THROUGH CONCRETE BEAMS WHERE
- 6. HEAT TRACE THE ENTIRE SERVICE TO BE PROTECTED FROM FREEZING IN ALL AREAS INDICATED ON THE DRAWINGS AND NOTED IN THE SPECIFICATIONS. PROVIDE HEAT TRACING TO ACCOMMODATE ALTERATIONS IN THE PIPE LAYOUT DUE TO INTERFERENCES OR OTHER INSTALLATION REQUIREMENTS. CONNECT HEAT TRACING CIRCUIT TO THE ELECTRICAL POWER LOCATIONS INDICATED ON THE DRAWINGS OR THE NEAREST CIRCUIT AVAILABLE. COORDINATE WITH ELECTRICAL DIVISION.
 7. PROVIDE SHUT—OFF VALVES ON ALL MAIN RISERS AND AT EACH
- 8. PROVIDE COMPLETE VENTING SYSTEMS IN ACCORDANCE WITH THE PLUMBING OR BUILDING CODE.
- HEAT TRACE ALL PIPING WITHIN UNHEATED SPACES SUCH AS PARKING LEVELS, SOFFITS AND WITHIN WALLS WHERE FREEZING MAY OCCUR.

Contractor must check and verify all dimensions on the job, and report any discrepancies to the Architect before proceeding with the work.

Do not scale this drawing.

oot scale this drawing.

REV	DESCRIPTION	DATE	E
1	ISSUED FOR TENDER	2021.08.25	
2	ISSUED FOR PERMIT	2021.09.09	
3	ISSUED FOR ADDENDUM #1	2021.09.15	
4	ISSUED FOR ADDENDUM #2	2021.09.27	
5 RE	-ISSUED FOR TENDER AND PERMIT	2022.01.31	

MJMA

maclennan jaunkalns miller architects

425 adelaide street west level 6 toronto ontario m5v 3c1 416 593 6796 www.mjmarchitects.com

TRITON ENGINEERING SERVICES LTD

CIVIL ENGINEERS

18 ROBB BOULEVARD — UNIT 8

ORANGEVILLE, ONTARIO TEL 519 941 0330 FAX 519 941 1830

BLACKWELL STRUCTURAL ENGINEERS

134 PETER STREET, SUITE 1301 TORONTO, ONTARIO, M5V 2H2 TEL 416.593.5300 FAX 416.593.4840

SMITH + ANDERSON MECHANICAL AND ELECTRICAL ENGINEERS

1100 - 100 SHEPPARD AVENUE EAST TORONTO, ONTARIO, M2N 6N5 TEL 416.487.8151 -




Smith + Andersen

1100 - 100 Sheppard Ave. East, Toronto On, M2N 6N5 416 487 8151 f 416 487 9104 smithandandersen.com

SAYERS FOOD LIMITED

132 BURLEIGH STREET t: 705.656.4531 e: sayers@apsley.ca

NORTH ARROW

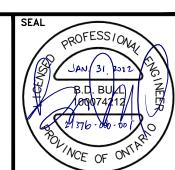

PROJECT TITLE

NEW SAYERS FOOD STORE BURLEIGH STREET, APSLEY


DRAWING TITLE

GROUND FLOOR PLAN
PLUMBING AND DRAINAGE

1:100

JUNE 16, 2021

PROJECT NUMBER 21076

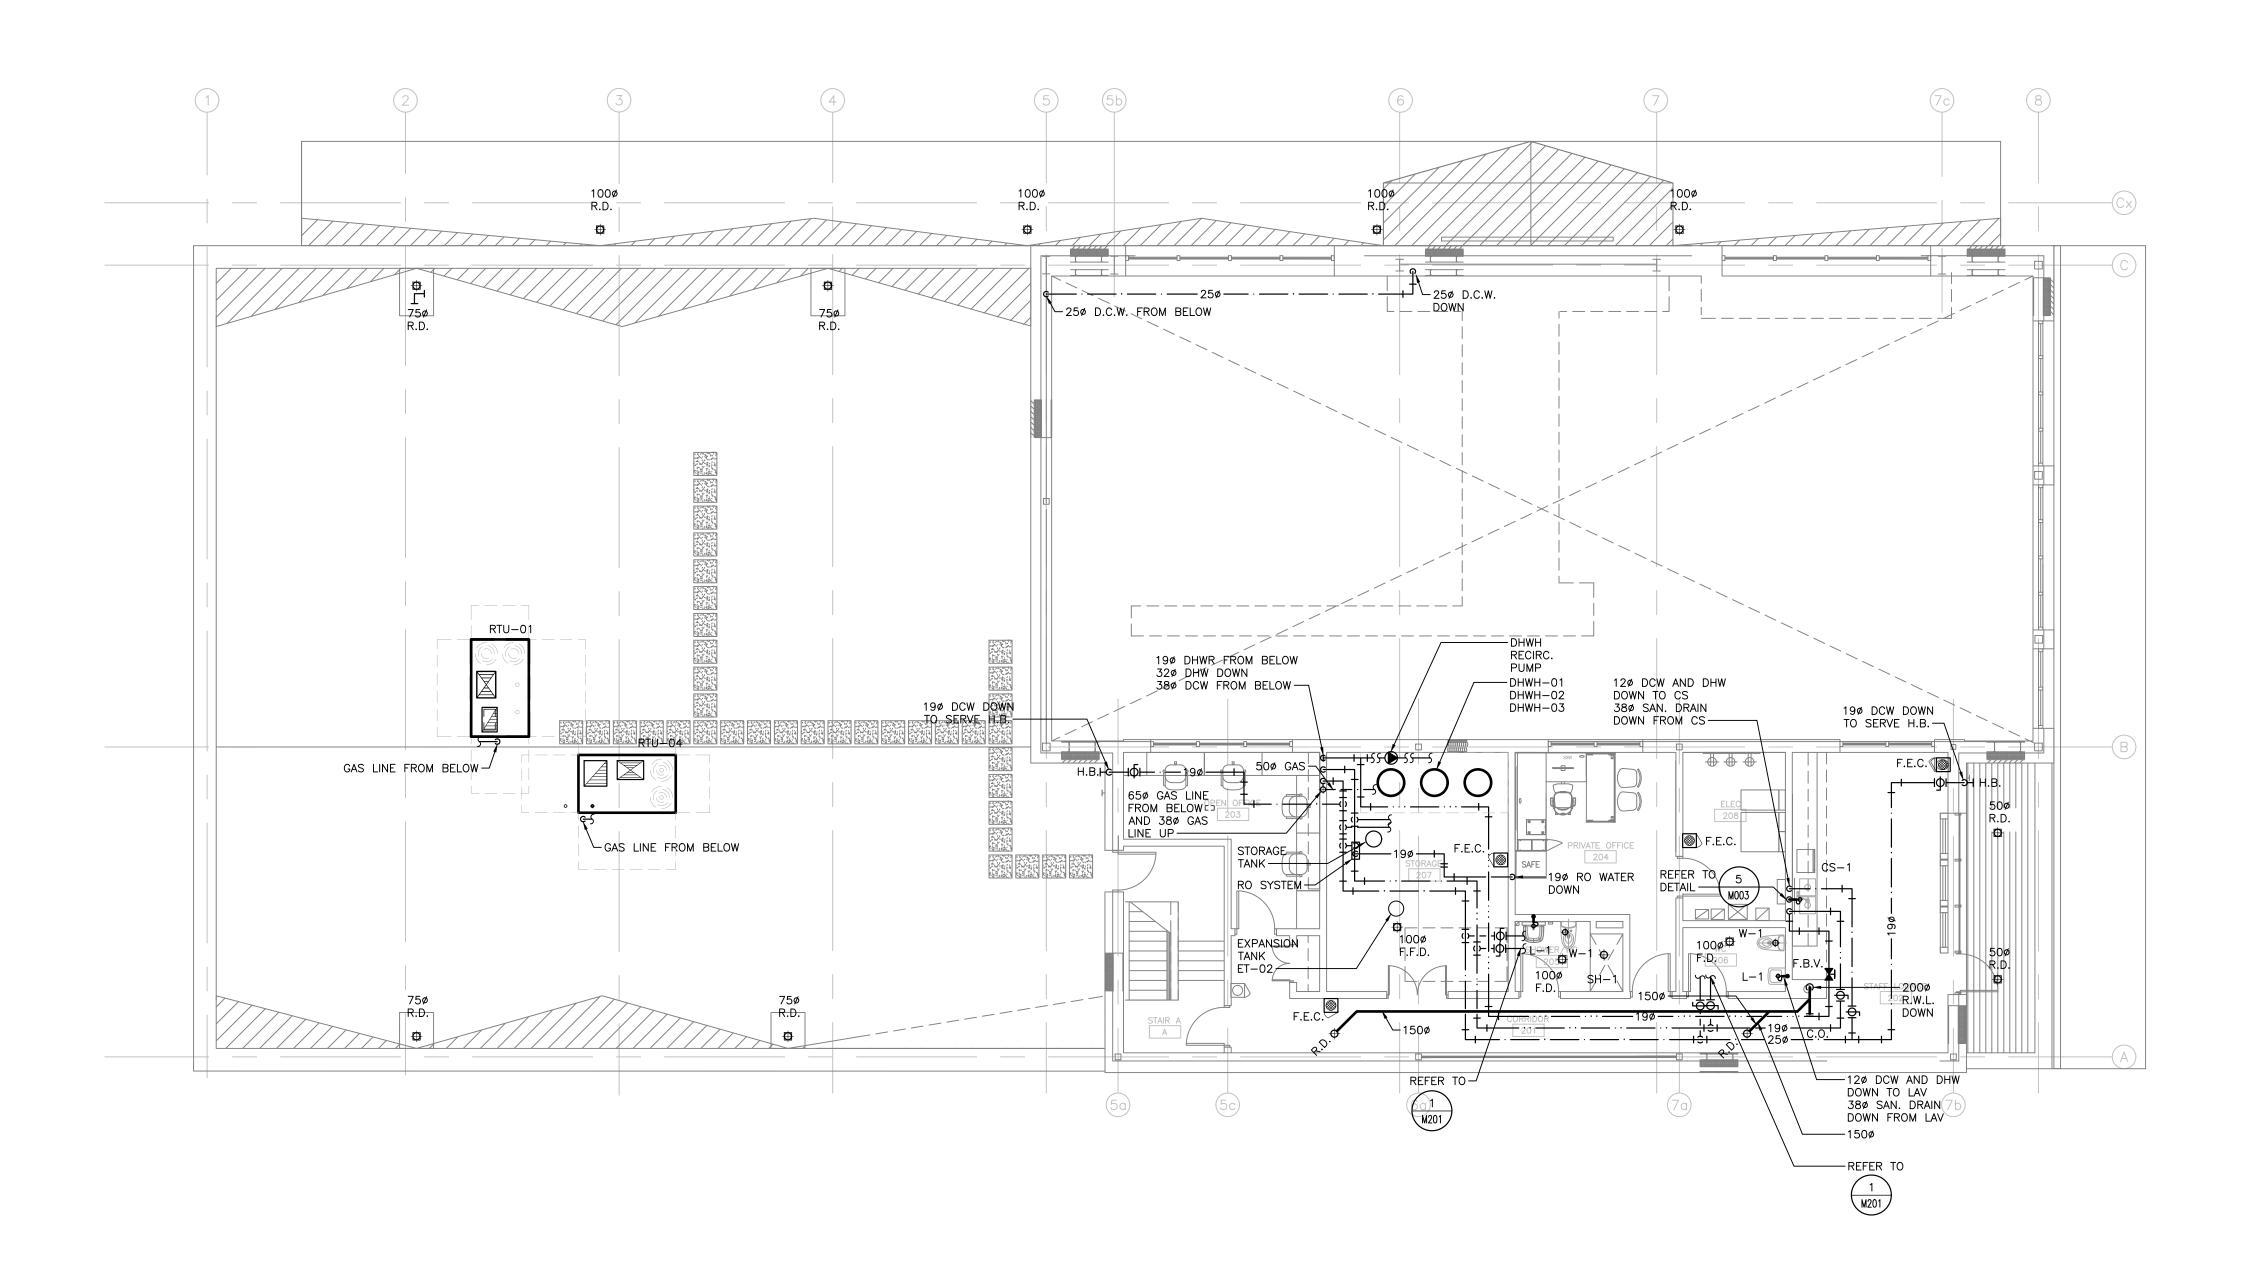

KITCHEN EQUIPMENT SCHEDULE

SIZE(MM) SIZE(M

12

FILTERE DIRECT INDIR INDIRECT GAS MBTU/

SIZE(M SIZE(M ROUGH-IN M)

WATER WATER D H2O DRAIN DRAIN SIZE(M H

M)

M)

38

Yes

EQUIPMENT CATEGORY

RESIDENTIAL FRIDGE

RESIDENTIAL DW

GENERAL NOTES:

- DO NOT SCALE DRAWINGS. THE LOCATIONS OF ALL ITEMS SHOWN ON THE DRAWINGS OR SPECIFIED THAT ARE NOT DEFINITELY FIXED BY DIMENSIONS ARE APPROXIMATE.

 DETERMINE THE EXACT LOCATIONS NECESSARY TO SECURE THE BEST CONDITIONS AND RESULTS BASED ON SITE CONDITIONS. REVIEW ALL REVISIONS WITH THE CONSULTANT.
 - APPLICABLE TO THE RELATED SYSTEM SCHEMATIC AND

PLUMBING AND DRAINAGE NOTES:

- SANITARY DRAINAGE UNLESS INDICATED OTHERWISE.

 2. PROVIDE APPROVED BACK FLOW PREVENTION FOR ALL TRAP PRIMER SYSTEMS.
- DRAINAGE UNLESS INDICATED OTHERWISE.
- 5. INSTALL ALL PIPING OVERHEAD, TIGHT TO UNDERSIDE OF THE STRUCTURE WITH SUFFICIENT ROOM FOR INSULATION UNLESS INDICATED OTHERWISE. ROUTE PIPING WITHIN STRUCTURAL STEEL STRATA OR THROUGH CONCRETE BEAMS WHERE
- HEAT TRACE THE ENTIRE SERVICE TO BE PROTECTED FROM FREEZING IN ALL AREAS INDICATED ON THE DRAWINGS AND NOTED IN THE SPECIFICATIONS. PROVIDE HEAT TRACING TO ACCOMMODATE ALTERATIONS IN THE PIPE LAYOUT DUE TO INTERFERENCES OR OTHER INSTALLATION REQUIREMENTS.
 CONNECT HEAT TRACING CIRCUIT TO THE ELECTRICAL POWER LOCATIONS INDICATED ON THE DRAWINGS OR THE NEAREST CIRCUIT AVAILABLE. COORDINATE WITH ELECTRICAL DIVISION. PROVIDE SHUT-OFF VALVES ON ALL MAIN RISERS AND AT EACH CONNECTION TO EQUIPMENT.
- 8. PROVIDE COMPLETE VENTING SYSTEMS IN ACCORDANCE WITH THE PLUMBING OR BUILDING CODE.
- PARKING LEVELS, SOFFITS AND WITHIN WALLS WHERE FREEZING MAY OCCUR.

- 2. READ FLOOR PLANS IN CONJUNCTION WITH SCHEMATICS. ASSUME INFORMATION SHOWN ON FLOOR PLANS TO BE
- VERIFY STRUCTURAL INTEGRITY OF ALL TEMPORARY AND PERMANENT OPENINGS. PROVIDE ADDITIONAL FRAMING TO ENSURE STRUCTURAL INTEGRITY AS REQUIRED.

VICE-VERSA TO PROVIDE A COMPLETE AND OPERATIONAL

4. REFER TO THE STANDARD DETAILS AND DETAIL SHEETS FOR ADDITIONAL INFORMATION.

1. PROVIDE MINIMUM 75mm (3 IN.) FOR UNDER GROUND

- 3. PROVIDE MINIMUM 100mm (4 IN.) FOR UNDER GROUND STORM
- 4. PROVIDE MINIMUM 19mm (3/4 IN.) DOMESTIC COLD WATER AND DOMESTIC HOT WATER PIPES UNLESS INDICATED

- 9. HEAT TRACE ALL PIPING WITHIN UNHEATED SPACES SUCH AS

Contractor must check and verify all dimensions on the job, and report any discrepancies to the Architect before proceeding with the work.

Do not scale this drawing.

REV	DESCRIPTION	DATE	ı
1	ISSUED FOR TENDER	2021.08.25	
2	ISSUED FOR PERMIT	2021.09.09	
3	ISSUED FOR ADDENDUM #1	2021.09.15	
4	ISSUED FOR ADDENDUM #2	2021.09.27	
5 RE	-ISSUED FOR TENDER AND PERMIT	2022.01.31	

MJMA

maclennan jaunkalns miller architects

425 adelaide street west level 6 toronto ontario m5v 3c1 416 593 6796 www.mjmarchitects.com

TRITON ENGINEERING SERVICES LTD CIVIL ENGINEERS

18 ROBB BOULEVARD - UNIT 8 ORANGEVILLE, ONTARIO TEL 519 941 0330 FAX 519 941 1830

BLACKWELL

STRUCTURAL ENGINEERS 134 PETER STREET, SUITE 1301 TORONTO, ONTARIO, M5V 2H2 TEL 416.593.5300 FAX 416.593.4840

SMITH + ANDERSON MECHANICAL AND ELECTRICAL ENGINEERS

1100 - 100 SHEPPARD AVENUE EAST TORONTO, ONTARIO, M2N 6N5 TEL 416.487.8151 -




Smith + Andersen

1100 - 100 Sheppard Ave. East, Toronto On, M2N 6N5 416 487 8151 f 416 487 9104 smithandandersen.com

SAYERS FOOD LIMITED

132 BURLEIGH STREET t: 705.656.4531 e: sayers@apsley.ca

NORTH ARROW

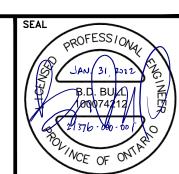

PROJECT TITLE

NEW SAYERS FOOD STORE BURLEIGH STREET, APSLEY


DRAWING TITLE

SECOND FLOOR PLAN PLUMBING AND DRAINAGE

SCALE 1:100

JUNE 16, 2021

PROJECT NUMBER 21076

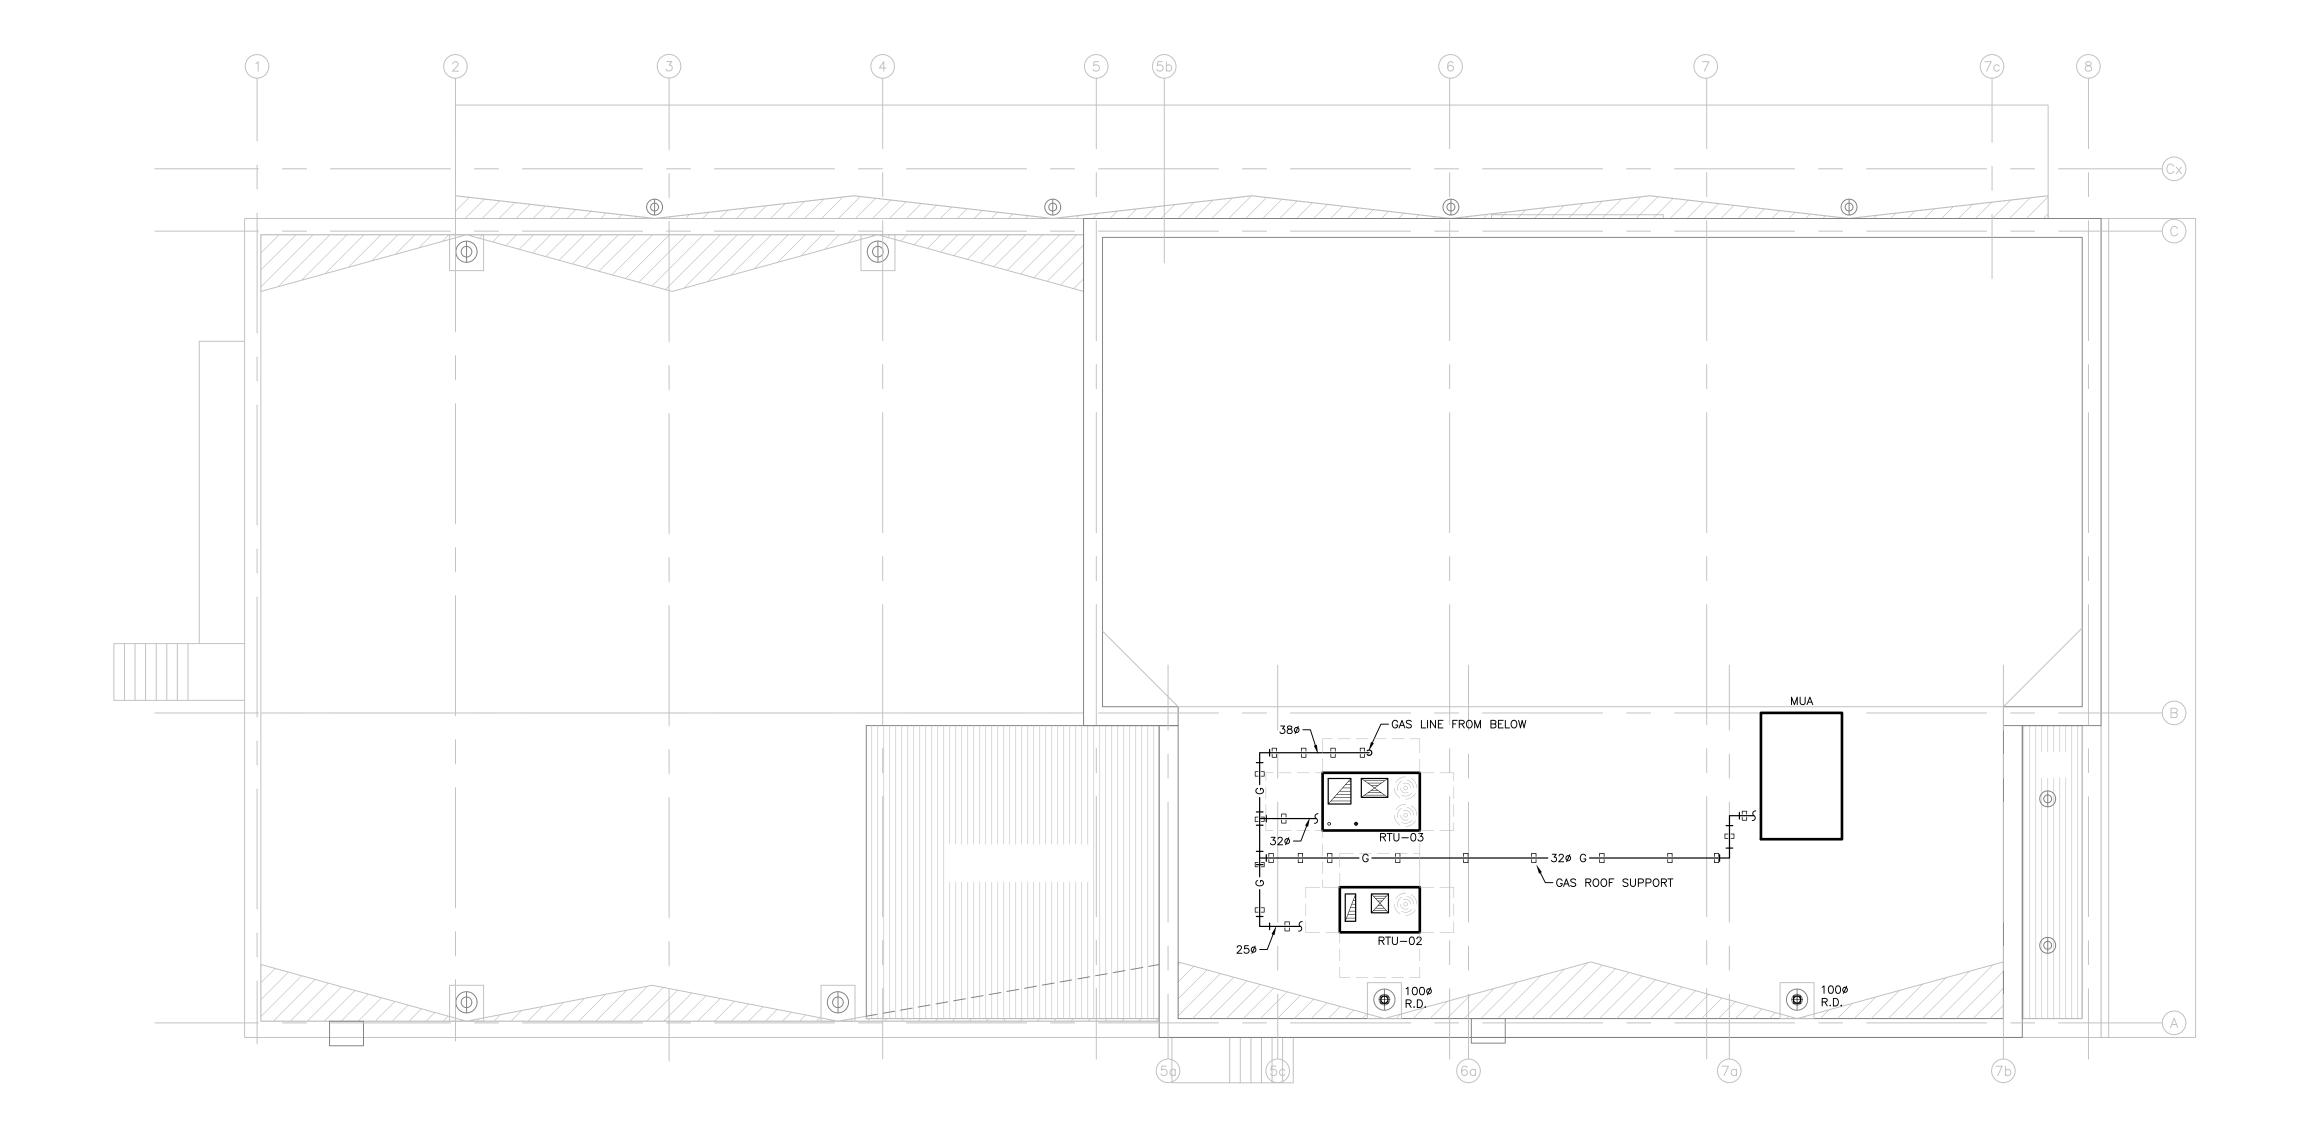

- 1. DO NOT SCALE DRAWINGS. THE LOCATIONS OF ALL ITEMS SHOWN ON THE DRAWINGS OR SPECIFIED THAT ARE NOT DEFINITELY FIXED BY DIMENSIONS ARE APPROXIMATE.

 DETERMINE THE EXACT LOCATIONS NECESSARY TO SECURE THE BEST CONDITIONS AND RESULTS BASED ON SITE CONDITIONS. REVIEW ALL REVISIONS WITH THE CONSULTANT.
- BEST CONDITIONS AND RESULTS BASED ON SITE CONDITION REVIEW ALL REVISIONS WITH THE CONSULTANT.

 2. READ FLOOR PLANS IN CONJUNCTION WITH SCHEMATICS. ASSUME INFORMATION SHOWN ON FLOOR PLANS TO BE APPLICABLE TO THE RELATED SYSTEM SCHEMATIC AND VICE—VERSA TO PROVIDE A COMPLETE AND OPERATIONAL SYSTEM.
- VERIFY STRUCTURAL INTEGRITY OF ALL TEMPORARY AND PERMANENT OPENINGS. PROVIDE ADDITIONAL FRAMING TO ENSURE STRUCTURAL INTEGRITY AS REQUIRED.
- 4. REFER TO THE STANDARD DETAILS AND DETAIL SHEETS FOR ADDITIONAL INFORMATION.

PLUMBING AND DRAINAGE NOTES:

- PROVIDE MINIMUM 75mm (3 IN.) FOR UNDER GROUND SANITARY DRAINAGE UNLESS INDICATED OTHERWISE.
 PROVIDE APPROVED BACK FLOW PREVENTION FOR ALL TRAP PRIMER SYSTEMS.
- PROVIDE MINIMUM 100mm (4 IN.) FOR UNDER GROUND STORM DRAINAGE UNLESS INDICATED OTHERWISE.
- PROVIDE MINIMUM 19mm (3/4 IN.) DOMESTIC COLD WATER AND DOMESTIC HOT WATER PIPES UNLESS INDICATED OTHERWISE.
- INSTALL ALL PIPING OVERHEAD, TIGHT TO UNDERSIDE OF THE STRUCTURE WITH SUFFICIENT ROOM FOR INSULATION UNLESS INDICATED OTHERWISE. ROUTE PIPING WITHIN STRUCTURAL STEEL STRATA OR THROUGH CONCRETE BEAMS WHERE PRACTICAL.
- 6. HEAT TRACE THE ENTIRE SERVICE TO BE PROTECTED FROM FREEZING IN ALL AREAS INDICATED ON THE DRAWINGS AND NOTED IN THE SPECIFICATIONS. PROVIDE HEAT TRACING TO ACCOMMODATE ALTERATIONS IN THE PIPE LAYOUT DUE TO INTERFERENCES OR OTHER INSTALLATION REQUIREMENTS. CONNECT HEAT TRACING CIRCUIT TO THE ELECTRICAL POWER LOCATIONS INDICATED ON THE DRAWINGS OR THE NEAREST CIRCUIT AVAILABLE. COORDINATE WITH ELECTRICAL DIVISION.
 7. PROVIDE SHUT-OFF VALVES ON ALL MAIN RISERS AND AT EACH CONNECTION TO EQUIPMENT.
- 8. PROVIDE COMPLETE VENTING SYSTEMS IN ACCORDANCE WITH THE PLUMBING OR BUILDING CODE.
- HEAT TRACE ALL PIPING WITHIN UNHEATED SPACES SUCH AS PARKING LEVELS, SOFFITS AND WITHIN WALLS WHERE FREEZING MAY OCCUR.

Contractor must check and verify all dimensions on the job, and report any discrepancies to the Architect before proceeding with the work.

Do not scale this drawing.

REVISIONS AND ISSUES

REV	DESCRIPTION	DATE
1	ISSUED FOR TENDER	2021.08.
2	ISSUED FOR PERMIT	2021.09.

3 RE-ISSUED FOR TENDER AND PERMIT 2022.01.31

4

5

6

MJMA

maclennan jaunkalns miller architects

425 adelaide street west level 6 toronto ontario m5v 3c1 416 593 6796 www.mjmarchitects.com

TRITON ENGINEERING SERVICES LTD

18 ROBB BOULEVARD — UNIT 8
ORANGEVILLE, ONTARIO

TEL 519 941 0330 FAX 519 941 1830

BLACKWELL STRUCTURAL ENGINEERS

134 PETER STREET, SUITE 1301 TORONTO, ONTARIO, M5V 2H2 TEL 416.593.5300 FAX 416.593.4840

SMITH + ANDERSON MECHANICAL AND ELECTRICAL ENGINEERS

1100 — 100 SHEPPARD AVENUE EAST TORONTO, ONTARIO, M2N 6N5 TEL 416.487.8151 —




Smith + Andersen

1100 - 100 Sheppard Ave. East, Toronto On, M2N 6N5 416 487 8151 f 416 487 9104 smithandandersen.com

SAYERS FOOD LIMITED

132 BURLEIGH STREET t: 705.656.4531 e: sayers@apsley.ca

NORTH AR

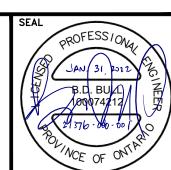

PROJECT

NEW SAYERS FOOD STORE BURLEIGH STREET, APSLEY


DRAWING TIT

ROOF PLAN PLUMBING AND DRAINAGE

1:1

JUNE 16, 2021

PROJECT NUMBER 21076

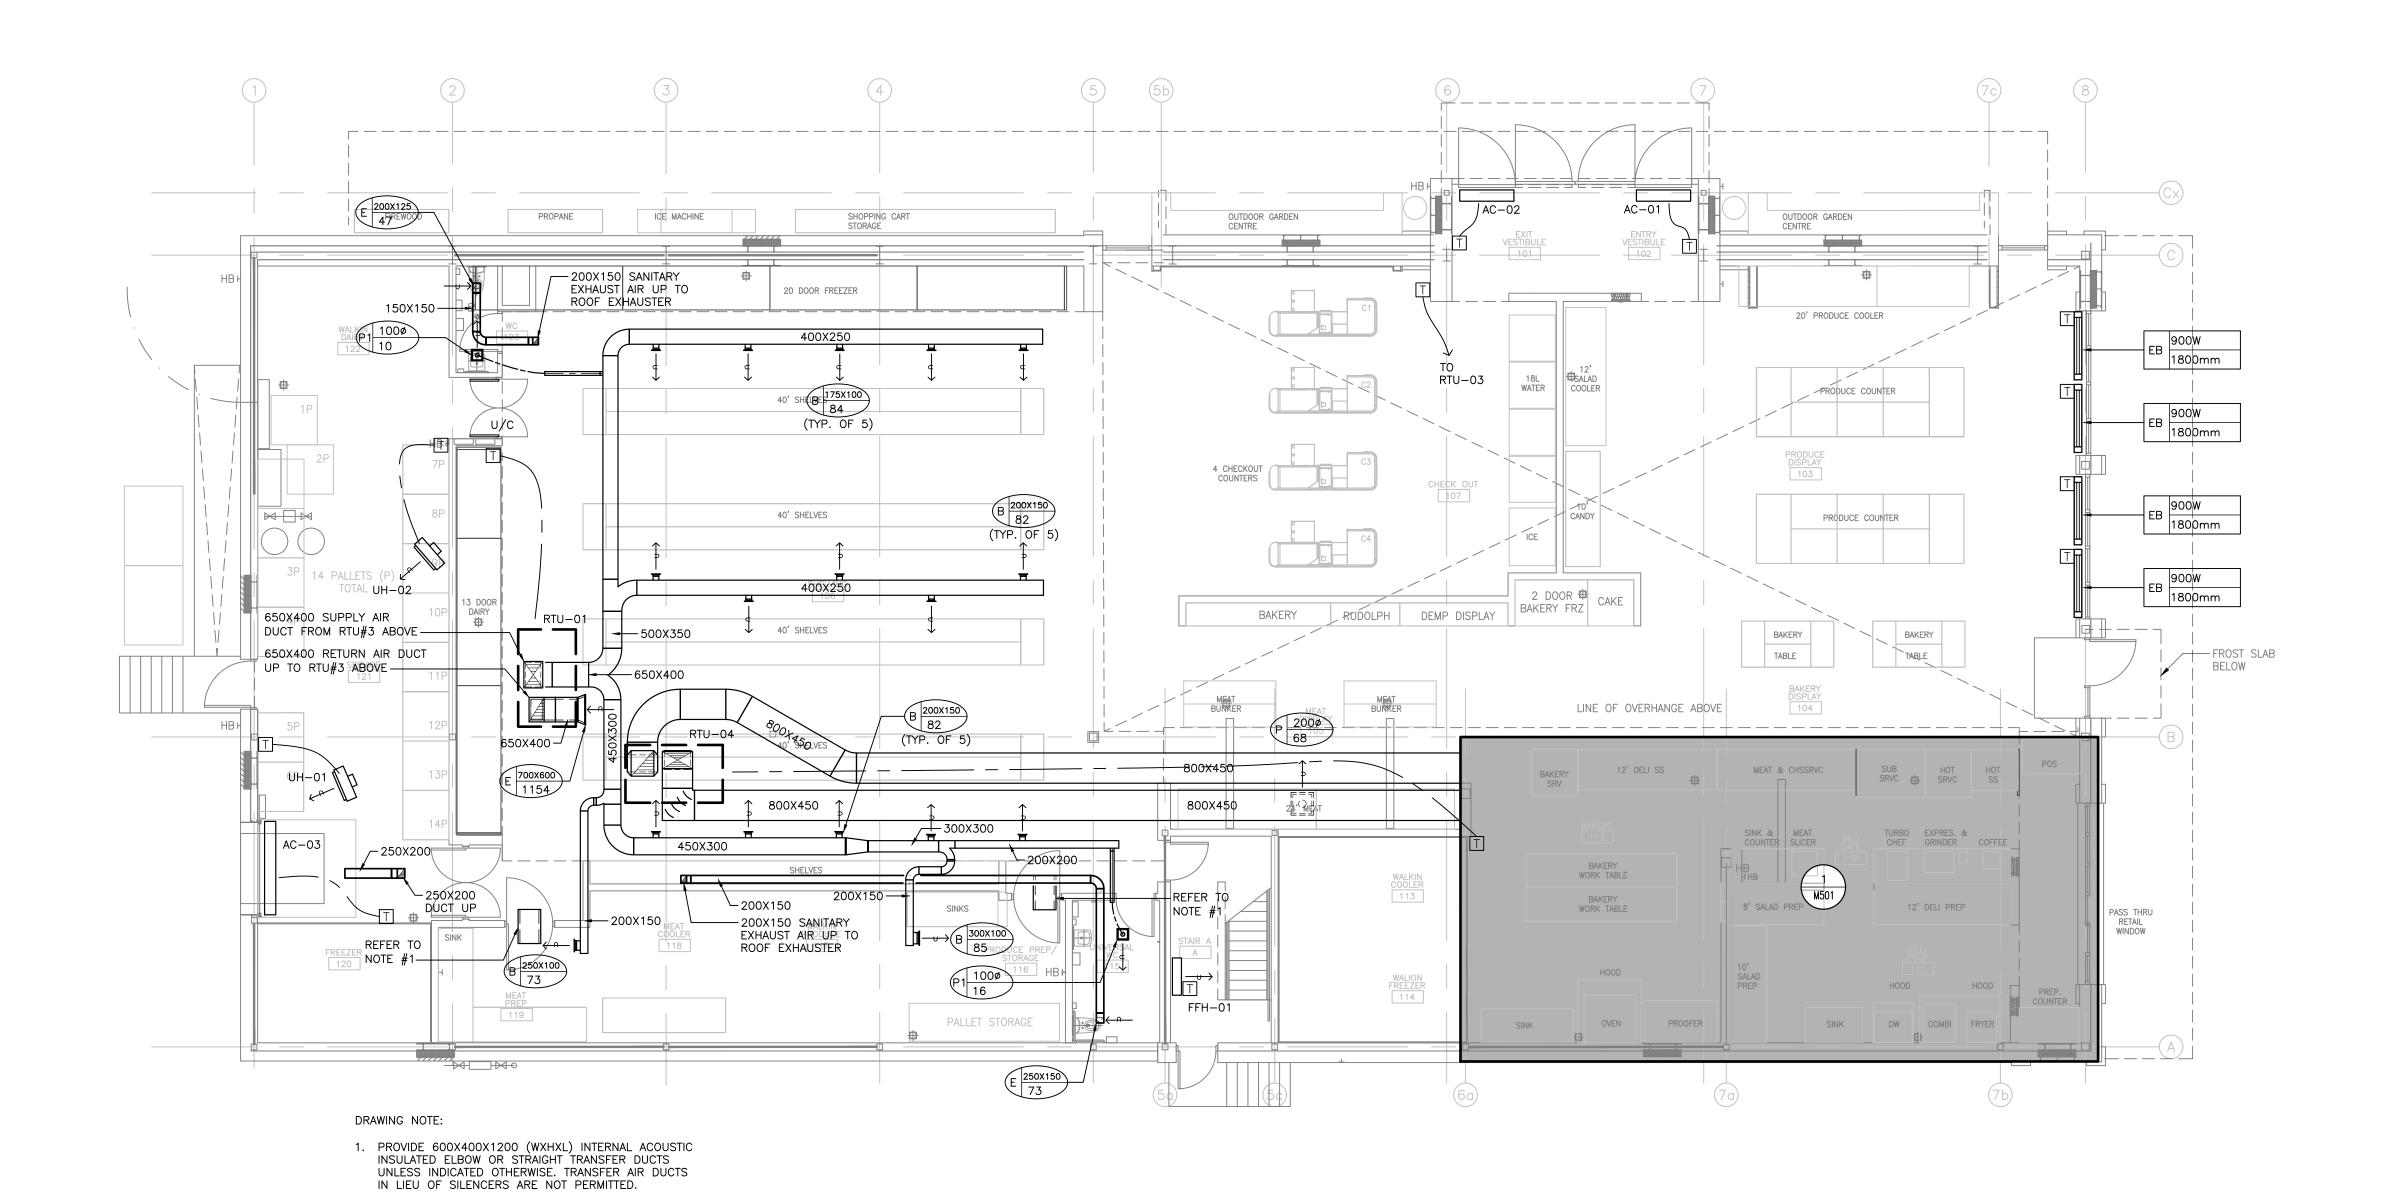

- DO NOT SCALE DRAWINGS. THE LOCATIONS OF ALL ITEMS SHOWN ON THE DRAWINGS OR SPECIFIED THAT ARE NOT DEFINITELY FIXED BY DIMENSIONS ARE APPROXIMATE. DETERMINE THE EXACT LOCATIONS NECESSARY TO SECURE THE BEST CONDITIONS AND RESULTS BASED ON SITE CONDITIONS. REVIEW ALL REVISIONS WITH THE CONSULTANT.
- BEST CONDITIONS AND RESULTS BASED ON SITE CONDITION REVIEW ALL REVISIONS WITH THE CONSULTANT.

 2. READ FLOOR PLANS IN CONJUNCTION WITH SCHEMATICS. ASSUME INFORMATION SHOWN ON FLOOR PLANS TO BE APPLICABLE TO THE RELATED SYSTEM SCHEMATIC AND
- VERIFY STRUCTURAL INTEGRITY OF ALL TEMPORARY AND PERMANENT OPENINGS. PROVIDE ADDITIONAL FRAMING TO ENSURE STRUCTURAL INTEGRITY AS REQUIRED.

VICE-VERSA TO PROVIDE A COMPLETE AND OPERATIONAL

 REFER TO THE STANDARD DETAILS AND DETAIL SHEETS FOR ADDITIONAL INFORMATION.

HVAC NOTES:

- REFER TO ARCHITECTURAL REFLECTED CEILING PLANS FOR EXACT LOCATIONS OF GRILLES AND DIFFUSERS. REQUEST CLARIFICATION FOR ANY DIFFUSER OR GRILLE WITH MORE THAN A 600MM (24 IN.) DISCREPANCY IN LOCATION.
- 2. TEMPERATURE SENSORS ARE LOCATED TO AID IN PRICING ONLY AND ALL REQUIRED SENSORS MAY NOT BE SHOWN (REFER TO SPECIFICATIONS). COORDINATE FINAL LOCATION WITH THE ARCHITECT WITHIN 1000MM (40 IN.) OF LOCATION SHOWN. REVIEW ALL RELOCATIONS OUTSIDE OF THIS RANGE WITH THE CONSULTANT.
- INSTALL TEMPERATURE SENSORS AT NOMINALLY 1200MM (48 IN.) ABOVE THE FINISHED FLOOR UNLESS INDICATED OTHERWISE.
- 4. PROVIDE DIFFUSER DUCT RUN-OUTS THE SAME SIZE AS THE DIFFUSER INLETS UNLESS INDICATED OTHERWISE.
- 5. MAINTAIN A MINIMUM OF 2400MM (96 IN.) CLEARANCE TO THE UNDERSIDE OF PIPES, DUCTS, CONDUITS, SUSPENDED EQUIPMENT, ETC. THROUGHOUT ACCESS ROUTES IN MECHANICAL ROOMS.
- 6. INSTALL ALL PIPING OVERHEAD, TIGHT TO UNDERSIDE OF THE STRUCTURE WITH SUFFICIENT ROOM FOR INSULATION UNLESS INDICATED OTHERWISE. ROUTE PIPING WITHIN STRUCTURAL STEEL STRATA OR THROUGH CONCRETE BEAMS WHERE PRACTICAL
- 7. VERIFY STRUCTURAL INTEGRITY OF ALL TEMPORARY AND PERMANENT OPENINGS. PROVIDE ADDITIONAL FRAMING TO
- ENSURE STRUCTURAL INTEGRITY AS REQUIRED.

 8. PROVIDE ALL OPEN ENDED DUCTWORK COMPLETE WITH WIRE MESH.
- 9. PROVIDE 600X400X1200 (WXHXL) INTERNAL ACOUSTIC INSULATED ELBOW OR STRAIGHT TRANSFER DUCTS UNLESS INDICATED OTHERWISE. TRANSFER AIR DUCTS IN LIEU OF SILENCERS ARE NOT PERMITTED.

F ALL ITEMS
F ARE NOT
IMATE.
TO SECURE THE
E CONDITIONS.

REVISIONS AND ISSUES
REV
DESCRIPTION

Do not scale this drawing.

 REV
 DESCRIPTION
 DATE

 1
 ISSUED FOR TENDER
 2021.08.25

 2
 ISSUED FOR PERMIT
 2021.09.09

 3
 ISSUED FOR ADDENDUM #1
 2021.09.15

Contractor must check and verify all dimensions on the job, and report any discrepancies to the Architect before proceeding with the work.

4 RE-ISSUED FOR TENDER AND PERMIT 2022.01.31

5
6

MJMA

maclennan jaunkalns miller architects

425 adelaide street west level 6 toronto ontario m5v 3c1 416 593 6796 www.mjmarchitects.com

TRITON ENGINEERING SERVICES LTD

18 ROBB BOULEVARD — UNIT 8
ORANGEVILLE, ONTARIO
TEL 519 941 0330 FAX 519 941 1830

BLACKWELL STRUCTURAL ENGINEERS

134 PETER STREET, SUITE 1301 TORONTO, ONTARIO, M5V 2H2 TEL 416.593.5300 FAX 416.593.4840

SMITH + ANDERSON MECHANICAL AND ELECTRICAL ENGINEERS

1100 - 100 SHEPPARD AVENUE EAST TORONTO, ONTARIO, M2N 6N5
TEL 416.487.8151 -




Smith + Andersen

1100 - 100 Sheppard Ave. East, Toronto On, M2N 6N5 416 487 8151 f 416 487 9104 smithandandersen.com

SAYERS FOOD LIMITED

132 BURLEIGH STREET t: 705.656.4531 e: sayers@apsley.ca

NORTH ARROW

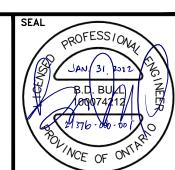

PROJECT TITLE

NEW SAYERS FOOD STORE BURLEIGH STREET, APSLEY

DRAWING TITLE

GROUND FLOOR PLAN HVAC

1:100


DATE
JUNE 16 20

JUNE 16, 2021

PROJECT NUMBER 21076

DRAWING NUMBER

M401

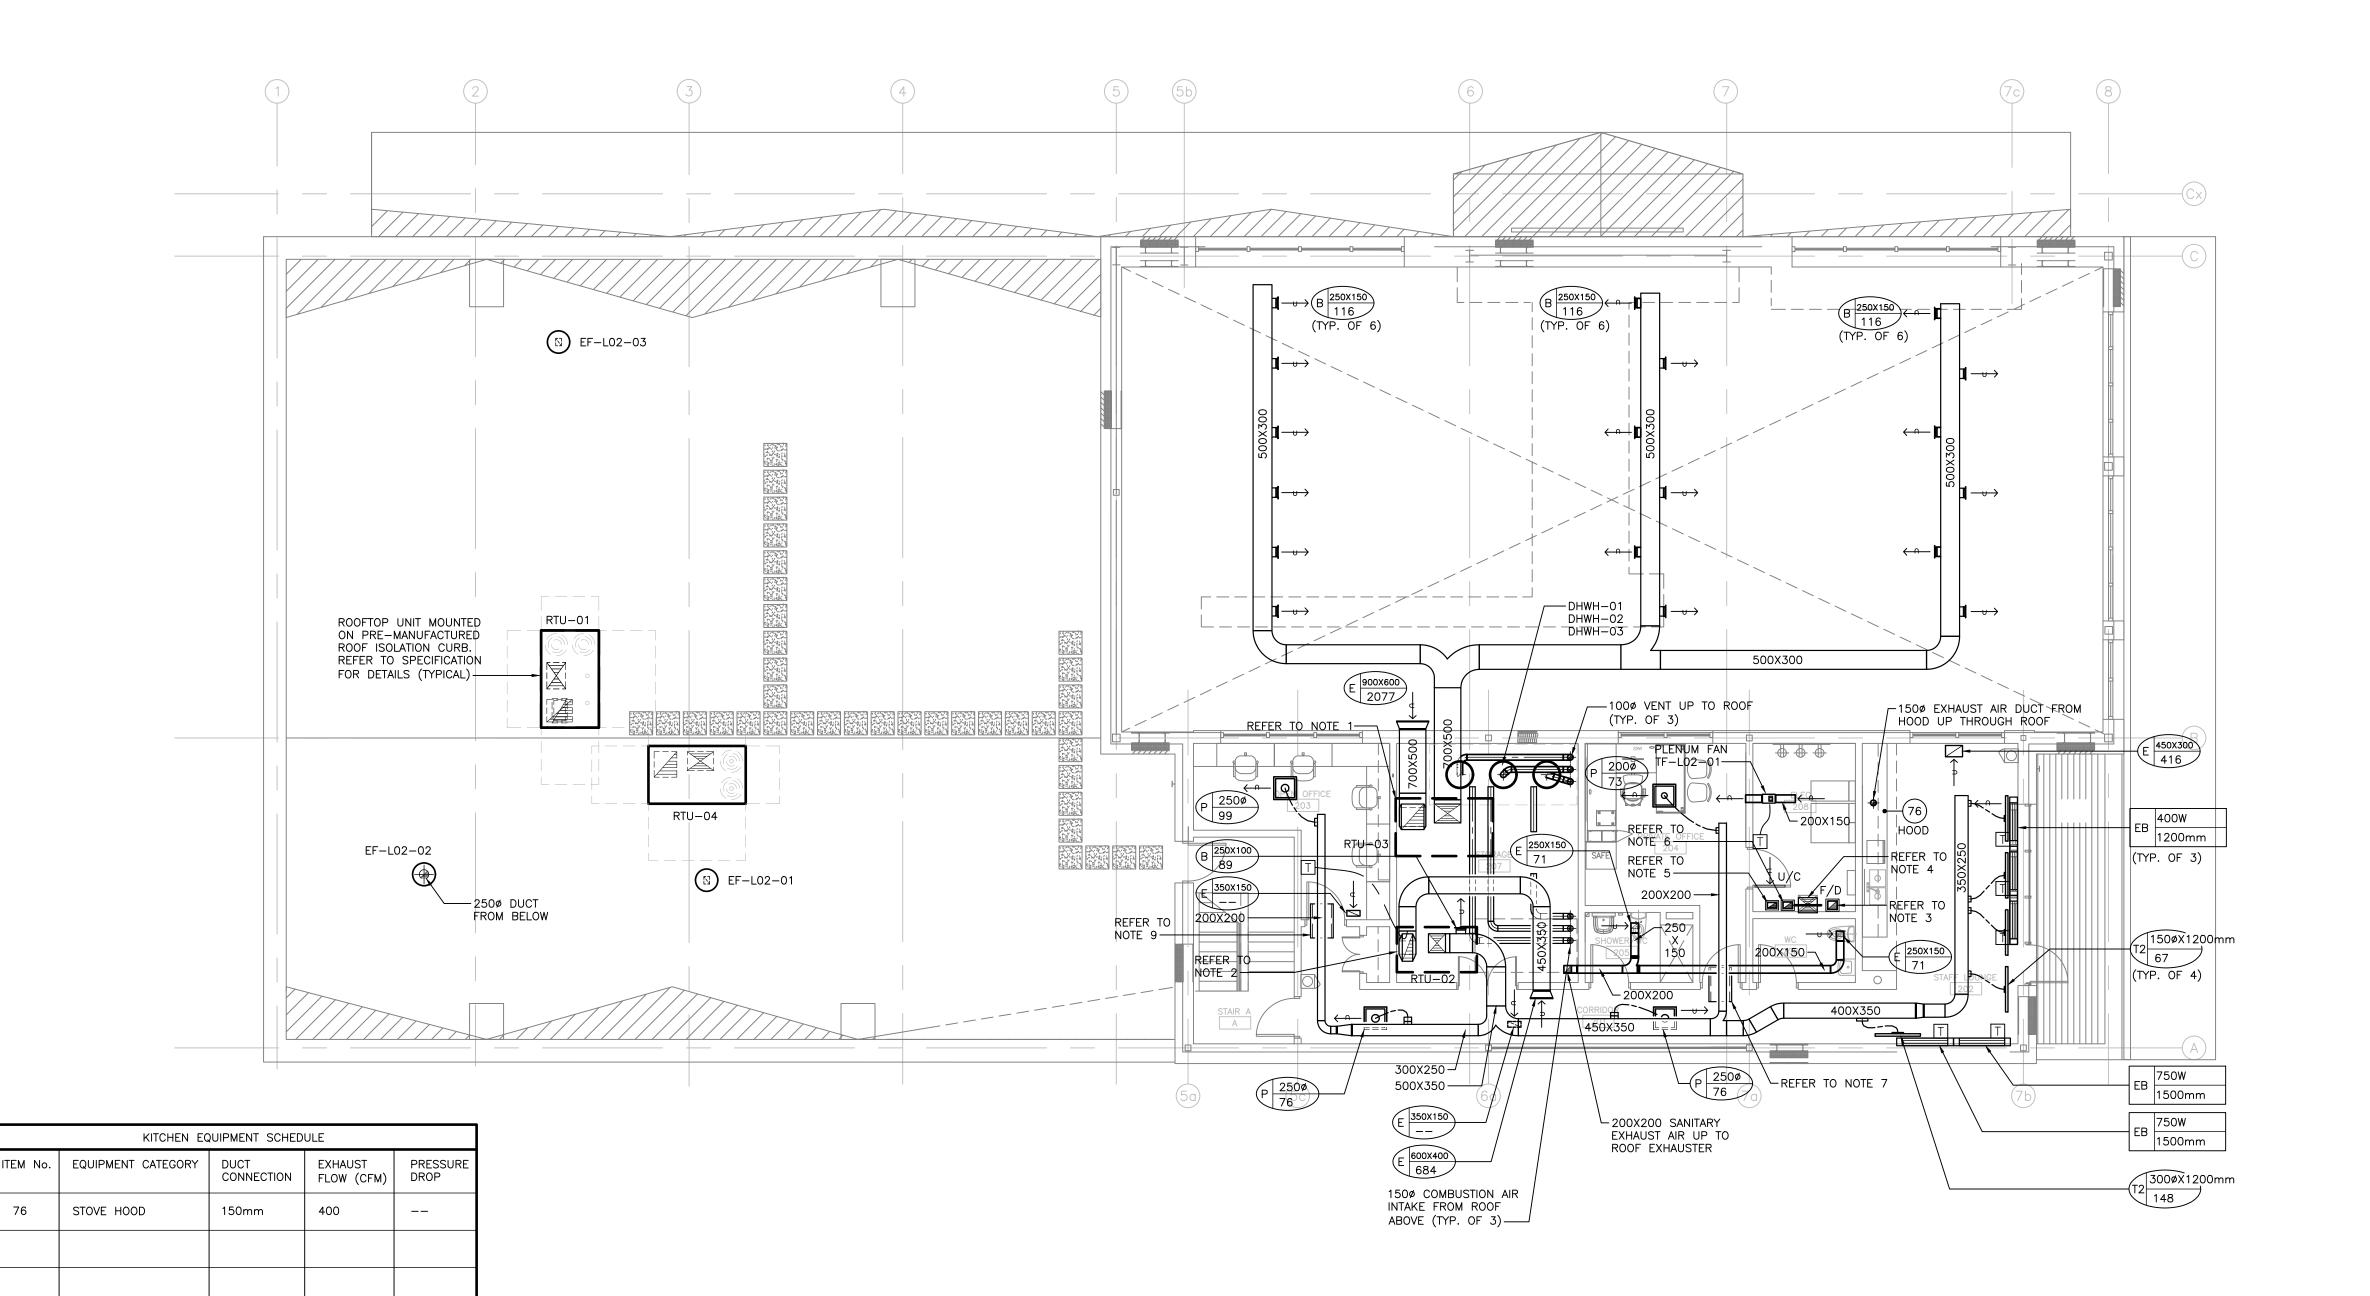

- DO NOT SCALE DRAWINGS. THE LOCATIONS OF ALL ITEMS SHOWN ON THE DRAWINGS OR SPECIFIED THAT ARE NOT DEFINITELY FIXED BY DIMENSIONS ARE APPROXIMATE.

 DETERMINE THE EXACT LOCATIONS NECESSARY TO SECURE THE BEST CONDITIONS AND RESULTS BASED ON SITE CONDITIONS. REVIEW ALL REVISIONS WITH THE CONSULTANT.
- 2. READ FLOOR PLANS IN CONJUNCTION WITH SCHEMATICS. ASSUME INFORMATION SHOWN ON FLOOR PLANS TO BE APPLICABLE TO THE RELATED SYSTEM SCHEMATIC AND

VICE-VERSA TO PROVIDE A COMPLETE AND OPERATIONAL

- 3. VERIFY STRUCTURAL INTEGRITY OF ALL TEMPORARY AND PERMANENT OPENINGS. PROVIDE ADDITIONAL FRAMING TO ENSURE STRUCTURAL INTEGRITY AS REQUIRED.
- 4. REFER TO THE STANDARD DETAILS AND DETAIL SHEETS FOR ADDITIONAL INFORMATION.

HVAC NOTES:

- 1. REFER TO ARCHITECTURAL REFLECTED CEILING PLANS FOR EXACT LOCATIONS OF GRILLES AND DIFFUSERS. REQUEST CLARIFICATION FOR ANY DIFFUSER OR GRILLE WITH MORE THAN A 600MM (24 IN.) DISCREPANCY IN LOCATION.
- 2. TEMPERATURE SENSORS ARE LOCATED TO AID IN PRICING ONLY AND ALL REQUIRED SENSORS MAY NOT BE SHOWN (REFER TO SPECIFICATIONS). COORDINATE FINAL LOCATION WITH THE ARCHITECT WITHIN 1000MM (40 IN.) OF LOCATION SHOWN. REVIEW ALL RELOCATIONS OUTSIDE OF THIS RANGE WITH THE CONSULTANT.
- 3. INSTALL TEMPERATURE SENSORS AT NOMINALLY 1200MM (48 IN.) ABOVE THE FINISHED FLOOR UNLESS INDICATED OTHERWISE.
- 4. PROVIDE DIFFUSER DUCT RUN-OUTS THE SAME SIZE AS THE DIFFUSER INLETS UNLESS INDICATED OTHERWISE.
- 5. MAINTAIN A MINIMUM OF 2400MM (96 IN.) CLEARANCE TO THE UNDERSIDE OF PIPES, DUCTS, CONDUITS, SUSPENDED EQUIPMENT, ETC. THROUGHOUT ACCESS ROUTES IN MECHANICAL ROOMS.
- 6. INSTALL ALL PIPING OVERHEAD, TIGHT TO UNDERSIDE OF THE STRUCTURE WITH SUFFICIENT ROOM FOR INSULATION UNLESS INDICATED OTHERWISE. ROUTE PIPING WITHIN STRUCTURAL STEEL STRATA OR THROUGH CONCRETE BEAMS WHERE
- 7. VERIFY STRUCTURAL INTEGRITY OF ALL TEMPORARY AND PERMANENT OPENINGS. PROVIDE ADDITIONAL FRAMING TO
- ENSURE STRUCTURAL INTEGRITY AS REQUIRED. 8. PROVIDE ALL OPEN ENDED DUCTWORK COMPLETE WITH WIRE MESH.
- PROVIDE 600X400X1200 (WXHXL) INTERNAL ACOUSTIC INSULATED ELBOW OR STRAIGHT TRANSFER DUCTS UNLESS INDICATED OTHERWISE. TRANSFER AIR DUCTS IN LIEU OF SILENCERS ARE NOT PERMITTED.

DRAWING NOTES:

- 700X500 SUPPLY AIR DUCT FROM RTU-03 ABOVE. 700X500 RETURN AIR DUCT UP TO RTU-03 ABOVE. 450X350 SUPPLY AIR DUCT FROM RTU-02 ABOVE. 450X350 RETURN AIR DUCT UP TO RTU-02 ABOVE.
- 3. 250X225 EXHAUST AIR DUCT IN FIRE RATED INSULATION FROM BELOW AND UP
- 4. 500X400 SUPPLY AIR DUCT FROM ABOVE AND DOWN
- 5. 250X175 EXHAUST AIR DUCT IN FIRE RATED INSULATION FROM BELOW AND UP

6. 250X150 EXHAUST AIR DUCT IN FIRE RATED INSULATION FROM BELOW AND UP

Contractor must check and verify all dimensions on the job, and report any discrepancies to the Architect before proceeding with the work.

Do not scale this drawing.

REV	DESCRIPTION	DATE
1	ISSUED FOR TENDER	2021.0
2	ISSUED FOR PERMIT	2021.0
3	ISSUED FOR ADDENDUM #1	2021.0
4	ISSUED FOR ADDENDUM #2	2021.0
5 RE-	-ISSUED FOR TENDER AND PERMIT	2022.0

MJMA

maclennan jaunkalns miller architects

425 adelaide street west level 6 toronto ontario m5v 3c1 416 593 6796 www.mjmarchitects.com

TRITON ENGINEERING SERVICES LTD CIVIL ENGINEERS

18 ROBB BOULEVARD - UNIT 8 ORANGEVILLE, ONTARIO

TEL 519 941 0330 FAX 519 941 1830

BLACKWELL STRUCTURAL ENGINEERS

134 PETER STREET, SUITE 1301 TORONTO, ONTARIO, M5V 2H2 TEL 416.593.5300 FAX 416.593.4840

SMITH + ANDERSON MECHANICAL AND ELECTRICAL ENGINEERS

1100 - 100 SHEPPARD AVENUE EAST TORONTO, ONTARIO, M2N 6N5 TEL 416.487.8151 -




Smith + Andersen

1100 - 100 Sheppard Ave. East, Toronto On, M2N 6N5 416 487 8151 f 416 487 9104 smithandandersen.com

SAYERS FOOD LIMITED

132 BURLEIGH STREET t: 705.656.4531 e: sayers@apsley.ca

NORTH ARROW

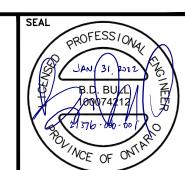

PROJECT TITLE

NEW SAYERS FOOD STORE BURLEIGH STREET, APSLEY


DRAWING TITLE

SECOND FLOOR PLAN HVAC

SCALE

JUNE 16, 2021

PROJECT NUMBER

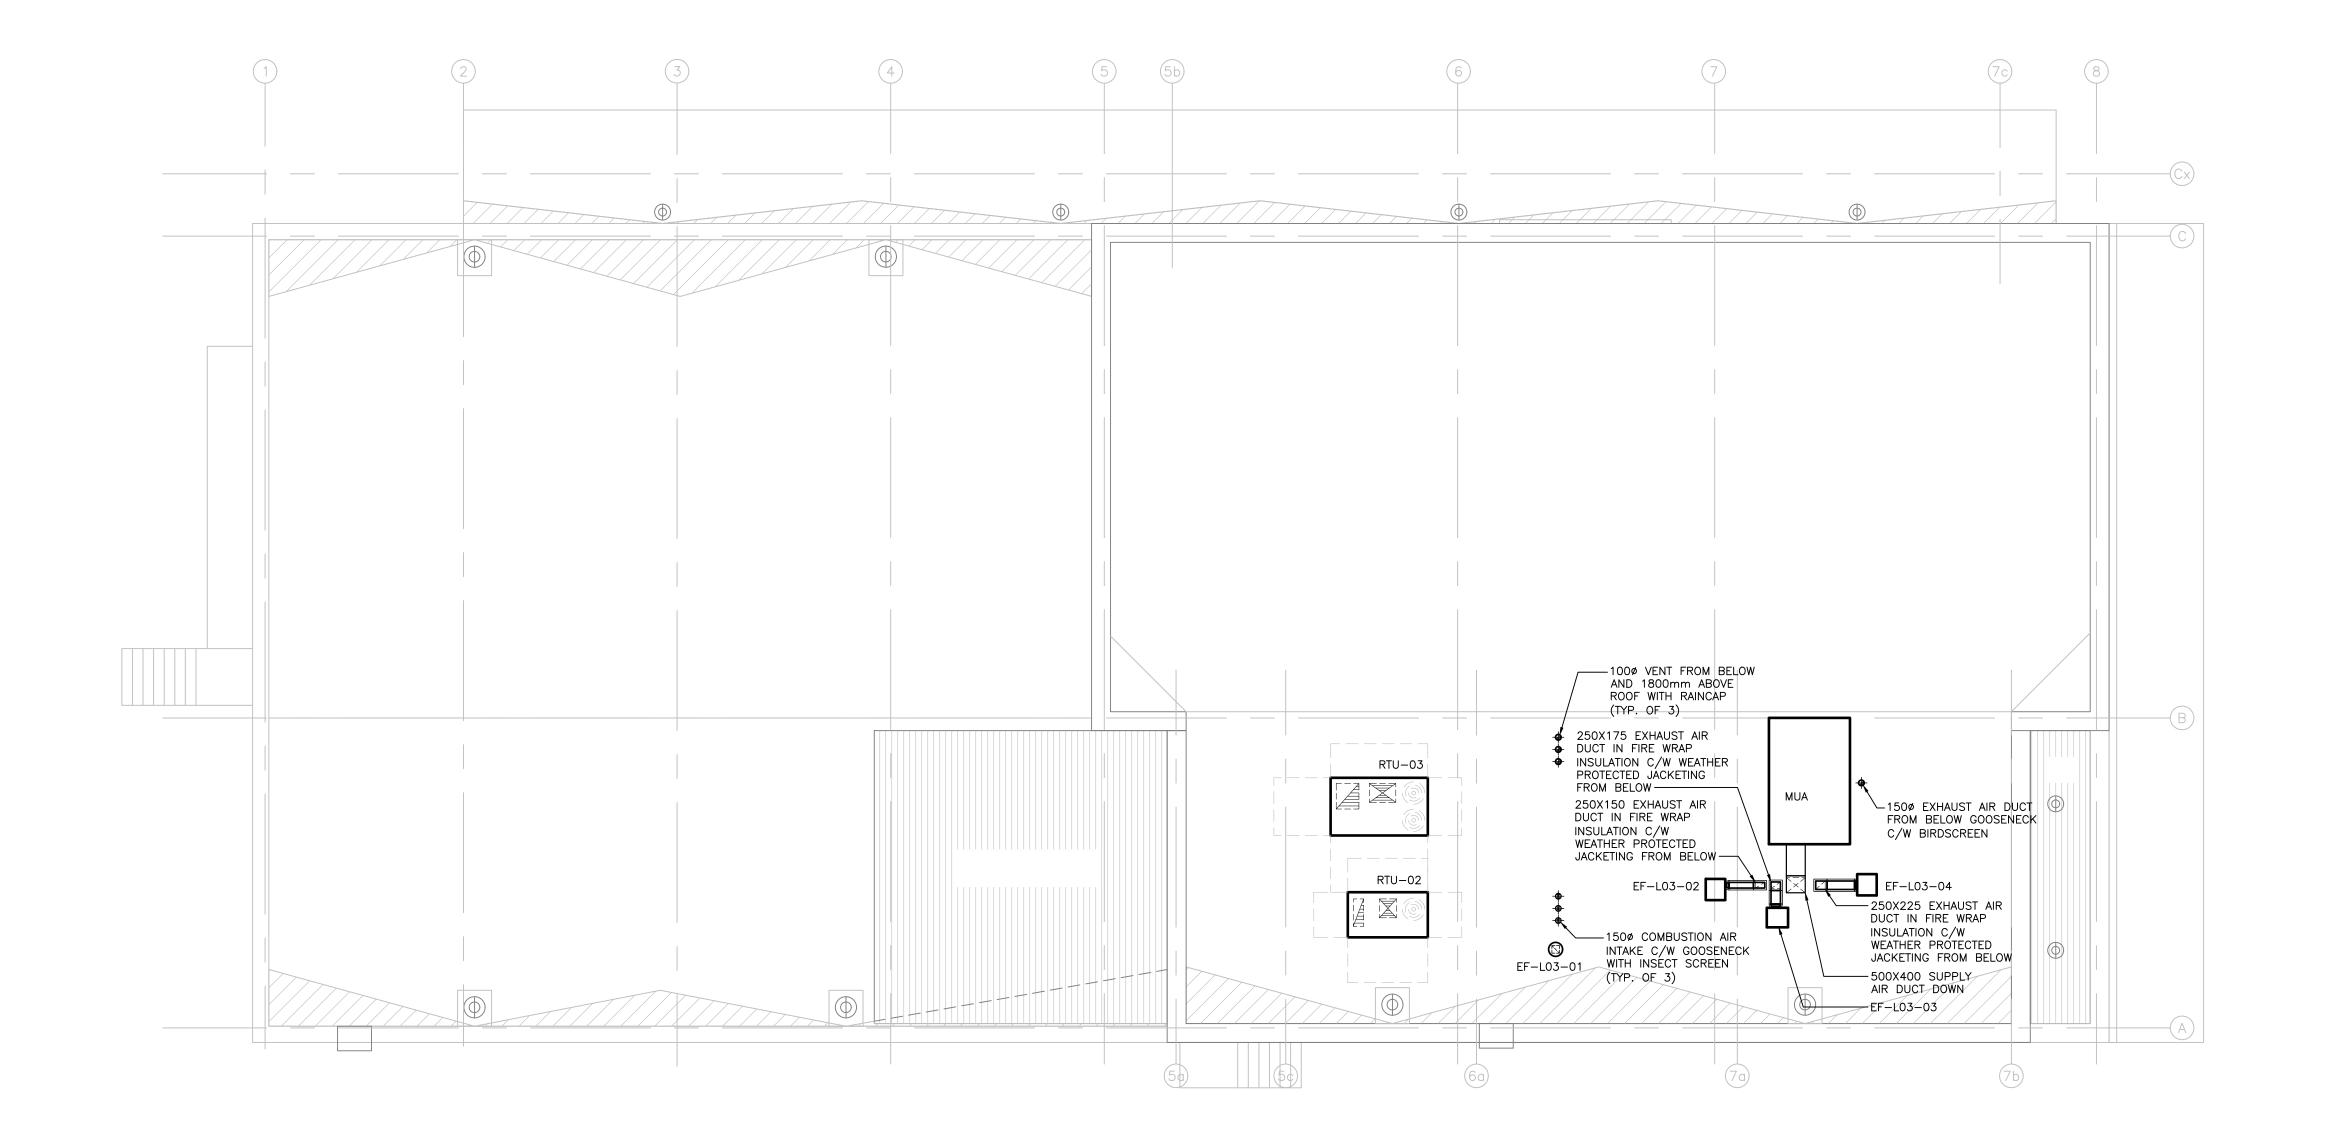

- DO NOT SCALE DRAWINGS. THE LOCATIONS OF ALL ITEMS SHOWN ON THE DRAWINGS OR SPECIFIED THAT ARE NOT DEFINITELY FIXED BY DIMENSIONS ARE APPROXIMATE. DETERMINE THE EXACT LOCATIONS NECESSARY TO SECURE THE BEST CONDITIONS AND RESULTS BASED ON SITE CONDITIONS. REVIEW ALL REVISIONS WITH THE CONSULTANT.
- 2. READ FLOOR PLANS IN CONJUNCTION WITH SCHEMATICS. ASSUME INFORMATION SHOWN ON FLOOR PLANS TO BE APPLICABLE TO THE RELATED SYSTEM SCHEMATIC AND VICE-VERSA TO PROVIDE A COMPLETE AND OPERATIONAL
- VERIFY STRUCTURAL INTEGRITY OF ALL TEMPORARY AND PERMANENT OPENINGS. PROVIDE ADDITIONAL FRAMING TO ENSURE STRUCTURAL INTEGRITY AS REQUIRED.
- REFER TO THE STANDARD DETAILS AND DETAIL SHEETS FOR ADDITIONAL INFORMATION.

HVAC NOTES:

- 1. REFER TO ARCHITECTURAL REFLECTED CEILING PLANS FOR EXACT LOCATIONS OF GRILLES AND DIFFUSERS. REQUEST CLARIFICATION FOR ANY DIFFUSER OR GRILLE WITH MORE THAN A 600MM (24 IN.) DISCREPANCY IN LOCATION.
- TEMPERATURE SENSORS ARE LOCATED TO AID IN PRICING ONLY AND ALL REQUIRED SENSORS MAY NOT BE SHOWN (REFER TO SPECIFICATIONS). COORDINATE FINAL LOCATION WITH THE ARCHITECT WITHIN 1000MM (40 IN.) OF LOCATION SHOWN. REVIEW ALL RELOCATIONS OUTSIDE OF THIS RANGE WITH THE CONSULTANT.
- 3. INSTALL TEMPERATURE SENSORS AT NOMINALLY 1200MM (48 IN.) ABOVE THE FINISHED FLOOR UNLESS INDICATED OTHERWISE.
- 4. PROVIDE DIFFUSER DUCT RUN-OUTS THE SAME SIZE AS THE DIFFUSER INLETS UNLESS INDICATED OTHERWISE.
- 5. MAINTAIN A MINIMUM OF 2400MM (96 IN.) CLEARANCE TO THE UNDERSIDE OF PIPES, DUCTS, CONDUITS, SUSPENDED EQUIPMENT, ETC. THROUGHOUT ACCESS ROUTES IN MECHANICAL ROOMS.
- 6. INSTALL ALL PIPING OVERHEAD, TIGHT TO UNDERSIDE OF THE STRUCTURE WITH SUFFICIENT ROOM FOR INSULATION UNLESS INDICATED OTHERWISE. ROUTE PIPING WITHIN STRUCTURAL STEEL STRATA OR THROUGH CONCRETE BEAMS WHERE
- 7. VERIFY STRUCTURAL INTEGRITY OF ALL TEMPORARY AND PERMANENT OPENINGS. PROVIDE ADDITIONAL FRAMING TO
- ENSURE STRUCTURAL INTEGRITY AS REQUIRED. 8. PROVIDE ALL OPEN ENDED DUCTWORK COMPLETE WITH WIRE MESH.
- PROVIDE 600X400X1200 (WXHXL) INTERNAL ACOUSTIC INSULATED ELBOW OR STRAIGHT TRANSFER DUCTS UNLESS INDICATED OTHERWISE. TRANSFER AIR DUCTS IN LIEU OF SILENCERS ARE NOT PERMITTED.

any discrepancies to the Architect before proceeding with the work.

Do not scale this drawing.

Contractor must check and verify all dimensions on the job, and report

REVISION	IS AND ISSUES	
REV	DESCRIPTION	DATE
1	ISSUED FOR TENDER	2021.08.25
2	ISSUED FOR PERMIT	2021.09.09

3 RE-ISSUED FOR TENDER AND PERMIT 2022.01.31

maclennan jaunkalns miller architects

425 adelaide street west level 6 toronto ontario m5v 3c1 416 593 6796 www.mjmarchitects.com

TRITON ENGINEERING SERVICES LTD CIVIL ENGINEERS

18 ROBB BOULEVARD - UNIT 8 ORANGEVILLE, ONTARIO TEL 519 941 0330 FAX 519 941 1830

BLACKWELL STRUCTURAL ENGINEERS

134 PETER STREET, SUITE 1301 TORONTO, ONTARIO, M5V 2H2 TEL 416.593.5300 FAX 416.593.4840

SMITH + ANDERSON MECHANICAL AND ELECTRICAL ENGINEERS

1100 - 100 SHEPPARD AVENUE EAST TORONTO, ONTARIO, M2N 6N5 TEL 416.487.8151 -




Smith + Andersen

1100 — 100 Sheppard Ave. East, Toronto On, M2N 6N5 416 487 8151 f 416 487 9104 smithandandersen.com

SAYERS FOOD LIMITED

132 BURLEIGH STREET t: 705.656.4531 e: sayers@apsley.ca

NORTH ARROW

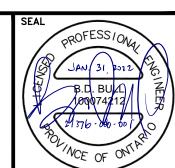

PROJECT TITLE

NEW SAYERS FOOD STORE BURLEIGH STREET, APSLEY


DRAWING TITLE

ROOF PLAN HVAC

SCALE 1:100

JUNE 16, 2021

PROJECT NUMBER

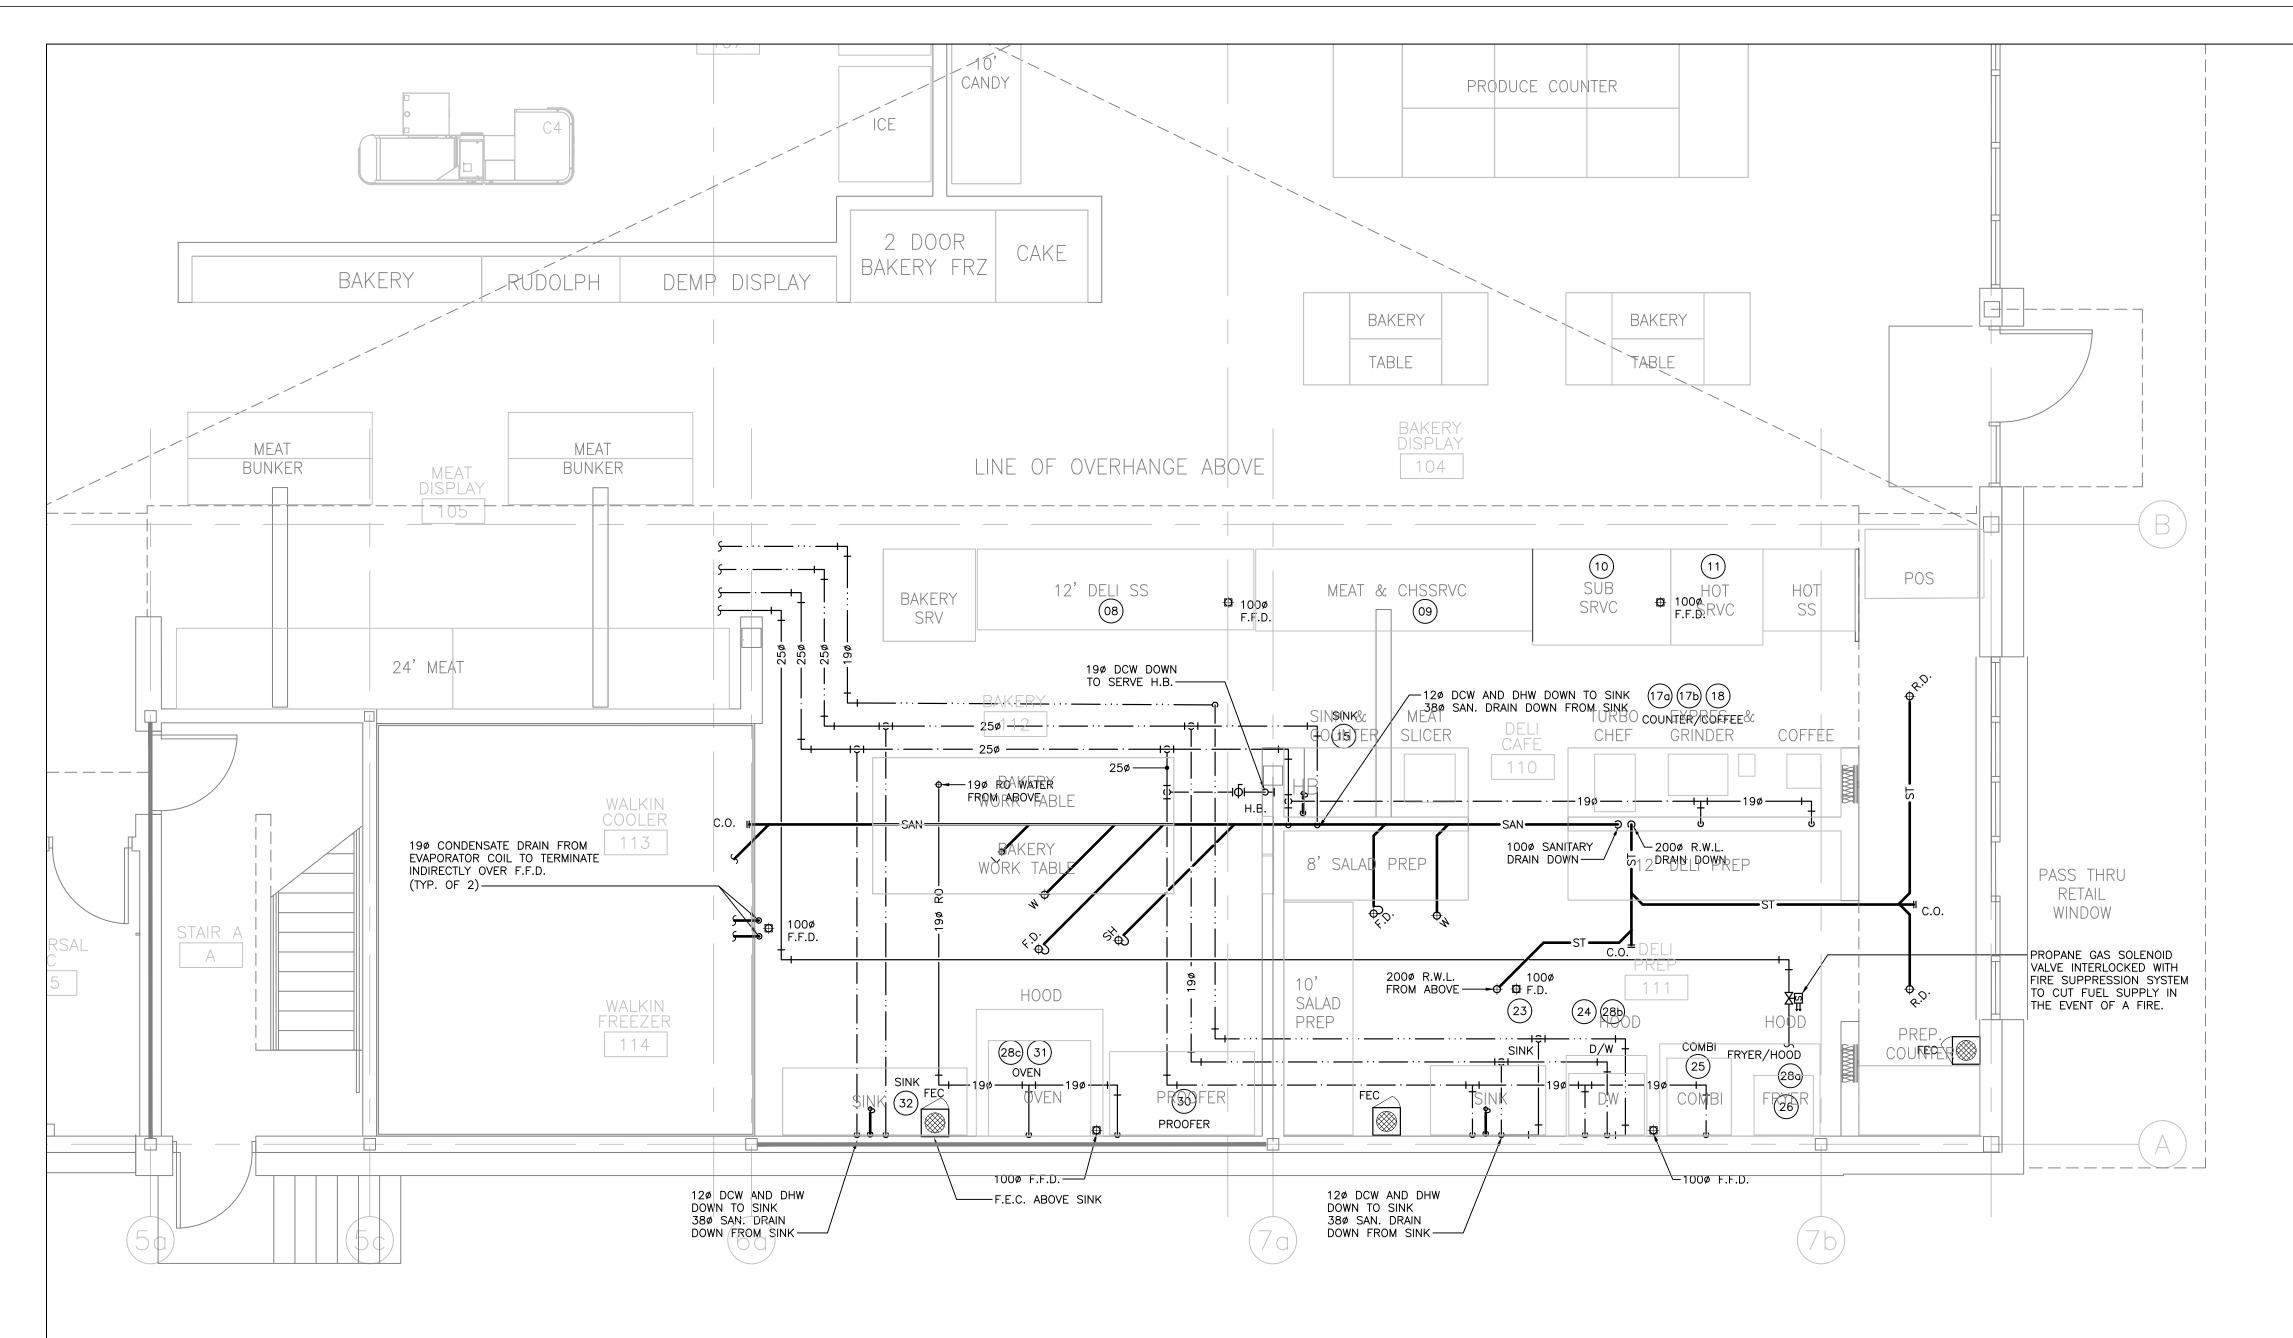

		KITCHE	N EQUIPM	MENT SCH	EDULE				
ITEM NO.	EQUIPMENT CATEGORY	COLD WATER SIZE(MM)	HOT WATER SIZE(M M)	FILTERE D H2O	DIRECT DRAIN SIZE(M M)	INDIR DRAIN SIZE(M M)	INDIRECT DRAIN ROUGH-IN	GAS SIZE(M M)	MBTU/ H
8	12' DELI SELF SERVE					38	FFD		
9	MEAT & CHEESE					38	FFD		
10	SUB SERV					38(x2)	FFD		
11	HOT SRVC					38(x2)	FFD		
15	MEAT SLICER COUNTER/SINK	12	12		38				
17a	ESPRESSO MACHINE	12			25				
18	COFFEE MAKER	6							
23	SINK	12	12		38				
24	DISHWASHER	19	19	19	16				
25	СОМВІ	19				50	FD	19	
26	FRYER							32	700
30	PROOFER	12				19	FD		
31	OVEN	6 NPT		YES					
32	COUNTER/SINK	12	12		38				
33	COOLER					38	FD		
34	FREEZER					38	FD		

- 1. DO NOT SCALE DRAWINGS. THE LOCATIONS OF ALL ITEMS SHOWN ON THE DRAWINGS OR SPECIFIED THAT ARE NOT DEFINITELY FIXED BY DIMENSIONS ARE APPROXIMATE. DETERMINE THE EXACT LOCATIONS NECESSARY TO SECURE THE BEST CONDITIONS AND RESULTS BASED ON SITE CONDITIONS. REVIEW ALL REVISIONS WITH THE CONSULTANT.
- READ FLOOR PLANS IN CONJUNCTION WITH SCHEMATICS. ASSUME INFORMATION SHOWN ON FLOOR PLANS TO BE APPLICABLE TO THE RELATED SYSTEM SCHEMATIC AND VICE-VERSA TO PROVIDE A COMPLETE AND OPERATIONAL
- VERIFY STRUCTURAL INTEGRITY OF ALL TEMPORARY AND PERMANENT OPENINGS. PROVIDE ADDITIONAL FRAMING TO ENSURE STRUCTURAL INTEGRITY AS REQUIRED.
- REFER TO THE STANDARD DETAILS AND DETAIL SHEETS FOR ADDITIONAL INFORMATION.

PLUMBING AND DRAINAGE NOTES:

- PROVIDE MINIMUM 75mm (3 IN.) FOR UNDER GROUND SANITARY DRAINAGE UNLESS INDICATED OTHERWISE.
 PROVIDE APPROVED BACK FLOW PREVENTION FOR ALL TRAP PRIMER SYSTEMS.
- PROVIDE MINIMUM 100mm (4 IN.) FOR UNDER GROUND STORM DRAINAGE UNLESS INDICATED OTHERWISE.
- 4. PROVIDE MINIMUM 19mm (3/4 IN.) DOMESTIC COLD WATER AND DOMESTIC HOT WATER PIPES UNLESS INDICATED
- 5. INSTALL ALL PIPING OVERHEAD, TIGHT TO UNDERSIDE OF THE STRUCTURE WITH SUFFICIENT ROOM FOR INSULATION UNLESS INDICATED OTHERWISE. ROUTE PIPING WITHIN STRUCTURAL STEEL STRATA OR THROUGH CONCRETE BEAMS WHERE PRACTICAL.
- 6. PROVIDE ADDITIONAL P.R.V.'S AS REQUIRED

Contractor must check and verify all dimensions on the job, and report any discrepancies to the Architect before proceeding with the work.

Do not scale this drawing.

REVISIONS AND ISSUES

REV	DESCRIPTION	DATE	В
1	ISSUED FOR TENDER	2021.08.25	
2	ISSUED FOR PERMIT	2021.09.09	
3	ISSUED FOR ADDENDUM #1	2021.09.15	
4	ISSUED FOR ADDENDUM #2	2021.09.27	
5 RE-	-ISSUED FOR TENDER AND PERMIT	2022.01.31	

AMLM

maclennan jaunkalns miller architects

425 adelaide street west level 6 toronto ontario m5v 3c1 416 593 6796 www.mjmarchitects.com

TRITON ENGINEERING SERVICES LTD

18 ROBB BOULEVARD - UNIT 8

ORANGEVILLE, ONTARIO
TEL 519 941 0330 FAX 519 941 1830

BLACKWELL STRUCTURAL ENGINEERS

134 PETER STREET, SUITE 1301 TORONTO, ONTARIO, M5V 2H2 TEL 416.593.5300 FAX 416.593.4840

SMITH + ANDERSON MECHANICAL AND ELECTRICAL ENGINEERS

1100 - 100 SHEPPARD AVENUE EAST TORONTO, ONTARIO, M2N 6N5 TEL 416.487.8151 -




Smith + Andersen

1100 — 100 Sheppard Ave. East, Toronto On, M2N 6N5 416 487 8151 f 416 487 9104 smithandandersen.com

SAYERS FOOD LIMITED

132 BURLEIGH STREET t: 705.656.4531 e: sayers@apsley.ca

NORTH ARROW

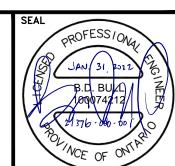

PROJECT TITLE

NEW SAYERS FOOD STORE BURLEIGH STREET, APSLEY

DRAWING TITLE

GROUND FLOOR PLAN
KITCHEN PLUMBING AND

DRAINACE scale

1:50

JUNE 16, 2021


00112 10, 202

PROJECT NUMBER

DRAWING NUMBER

21076

1/5

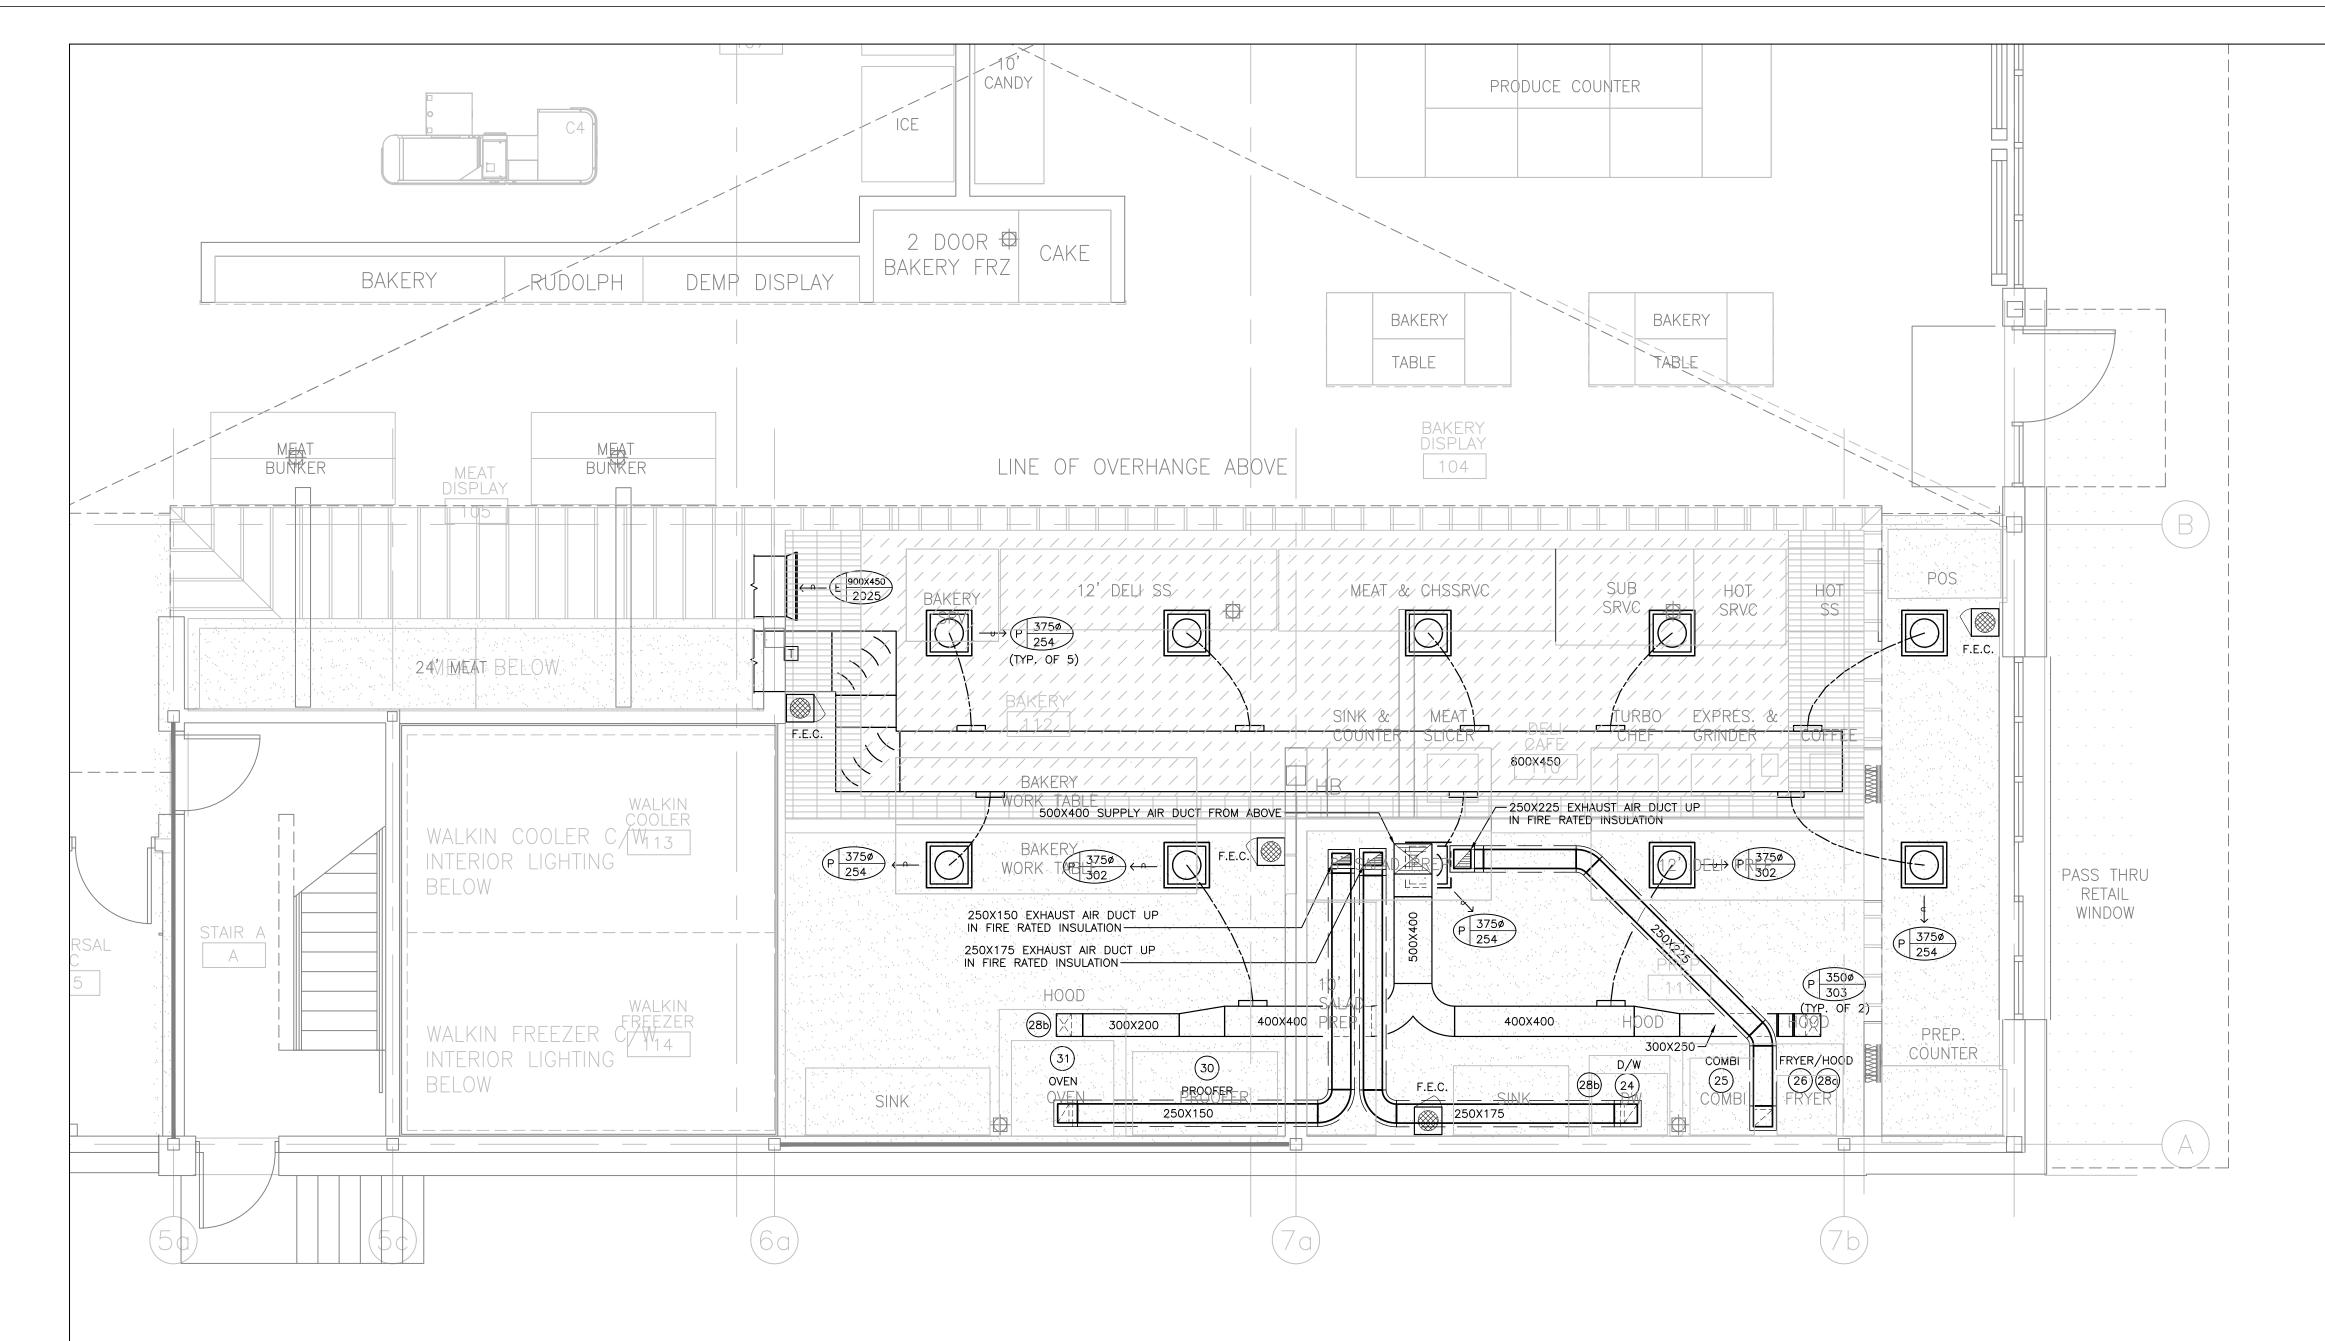

	KITCHEN EQUIPMENT SCHEDULE						
ITEM NO.	EQUIPMENT CATEGORY	DUCT CONNECTI ON SIZE(MM)	EXHAU ST FLOW (CFM)	PRESSUR E DROP	REMARK		
28a	EXHAUST HOOD (Supply)	203x279	504	0.11	SERVING 25, 26		
28a	EXHAUST HOOD (Return)	254x229	840	0.38	SERVING 25, 26		
28b	EXHAUST HOOD	254X178	700	0.25	SERVING 24		
28c	EXHAUST HOOD (Supply)	254X152	363	0.37	SERVING 31		
28c	EXHAUST HOOD (Return)	254X152	605	0.11	SERVING 31		

- 1. DO NOT SCALE DRAWINGS. THE LOCATIONS OF ALL ITEMS SHOWN ON THE DRAWINGS OR SPECIFIED THAT ARE NOT DEFINITELY FIXED BY DIMENSIONS ARE APPROXIMATE. DETERMINE THE EXACT LOCATIONS NECESSARY TO SECURE THE BEST CONDITIONS AND RESULTS BASED ON SITE CONDITIONS. REVIEW ALL REVISIONS WITH THE CONSULTANT.
- READ FLOOR PLANS IN CONJUNCTION WITH SCHEMATICS. ASSUME INFORMATION SHOWN ON FLOOR PLANS TO BE APPLICABLE TO THE RELATED SYSTEM SCHEMATIC AND VICE-VERSA TO PROVIDE A COMPLETE AND OPERATIONAL
- VERIFY STRUCTURAL INTEGRITY OF ALL TEMPORARY AND PERMANENT OPENINGS. PROVIDE ADDITIONAL FRAMING TO ENSURE STRUCTURAL INTEGRITY AS REQUIRED.
- REFER TO THE STANDARD DETAILS AND DETAIL SHEETS FOR ADDITIONAL INFORMATION.

HVAC NOTES:

- REFER TO ARCHITECTURAL REFLECTED CEILING PLANS FOR EXACT LOCATIONS OF GRILLES AND DIFFUSERS. REQUEST CLARIFICATION FOR ANY DIFFUSER OR GRILLE WITH MORE THAN A 600MM (24 IN.) DISCREPANCY IN LOCATION.
- 2. TEMPERATURE SENSORS ARE LOCATED TO AID IN PRICING ONLY AND ALL REQUIRED SENSORS MAY NOT BE SHOWN (REFER TO SPECIFICATIONS). COORDINATE FINAL LOCATION WITH THE ARCHITECT WITHIN 1000MM (40 IN.) OF LOCATION SHOWN. REVIEW ALL RELOCATIONS OUTSIDE OF THIS RANGE WITH THE CONSULTANT.
- INSTALL TEMPERATURE SENSORS AT NOMINALLY 1200MM (48 IN.) ABOVE THE FINISHED FLOOR UNLESS INDICATED OTHERWISE.
- PROVIDE DIFFUSER DUCT RUN-OUTS THE SAME SIZE AS THE DIFFUSER INLETS UNLESS INDICATED OTHERWISE.
- 5. MAINTAIN A MINIMUM OF 2400MM (96 IN.) CLEARANCE TO THE UNDERSIDE OF PIPES, DUCTS, CONDUITS, SUSPENDED EQUIPMENT, ETC. THROUGHOUT ACCESS ROUTES IN MECHANICAL ROOMS.
- 6. INSTALL ALL PIPING OVERHEAD, TIGHT TO UNDERSIDE OF THE STRUCTURE WITH SUFFICIENT ROOM FOR INSULATION UNLESS INDICATED OTHERWISE. ROUTE PIPING WITHIN STRUCTURAL STEEL STRATA OR THROUGH CONCRETE BEAMS WHERE
- VERIFY STRUCTURAL INTEGRITY OF ALL TEMPORARY AND PERMANENT OPENINGS. PROVIDE ADDITIONAL FRAMING TO ENSURE STRUCTURAL INTEGRITY AS REQUIRED.
 PROVIDE ALL OPEN ENDED DUCTWORK COMPLETE WITH WIRE
- PROVIDE 600X400X1200 (WXHXL) INTERNAL ACOUSTIC INSULATED ELBOW OR STRAIGHT TRANSFER DUCTS UNLESS INDICATED OTHERWISE. TRANSFER AIR DUCTS IN LIEU OF SILENCERS ARE NOT PERMITTED.

Contractor must check and verify all dimensions on the job, and report any discrepancies to the Architect before proceeding with the work.

Do not scale this drawing.

Do not scale this drawing.

REVISIONS AND ISSUES

DESCRIPTION DATE

ISSUED FOR TENDER 2021.08.25

3 RE-ISSUED FOR TENDER AND PERMIT 2022.01.31

2021.09.09

ISSUED FOR PERMIT

MJMA

maclennan jaunkalns miller architects

425 adelaide street west level 6 toronto ontario m5v 3c1 416 593 6796 www.mjmarchitects.com

TRITON ENGINEERING SERVICES LTD

18 ROBB BOULEVARD – UNIT 8
ORANGEVILLE, ONTARIO
TEL 519 941 0330 FAX 519 941 1830

519 941 0330 FAX 519 94

BLACKWELL STRUCTURAL ENGINEERS

134 PETER STREET, SUITE 1301 TORONTO, ONTARIO, M5V 2H2 TEL 416.593.5300 FAX 416.593.4840

SMITH + ANDERSON
MECHANICAL AND ELECTRICAL ENGINEERS

1100 - 100 SHEPPARD AVENUE EAST
TORONTO, ONTARIO, M2N 6N5
TEL 416.487.8151 -




Smith + Andersen

1100 — 100 Sheppard Ave. East, Toronto On, M2N 6N5 416 487 8151 f 416 487 9104 smithandandersen.com

SAYERS FOOD LIMITED

132 BURLEIGH STREET t: 705.656.4531 e: sayers@apsley.ca

NORTH ARROW

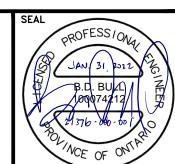

PROJECT TITLE

NEW SAYERS FOOD STORE BURLEIGH STREET, APSLEY

DRAWING TITLE

GROUND FLOOR PLAN KITCHEN HVAC

SCALE 1:50

JUNE 16, 2021

PROJECT NUMBER 21076

Z I U / O

DRAWING NUMBER

M502