


FIREARMS OUTLET CANADA
INTERIOR RENOVATION & ADDITION

725 WESTNEY ROAD SOUTH
AJAX, ONTARIO L1S 7J7

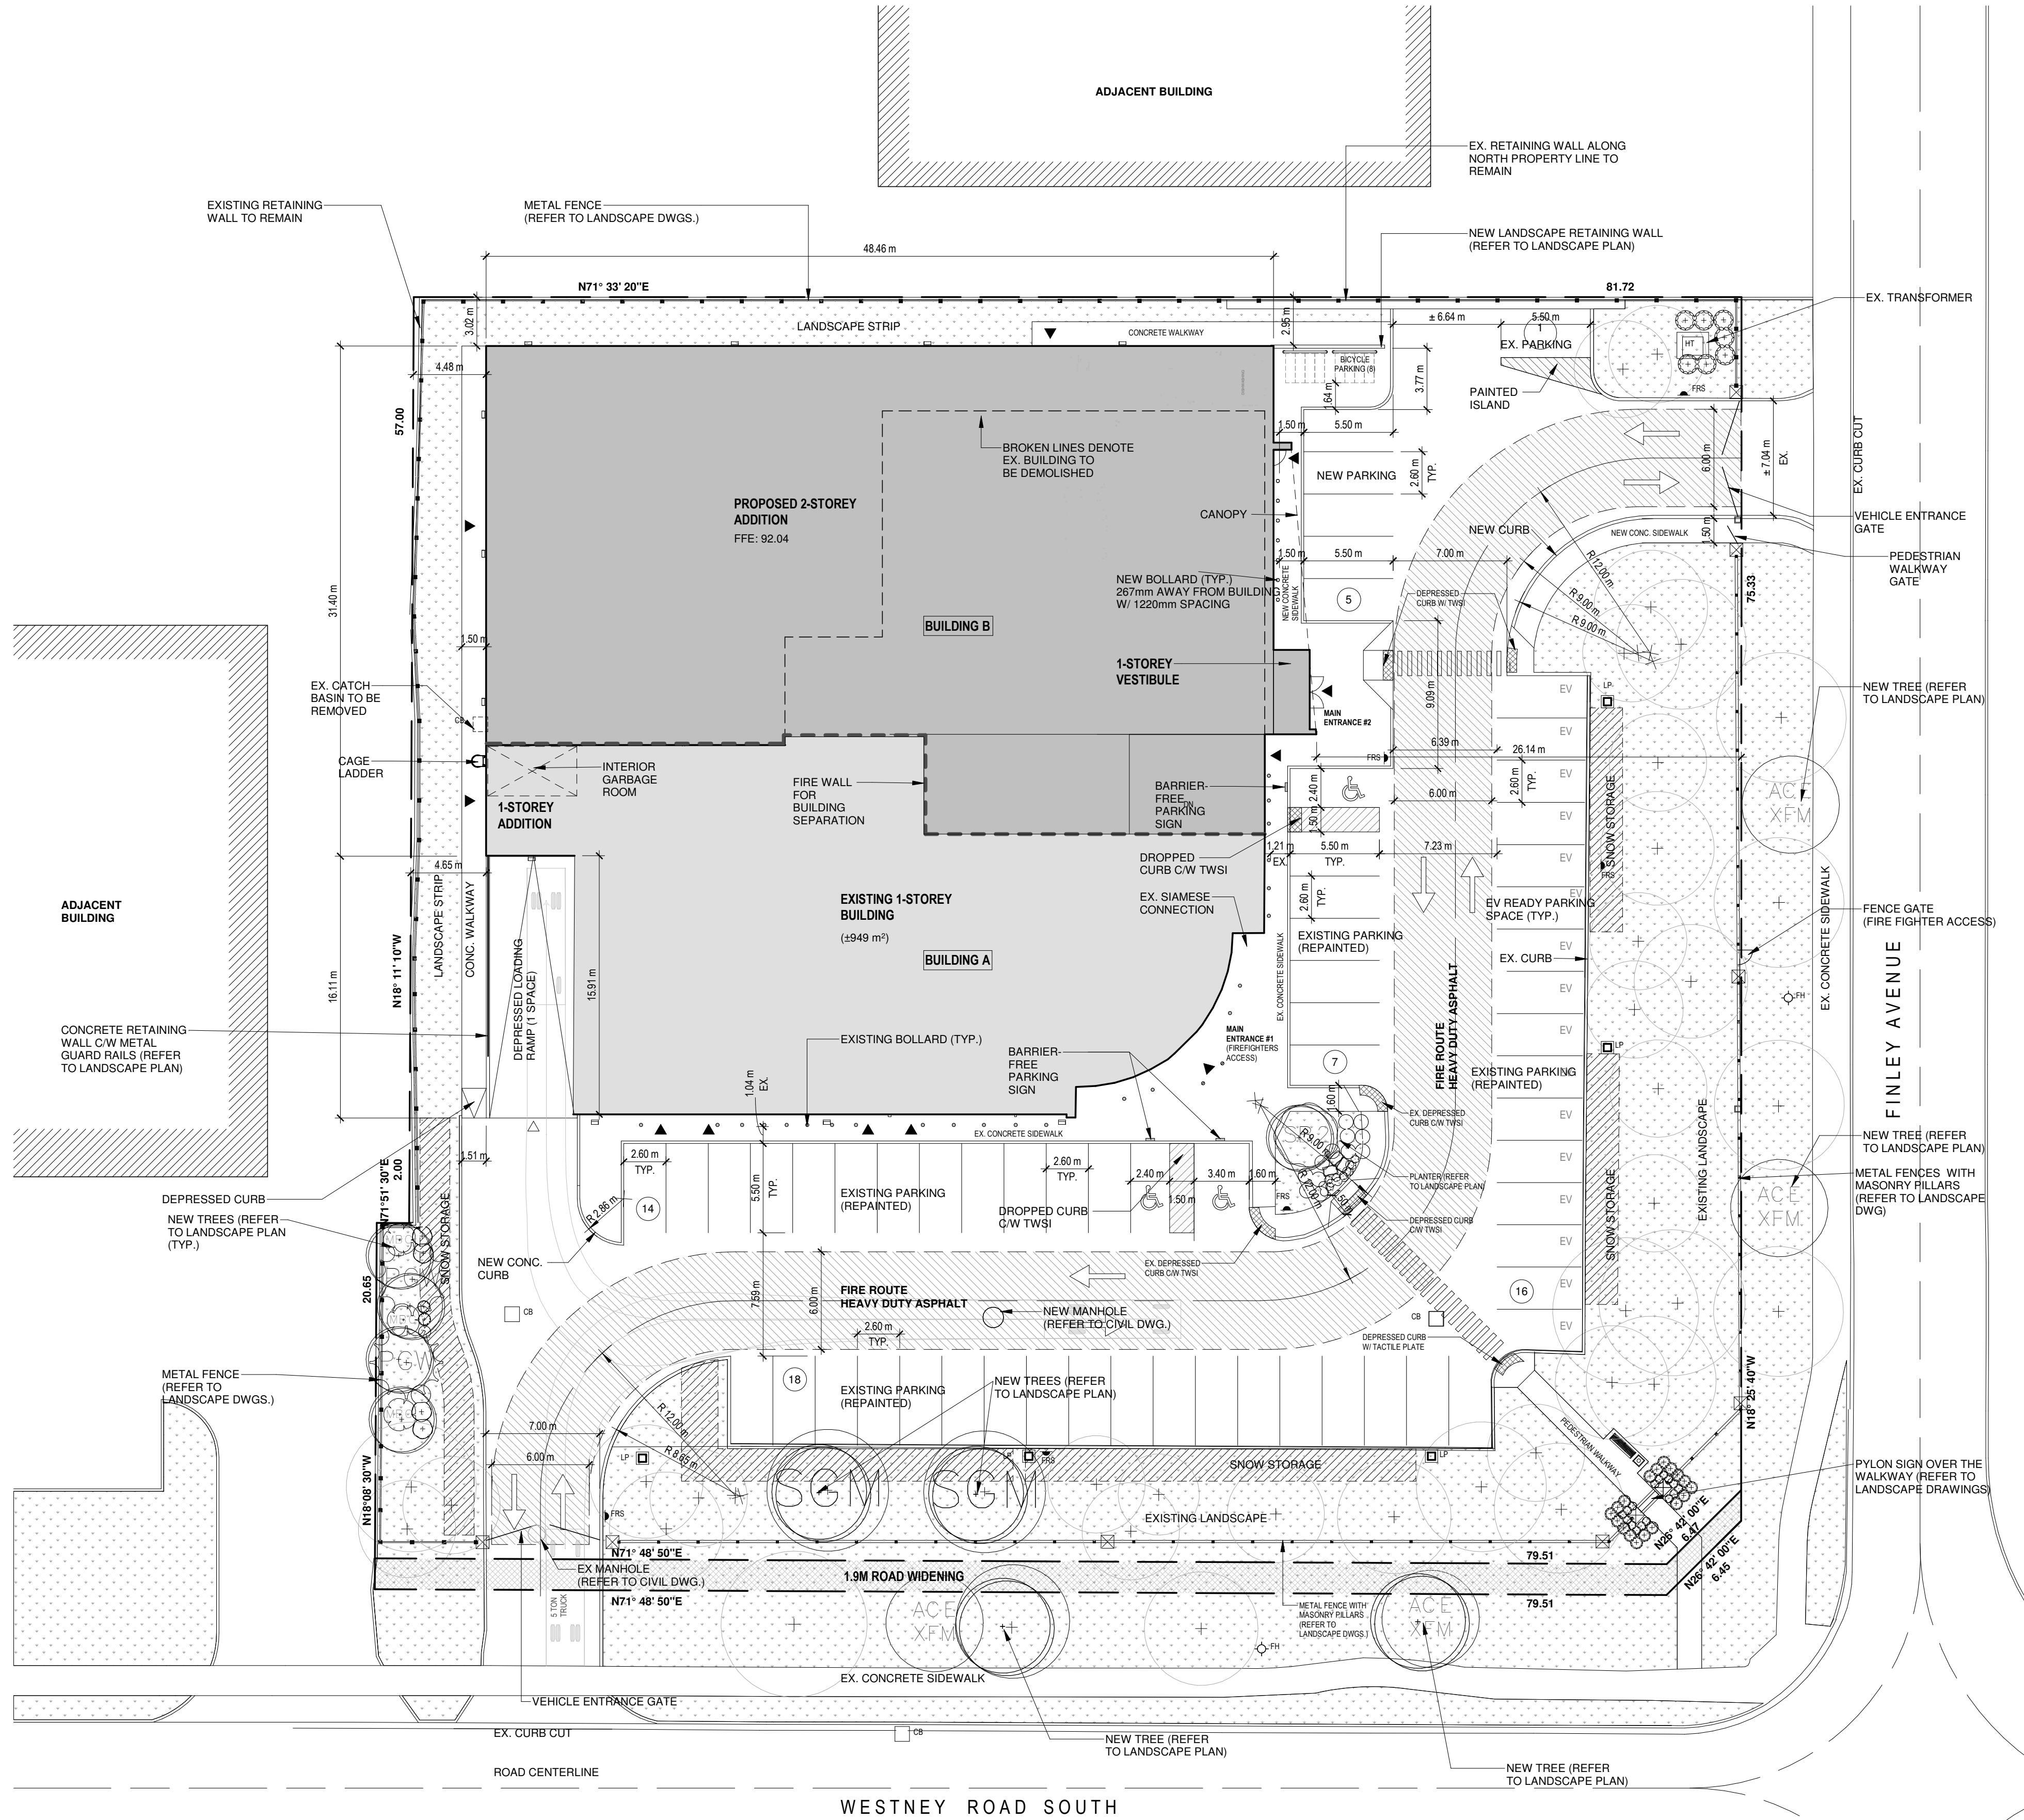

LOCATION MAP

SITE STATISTICS	
LOT AREA: ±6,563.15 m ²	
DEVELOPABLE (NET) LOT AREA: 6,324.71 m ²	
ZONING CATEGORY: PE	
SETBACKS	FRONT YARD: ±26.1m
	EXTERIOR SIDE YARD: 27.1m
	INTERIOR SIDE YARD: 4.5m
	REAR YARD: 3.0m
BUILDING AREA	EXISTING: ±854 m ² (9191 SF)
	ADDITION: 1,314 m ² (14,144 SF)
	TOTAL: 2,168 m ² (23,335 SF)
	EXISTING: ±854 m ² (9191 SF)
GFA	ADDITION: GROUND FLOOR: 1,314 m ² (14,144 SF)
	SECOND FLOOR: 1,207 m ² (13,001 SF)
	TOTAL: 2,521 m ² (27,145 SF)
	TOTAL: 3,375 m ² (36,336 SF)
LOT COVERAGE	33.9%
FSI	0.53
BUILDING HEIGHT	15.06m
GFA BREAKDOWN	RETAIL: 271 m ² (8% OF GFA)
	OFFICES: 84.2 m ²
	CLASSROOMS: 96 m ²
	WASHROOMS: 67 m ²
PARKING	VESTIBULES: 20 m ²
	SECURITY ROOM: 17 m ²
	STAFF/LUNCH ROOM: 8 m ²
	LOBBY: 60 m ²
	RESTAURANT: 245 m ²
	LOADING: 24 m ²
	WAREHOUSE: 311 m ²
	SHOOTING RANGES:
	TRADITIONAL RANGE: 625 m ² (BOOTH: 56 m ²) (15 LANES)
	CLAYHOUSE SHOTGUN RANGE: 1,059 m ²
	BOOTH: 89 m ² (8 LANES)
	TOTAL: 1,684 m ² (BOOTH: 145 m ²) (23 LANES)
OTHER SPACES: 448 m ²	(CORRIDOR/MECH ROOM/ELEC ROOM/ JANITOR/STAIRS/ LOBBY)
	STORAGE/
	STORAGE/
	STORAGE/
PARKING	REQUIRED: RETAIL: 10 SPACES (1 PER 28m ²)
	CLASSROOMS: 5 SPACES (1 PER 20m ²)
	WAREHOUSE: 1 SPACE (1 PER 500m ²)
	RESTAURANT: 35 SPACES (1 PER 10m ²)
PARKING	SHOOTING RANGES: 21 SPACES (0.92 PER LANE)
	TOTAL: 61 SPACES
PARKING	PROVIDED: 61 SPACES
	(INCLUDING 3 BARRIER-FREE PARKING SPACES)
	(INCLUDING 16 EV READY PARKING SPACES)
	TOTAL: 61 SPACES
BICYCLE PARKING	PROVIDED: 8 SPACES (SHORT TERM)
	SNOW STORAGE
	PROVIDED: 205 m ²
	LANDSCAPED AREA
PAVED AREA	1,978 m ² (31% LOT AREA)
	SOFT LANDSCAPE
LANDSCAPED AREA	1,415 m ² (71.5% LANDSCAPED AREA)

SHEET LIST	
Sheet Number	Sheet Name
A1.1	SITE PLAN
A1.2	IBC MATRIX & CONSTRUCTION NOTES
A1.3	ASSEMBLIES
A1.4	FIRE SEPARATION PLAN
A2.1	DEMO FLOOR PLAN
A2.2	GROUND FLOOR PROPOSED PLAN
A2.3	SECOND FLOOR PLAN
A2.4	ROOF PLAN
A2.5	REFLECTED CEILING PLAN - GROUND FLOOR
A2.6	REFLECTED CEILING PLAN - SECOND FLOOR
A2.7	FLOOR FINISH PLAN - GROUND FLOOR
A2.8	FLOOR FINISH PLAN - SECOND FLOOR
A2.9	ENLARGE FLOOR PLAN
A2.10	ENLARGE FLOOR PLAN
A3.1	BUILDING ELEVATIONS
A3.2	BUILDING ELEVATIONS
A4.1	BUILDING SECTIONS
A4.2	BUILDING SECTIONS
A4.3	WALL SECTION
A4.4	WALL SECTION
A4.5	DOOR & WINDOW & ROOM FINISH SCHEDULES
A4.6	WASHROOM DETAIL
A4.7	STAIR B DETAILS
A4.8	STAIR B DETAILS
A4.9	ELEVATOR SHAFT SECTION
A5.1	WALL SECTION DETAILS
A5.2	SECTION DETAILS
A5.3	PLAN DETAILS

LEGEND	
---	PROPERTY LINE
▶	MEN DOOR (ENTRANCES & EXITS)
◻	TRUCK ENTRANCES
◻	HYDRO TRANSFORMER
⊕	FIRE HYDRANT
⊕	CATCH BASIN
⊕	FIRE DEPARTMENT CONNECTION
⊕	FIRE ROUT SIGN
⊕	INDICATE NUMBER OF PARKING SPACES
⊕	ACCESSIBLE PARKING SPACES
⊕	LIGHT POLE (REFER TO ELEC. PLAN)
---	FIRE WALL SEPARATION
EV	ELECTRIC VEHICLE

16	05/28/2025	ISSUED FOR PERMIT	HW
15	03/19/2025	ISSUED FOR SPA	HW
14	09/17/2024	ISSUED FOR REVIEW	HW
13	06/21/2024	ISSUED FOR PRE-CON PHASE II	HW
12	06/12/2024	ISSUED FOR COORDINATION	HW
11	06/05/2024	ISSUED FOR COORDINATION	HW
10	05/29/2024	ISSUED FOR COORDINATION	HW
9	05/03/2024	ISSUED FOR COORDINATION	HW
8	04/09/2024	ISSUED FOR COORDINATION	HW
7	12/19/2023	ISSUED FOR REVIEW	HW
6	12/18/2023	ISSUED FOR COORDINATION	HW
5	12/08/2023	ISSUED FOR REVIEW	HW
4	11/21/2023	ISSUED FOR REVIEW	HW
3	11/06/2023	ISSUED FOR REVIEW	HW
2	07/18/2023	ISSUED FOR REVIEW	HW
1	07/17/2023	ISSUED FOR REVIEW	HW
No.	Date:	Issued/Revision:	By

Client:

FIREARMS OUTLET CANADA

WANG ARCHITECTS INC.
3950 14th Ave, Unit 609
Markham, ON L3R 0A9
T: 905-604-6960
E: info@wangarchitects.ca
www.wangarchitects.ca



Project : FIREARMS OUTLET CANADA

725 WESTNEY RD. S.,
AJAX, ON L1S 7J7

Drawing Name : SITE PLAN

Scale :	As indicated	Project No :	00026
Drawn by :	ZC	Drawing No :	A1.1
Checked by :	HW		

NAME OF PRACTICE:
NAME OF PROJECT:
PROJECT LOCATION:

WANG ARCHITECTS INC.
FIREARMS OUTLET CANADA
725 WESTNEY ROAD SOUTH
AJAX, ONTARIO L1S 7J7

ONTARIO BUILDING CODE DATA MATRIX PART 3 (BUILDING "A" EXISTING)										BUILDING CODE REFERENCE
3.01	PROJECT TYPE:	<div><div><input type="checkbox"/> NEW CONSTRUCTION <input type="checkbox"/> CHANGE OF USE</div><div><input type="checkbox"/> ADDITION <input checked="" type="checkbox"/> ADDITION AND RENOVATION</div><div><input type="checkbox"/> RENOVATION</div></div>								[A] 1.1.2.2.
3.02	MAJOR OCCUPANCY CLASSIFICATION:	<div>OCCUPANCY GROUP F, DIVISION 1 HIGH HAZARDOUS INDUSTRIAL OCCUPANCY GROUP E, MERCANTILE OCCUPANCIES</div> <div>USE WAREHOUSE & RETAIL</div>								3.1.2.
3.03	SUPERIMPOSED MAJOR OCCUPANCIES:	<input checked="" type="checkbox"/> NO <input type="checkbox"/> YES								3.2.2.7.
3.04	BUILDING AREA (M²)	DESCRIPTION: <div>EXISTING ± 811.4 M²NEW 39.6 M²TOTAL 851 M²</div>								[A] 1.4.1.2.
3.05	GROSS AREA (M²)	GROUND FLOOR <div>EXISTING ± 811.4 M²NEW 39.6 M²TOTAL 851 M²</div>								[A] 1.4.1.2.
3.07	BUILDING HEIGHT	1 STOREYS ABOVE GRADE 6.48m ABOVE GRADE								[A] 1.4.1.2. & 3.2.1.1.
3.08	HIGH BUILDING	<input checked="" type="checkbox"/> NO <input type="checkbox"/> YES								3.2.6.
3.09	NUMBER OF STREETS/ FIREFIGHTER ACCESS	2 STREETS								3.2.2.10. & 3.2.5.
3.10	BUILDING CLASSIFICATION	3.2.2.74 GROUP F, DIVISION 1, UP TO 2 STOREYS, SPRINKLERED								3.2.2.20 - 83.
3.11	SPRINKLER SYSTEM	<div><input checked="" type="checkbox"/> REQUIRED <input type="checkbox"/> NOT REQUIRED</div> <div>PROVIDED <div><input checked="" type="checkbox"/> ENTIRE BUILDING <input type="checkbox"/> SELECTED FLOOR AREA <input type="checkbox"/> IN LIEU OF ROOF RATING</div><div><input type="checkbox"/> SELECTED COMPARTMENTS <input type="checkbox"/> BASEMENT <input type="checkbox"/> NONE</div></div>								3.2.1.5. & 3.2.2.17, 3.2.2.18, 3.2.4.8. TO 3.2.4.10, AND 3.2.5.13
3.12	STANDPIPE SYSTEM	<input type="checkbox"/> REQUIRED <input checked="" type="checkbox"/> NOT REQUIRED								3.2.9.
3.13	FIRE ALARM SYSTEM	<div><input checked="" type="checkbox"/> REQUIRED <input type="checkbox"/> NOT REQUIRED</div> <div>TYPE PROVIDED: <input type="checkbox"/> SINGLE STAGE <input type="checkbox"/> TWO STAGE <input type="checkbox"/> NONE</div>								3.2.4.
3.14	WATER SERVICE / SUPPLY IS ADEQUATE	<input type="checkbox"/> NO <input checked="" type="checkbox"/> YES								3.2.5.7.
3.15	CONSTRUCTION TYPE:	<div>RESTRICTION: <input checked="" type="checkbox"/> COMBUSTIBLE PERMITTED <input type="checkbox"/> NON-COMBUSTIBLE REQUIRED <input type="checkbox"/> ENCAPSULATED MASS TIMBER</div> <div>ACTUAL: <div><input type="checkbox"/> COMBUSTIBLE <input type="checkbox"/> COMBINATION OF COMBUSTIBLE AND NON-COMBUSTIBLE <input type="checkbox"/> ENCAPSULATED MASS TIMBER <input type="checkbox"/> COMBINATION OF ENCAPSULATED MASS TIMBER AND NON-COMBUSTIBLE</div><div>HEAVY TIMBER CONSTRUCTION: <input checked="" type="checkbox"/> NO <input type="checkbox"/> YES</div></div>								3.2.2.20 - 83. & 3.2.1.4.
3.16	IMPORTANCE CATEGORY:	<div><input type="checkbox"/> LOW <input type="checkbox"/> LOW HUMAN OCCUPANCY <input type="checkbox"/> POST-DISASTRE SHELTER</div> <div><input checked="" type="checkbox"/> NORMAL <input type="checkbox"/> HIGH <input type="checkbox"/> MINOR STORAGE BUILDING <input type="checkbox"/> EXPLOSIVE OR HAZARDOUS SUBSTANCES <input type="checkbox"/> POST-DISASTER</div>								4.1.2.1.(3) & 74.1.2.1.8
3.18	OCCUPANT LOAD (ADDITION ONLY)	<div>FLOOR LEVEL/AREA OCCUPANCY TYPE BASED ON OCCUPANT LOAD (PERSONS)</div> <div>RETAIL AND WHARE HOUSE E & F1 DESIGN LOAD 48 TOTAL: 48</div>								3.1.1.7 AND 3.1.17.1.(2)
3.19	BARRIER-FREE DESIGN: BARRIER-FREE ENTRANCES:	<div><input type="checkbox"/> NO <input checked="" type="checkbox"/> YES</div> <div>NUMBER: 1</div>								3.8. 3.1.8.2.
3.20	HAZARDOUS SUBSTANCES:	<input type="checkbox"/> NO <input checked="" type="checkbox"/> YES								3.3.1.2. & 3.3.1.19.
3.21	REQUIRED FIRE RESISTANCE RATINGS	<div>HORIZONTAL ASSEMBLY RATING (H) SUPPORTING ASSEMBLY (H) NONCOMBUSTIBLE IN LIEU OF RATING?</div> <div>3.2.2.20 - 83., 3.2.1.2., 3.2.1.4., 3.2.2.15.</div> <div>STOREYS BELOW GRADE N/A N/A <input type="checkbox"/> NO <input type="checkbox"/> YES <input checked="" type="checkbox"/> N/A FLOORS OVER BASEMENT N/A N/A <input type="checkbox"/> NO <input type="checkbox"/> YES <input checked="" type="checkbox"/> N/A FLOORS N/A N/A <input type="checkbox"/> NO <input type="checkbox"/> YES <input checked="" type="checkbox"/> N/A MEZZANINE N/A N/A <input type="checkbox"/> NO <input type="checkbox"/> YES <input checked="" type="checkbox"/> N/A ROOF - - <input checked="" type="checkbox"/> NO <input type="checkbox"/> YES <input type="checkbox"/> N/A</div>								
3.22a	SPATIAL SEPARATION	<div>EXPOSING BUILDING FACE EBF AREA (M²) L.D. (M) L/H REQUIRED FRR (H) % UNPROTECTED OPENINGS PERMITTED % UNPROTECTED OPENINGS PROVIDED</div> <div>NORTH - - - - - EAST - - - - - SOUTH N/A - - - - - WEST 166 10.19 3.7:1 1 60 1.8</div>								3.2.3.
3.23a	PLUMBING FIXTURE REQUIREMENTS:	<div>RATIO: MALE:FEMALE = 50:50 EXCEPT AS NOTED OTHERWISE</div> <div>WATER CLOSETS REQUIRED: (EXISTING) WHARE HOUSE & RETAIL : 2 FIXTURE FOR MALES, 2 FIXTURE FOR FEMALES</div> <div>TOTAL: : 2 FIXTURES FOR MALES, 2 FIXTURES FOR FEMALES.</div> <div>WATER CLOSETS PROVIDED: 1 FIXTURES FOR MALES, 1 FIXTURES FOR FEMALES (SHARE WITH THE PROPOSED EXTENSION PLUMBING FIXTURE) 1 UNIVERSAL WASHROOM</div>								3.7.4., 3.8.2.3.

NAME OF PRACTICE:
NAME OF PROJECT:
PROJECT LOCATION:

WANG ARCHITECTS INC.
FIREARMS OUTLET CANADA
725 WESTNEY ROAD SOUTH
AJAX, ONTARIO L1S 7J7

ONTARIO BUILDING CODE DATA MATRIX PART 3 (BUILDING "B" NEW)										BUILDING CODE REFERENCE
3.01	PROJECT TYPE:	<div><div><input type="checkbox"/> NEW CONSTRUCTION <input type="checkbox"/> CHANGE OF USE</div><div><input type="checkbox"/> ADDITION <input checked="" type="checkbox"/> ADDITION AND RENOVATION</div><div><input type="checkbox"/> RENOVATION</div></div>								[A] 1.1.2.2.
3.02	MAJOR OCCUPANCY CLASSIFICATION:	<div>OCCUPANCY GROUP A, DIVISION 2 ASSEMBLY OCCUPANCY</div> <div>USE SHOOTING RANGE & RESTAURANT</div>								3.1.2.
3.03	SUPERIMPOSED MAJOR OCCUPANCIES:	<input checked="" type="checkbox"/> NO <input type="checkbox"/> YES								3.2.2.7.
3.04	BUILDING AREA (M²)	DESCRIPTION: <div>EXISTING -NEW 1,284 M²TOTAL 1,284 M²</div>								[A] 1.4.1.2.
3.05	GROSS AREA (M²)	GROUND FLOOR EXISTING -NEW 1,284 M²TOTAL 1,284 M² SECOND FLOOR - 1,187 M²1,187 M² TOTAL - 2,471 M²2,471 M²								[A] 1.4.1.2.
3.07	BUILDING HEIGHT	2 STOREYS ABOVE GRADE 14.06m ABOVE GRADE 0 STOREY BELOW GRADE								[A] 1.4.1.2. & 3.2.1.1.
3.08	HIGH BUILDING	<input checked="" type="checkbox"/> NO <input type="checkbox"/> YES								3.2.6.
3.09	NUMBER OF STREETS/ FIREFIGHTER ACCESS	2 STREETS								3.2.2.10. & 3.2.5.
3.10	BUILDING CLASSIFICATION	3.2.2.26 GROUP A, DIVISION 2, UP TO 2 STOREYS, INCREASED AREA, SPRINKLERED								3.2.2.20 - 83.
3.11	SPRINKLER SYSTEM	<div><input checked="" type="checkbox"/> REQUIRED <input type="checkbox"/> NOT REQUIRED</div> <div>PROVIDED <div><input checked="" type="checkbox"/> ENTIRE BUILDING <input type="checkbox"/> SELECTED FLOOR AREA <input type="checkbox"/> IN LIEU OF ROOF RATING</div><div><input type="checkbox"/> SELECTED COMPARTMENTS <input type="checkbox"/> BASEMENT <input type="checkbox"/> NONE</div></div>								3.2.1.5. & 3.2.2.17, 3.2.2.18, 3.2.4.8. TO 3.2.4.10, AND 3.2.5.13
3.12	STANDPIPE SYSTEM	<input type="checkbox"/> REQUIRED <input checked="" type="checkbox"/> NOT REQUIRED								3.2.9.
3.13	FIRE ALARM SYSTEM	<div><input checked="" type="checkbox"/> REQUIRED <input type="checkbox"/> NOT REQUIRED</div> <div>TYPE PROVIDED: <input type="checkbox"/> SINGLE STAGE <input type="checkbox"/> TWO STAGE <input type="checkbox"/> NONE</div>								3.2.4.
3.14	WATER SERVICE / SUPPLY IS ADEQUATE	<input type="checkbox"/> NO <input checked="" type="checkbox"/> YES								3.2.5.7.
3.15	CONSTRUCTION TYPE:	<div>RESTRICTION: <input checked="" type="checkbox"/> COMBUSTIBLE PERMITTED <input type="checkbox"/> NON-COMBUSTIBLE REQUIRED <input type="checkbox"/> ENCAPSULATED MASS TIMBER</div> <div>ACTUAL: <div><input type="checkbox"/> COMBUSTIBLE <input type="checkbox"/> COMBINATION OF COMBUSTIBLE AND NON-COMBUSTIBLE <input type="checkbox"/> ENCAPSULATED MASS TIMBER <input type="checkbox"/> COMBINATION OF ENCAPSULATED MASS TIMBER AND NON-COMBUSTIBLE</div><div>HEAVY TIMBER CONSTRUCTION: <input checked="" type="checkbox"/> NO <input type="checkbox"/> YES</div></div>								3.2.2.20 - 83. & 3.2.1.4.
3.16	IMPORTANCE CATEGORY:	<div><input type="checkbox"/> LOW <input type="checkbox"/> LOW HUMAN OCCUPANCY <input type="checkbox"/> POST-DISASTRE SHELTER</div> <div><input checked="" type="checkbox"/> NORMAL <input type="checkbox"/> HIGH <input type="checkbox"/> MINOR STORAGE BUILDING <input type="checkbox"/> EXPLOSIVE OR HAZARDOUS SUBSTANCES <input type="checkbox"/> POST-DISASTER</div>								4.1.2.1.(3) & 74.1.2.1.8
3.18	OCCUPANT LOAD (ADDITION ONLY)	<div>FLOOR LEVEL/AREA OCCUPANCY TYPE BASED ON OCCUPANT LOAD (PERSONS)</div> <div>RESTAURANT & STAFF A2 DESIGN LOAD 140 PATRONS, EMPLOYEE 5 SHOOTING RANGES, CLASSROOM A2 DESIGN LOAD 50 TOTAL: 195</div>								3.1.1.7 AND 3.1.17.1.(2)
3.19	BARRIER-FREE DESIGN: BARRIER-FREE ENTRANCES:	<div><input type="checkbox"/> NO <input checked="" type="checkbox"/> YES</div> <div>NUMBER: 2</div>								3.8. 3.1.8.2.
3.20	HAZARDOUS SUBSTANCES:	<input type="checkbox"/> NO <input checked="" type="checkbox"/> YES								3.3.1.2. & 3.3.1.19.
3.21	REQUIRED FIRE RESISTANCE RATINGS	<div>HORIZONTAL ASSEMBLY RATING (H) SUPPORTING ASSEMBLY (H) NONCOMBUSTIBLE IN LIEU OF RATING?</div> <div>3.2.2.20 - 83., 3.2.1.2., 3.2.1.4., 3.2.2.15.</div> <div>STOREYS BELOW GRADE N/A N/A <input type="checkbox"/> NO <input type="checkbox"/> YES <input type="checkbox"/> N/A FLOORS OVER BASEMENT N/A N/A <input type="checkbox"/> NO <input type="checkbox"/> YES <input type="checkbox"/> N/A FLOORS N/A N/A <input type="checkbox"/> NO <input type="checkbox"/> YES <input type="checkbox"/> N/A MEZZANINE N/A N/A <input type="checkbox"/> NO <input type="checkbox"/> YES <input type="checkbox"/> N/A ROOF N/A N/A <input type="checkbox"/> NO <input type="checkbox"/> YES <input type="checkbox"/> N/A</div>								
3.22a	SPATIAL SEPARATION	<div>EXPOSING BUILDING FACE EBF AREA (M²) L.D. (M) L/H REQUIRED FRR (H) % UNPROTECTED OPENINGS PERMITTED % UNPROTECTED OPENINGS PROVIDED</div> <div>NORTH 609 3.0 3.7:1 2 22 0.16 EAST N/A - - - - - SOUTH N/A - - - - - WEST 363 10.19 3.7:1 2 50 1.65</div>								3.2.3.
3.23a	PLUMBING FIXTURE REQUIREMENTS:	<div>RATIO: MALE:FEMALE = 50:50 EXCEPT AS NOTED OTHERWISE</div> <div>WATER CLOSETS REQUIRED: CLASSROOM, OFFICE AND SHOOTING RANGE: 1 FIXTURE FOR MALES, 1 FIXTURE FOR FEMALES RESTAURANT : 2 FIXTURES FOR MALES, 2 FIXTURES FOR FEMALES EMPLOYEE : 1 FIXTURE FOR BOTH FEMALES AND MALES</div> <div>TOTAL: 3 FIXTURES FOR MALES, 3 FIXTURES FOR FEMALES, 1 FIXTURE FOR RESTAURANT EMPLOYEES</div> <div>WATER CLOSETS PROVIDED: 3 FIXTURES FOR MALES, 3 FIXTURES FOR FEMALES, 1 UNIVERSAL WASHROOM 1 FIXTURE FOR RESTAURANT EMPLOYEES</div>								3.7.4., 3.8.2.3.

ABBREVIATIONS	
ACST. A.F.F. AL. AP AVG. & @	ACOUSTIC ABOVE FINISHED FLOOR ALUMINUM ACCESS PANEL AVERAGE AND AT SPACEING
BLOG. BOT. BM.	BUILDING BOTTOM BEAM
CB CH CL. CLG. CONC. CONT. CORR. CT	CATCH BASIN CEILING HEIGHT CENTERLINE CEILING CAULKING CONCRETE CONTINUOUS CORRIDOR CERAMIC TILE
DET. DIA. DIM. DIST DN DWG. DS DEPT.	DETAIL DIAMETER DIMENSION DISTANCE DOWN DRAWING DOWN SPOUT DEPARTMENT
EL. ELEC. ELEV. EMER. ENT. EQ. EQUIP. EX. EXH. EXT. EV	ELEVATION ELECTRICAL ELEVATOR EMERGENCY ENTRANCE EQUAL EQUIPMENT EXISTING EXHAUST EXTERIOR ELECTRIC VEHICAL
FD FF FFL FIN. FIX. FL FRR	FLOOR DRAIN FINISHED FLOOR FINISHED FLOOR LEVEL FINISH FIXTURE FLOOR FIRE-RESISTANCE RATING
GA GALV. GEN. GL GLS. GYP.	GARAGE GALVANIZED GENERAL GROUND LEVEL GLASS GYPSUM
HM HOR. HP HT. HVAC	HOLLOW METAL HORIZONTAL HIGH POINT HEIGHT HEATING, VENTILATION AND AIR CONDITIONING
INSUL. INT. JAN.	INSULATED INTERIOR JANITOR

GENERAL NOTES

1. THE CONTRACTOR SHALL COMPLY WITH RULES AND REGULATIONS FOR CONSTRUCTION WITHIN THE BUILDING AS SET OUT IN THE ONTARIO BUILDING CODE.

2. THESE DRAWINGS ARE NOT FOR CONSTRUCTION UNTIL A PERMIT IS ISSUED BY MUNICIPALITY.

3. GENERAL CONTRACTOR TO SITE VERIFY ALL EXISTING DIMENSIONS.

4. THESE DRAWINGS MUST NOT BE SCALED. DIMENSIONS ARE SHOWN IN MILLIMETERS. ELEVATIONS AND COORDINATES ARE IN METERS, UNLESS NOTED OTHERWISE ON THE DRAWINGS.

5. THE CONTRACTOR SHALL VERIFY ALL LEVEL, BUILDING WORKPOINT COORDINATES DATUM AND DIMENSIONS PRIOR TO COMMENCEMENT OF WORK. ALL DISCREPANCIES MUST BE REPORTED TO THE ARCHITECT IMMEDIATELY.

6. ANY REVISIONS TO THE DOCUMENTS OR CHANGES PRIOR TO, DURING, OR AFTER CONSTRUCTION THAT ARE DONE WITHOUT WRITTEN AUTHORIZATION FROM THE ARCHITECT SHALL NOT BE RESPONSIBILITY OF THE ARCHITECT.

7. READ ARCHITECTURAL DRAWINGS IN CONJUNCTION WITH THE ARCHITECTURAL SPECIFICATIONS, INTERFACE BETWEEN DISCIPLINES (CIVIL, STRUCTURAL, PLUMBING, MECHANICAL HVAC AND ELECTRICAL) AND WORK BETWEEN ALL TRADES SHALL BE COORDINATED PRIOR TO PROCEEDING WITH CONSTRUCTION.

8. THE CONTRACTOR SHALL BE RESPONSIBLE FOR ALL COORDINATION WITH THE BUILDING MATERIALS SUPPLIERS, OTHER TRADES AND THE CONTRACTORS PROJECT FIELD REPRESENTATIVES.

9. GENERAL CONTRACTOR SHALL PROVIDE SHOP DRAWINGS FOR ALL BUILDING COMPONENTS TO ARCHITECT AND ENGINEERS FOR REVIEW PRIOR TO FABRICATION. ALL SHOP DRAWINGS SHALL BEAR THE SEAL OF A PROFESSIONAL ENGINEER LICENSED IN THE PROVINCE OF ONTARIO UNLESS ALTERNATE ARRANGEMENTS HAVE BEEN PREVIOUSLY AGREED UPON.

10. INSTALL ONLY NEW MATERIALS AND EQUIPMENT IN ACCORDANCE WITH MANUFACTURER'S WRITTEN INSTRUCTION AND SPECIFICATIONS.

CONSTRUCTION NOTES

1. ALL EXISTING COLUMNS, BEAMS AND ROOF JOISTS SHALL REMAIN INTACT UNLESS OTHERWISE INDICATED.

2. GENERAL CONTRACTOR TO CUT OPENINGS ON EXISTING EXTERIOR WALLS FOR NEW DOORS. GENERAL CONTRACTOR TO ENSURE THE CUT IS NEAT AND CLEAN, NOT DAMAGING ADJACENT WALLS, FLOORS AND CEILINGS.

3. GENERAL CONTRACTOR TO ENSURE ALL FLOOR AREAS ARE FREE OF DEBRIS AND HAZARDOUS MATERIAL AFTER DEMOLITION IS COMPLETED.

4. STUD PARTITION FRAMING TO BE MINIMUM 20 GAUGE UNLESS OTHERWISE NOTED.

5. GENERAL CONTRACTOR TO PROVIDE GYPSUM WALL BOARD CONTROL JOINTS IN ALL WALLS. CONTROL JOINTS TO BE STRAIGHT, CONTINUOUS AND INSTALLED 30 FEET OC MAX..

6. APPLY PREVENTIVE PEST CONTROL POWDER IN ALL STUD WALL TRACKS, PIPE SPACES AND OTHER CONCEALED SPACES WITHIN STUD PARTITIONS. REFER TO SPECIFICATIONS.

7. PROVIDE FIBERGLASS SOUND ATTENUATION BATT IN ALL SUITE PARTITIONS AND AREA WHERE THERE IS MECHANICAL EQUIPMENT.

8. PROVIDE FIBERGLASS SOUND ATTENUATION BATT IN ALL PLUMBING SPACE WITH VERTICAL SANITARY STACK PIPE.

9. CONCRETE BLOCK WALL AND PARTITION NOTES:
- ALL CONCRETE BLOCK PARTITIONS AND WALLS TO EXTEND TO U/S OF FLOOR OR ROOF SLAB ABOVE, UNLESS OTHERWISE INDICATED.
- PROVIDE COMPRESSIBLE JOINT FILLER CONTINUOUS AT TOP OF ALL BLOCK WALLS AND PARTITIONS.
- CAULK JOINT WHERE EXPOSED.
- PROVIDE FIRESTOP AND SMOKE SEALS AT PERIMETER JOINTS AND PENETRATIONS IN FIRE RATED PARTITIONS.
- PROVIDE LATERAL BRACING AT TOP OF CONCRETE BLOCK WALLS AND PARTITIONS. REFER TO STRUCTURAL DRAWINGS FOR DETAILS.

10. WASHROOM TO BE PROVIDED WITH EXHAUST VENT DIRECTLY TO OUTSIDE WITH MIN. 1 AIR EXCHANGE PER HOUR.(REFER TO MECH. DWGS) TAPE AND INSULATE WITH MIN. RSI 1.4 (R8) AT WHERE DUCT PASSES THROUGH COLD SPACES. PROVIDE EXTERIOR WALL CAP COMPLETE WITH INSECT SCREEN.

11. PROVIDE SOUND ATTENUATION BATT INSULATION IN ALL WASHROOM CEILINGS.

12. PROVIDE PLYWOOD BACKING IN WASHROOMS FOR GRAB BAR IN WASHROOMS.

13. TRANSPARENT DOORS AND PANELS IN PUBLIC AREAS SHALL BE OF TEMPERED GLASS OR LAMINATED GLASS AND SHALL BE APPROVED BY ATTACHING NON-TRANSPARENT HARDWARE AS REQUIRED BY 3.3.1.18 OBC

14. NEW WINDOWS AND DOORS
- ALL WINDOWS SHALL BE THERMALLY BROKEN, LOW-E ALUMINUM WINDOWS
- SEAL EXTERIOR WINDOW AND DOOR FRAMES WITH FOAMED IN-PLACE AIR SEALANT.

15. GUARD RAIL DESIGN TO MEET REQUIREMENTS OF PART 4.1.5.15 OF THE OBC.

16. TRANSPARENT DOORS AND PANELS IN PUBLIC AREAS SHALL BE CONSTRUCTED WITH TEMPERED GLASS OR LAMINATED GLASS, AND SHALL BE APPROVED BY ATACHING NON-TRANSPARENT HARDWARE AS REQUIRED BY OBC 3.3.1.18.

17. ALL FIXTURES IN WASHROOMS SHALL BE INSTALLED COMPLYING WITH OBC REQUIREMENTS.

18. FIRESTOP ALL PENETRATIONS THROUGH FIRE SEPARATIONS.

19. ALL COMBUSTIBLE PIPING MATERIALS SHALL COMPLY WITH OBC 3.1.5.16. ALL CABLES AND WIRES SHALL COMPLY WITH OBC 3.1.5.16.

20. BUILDING SERVICES THAT PENETRATE A FIRE WALL OR FIRE SEPARATION SHALL BE SEALED BY A FIRE STOP SYSTEM THAT HAS A FIRE RATING NOT LESS THAN THE FIRE RESISTANCE RATING FOR THE FIRE SEPARATION. (OBC DIV. B - 3.1.9.)

21. ALL BARRIER-FREE SIGH SHALL COMPLY WITH OBC 38.3.1.

22. GENERAL CONTRACTOR TO ENSURE ALL NEW AND EXISTING COMBUSTIBLE ELECTRICAL AND DATA WIRING IS CONCEALED IN A NON-COMBUSTIBLE RACEWAY WITHIN THE RETURN AIR PLenum.

MATERIAL SYMBOLS

EARTH SECTION

CONCRETE SECTION

PLASTER/GYPSUM SECTION

GRASS

PLYWOOD

SEMI-RIGID / BATT INSULATION SECTION

RIGID INSULATION SECTION

STEEL, IRON SECTION

ALUMNUM SECTION

EXISTING MATERIAL

ARCHITECTURAL SYMBOLS

SECTION REFERENCE

SECTION

ELEVATION REFERENCE

ELEVATION

DETAIL REFERENCE

DETAIL

REVISION CLOUD

ROOM NAME
XXX

ROOM NAME & NUMBER

DOOR NUMBER

WALL TYPE

REVISION CLOUD

5	05/28/2025	ISSUED FOR PERMIT	HW
4	03/19/2025	ISSUED FOR SPA	HW
3	06/21/2024	ISSUED FOR PRE-CON PHASE II	HW
2	06/17/2024	ISSUED FOR REVIEW	HW
1	12/19/2023	ISSUED FOR REVIEW	HW
No.	Date:	Issued/Revision:	By

Client:



WANG ARCHITECTS INC.
3950 14th Ave, Unit 609
Markham, ON L3R 0A9
T: 905-604-6960
E: info@wangarchitects.ca
www.wangarchitects.ca



Project :








FIREARMS OUTLET CANADA


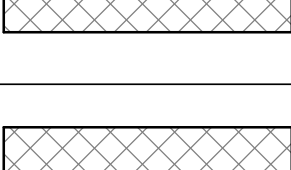
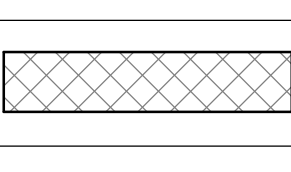
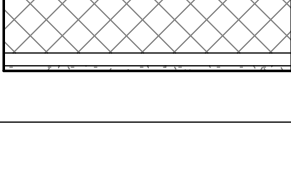
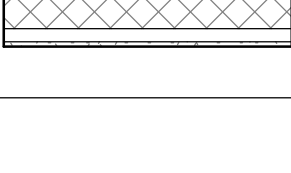
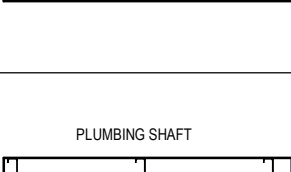
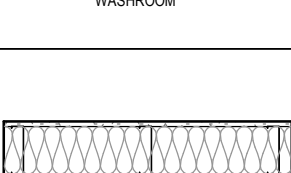
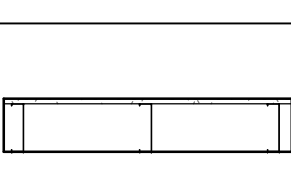
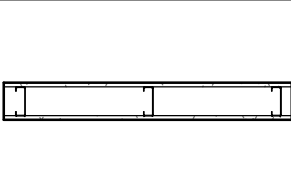
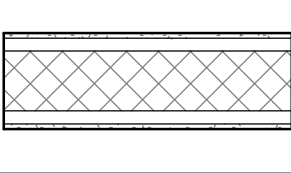
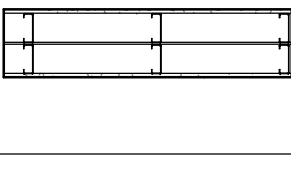
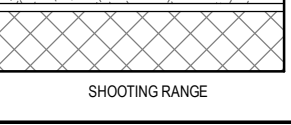

725 WESTNEY RD. S.,
AJAX, ON L1S 7J7




Drawing Name :






OBC MATRIX &
CONSTRUCTION NOTES



Scale :	As indicated	Project No :	00026
Drawn by :	JW	Drawing No :	A1.2
Checked by :	HW		

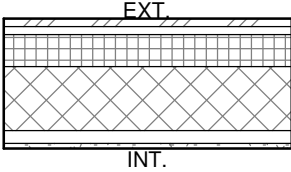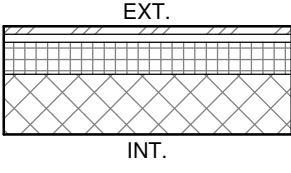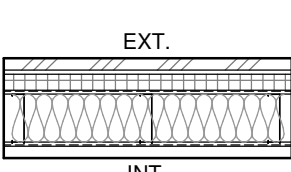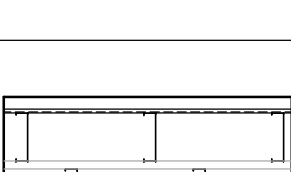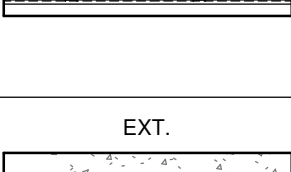
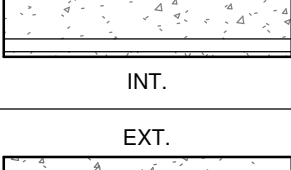
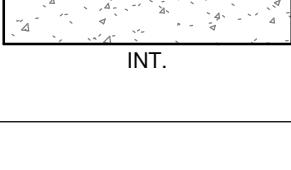
EXTERIOR WALL TYPES				
TYPE	CONSTRUCTIONS	DESCRIPTION	FIRE RATE	COMMENTS
W1		HARDENED CONC. BLOCK WALL <ul style="list-style-type: none">- PREFINISH METAL COMPOSITE PANEL SYSTEM- AIR BARRIER- 4" POLYSIO RIGID INSULATION (R17 MIN.)- 8" LIGHTWEIGHT CONC. BLOCK- 1 5/8" METAL FURRING- 1 LAYER OF 5/8" GYPSUM BOARD		
W2		HARDENED CONC. BLOCK WALL <ul style="list-style-type: none">- PREFINISH METAL COMPOSITE PANEL SYSTEM- AIR BARRIER- 4" POLYSIO RIGID INSULATION (R17 MIN.)- 8" HARDENED CONC. BLOCK- PAINT FINISH		
W3		METAL PANEL STUD WALL ON BOTH SIDES <ul style="list-style-type: none">- PREFINISH METAL COMPOSITE PANEL SYSTEM- AIR BARRIER- 2" POLYSIO RIGID INSULATION (R12 MIN.)- 1/2" EXT. GRADE SHEATHING- 6" METAL STUD @ 16" O.C. C/W BATT INSUL. (R13 MIN.)- 1/2" PLYWOOD SHEATING- 6 MIL POLY VAPOUR BARRIER- METAL PANEL FINISH		
W4		DOUBLE METAL STUD W/ METAL PANEL <ul style="list-style-type: none">- PREFINISH METAL COMPOSITE PANEL SYSTEM- VAPOUR BARRIER- EXT. GRADE SHEATHING- 6" METAL STUD @ 16" O.C- 6" METAL STUD @ 16" O.C- EXT. GRADE SHEATHING- VAPOUR BARRIER- PREFINISH METAL COMPOSITE PANEL SYSTEM		WRAP THE METAL PANEL AROUND THE WALL
W5		INSULATED PRECAST CONC. PANEL WALL <ul style="list-style-type: none">- 3" PRECAST CONC. PANEL- 4" POLYSIO RIGID INSULATION (R17 MIN.)- 6" PRECAST CONC. PANEL- 1 5/8" METAL FURRING @ 16" O.C- 1 LAYER OF 5/8" GYPSUM BOARD	2 HR FRR	PRE- MANUFACTURED INSULATED PRECAST CONC.WALL
W6		INSULATED PRECAST CONC. PANEL WALL <ul style="list-style-type: none">- 3" PRECAST CONC. PANEL- 4" POLYSIO RIGID INSULATION (R17 MIN.)- 6" PRECAST CONC. PANEL	2 HR FRR	PRE- MANUFACTURED INSULATED PRECAST CONC.WALL
W7		EXISTING WALL PANEL (SITE VERIFY) <ul style="list-style-type: none">- PREFINISHED METAL COMPOSITE PANEL SYSTEM.		

INTERIOR WALL TYPES				
TYPE	CONSTRUCTIONS	DESCRIPTION		
P1		HARDENED CONC. BLOCK WALL (FIRE WALL) <ul style="list-style-type: none">- 8" HARDENED CONC. BLOCK- 1 5/8" FURRING CHANNEL @ 16" O.C- 1 LAYER OF 5/8" GYPSUM BOARD	4 HR	W/ 1-25M VERTI. REINFORCING @ 16" O.C GROUTED SOLID C/W HORIZONTAL REINF. EVERY 2ND BLOCK COURSE (FULL HEIGHT) 3'-0" ABOVE FINISH ROOF
P2		HARDENED CONC. BLOCK WALL (FIRE WALL) <ul style="list-style-type: none">- 8" HARDENED CONC BLOCK	4 HR	W/ 1-25M VERTI. REINFORCING @ 16" O.C GROUTED SOLID C/W HORIZONTAL REINF. EVERY 2ND BLOCK COURSE (FULL HEIGHT) 3'-0" ABOVE FINISH ROOF
P3		8" LIGHTWEIGHT CONC. BLOCK <ul style="list-style-type: none">- PAINTED FINISH ON BOTH SIDES		HEIGHT TO U/S OF FLOOR SLAB OR ROOF SLAB
P4		8" HARDENED CONC. BLOCK <ul style="list-style-type: none">- PAINTED FINISH ON BOTH SIDES	1 HR	HEIGHT TO U/S OF FLOOR SLAB OR ROOF SLAB
P5		LIGHTWEIGHT CONC. <ul style="list-style-type: none">- 8" LIGHTWEIGHT CONC. BLOCK- 1 5/8" FURRING CHANNEL @ 16" O.C- 1 LAYER OF 5/8" GYPSUM BOARD		
P6		HARDENED CONC. BLOCK <ul style="list-style-type: none">- 8" CONC. BLOCK- 1 5/8" FURRING CHANNEL @ 16" O.C- 1 LAYER OF 5/8" GYPSUM BOARD	1 HR	CARRY GYPSUM WALLBOARD 4" ABOVE CEILING
P7		3 5/8" METAL STUD WALL (INSULATED) <ul style="list-style-type: none">- 1 LAYER OF 5/8" GYPSUM BOARD- 3 5/8" METAL STUDS AT 16" O.C.- BATT INSULATION- 1 LAYER OF 5/8" GYPSUM BOARD		
P8		3 5/8" METAL STUD WALL - CHASE WALL <ul style="list-style-type: none">- 3 5/8" METAL STUDS @ 16" O.C.- 1 LAYER OF 5/8" GYPSUM BOARD		
P9		6" METAL STUD WALL W/ INSUL. <ul style="list-style-type: none">- 1 LAYER OF 5/8" GYPSUM BOARD- 6" METAL STUDS @ 16" O.C.- BATT INSULATION- 1 LAYER OF 5/8" GYPSUM BOARD		
P10		METAL STUD WALL <ul style="list-style-type: none">- 1 LAYER OF 5/8" GYPSUM BOARD- 6" METAL STUDS @ 16" O.C.		
P11		METAL STUD WALL <ul style="list-style-type: none">- 1 LAYER OF 5/8" GYPSUM BOARD- 3 5/8" METAL STUDS @ 16" O.C.- 1 LAYER OF 5/8" GYPSUM BOARD		
P12		LIGHT WEIGHT CONC. BLOCK W/ FINISH <ul style="list-style-type: none">- 1 LAYER OF 5/8" GYPSUM BOARD- 1 5/8" FURRING CHANNEL @ 16" O.C- 8" CONC BLOCK- 1 5/8" FURRING CHANNEL @ 16" O.C- 1 LAYER OF 5/8" GYPSUM BOARD		
P13		DOUBLE 3 5/8" METAL STUD WALL <ul style="list-style-type: none">- 1 LAYER OF 5/8" GYPSUM BOARD- 3 5/8" METAL STUDS @ 16" O.C.- 3 5/8" METAL STUDS @ 16" O.C.- 1 LAYER OF 5/8" GYPSUM BOARD		
P14		HARDENED CONC. BLOCK WALL <ul style="list-style-type: none">- 8" HARDENED CONC. BLOCK- ACOUSTICS PANEL		NRC 0.8 TREATMENT

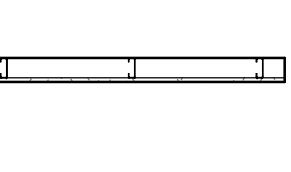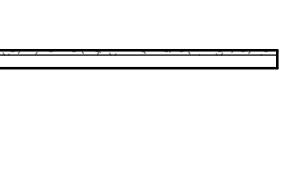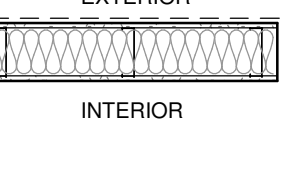INTERIOR WALL TYPES				
TYPE	CONSTRUCTIONS	DESCRIPTION	FIRE RATE	COMMENTS
P15		2 1/2" METAL STUD WALL <ul style="list-style-type: none">- 2 1/2" METAL STUDS @ 16" O.C.- 1 LAYER OF 5/8" GYPSUM BOARD		
P16		FURRING WALL <ul style="list-style-type: none">- 1 LAYER OF 5/8" GYPSUM BOARD- 1 5/8" METAL FURRING		
P17		METAL STUD WALL W/ INSUL. <ul style="list-style-type: none">- AIR BARRIER- EXTERIOR GRADE SHEATHING BOARD- 6" METAL STUDS @ 16" O.C.- FILL STUD SPACE WITH BATT INSULATION- 1 LAYER OF 5/8" GYPSUM BOARD		CONSTRUCT TEMPORARY WALL PRIOR TO DEMOLITION. REMOVE UPON COMPLETION OF PHASE 1

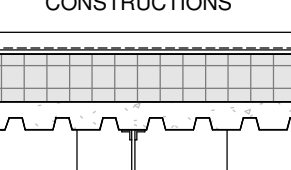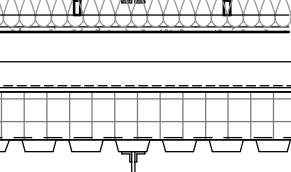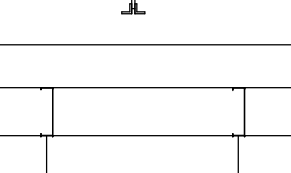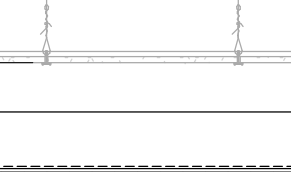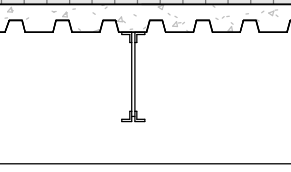ROOF TYPES			
TYPE	CONSTRUCTIONS	DESCRIPTION	COMMENTS
RF-1		<ul style="list-style-type: none">- TPO WATERPROOF MEMBRANE (HIGH REFLECTIVE)- PROTECTION BOARD- TAPERED RIGID INSULATION (R35 MIN.) TO CREATE ROOF SLOPE- 2" CONCRETE TOPPING- METAL DECK- STRUCTURE STEEL- FIBERGLASS INSULATION FOR SOUND ATTENUATION- SUSPENDED DRYWALL CEILING (1 LAYER OF 5/8" GYP. BOARD)	
RF-2		<ul style="list-style-type: none">- TPO WATERPROOF MEMBRANE (HIGH RELECTIVE)- PROTECTION BOARD- TAPERED RIGID INSULATION (R35 MIN.) TO CREATE ROOF SLOPE- 6MIL POLY VAPOUR BARRIER- METAL DECK- STRUCTURE STEEL	
RF-3		<ul style="list-style-type: none">- 6" METAL STUD @ 2'-0" O.C (GAUGE 16)- SUSPENDED ACOUSTIC TILE CEILING	
RF-4		<ul style="list-style-type: none">- TPO WATERPROOF MEMBRANE (HIGH REFLECTIVE)- PROTECTION BOARD- TAPERED RIGID INSULATION (R35 MIN.) TO CREATE ROOF SLOPE- 2" CONCRETE TOPPING- METAL DECK- STRUCTURE STEEL	
RF-5		<ul style="list-style-type: none">-TPO ROOFING MEMBRANE- PROTECTION BOARD- TAPERED INSULATION TO FORM SLOPES - MIN. 2% SLOPE TO DRAIN- METAL DECK (REFER TO STRUC. DWGS.)- ROOF STRUCTURE (REFER TO STRUC. DWGS.)- COLD FORMED STUD/FURRING FRAMING (IF REQUIRED)- 1/2" EXTERIOR GRADE PLYWOOD SHEATHING- VAPOUR IMPERMEABLE AIR BARRIER- ALUMINUM SOFFIT	

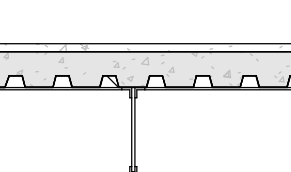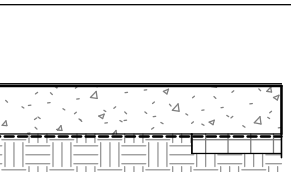FLOOR TYPES		
TYPE	CONSTRUCTIONS	DESCRIPTION
FL-1		TYPICAL COMPOSITE FLOOR <ul style="list-style-type: none">- FLOOR FINISH AS SEPCIFIED- 3" CONCRETE TOPPING (REFER TO STRUC. DWGS.)- METAL DECK (REFER TO STRUC. DWGS.)- STRUCTURE STEEL (REFER TO STRUC. DWGS.)
FL-2		CONCRETE SLAB ON GRADE <ul style="list-style-type: none">- FLOOR FINISH AS SPECIFIED- CONCRETE SEALER- 6" CAST-IN-PLACE CONCRETE SLAB (REFER TO STRUC. DWGS.)- 10MIL POLYETHYLANE MOISTURE BARRIER- 3" RIGID INSULATION AT FOUNDATION PERIMETER, MECHANICALLY FASTENED TO A DEPTH OF 4H.- GRAVEL OR CRUSHED STONE DRAINAGE COURSE- UNDISTURBED SOIL

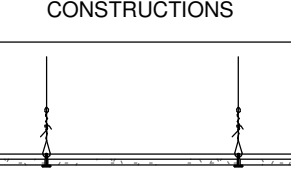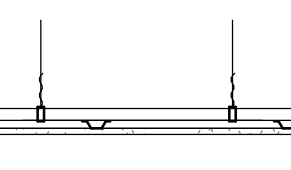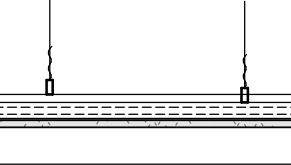CEILING TYPES		
TYPE	CONSTRUCTIONS	DESCRIPTION
CL-1		SUSPENDED ACOUSTIC TILE CEILING <ul style="list-style-type: none">- SUSPENSION SYSTEM WITH HANGING WIRE ATTACHED TO STRUCTURE ABOVE- ACOUSTIC CEILING TILE
CL-2		SUSPENDED GYPSUM BOARD CEILING <ul style="list-style-type: none">- SUSPENSION SYSTEM WITH HANGING WIRE ATTACHED TO STRUCTURE ABOVE- 20 GA. MIN. METAL FURRING CHANNEL- 1/2" GYPSUM BOARD
CL-3		ACOUSTIBUILT CEILING SYSTEM <ul style="list-style-type: none">- ACOUSTICAL SUSPENSION SYSTEM- METAL FRAMING- ACOUSTIBUILT PANEL

ASSEMBLY NOTES		
1. PROVIDE FULL HEIGHT SOUND ATTENUATION BLANKET AT ALL WASHROOM PARTITIONS.		
2. PROVIDE FULL HEIGHT SOUND ATTENUATION BLANKET IN ALL PARTITIONS AROUND SHAFTS AND SERVICE ROOMS.		
3. SEAL ALL FIRE RATED PARTITIONS TO FLOOR SLAB AND THE UNDERSIDE OF STRUCTURE ABOVE WITH FIRE STOP AND FIRE PROOFING SEALANT. SEAL ALL PENETRATIONS THROUGH FIRE SEPARATIONS WITH ULC-APPROVED FIRES TOP SYSTEMS.		
4. ALL GYPSUM BOARD FINISH, FURRING MATERIALS AND INTERIOR VENEER MATERIALS SHALL EXTEND A MINIMUM OF 4" ABOVE THE HIGHEST ADJACENT FINISHED CEILING UNLESS NOTED OTHERWISE ON DRAWINGS.		
5. SUBSTITUTE GYPSUM BOARD WITH MOISTURE RESISTANT GYPSUM BOARD WHERE MOISTURE IS A FACTOR AND TILE IS NOT SPECIFIED.		
7. FOR STEEL FRAMING, PROVIDE SHOP DRAWINGS DESIGNED AND STAMPED BY STRUCTURAL ENGINEER LICENSED IN THE PROVINCE OF ONTARIO.		

20/05/2025

03/19/2025

No.

Date:

ISSUED FOR PERMIT

ISSUED FOR SPA

Issued/Revision:

By

Client:

FIREARMS

OUTLET CANADA

W

WANG ARCHITECTS INC.

3950 14th Ave, Unit 609
Markham, ON L3R 0A9
T: 905-604-6960
E: info@wangarchitects.ca
www.wangarchitects.ca

ONTARIO ASSOCIATION
OF
ARCHITECTS
LI QING HUA (HENRY) WANG
LICENCE
7675

Project :

FIREARMS OUTLET CANADA

Drawing No :

ASSEMBLIES

Scale :

As indicated

Project No :

00026

Drawn by :


JW

Drawing No :


Checked by :

HW

A1.3

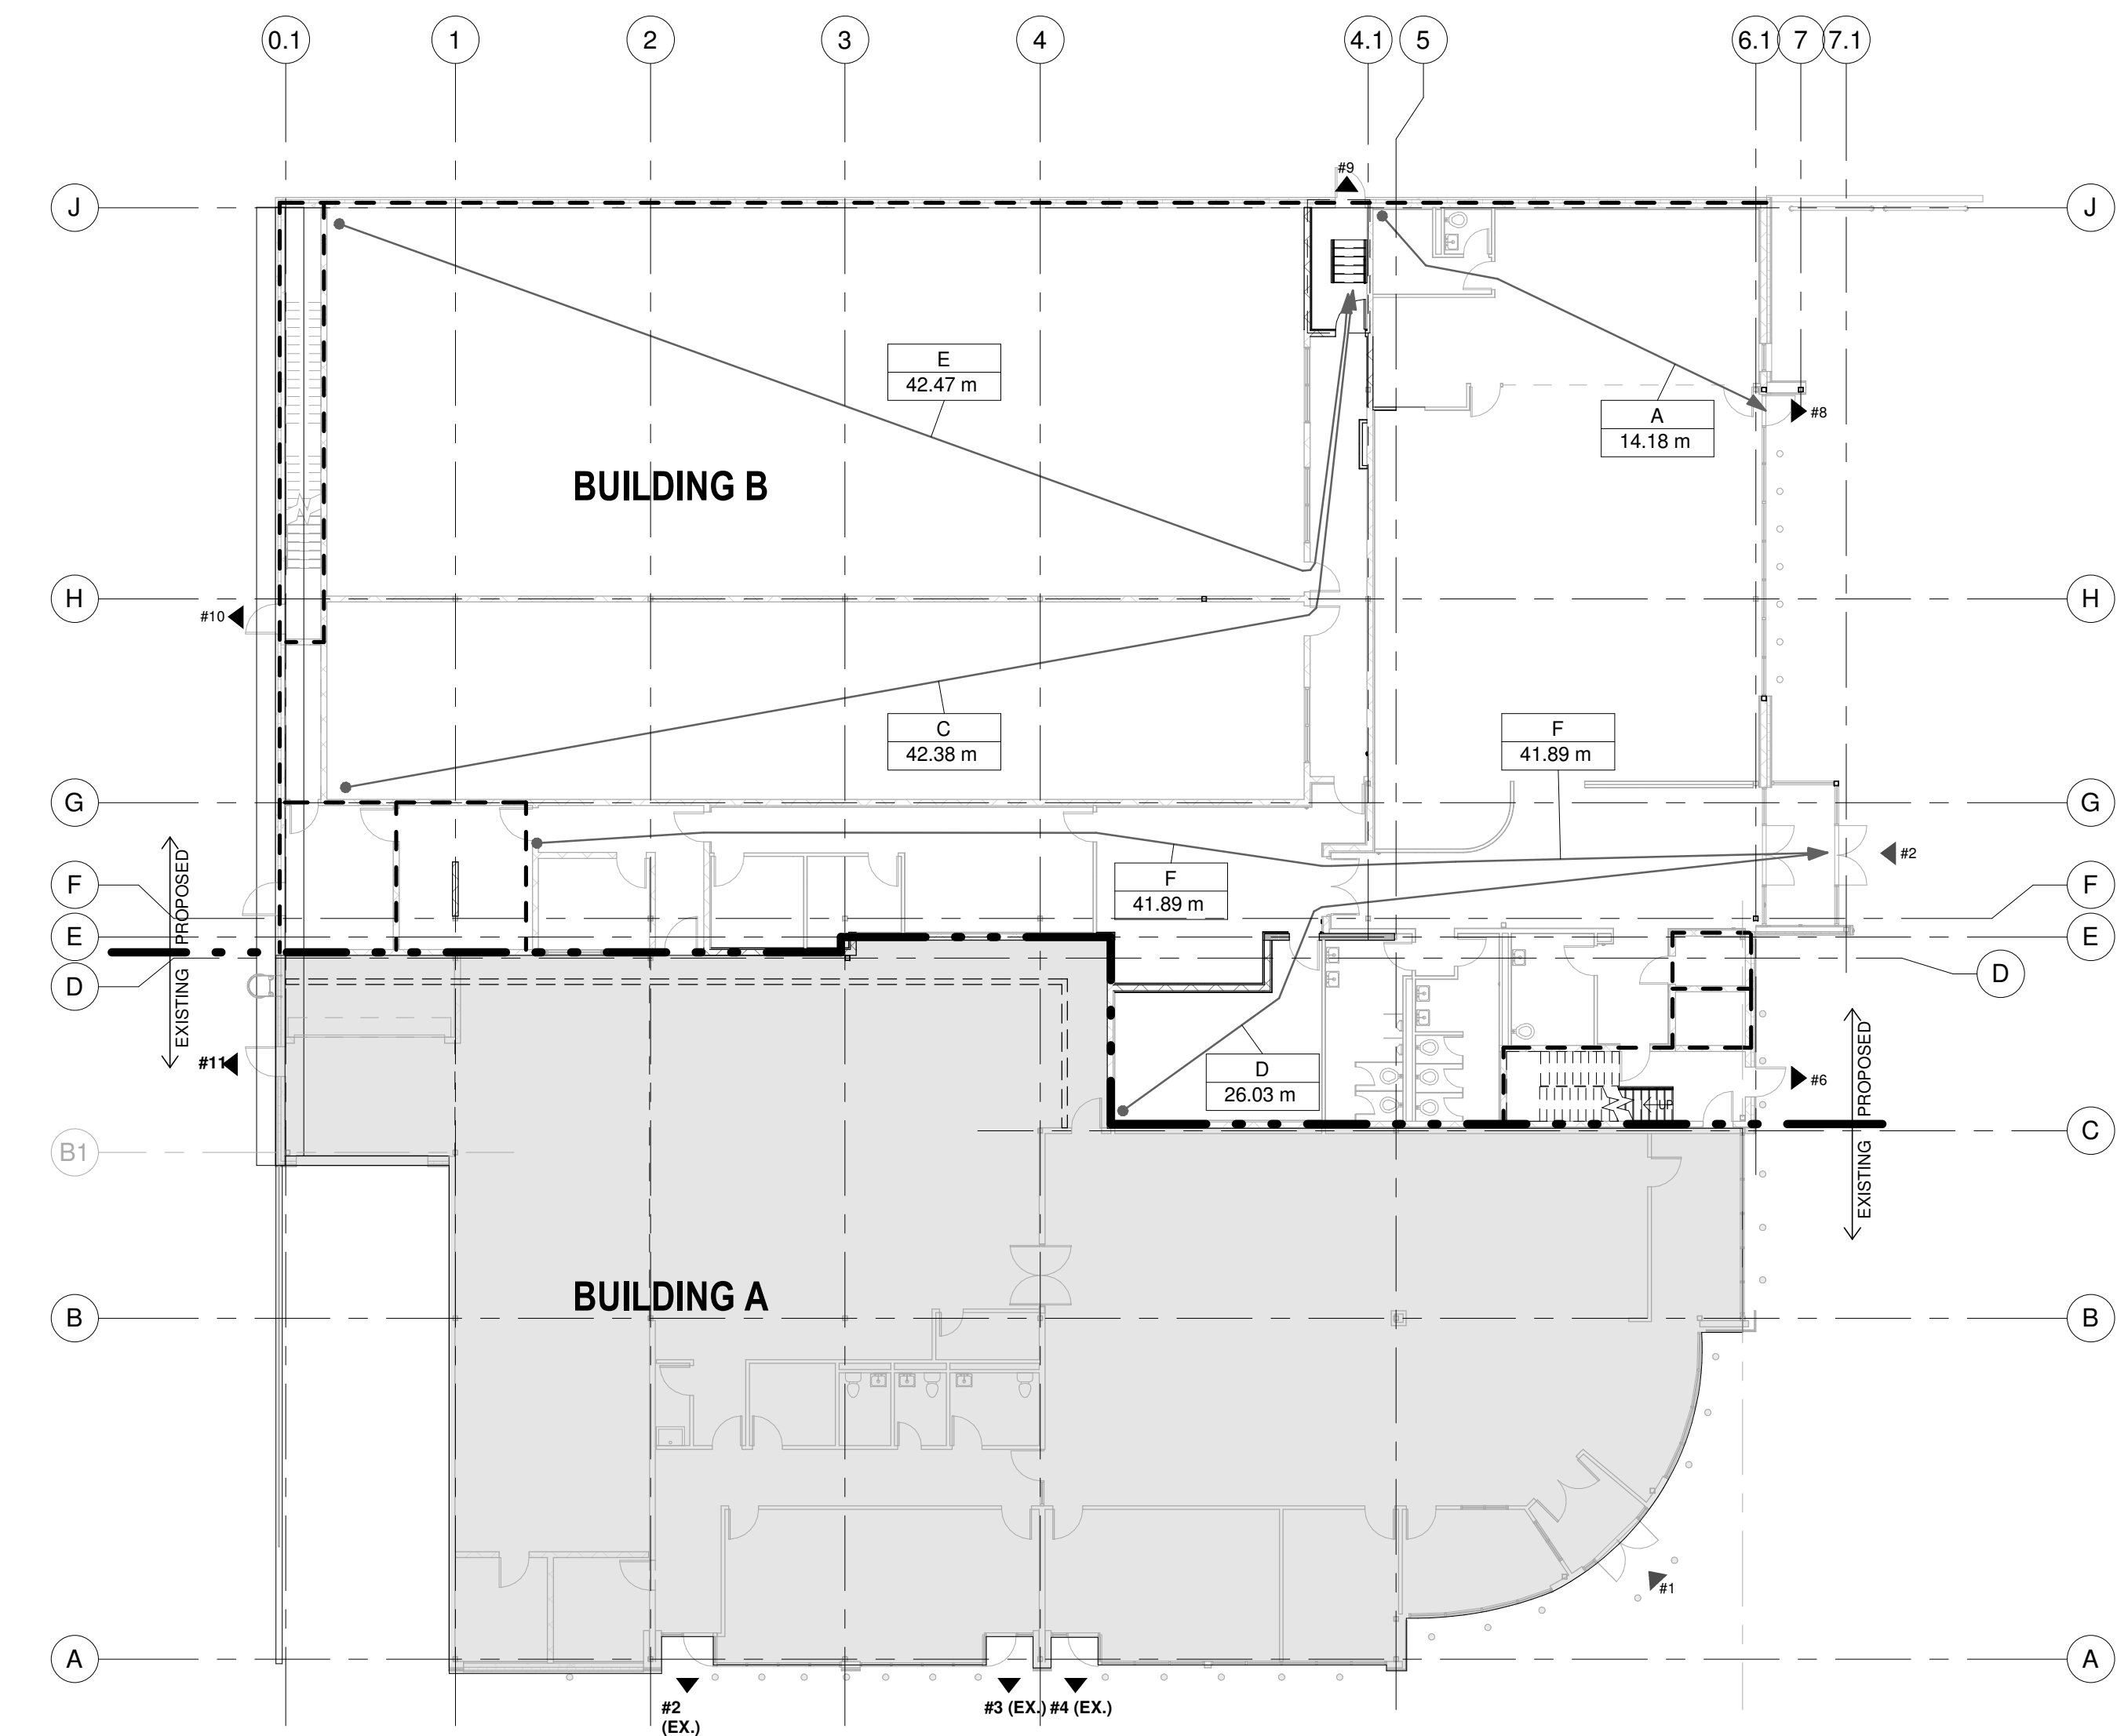

1 FIRE SEPERATION GROUND FLOOR
1/16" = 1'-0"

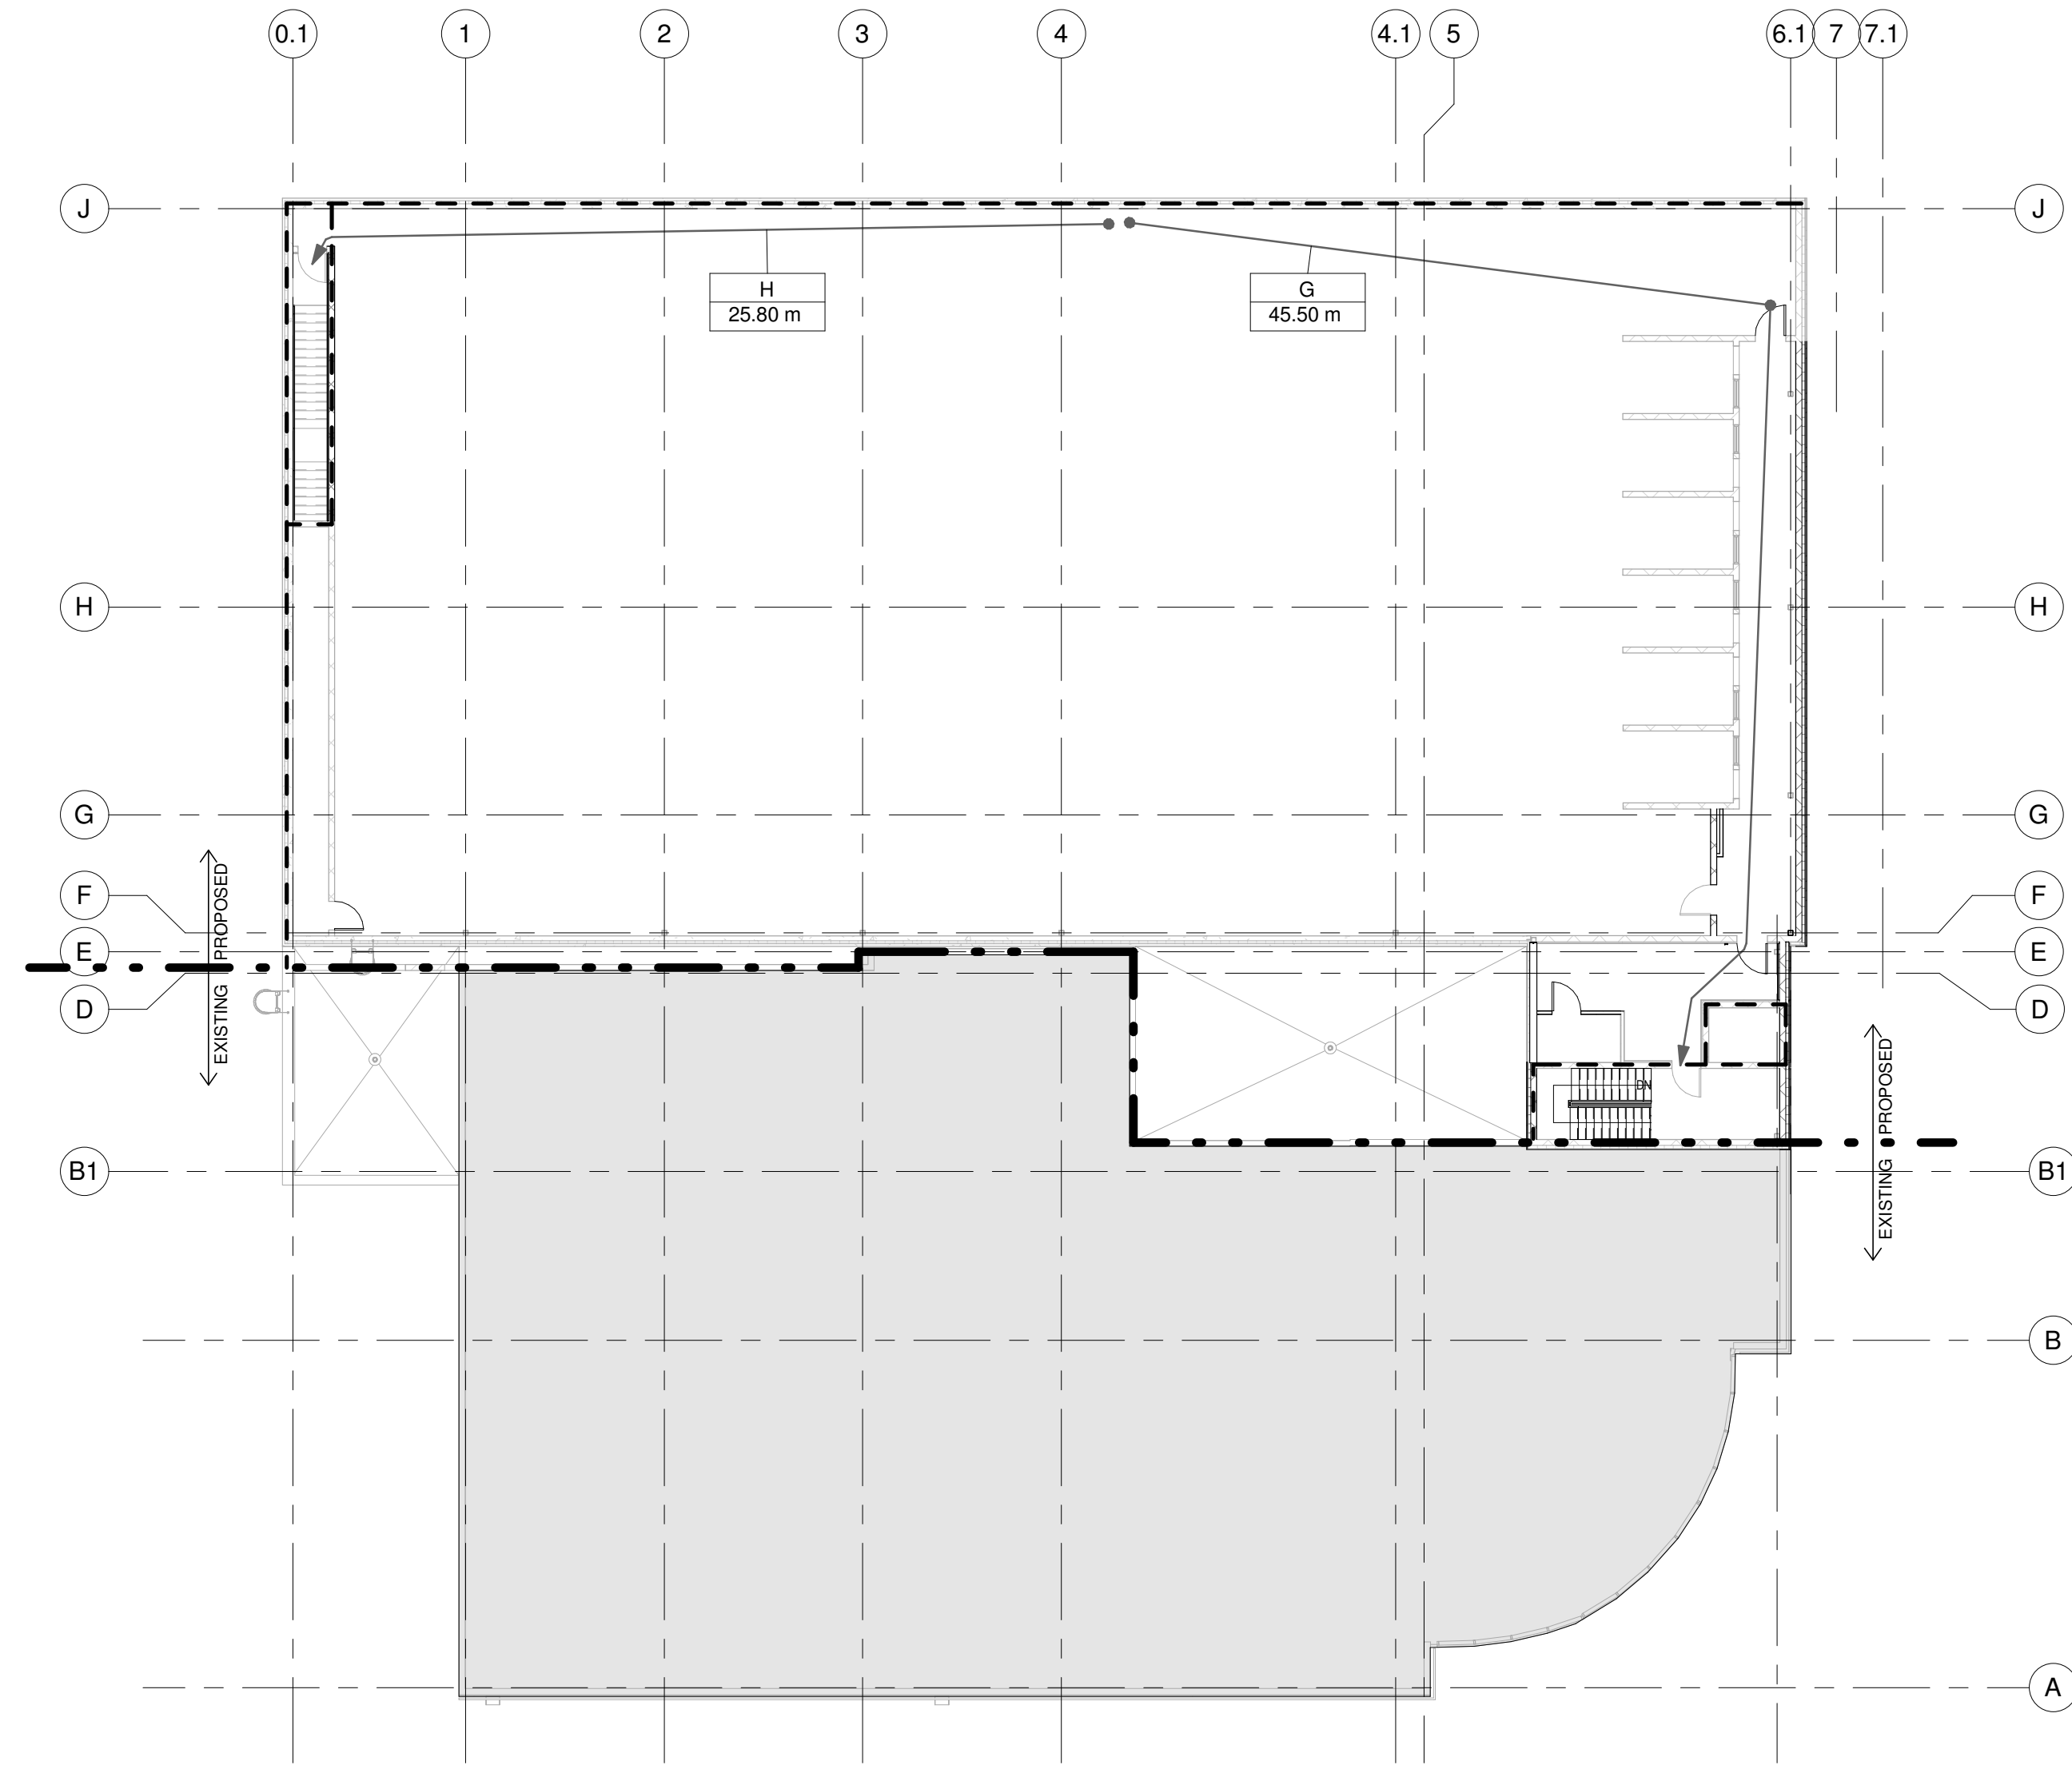

2 FIRE SEPERATION SECOND FLOOR
1/16" = 1'-0"

LEGEND

- EGRESS PATH
- 1 HOUR FIRE RATED SEPERATION
- 4 HOUR FIRE RATED SEPERATION (FIRE WALL)
- ENTRANCE DOOR
- EXIT DOOR

TRAVEL DISTANCE NOTE
147.6 FT MAX FOR GROUP A ASSEMBLY

2	05/28/2025	ISSUED FOR PERMIT	HW
1	03/19/2025	ISSUED FOR SPA	HW
No.	Date:	Issued/Revision:	By

Client:

FIREARMS
OUTLET CANADA

W **WANG ARCHITECTS INC.**
3950 14th Ave, Unit 609
Markham, ON L3R 0A9
T: 905-604-6960
E: info@wangarchitects.ca
www.wangarchitects.ca




Project :
FIREARMS OUTLET CANADA

725 WESTNEY RD. S.,
AJAX, ON L1S 7J7

Drawing Name :
FIRE SEPERATION PLAN

Scale :	As indicated	Project No :	00026
Drawn by :	JW	Drawing No :	A1.5
Checked by :	HW		

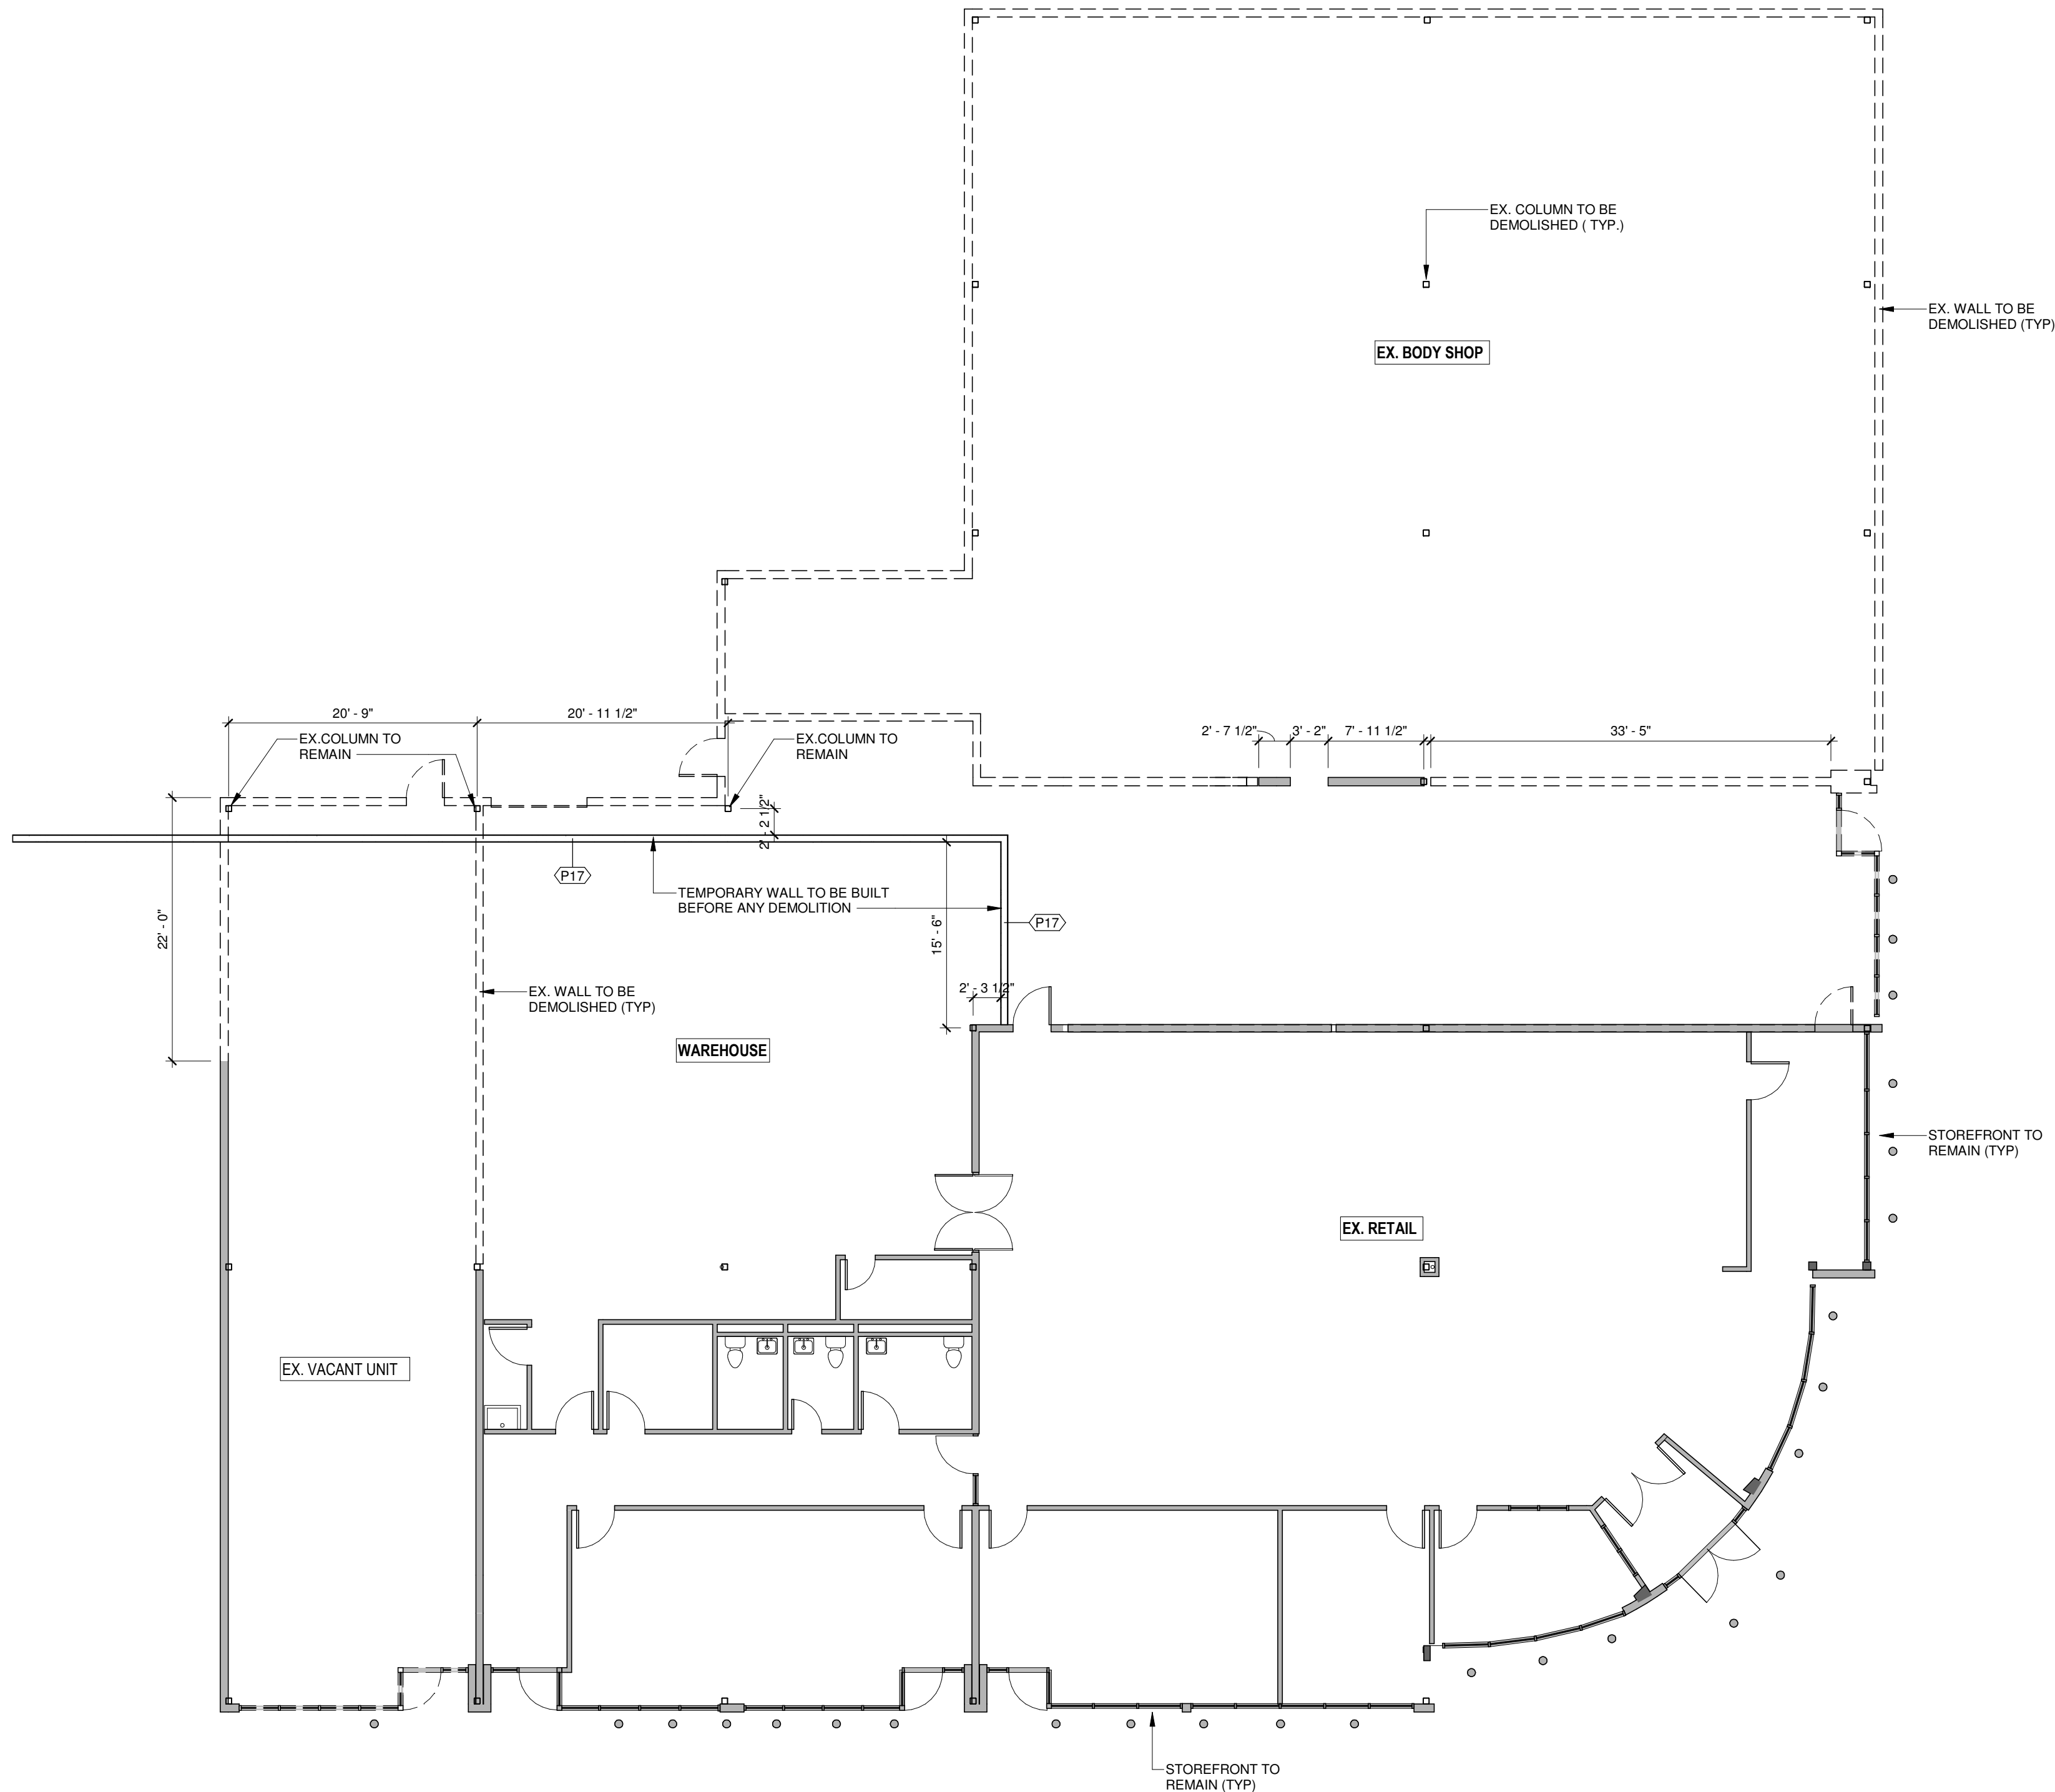

DEMOLITION PLAN NOTES

1. READ ARCHITECTURAL DRAWINGS IN CONJUNCTION WITH THE ARCHITECTURAL SPECIFICATIONS. INTERFACE BETWEEN DISCIPLINES (STRUCTURAL, MECHANICAL, HVAC, PLUMBING AND ELECTRICAL) AND WORK BETWEEN TRADES SHALL BE COORDINATED PRIOR TO PROCEEDING WITH CONSTRUCTION.

2. SEE ARCHITECTURAL, MECHANICAL AND ELECTRICAL DRAWINGS FOR ALL RELATED COMPONENTS OF DEMOLITION, MODIFICATION, AND NEW INSTALLATION.

3. ALL DIMENSIONS ON THIS DRAWING HAVE BEEN ROUNDED TO THE NEAREST 1" FOR CLARITY UNLESS OTHERWISE NOTED.

4. GENERAL CONTRACTOR TO SITE VERIFY ALL EXISTING DIMENSIONS.

5. GENERAL CONTRACTOR TO PROTECT ALL EXISTING COMPONENTS. FINISHES THAT ARE NOT DESIGNATED TO BE DEMOLISHED FROM DAMAGE DURING DEMOLITION. MAKE GOOD ALL DAMAGE RESULTING FROM THE WORK CARRIED OUT UNDER THIS CONTRACT AT NO EXTRA CHARGE.

6. GENERAL CONTRACTOR SHALL COORDINATE ALL DEMOLITION WORK WITH APPROPRIATE UTILITY COMPANIES PRIOR TO STARTING WORK.

7. GENERAL CONTRACTOR TO CUT OPENINGS ON EXISTING EXTERIOR AND INTERIOR WALLS FOR NEW WINDOWS AND DOORS BASED ON PROPOSED FLOOR PLANS. GENERAL CONTRACTOR TO ENSURE THESE CUTS ARE NEAT AND CLEAN, NOT DAMAGING ADJACENT WALLS, FLOORS AND CEILINGS.

8. EXISTING DOORS BEING REMOVED ARE TO BE KEPT FOR REUSE IF POSSIBLE.

9. EXISTING WALLS TO BE REMOVED, MAKE GOOD ALL ADJACENT WALLS, FLOORS AND CEILING FINISHES AS REQUIRED.

10. GENERAL CONTRACTOR TO ENSURE ALL FLOOR AREA ARE FREE OF DEBRIS AND HAZARDOUS MATERIAL AFTER DEMOLITION IS COMPLETED.

11. ALL EXISTING STRUCTURES REMAIN INTACT UNLESS OTHERWISE NOTED.

12. ALL EXISTING PLUMBING AND DRAINAGE LINES SHALL BE CAPPED OFF WHERE EXISTING PLUMBING FIXTURES AND DRAINAGE LINES TO BE REMOVED AND DISPOSED OF. MAKE GOOD ALL ADJACENT SURFACES AS REQUIRED. (SEE MECHANICAL)

13. ALL EXISTING WINDOWS ARE TO REMAIN INTACT UNLESS OTHERWISE INDICATED.

14. GENERAL CONTRACTOR IS RESPONSIBLE FOR ALL ONGOING AND FINAL CLEAN UP.

1

GROUND FLOOR DEMOLITION PLAN

1" = 10'-0"

5	05/28/2025	ISSUED FOR PERMIT	HW
4	03/19/2025	ISSUED FOR SPA	HW
3	06/21/2024	ISSUED FOR PRE-CON PHASE II	HW
2	06/17/2024	ISSUED FOR REVIEW	HW
1	12/19/2023	ISSUED FOR REVIEW	HW
No.	Date:	Issued/Revision:	By

Client:

FIREARMS

OUTLET CANADA

W

WANG ARCHITECTS INC.

3950 14th Ave, Unit 609

Markham, ON L3R 0A9

T: 905-604-6960

E: info@wangarchitects.ca


www.wangarchitects.ca

Project :

FIREARMS OUTLET CANADA

725 WESTNEY RD. S.,
AJAX, ON L1S 7J7

Drawing Name :	DEMO FLOOR PLAN		
Scale :	As indicated	Project No :	00026
Drawn by :	JW	Drawing No :	A2.1
Checked by :	HW		

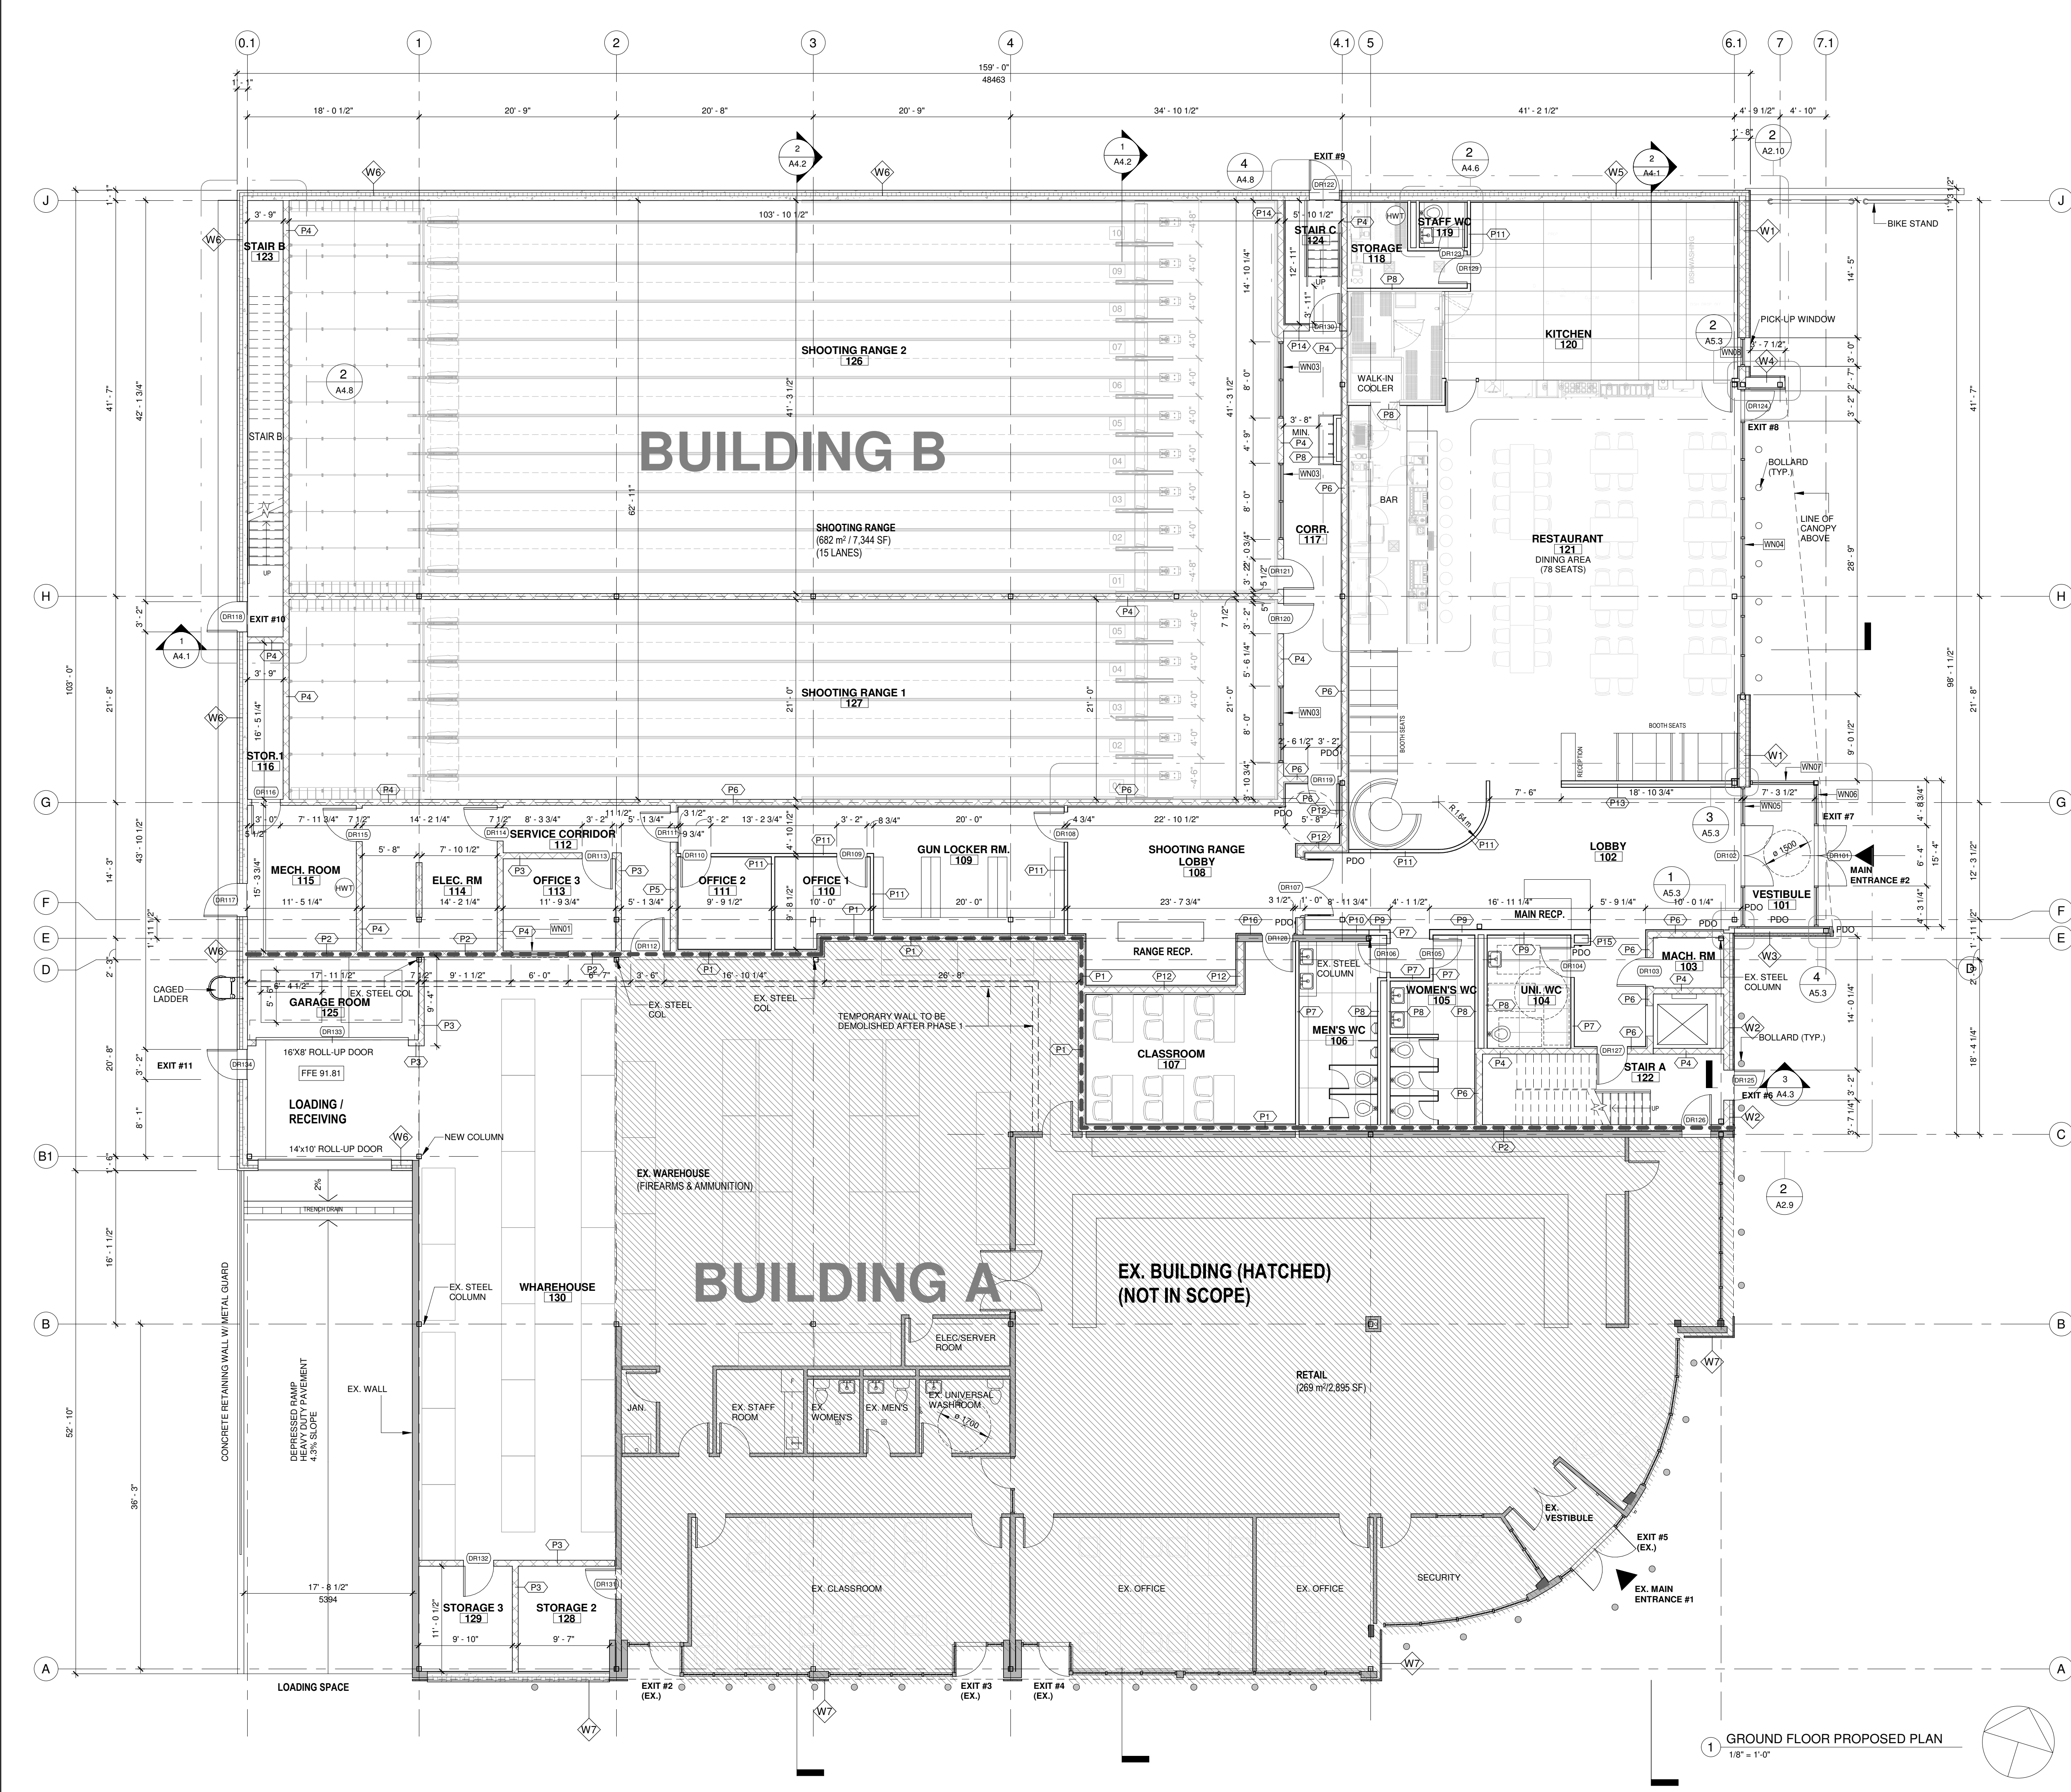

LEGEND

- EXISTING WALLS TO REMAIN
- EXISTING WALLS TO BE DEMOLISHED
- NEW INTERIOR WALLS
- P.D.O. POWER DOOR OPERATOR
- FLOOR DRAIN (REFER TO MECH DWGS)
- DOOR TYPE
- EXTERIOR WALL TYPE
- INTERIOR WALL TYPE
- GLZ-X GLAZING NUMBER
- 4 HR FIRE WALL SEPERATION

FLOOR PLAN NOTES

- FOR GENERAL NOTES, LEGEND AND WALL TYPES, REFER TO DRAWING A1.2
- READ ARCHITECTURAL DRAWINGS IN CONJUNCTION WITH THE ARCHITECTURAL SPECIFICATIONS. INTERFACE BETWEEN DISCIPLINES (STRUCTURAL, MECHANICAL, HVAC, PLUMBING AND ELECTRICAL) AND WORK BETWEEN TRADES SHALL BE COORDINATED PRIOR TO PROCEEDING WITH CONSTRUCTION. ALL DIMENSIONS ON THIS DRAWING HAVE BEEN ROUNDED TO THE NEAREST 1/4" FOR CLARITY.
- ALL EXISTING DIMENSIONS ARE PLUS/MINUS. CONTRACTOR TO VERIFY DIMENSIONS FOR EXISTING BUILDING PRIOR TO CONSTRUCTION.
- FOR FLOOR FINISHES REFER TO FLOOR FINISH PLAN ON DRAWING A2.3.
- FOR FLOOR DRAIN LOCATIONS REFER TO MECHANICAL DRAWINGS TYP.
- FOR DOOR AND FRAME TYPES REFER TO DOOR SCHEDULE ON DRAWING A1.3.
- PARTITIONS WHICH SUPPORT FIXTURES, MILLWORK AND/OR ACCESSORIES ARE TO BE REINFORCED WITH WOOD STUD BLOCKING AND/OR PLYWOOD AS REQUIRED TO PROVIDE RIGID SUPPORT AND A FASTENING SURFACE.
- ALL EXISTING WINDOWS TO REMAIN UNLESS OTHERWISE NOTED.
- ALL STEEL STUD PARTITIONS ARE TO BE EXTENDED MIN. 6" ABOVE FINISHED CEILING UNLESS OTHERWISE NOTED. STUDS PARTITION FRAMING TO BE MIN. 20 GAUGE UNLESS OTHERWISE NOTED. APPLY WEB STIFFENERS WHEN IF EXCEED MAX. HEIGHT SPAN.
- GENERAL CONTRACTOR TO ENSURE ALL NEW AND EXISTING COMBUSTIBLE ELECTRICAL AND DATA WIRING IS CONCEALED IN A NON-COMBUSTIBLE RACEWAY WITHIN THE RETURN ARE PLENUM.
- BUILDING SERVICES THAT PENETRATE A FIRE WALL OR FIRE SEPERATION SHALL BE SEALED BY A FIRE STOP SYSTEM THAT HAS A FIRE RATING NOT LESS THAN FIRE RESISTANCE RATING FOR THE FIRE SEPERATION (JOBC DIV. B - 3.1.9.1).
- GENERAL CONTRACTOR TO ENSURE EXISTING DEMISING WALLS REMAIN CONTINUOUS DURING CONSTRUCTION. REFER TO WALL TYPES ON DRAWING A1.2 FOR EXISTING DEMISING WALL TREATMENT.
- ALL EXISTING STRUCTURE SHALL REMAIN UNLESS OTHERWISE NOTED.
- DOOR AND WINDOW MANUFACTURER TO SITE VERIFY ALL OPENING DIMENSIONS PRIOR TO FABRICATION.
- EXTERIOR DOOR AND WINDOW ASSEMBLIES TO MEET THE REQUIREMENTS OF SBI10 OF THE ONTARIO BUILDING CODE.
- EXTERIOR WALL ASSEMBLIES TO MEET THE REQUIREMENTS OF SBI10 OF THE ONTARIO BUILDING CODE.
- GENERAL CONTRACTOR TO PROVIDE GYPSUM WALL BOARD CONTROL JOINTS IN ALL WALLS. CONTROL JOINTS TO BE STRAIGHT, CONTINUOUS AND INSTALLED 30 FEET O.C. MAX. PROVIDE SORT WEATHER TIGHT JOINTS AT ALL ADJACENT MATERIALS AND SURFACES AS PER MANUFACTURERS SPECIFICATIONS.
- GENERAL CONTRACTOR TO INSTALL EMERGENCYEXIT LIGHTING AS PER ELECTRICAL DRAWINGS.
- GENERAL CONTRACTOR TO INSPECT AND ENSURE ALL EXISTING EMERGENCYEXIT LIGHTS ARE IN GOOD WORKING CONDITION. REPLACE BATTERY PACK AS REQUIRED.
- CONTRACTOR TO PROVIDE ARCHITECT/ELECTRICAL CONSULTANT WITH AN EMERGENCY LIGHTING TEST REPORT.
- GENERAL CONTRACTOR TO HAVE EXISTING FIRE ALARM SYSTEM VERIFIED AND PROVIDE A CERTIFICATE TO THE ARCHITECT / ELECTRICAL CONSULTANTS, BUILDING DEPARTMENT AND FIRE DEPARTMENT.
- EXISTING ROOF TO REMAIN INTACT UNLESS OTHERWISE NOTED.
- TRANSPARENT DOORS AND PANELS IN PUBLIC AREAS SHALL BE CONSTRUCTED WITH TEMPERED GLASS OR LAMINATED GLASS AND SHALL BE APPROVED BY ATTACHING NON-TRANSPARENT HARDWARE AS REQUIRED BY 3.3.1.18 OF THE ONTARIO BUILDING CODE.
- REFER TO SECURITY DRAWINGS FOR ALL SECURITY ACCESS DEVICE LOCATIONS AND REQUIREMENTS TYPICAL.

1 GROUND FLOOR PROPOSED PLAN
1/8" = 1'-0"

12	05/28/2025	ISSUED FOR PERMIT	HW
11	03/19/2025	ISSUED FOR SPA	HW
10	02/06/2025	ISSUE FOR REVIEW	HW
9	01/13/2025	ISSUED FOR REVIEW	HW
8	06/21/2024	ISSUED FOR PRE-CON PHASE II	HW
7	06/17/2024	ISSUED FOR REVIEW	HW
6	12/19/2023	ISSUED FOR REVIEW	HW
5	12/18/2023	ISSUED FOR COORDINATION	HW
4	12/08/2023	ISSUED FOR REVIEW	HW
3	07/20/2023	ISSUED FOR REVIEW	HW
2	07/18/2023	ISSUED FOR REVIEW	HW
1	07/17/2023	ISSUED FOR REVIEW	HW
No.	Date:	Issued/Revision:	By

Client:

FIREARMS OUTLET CANADA

WANG ARCHITECTS INC.
3950 14th Ave, Unit 609
Markham, ON L3R 0A9
T: 905-604-6960
E: info@wangarchitects.ca
www.wangarchitects.ca




Project : FIREARMS OUTLET CANADA

725 WESTNEY RD. S.,
AJAX, ON L1S 7J7

Drawing Name : GROUND FLOOR PROPOSED PLAN

Scale :	As indicated	Project No :	00026
Drawn by :	JW	Drawing No :	A2.2
Checked by :	HW		

C:\Users\henry\Documents\725 Westney Rd S - WORKING DRAWING - TENDER\henry.t

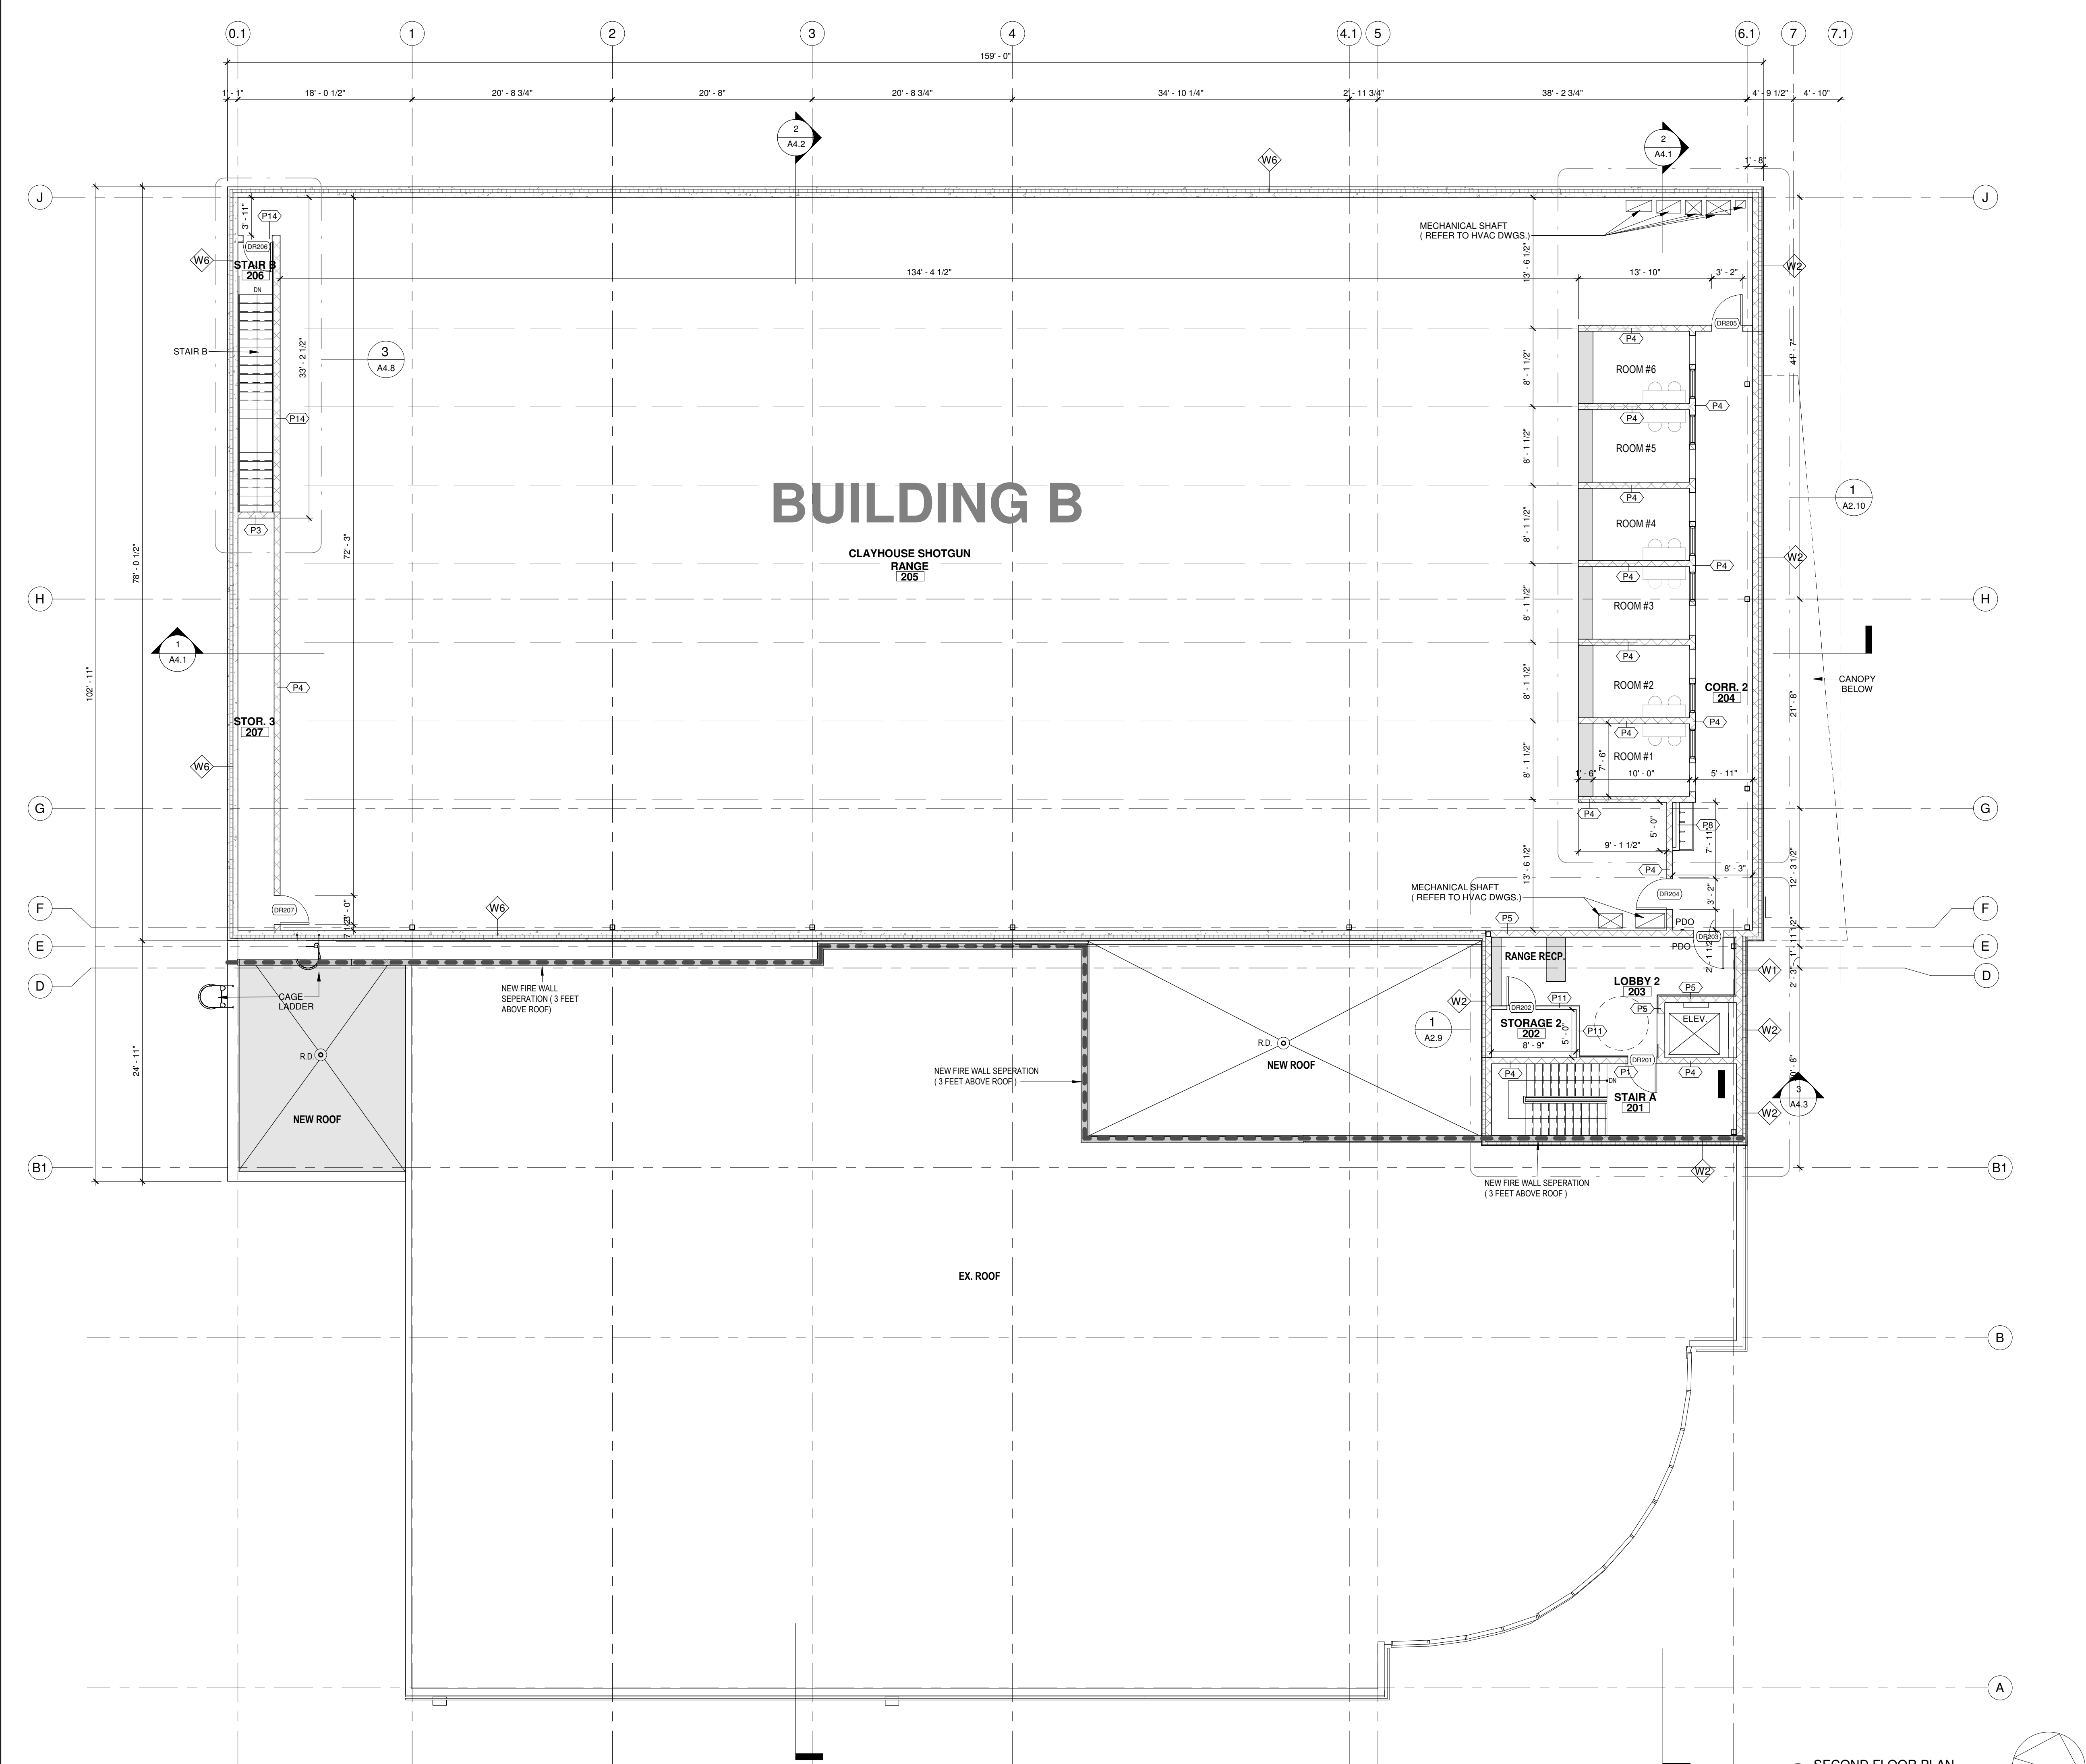

LEGEND	
	EXISTING WALLS TO REMAIN
	EXISTING WALLS TO BE DEMOLISHED
	NEW INTERIOR WALLS
	POWER DOOR OPERATOR
	FLOOR DRAIN (REFER TO MECH DWGS)
	DOOR TYPE
	EXTERIOR WALL TYPE
	INTERIOR WALL TYPE
	GLAZING NUMBER
	4 HR FIRE WALL SEPERATION

FLOOR PLAN NOTES		
1. FOR GENERAL NOTES, LEGEND AND WALL TYPES, REFER TO DRAWING A1.2.		
2. READ ARCHITECTURAL DRAWINGS IN CONJUNCTION WITH THE ARCHITECTURAL SPECIFICATIONS, INTERFACE BETWEEN DISCIPLINES (STRUCTURAL, MECHANICAL, HVAC, PLUMBING AND ELECTRICAL) AND WORK BETWEEN TRADES SHALL BE COORDINATED PRIOR TO PROCEEDING WITH CONSTRUCTION.		
3. ALL DIMENSIONS ON THIS DRAWING HAVE BEEN ROUNDED TO THE NEAREST 1/4" FOR CLARITY.		
4. ALL EXISTING DIMENSIONS ARE PLUS/MINUS. CONTRACTOR TO VERIFY DIMENSIONS FOR EXISTING BUILDING PRIOR TO CONSTRUCTION.		
5. FOR FLOOR FINISHES REFER TO FLOOR FINISH PLAN ON DRAWING A2.3.		
6. FOR FLOOR DRAIN LOCATIONS REFER TO MECHANICAL DRAWINGS TYP.		
7. FOR DOOR AND FRAME TYPES REFER TO DOOR SCHEDULE ON DRAWING A1.3.		
8. PARTITIONS WHICH SUPPORT FIXTURES, MILLWORK AND/OR ACCESSORIES ARE TO BE REINFORCED WITH WOOD STUD BLOCKING AND/OR PLYWOOD AS REQUIRED TO PROVIDE RIGID SUPPORT AND A FASTENING SURFACE.		
9. ALL EXISTING WINDOWS TO REMAIN UNLESS OTHERWISE NOTED.		
10. ALL STEEL STUD PARTITIONS ARE TO BE EXTENDED MIN. 6" ABOVE FINISHED CEILING UNLESS OTHERWISE NOTED. STUDS PARTITION FRAMING TO BE MIN. 20 GAUGE UNLESS OTHERWISE NOTED. APPLY WEB STIFFENERS WHEN IF EXCEED MAX. HEIGHT SPAN.		
11. GENERAL CONTRACTOR TO ENSURE ALL NEW AND EXISTING COMBUSTIBLE ELECTRICAL AND DATA WIRING IS CONCEALED IN A NON-COMBUSTIBLE RACEWAY WITHIN THE RETURN ARE PLENUM.		
12. BUILDING SERVICES THAT PENETRATE A FIRE WALL OR FIRE SEPERATION SHALL BE SEALED BY A FIRE STOP SYSTEM THAT HAS A FIRE RATING NOT LESS THAN FIRE RESISTANCE RATING FOR THE FIRE SEPERATION. (OBC DIV. B - 3.1.8.)		
13. GENERAL CONTRACTOR TO ENSURE EXISTING DEMISING WALLS REMAIN CONTINUOUS DURING CONSTRUCTION. REFER TO WALL TYPES ON DRAWING A1.2 FOR EXISTING DEMISING WALL TREATMENT.		
14. ALL EXISTING STRUCTURE SHALL REMAIN UNLESS OTHERWISE NOTED.		
15. DOOR AND WINDOW MANUFACTURER TO SITE VERIFY ALL OPENING DIMENSIONS PRIOR TO FABRICATION.		
16. EXTERIOR DOOR AND WINDOW ASSEMBLIES TO MEET THE REQUIREMENTS OF S810 OF THE ONTARIO BUILDING CODE.		
17. EXTERIOR WALL ASSEMBLIES TO MEET THE REQUIREMENTS OF S810 OF THE ONTARIO BUILDING CODE.		
18. GENERAL CONTRACTOR TO PROVIDE GYPSUM WALL BOARD CONTROL JOINTS IN ALL WALLS. CONTROL JOINTS TO BE STRAIGHT, CONTINUOUS AND INSTALLED 30 FEET O.C. MAX.		
19. PROVIDE SOFT WEATHER TIGHT JOINTS AT ALL ADJACENT MATERIALS AND SURFACES AS PER MANUFACTURES SPECIFICATIONS.		
20. GENERAL CONTRACTOR TO INSTALL EMERGENCY/EXIT LIGHTING AS PER ELECTRICAL DRAWINGS.		
21. GENERAL CONTRACTOR TO INSPECT AND ENSURE ALL EXISTING EMERGENCY/EXIT LIGHTS ARE IN GOOD WORKING CONDITION. REPLACE BATTERY PACK AS REQUIRED.		
22. CONTRACTOR TO PROVIDE ARCHITECT/ELECTRICAL CONSULTANT WITH AN EMERGENCY LIGHTING TEST REPORT.		
23. GENERAL CONTRACTOR TO HAVE EXISTING FIRE ALARM SYSTEM VERIFIED AND PROVIDE A CERTIFICATE TO THE ARCHITECT / ELECTRICAL CONSULTANTS, BUILDING DEPARTMENT AND FIRE DEPARTMENT.		
24. EXISTING ROOF TO REMAIN INTACT UNLESS OTHERWISE NOTED.		
25. TRANSPARENT DOORS AND PANELS IN PUBLIC AREAS SHALL BE CONSTRUCTED WITH TEMPERED GLASS OR LAMINATED GLASS AND SHALL BE APPROVED BY ATTACHING NON-TRANSPARENT HARDWARE AS REQUIRED BY 3.3.1.18 OF THE ONTARIO BUILDING CODE.		
26. REFER TO SECURITY DRAWINGS FOR ALL SECURITY ACCESS DEVICE LOCATIONS AND REQUIREMENTS TYPICAL.		

9	05/28/2025	ISSUED FOR PERMIT	HW
8	03/19/2025	ISSUED FOR SPA	HW
7	01/13/2025	ISSUED FOR REVIEW	HW
6	06/21/2024	ISSUED FOR PRE-CON PHASE II	HW
5	06/17/2024	ISSUED FOR REVIEW	HW
4	12/19/2023	ISSUED FOR REVIEW	HW
3	12/08/2023	ISSUED FOR REVIEW	HW
2	07/18/2023	ISSUED FOR REVIEW	HW
1	07/17/2023	ISSUED FOR REVIEW	HW
No.	Date:	Issued/Revision:	By

Client:

FIREARMS OUTLET CANADA

WANG ARCHITECTS INC.
3950 14th Ave, Unit 609
Markham, ON L3R 0A9
T: 905-604-6960
E: info@wangarchitects.ca
www.wangarchitects.ca



Project :

FIREARMS OUTLET CANADA

725 WESTNEY RD. S.,
AJAX, ON L1S 7J7


Drawing Name :

SECOND FLOOR PLAN

Scale : As indicated Project No : 00026

Drawn by : JW Drawing No :

Checked by : HW A2.3

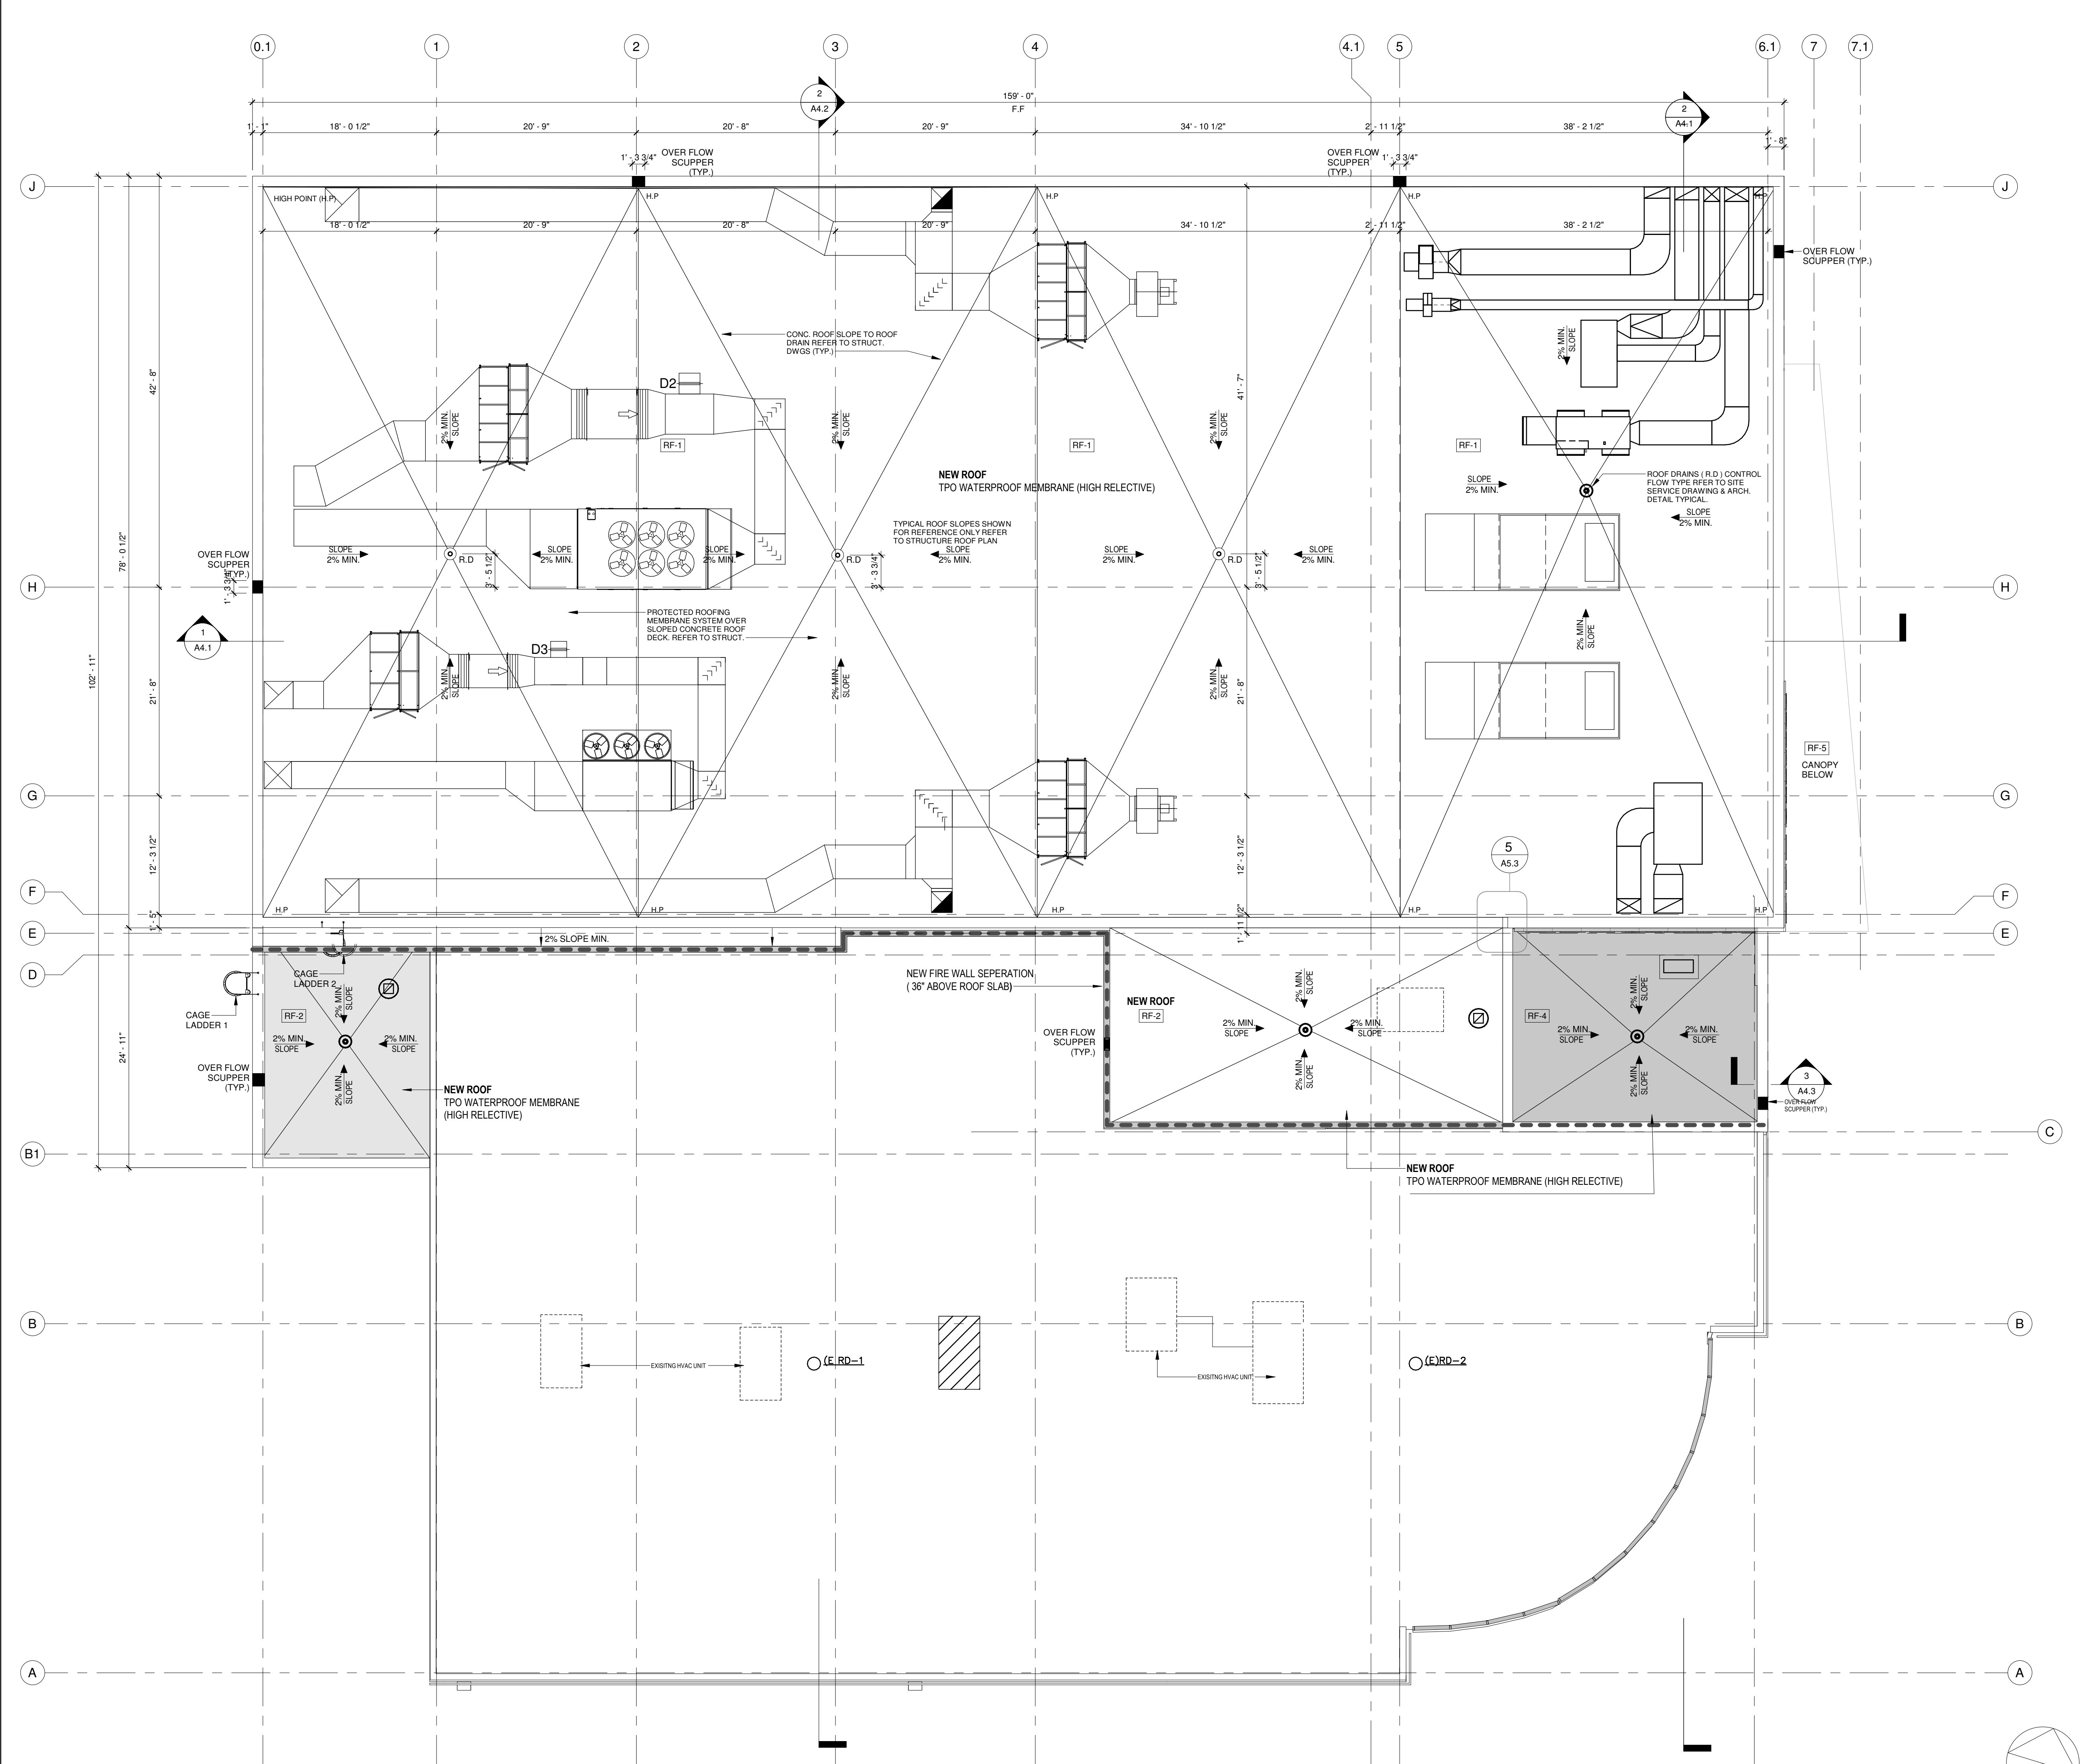

1 ROOF PLAN
1/8" = 1'-0"

LEGEND

HP HIGH POINT
RD ROOF DRAIN
SLOPE 2% MIN. ROOF SLOPE
SCUPPER

NOTE:
1. ALL NEW ROOFS SHALL BE COOL ROOFS.
2. THE COOL ROOFING MATERIAL SHALL HAVE A MINIMUM INITIAL REFLECTANCE OF 0.85 AND MINIMUM EMITTANCE OF 0.9 OR A THREE-YEAR AGED SRI VALUE OF 84.

ROOF PLAN NOTE

1. FOR GENERAL NOTES AND LEGEND, REFER TO DRAWING A002.
2. FOR WALL TYPES, REFER TO DRAWING A003.
3. READ ARCHITECTURAL DRAWINGS IN CONJUNCTION WITH ALL INTERFACE DISCIPLINE DRAWINGS (STRUCTURAL, MECHANICAL, ELECTRICAL, AND LANDSCAPE DESIGN), AND WORK BETWEEN ALL TRADES SHALL BE COORDINATED PRIOR TO PROCEEDING WITH CONSTRUCTION.
4. FOR FLOOR PLANS REFER TO DRAWINGS A201 & A202.
5. FOR MECHANICAL HVAC AND PLUMBING ROOF OPENINGS REFER TO MECHANICAL AND STRUCTURAL DRAWINGS.
6. REFER TO MECHANICAL HVAC DRAWINGS FOR LOCATIONS AND TYPES OF ROOF TOP UNITS INCLUDING ALL MIN. MAINTENANCE CLEARANCE REQUIREMENTS TYPICAL.


9	05/28/2025	ISSUED FOR PERMIT	HW
8	03/19/2025	ISSUED FOR SPA	HW
7	01/13/2025	ISSUED FOR REVIEW	HW
6	06/21/2024	ISSUED FOR PRE-CON PHASE II	HW
5	06/17/2024	ISSUED FOR REVIEW	HW
4	12/19/2023	ISSUED FOR REVIEW	HW
3	12/08/2023	ISSUED FOR REVIEW	HW
2	07/18/2023	ISSUED FOR REVIEW	HW
1	07/17/2023	ISSUED FOR REVIEW	HW

No. Date: Issued/Revision: By

Client:

FIREARMS OUTLET CANADA

WANG ARCHITECTS INC.
3950 14th Ave, Unit 609
Markham, ON L3R 0A9
T: 905-604-6960
E: info@wangarchitects.ca
www.wangarchitects.ca

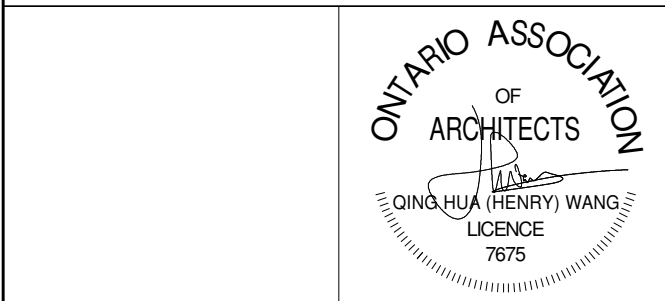

Project : FIREARMS OUTLET CANADA



725 WESTNEY RD. S.,
AJAX, ON L1S 7J7


Drawing Name : ROOF PLAN

Scale : 1/8" = 1'-0" Project No : 00026

Drawn by : JW Drawing No : A2.4

Checked by : HW

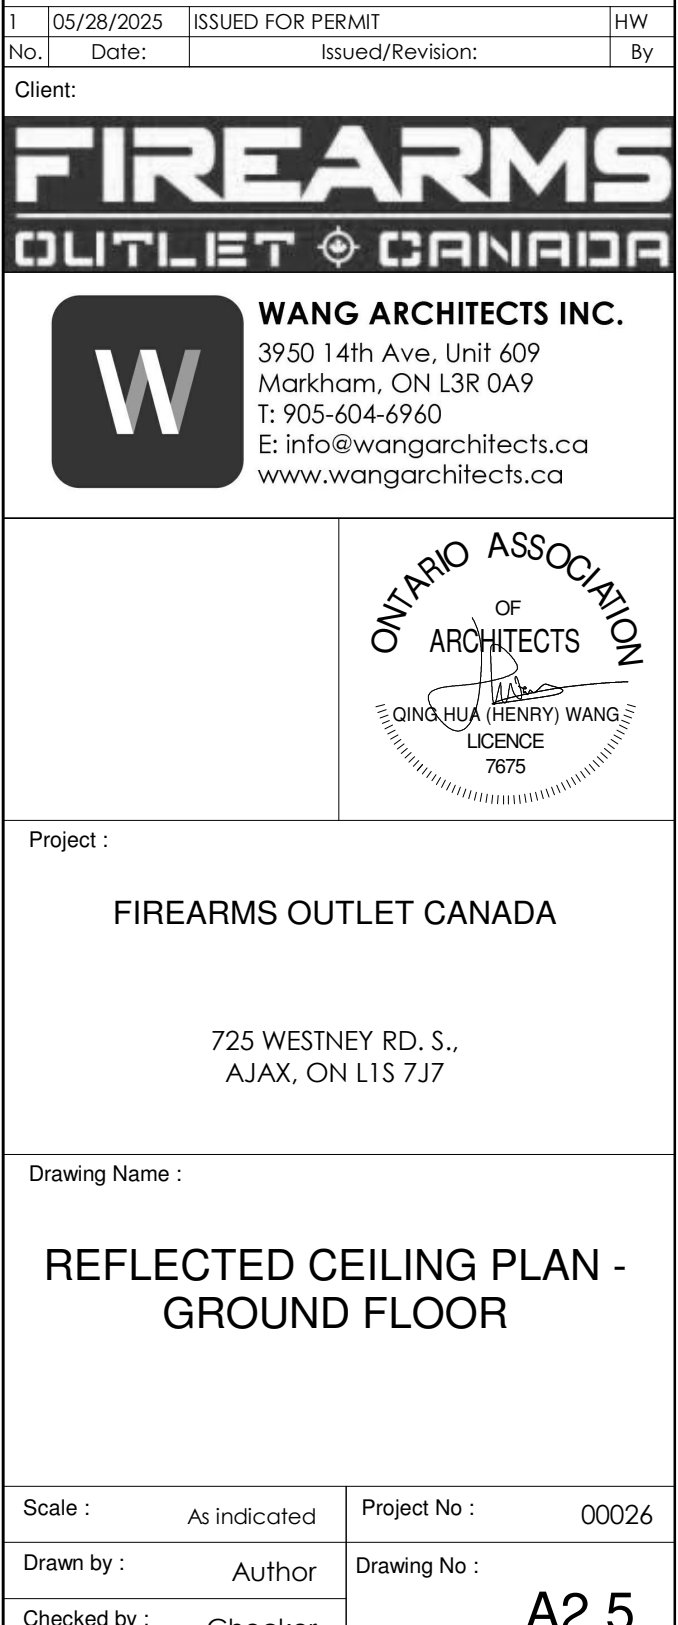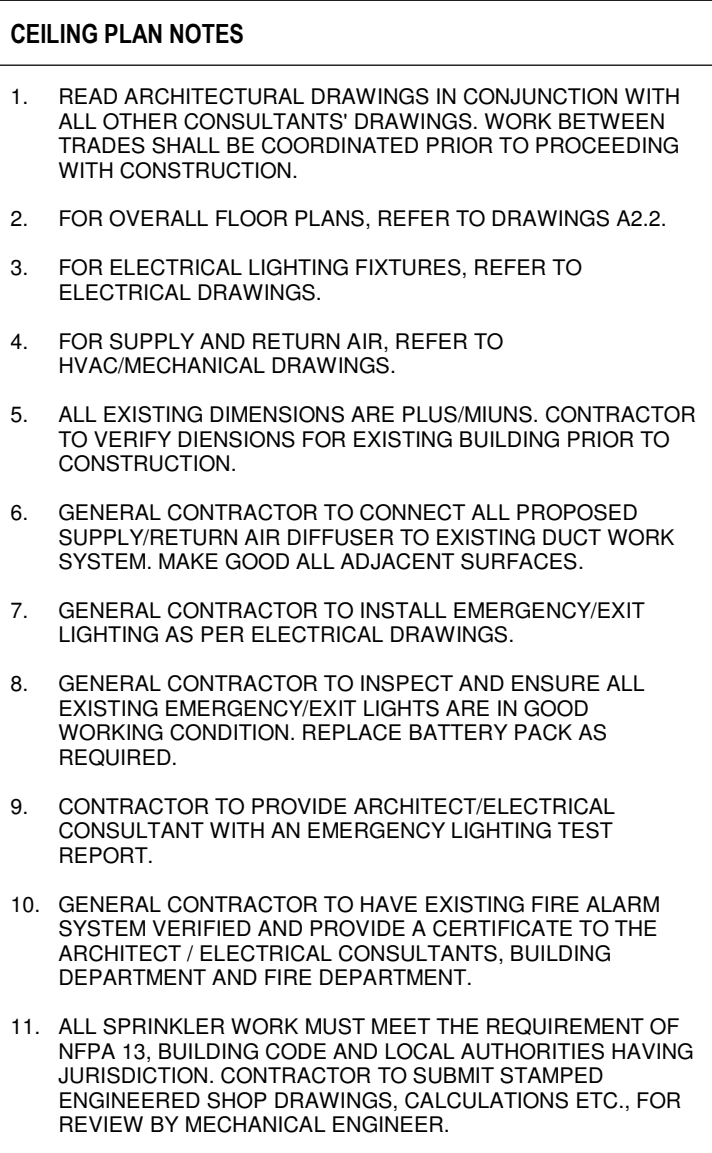

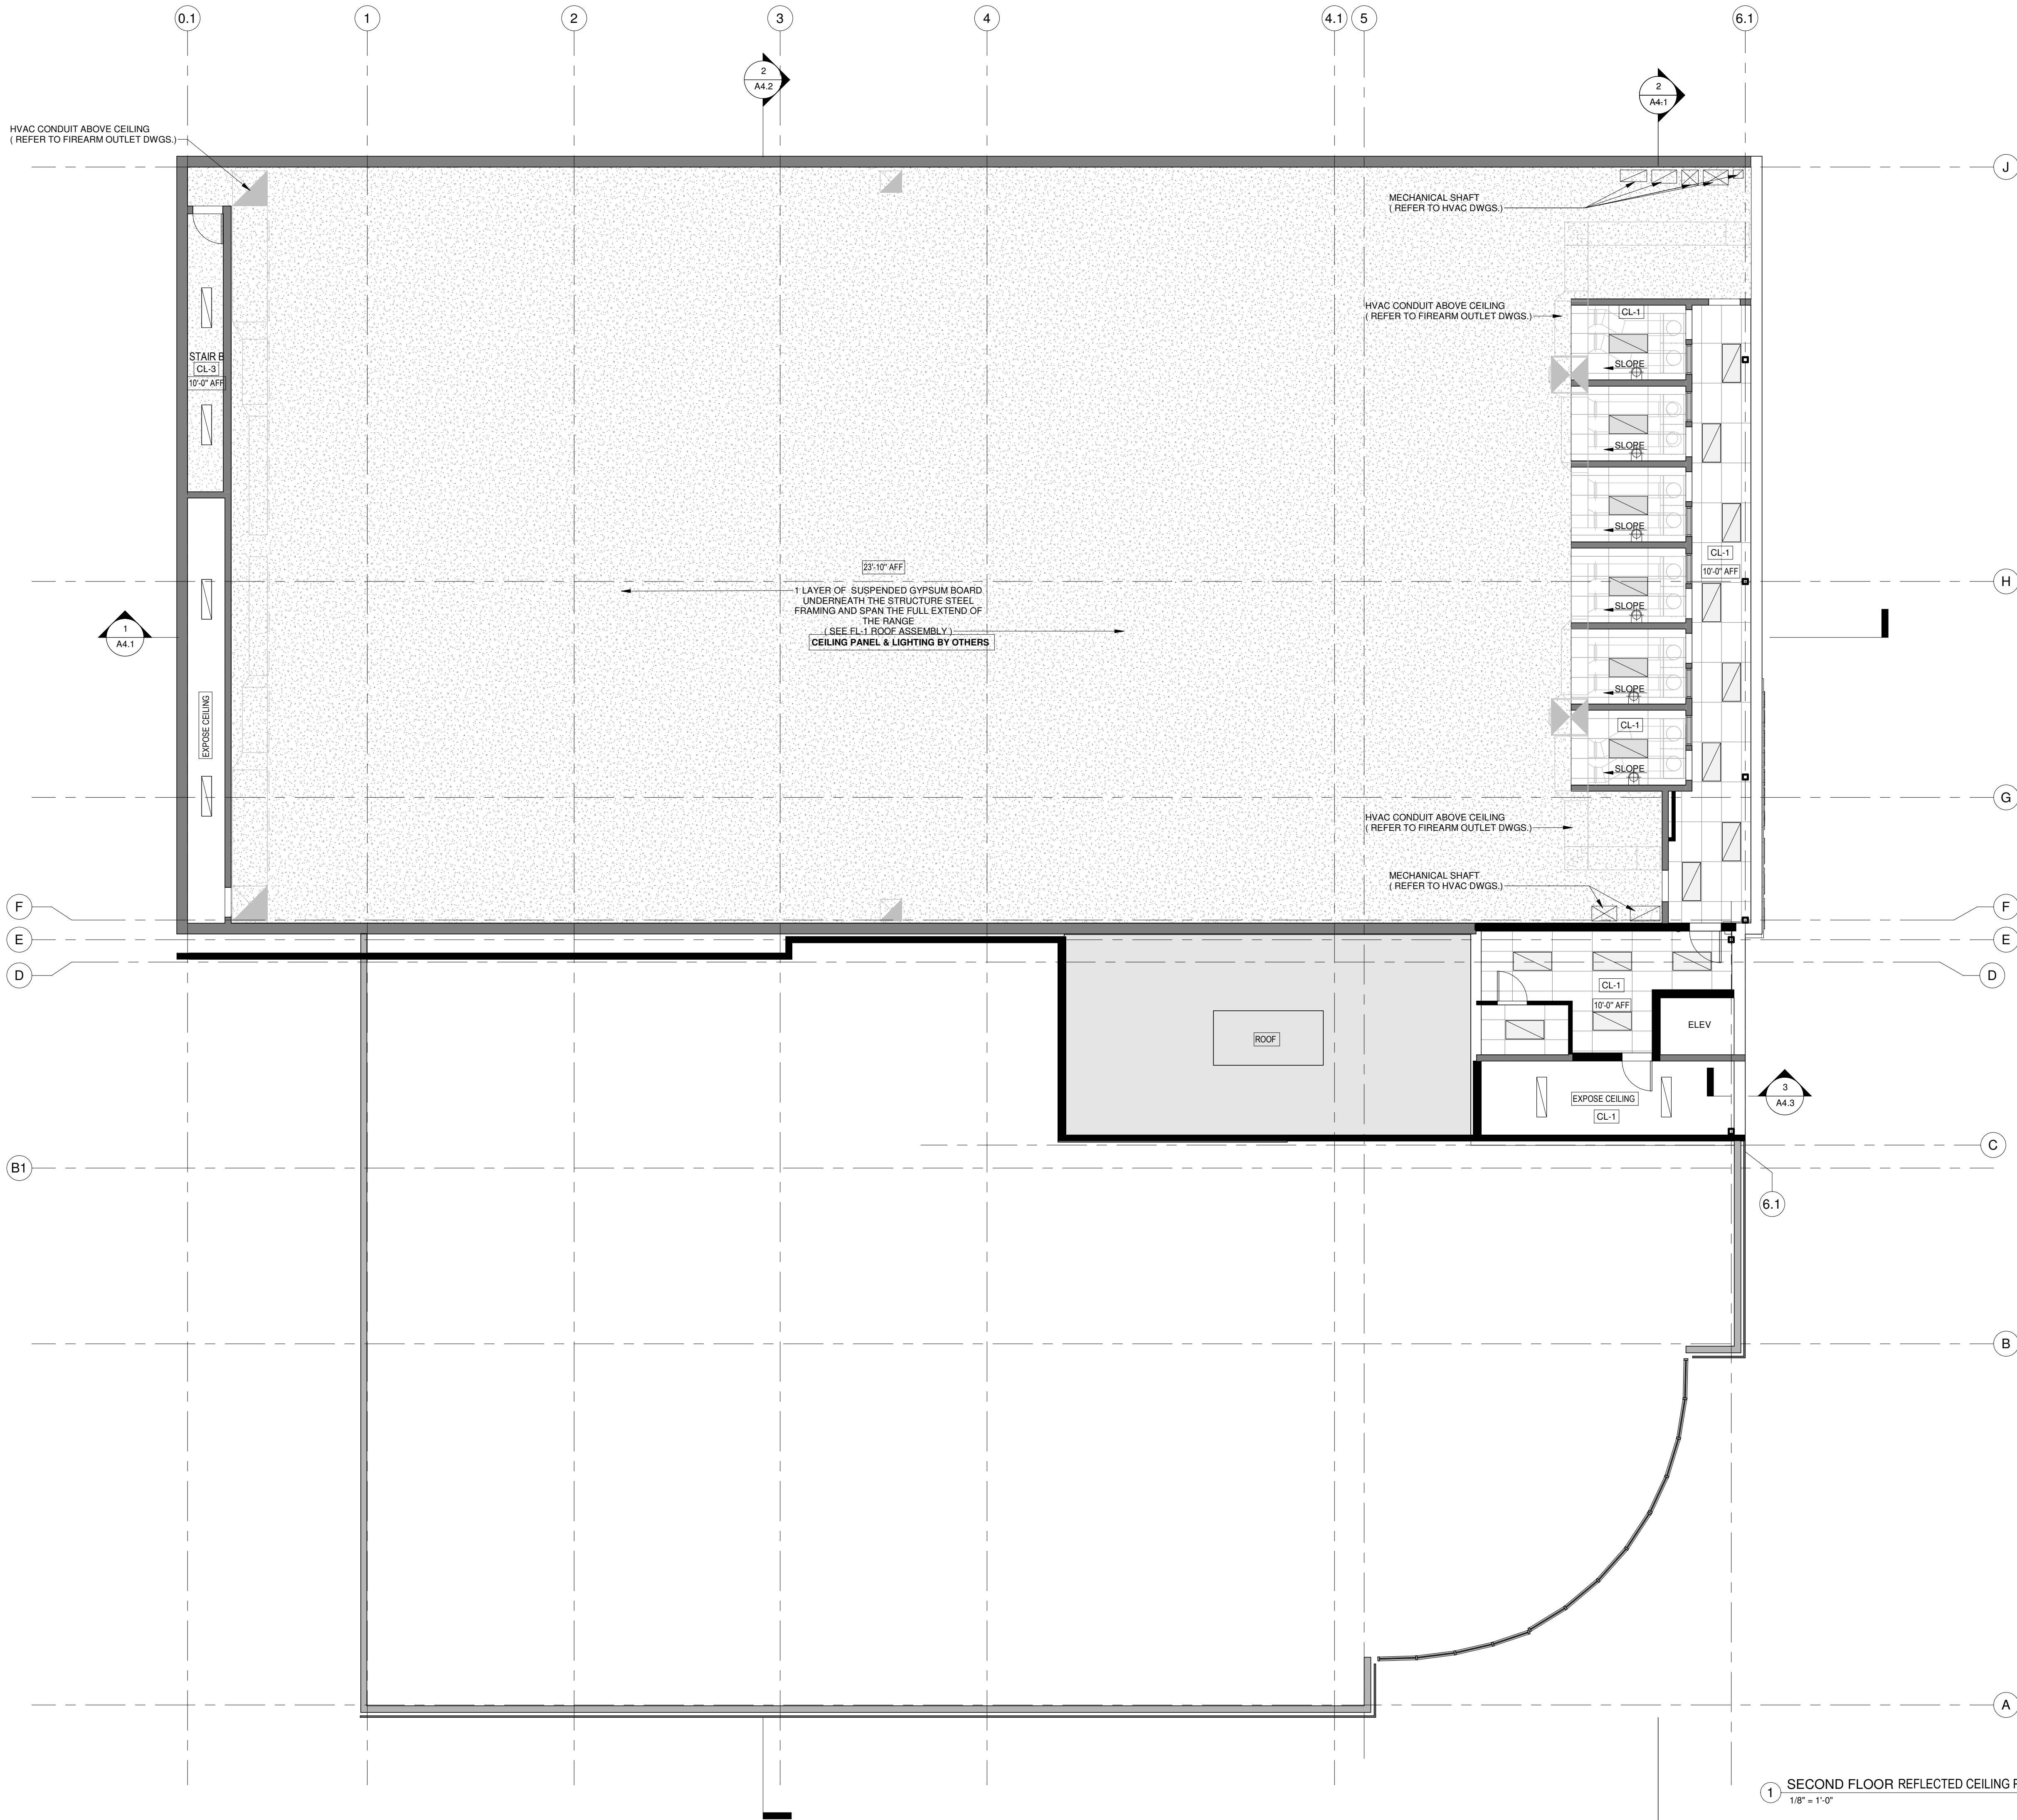

1 SECOND FLOOR REFLECTED CEILING PLAN
1/8" = 1'-0"

- CEILING PLAN NOTES**
1. READ ARCHITECTURAL DRAWINGS IN CONJUNCTION WITH ALL OTHER CONSULTANTS' DRAWINGS. WORK BETWEEN TRADES SHALL BE COORDINATED PRIOR TO PROCEEDING WITH CONSTRUCTION.
 2. FOR OVERALL FLOOR PLANS, REFER TO DRAWINGS A2.2.
 3. FOR ELECTRICAL LIGHTING FIXTURES, REFER TO ELECTRICAL DRAWINGS.
 4. FOR SUPPLY AND RETURN AIR, REFER TO HVAC/MECHANICAL DRAWINGS.
 5. ALL EXISTING DIMENSIONS ARE PLUS/MINUS. CONTRACTOR TO VERIFY DIMENSIONS FOR EXISTING BUILDING PRIOR TO CONSTRUCTION.
 6. GENERAL CONTRACTOR TO CONNECT ALL PROPOSED SUPPLY/RETURN AIR DIFFUSER TO EXISTING DUCT WORK SYSTEM. MAKE GOOD ALL ADJACENT SURFACES.
 7. GENERAL CONTRACTOR TO INSTALL EMERGENCY/EXIT LIGHTING AS PER ELECTRICAL DRAWINGS.
 8. GENERAL CONTRACTOR TO INSPECT AND ENSURE ALL EXISTING EMERGENCY/EXIT LIGHTS ARE IN GOOD WORKING CONDITION. REPLACE BATTERY PACK AS REQUIRED.
 9. CONTRACTOR TO PROVIDE ARCHITECT/ELECTRICAL CONSULTANT WITH AN EMERGENCY LIGHTING TEST REPORT.
 10. GENERAL CONTRACTOR TO HAVE EXISTING FIRE ALARM SYSTEM VERIFIED AND PROVIDE A CERTIFICATE TO THE ARCHITECT / ELECTRICAL CONSULTANTS, BUILDING DEPARTMENT AND FIRE DEPARTMENT.
 11. ALL SPRINKLER WORK MUST MEET THE REQUIREMENT OF NFPA 13, BUILDING CODE AND LOCAL AUTHORITIES HAVING JURISDICTION. CONTRACTOR TO SUBMIT STAMPED ENGINEERED SHOP DRAWINGS, CALCULATIONS ETC., FOR REVIEW BY MECHANICAL ENGINEER.

CEILING PLAN LEGEND & NOTES			
	CL-1	2' x 4' ACOUSTIC TILE CEILING ON SUSPENDED T-BAR GRID SYSTEM	
	CL-2	SUSPENDED GYPSUM CEILING	
	CL-3	ACOUSTIC PANEL	
	2' x 2' RECESSED LIGHT:	PHILIPS CFI SoTTrace LED 2x2	
	2' x 4' RECESSED LIGHT:	PHILIPS CFI SoTTrace LED 2x4	
	SUSPENDED LINEAR LIGHT:	PHILIPS FLATLINE Suspended LED 4'	
	RECESSED POT LIGHT	PHILIPS LIGHTOLIER LyteCaster LED 5" Round Downlight	
	CYLINDRICAL POT LIGHT:	LUKSPACE SURFACE MOUNTED (DN570C LED20S/840 DIA-VLC-E C WH)	
	PENDANT LIGHT #1	ROBINSON LIGHT & BATH RENITY 1 LIGHT PENDANT (Matteo)	
	PENDANT LIGHT #2 (BAR AREA)	ROBINSON LIGHT & BATH CHARISMO 1-LIGHT CYLINDER PENDANT	
	EXISTING SPRINKLER HEAD		
	NEW SPRINKLER HEAD	(REFER TO FIRE PROTECTION DRAWINGS)	
	SUPPLY AIR SQUARE DIFFUSER - REFER TO MECH. DRAWINGS		
	RED LIGHT (WALL MOUNTED)		
	SUPPLY AIR LINEAR DIFFUSER - REFER TO MECH. DRAWINGS		
	SUPPLY AIR CIRCULAR DIFFUSER - REFER TO MECH. DRAWINGS		

1	05/28/2025	ISSUED FOR PERMIT	HW
No.	Date:	Issued/Revision:	By

Client:
FIREARMS OUTLET CANADA

W **WANG ARCHITECTS INC.**
3950 14th Ave, Unit 609
Markham, ON L3R 0A9
T: 905-604-6960
E: info@wangarchitects.ca
www.wangarchitects.ca




Project :
FIREARMS OUTLET CANADA

725 WESTNEY RD. S.,
AJAX, ON L1S 7J7

Drawing Name :
REFLECTED CEILING PLAN - SECOND FLOOR

Scale :	As indicated	Project No :	00026
Drawn by :	Author	Drawing No :	A2.6
Checked by :	Checker		

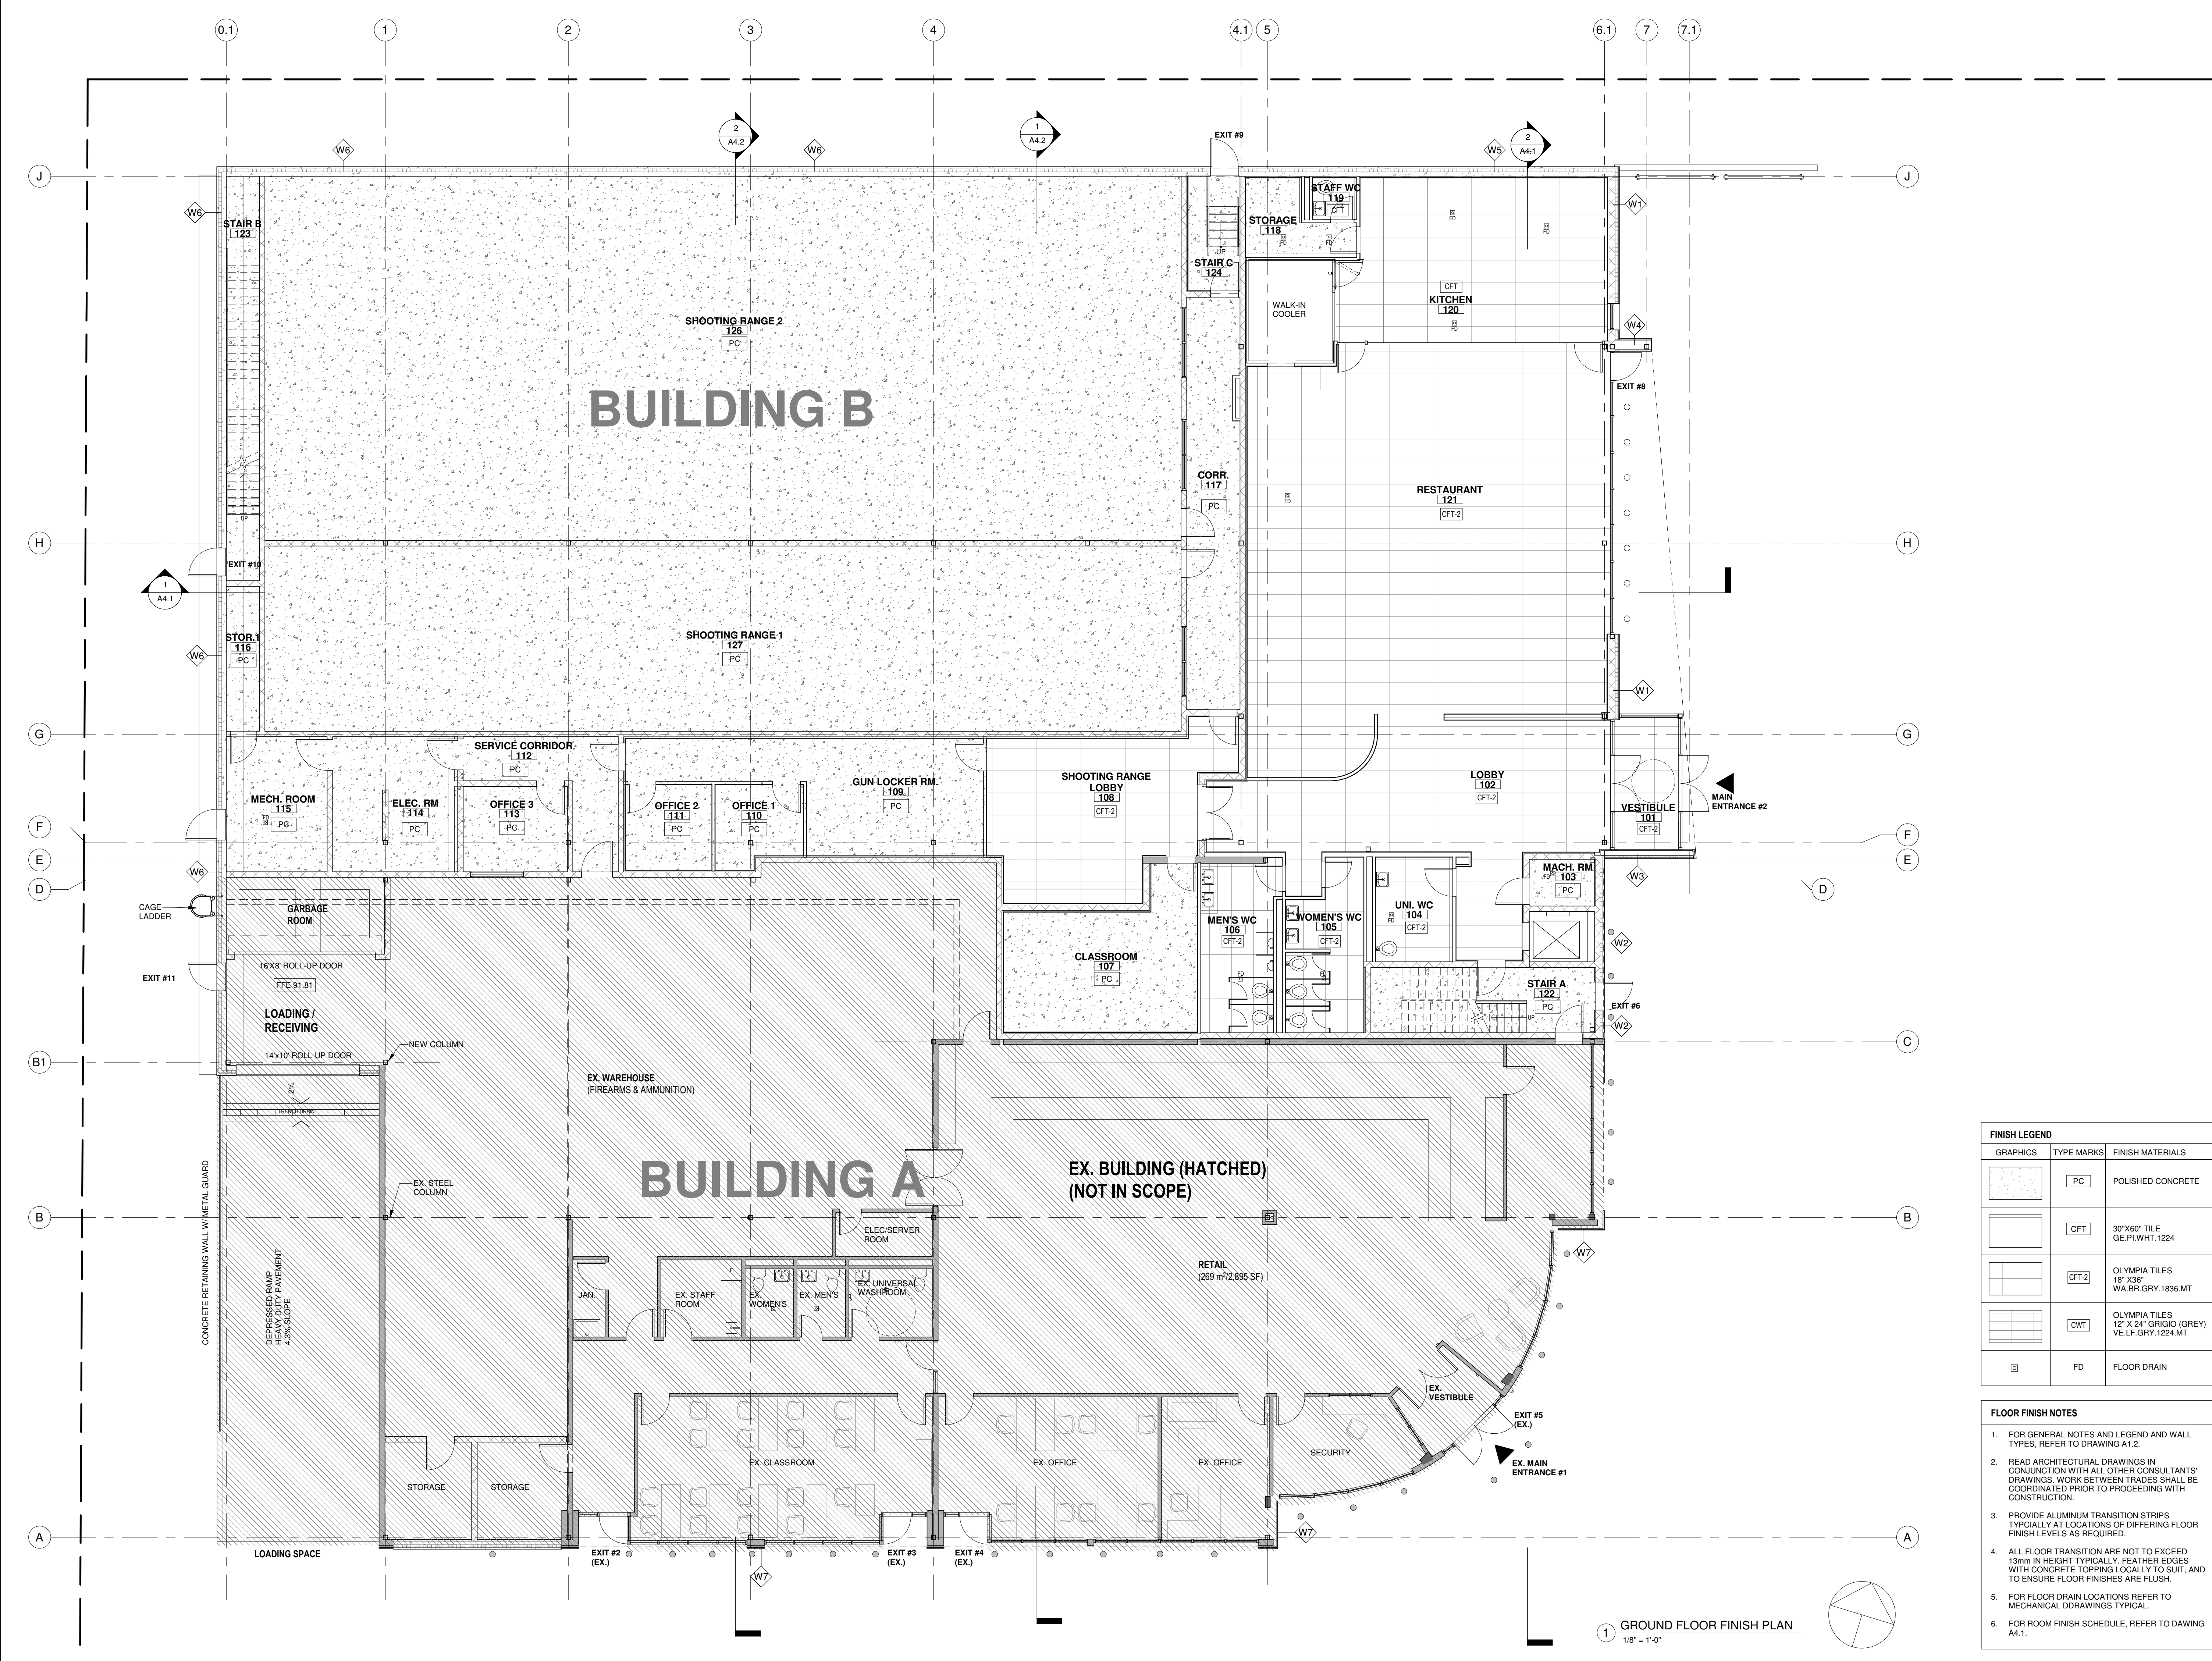

1 GROUND FLOOR FINISH PLAN
1/8" = 1'-0"

FINISH LEGEND		
GRAPHICS	TYPE MARKS	FINISH MATERIALS
	PC	POLISHED CONCRETE
	CFT	30"x60" TILE GE.PL.WHT.1224
	CFT-2	OLYMPIA TILES 18" X 36" WA.BR.GRY.1836.MT
	CWT	OLYMPIA TILES 12" X 24" GRIGIO (GREY) VE.LF.GRY.1224.MT
	FD	FLOOR DRAIN


- FLOOR FINISH NOTES**
- FOR GENERAL NOTES AND LEGEND AND WALL TYPES, REFER TO DRAWING A1.2.
 - READ ARCHITECTURAL DRAWINGS IN CONJUNCTION WITH ALL OTHER CONSULTANTS' DRAWINGS. WORK BETWEEN TRADES SHALL BE COORDINATED PRIOR TO PROCEEDING WITH CONSTRUCTION.
 - PROVIDE ALUMINUM TRANSITION STRIPS TYPICALLY AT LOCATIONS OF DIFFERING FLOOR FINISH LEVELS AS REQUIRED.
 - ALL FLOOR TRANSITION ARE NOT TO EXCEED 13mm IN HEIGHT. TYPICALLY, FEATHER EDGES WITH CONCRETE TOPPING LOCALLY TO SUIT, AND TO ENSURE FLOOR FINISHES ARE FLUSH.
 - FOR FLOOR DRAIN LOCATIONS REFER TO MECHANICAL DDRAWINGS TYPICAL.
 - FOR ROOM FINISH SCHEDULE, REFER TO DAWING A4.1.

1	05/28/2025	ISSUED FOR PERMIT	HW
No.	Date:	Issued/Revision:	By

Client:

FIREARMS OUTLET CANADA

W **WANG ARCHITECTS INC.**
3950 14th Ave, Unit 609
Markham, ON L3R 0A9
T: 905-604-6960
E: info@wangarchitects.ca
www.wangarchitects.ca

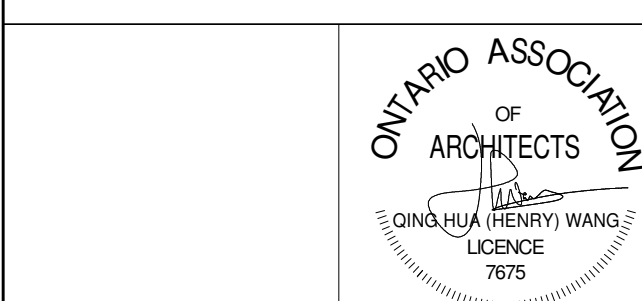


Project : FIREARMS OUTLET CANADA

725 WESTNEY RD. S.,
AJAX, ON L1S 7J7

Drawing Name : FLOOR FINISH PLAN-
GROUND FLOOR

Scale :	As indicated	Project No :	00026
Drawn by :	Author	Drawing No :	A2.7
Checked by :	Checker		

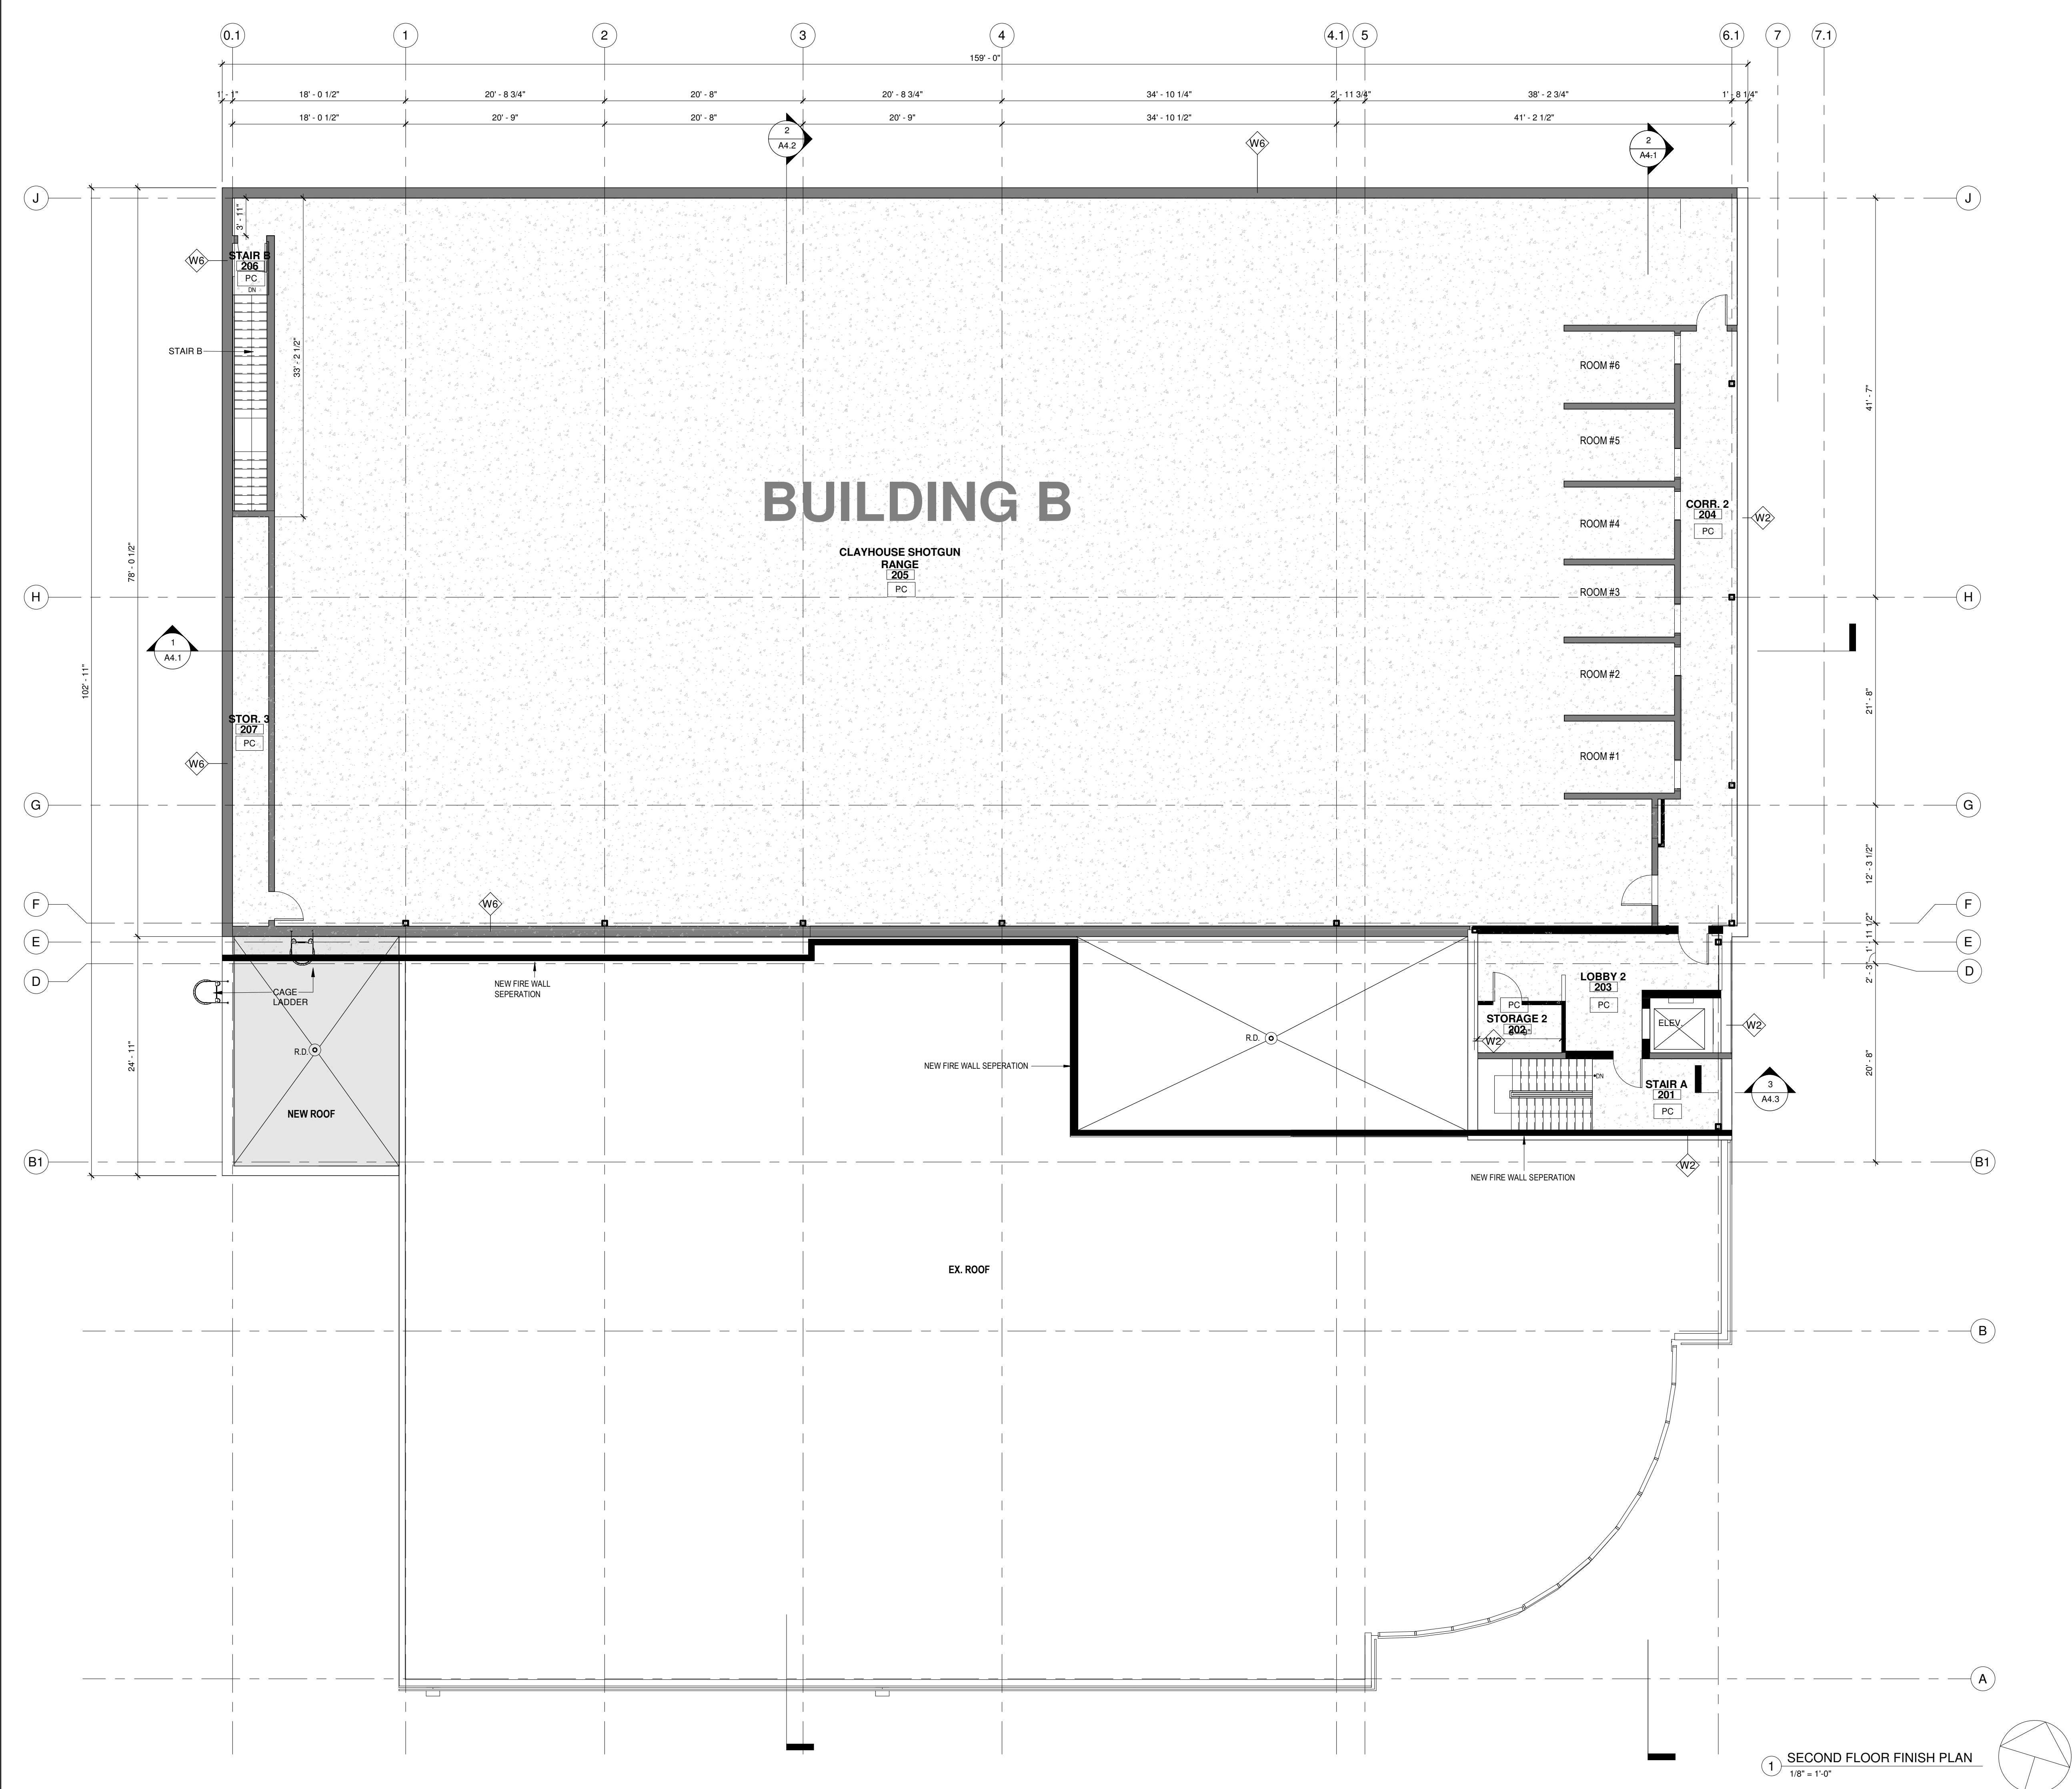

FINISH LEGEND		
GRAPHICS	TYPE MARKS	FINISH MATERIALS
	PC	POLISHED CONCRETE
	CFT	30"x60" TILE GE.PI.WHT.1224
	CFT-2	OLYMPIA TILES 18" X36" WA.BR.GRY.1836.MT
	CWT	OLYMPIA TILES 12" X 24" GRIGIO (GREY) VE.LF.GRY.1224.MT
	FD	FLOOR DRAIN


- FLOOR FINISH NOTES**
- FOR GENERAL NOTES AND LEGEND AND WALL TYPES, REFER TO DRAWING A1.2.
 - READ ARCHITECTURAL DRAWINGS IN CONJUNCTION WITH ALL OTHER CONSULTANTS' DRAWINGS. WORK BETWEEN TRADES SHALL BE COORDINATED PRIOR TO PROCEEDING WITH CONSTRUCTION.
 - PROVIDE ALUMINUM TRANSITION STRIPS TYPICALLY AT LOCATIONS OF DIFFERING FLOOR FINISH LEVELS AS REQUIRED.
 - ALL FLOOR TRANSITION ARE NOT TO EXCEED 13mm IN HEIGHT. TYPICALLY FEATHER EDGES WITH CONCRETE TOPPING LOCALLY TO SUIT, AND TO ENSURE FLOOR FINISHES ARE FLUSH.
 - FOR FLOOR DRAIN LOCATIONS REFER TO MECHANICAL DDRAWINGS TYPICAL.
 - FOR ROOM FINISH SCHEDULE, REFER TO DAWING A4.1.

1	05/28/2025	ISSUED FOR PERMIT	HW
No.	Date:	Issued/Revision:	By

Client:



WANG ARCHITECTS INC.
3950 14th Ave, Unit 609
Markham, ON L3R 0A9
T: 905-604-6960
E: info@wangarchitects.ca
www.wangarchitects.ca

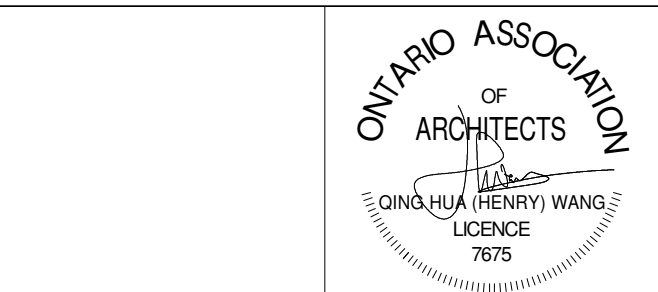

Project :
FIREARMS OUTLET CANADA


725 WESTNEY RD. S.,
AJAX, ON L1S 7J7

Drawing Name :
**FLOOR FINISH PLAN-
SECOND FLOOR**

Scale :	As indicated	Project No :	00026
Drawn by :	Author	Drawing No :	A2.8
Checked by :	Checker		

ABBREVIATIONS	
TPD	TOILET PAPER DISPENSER
SPD	SANITARY NAPKIN DISPENSER
PB	PUSH BUTTON
PDO	POWER DOOR OPERATION
PTD/R	PAPER TOWEL DISPENSER/ RECEPTACLE
SNR	SANITARY NAPKIN RECEPTACLE
SD	SOAP DISPENSER
MIR	MIRROR
CH	COAT HOOK
GB	GRAB BARS
WC	FLOOR MOUNTED WATER CLOSET
UP	URINAL PARTITION
U	URINAL
TP	TOILET PARTITION
LAV	LAVATORY

NOTE	
1.	FOR GENERAL NOTES AND LEGEND AND WALL TYPES, REFER TO DRAWING A1.2.
2.	READ ARCHITECTURAL DRAWINGS IN CONJUNCTION WITH ALL OTHER INTERFACE DISCIPLINE DRAWINGS (CIVIL, STRUCTURAL, PLUMBING, HVAC, MECHANICAL AND ELECTRICAL) AND PRIOR TO PROCEEDING WITH CONSTRUCTION.
3.	FOR ADDITIONAL INTERIOR WALL DETAILS OF FINISHES, REFER TO SPECIFIC INTERIOR BUILDING ELEVATIONS.

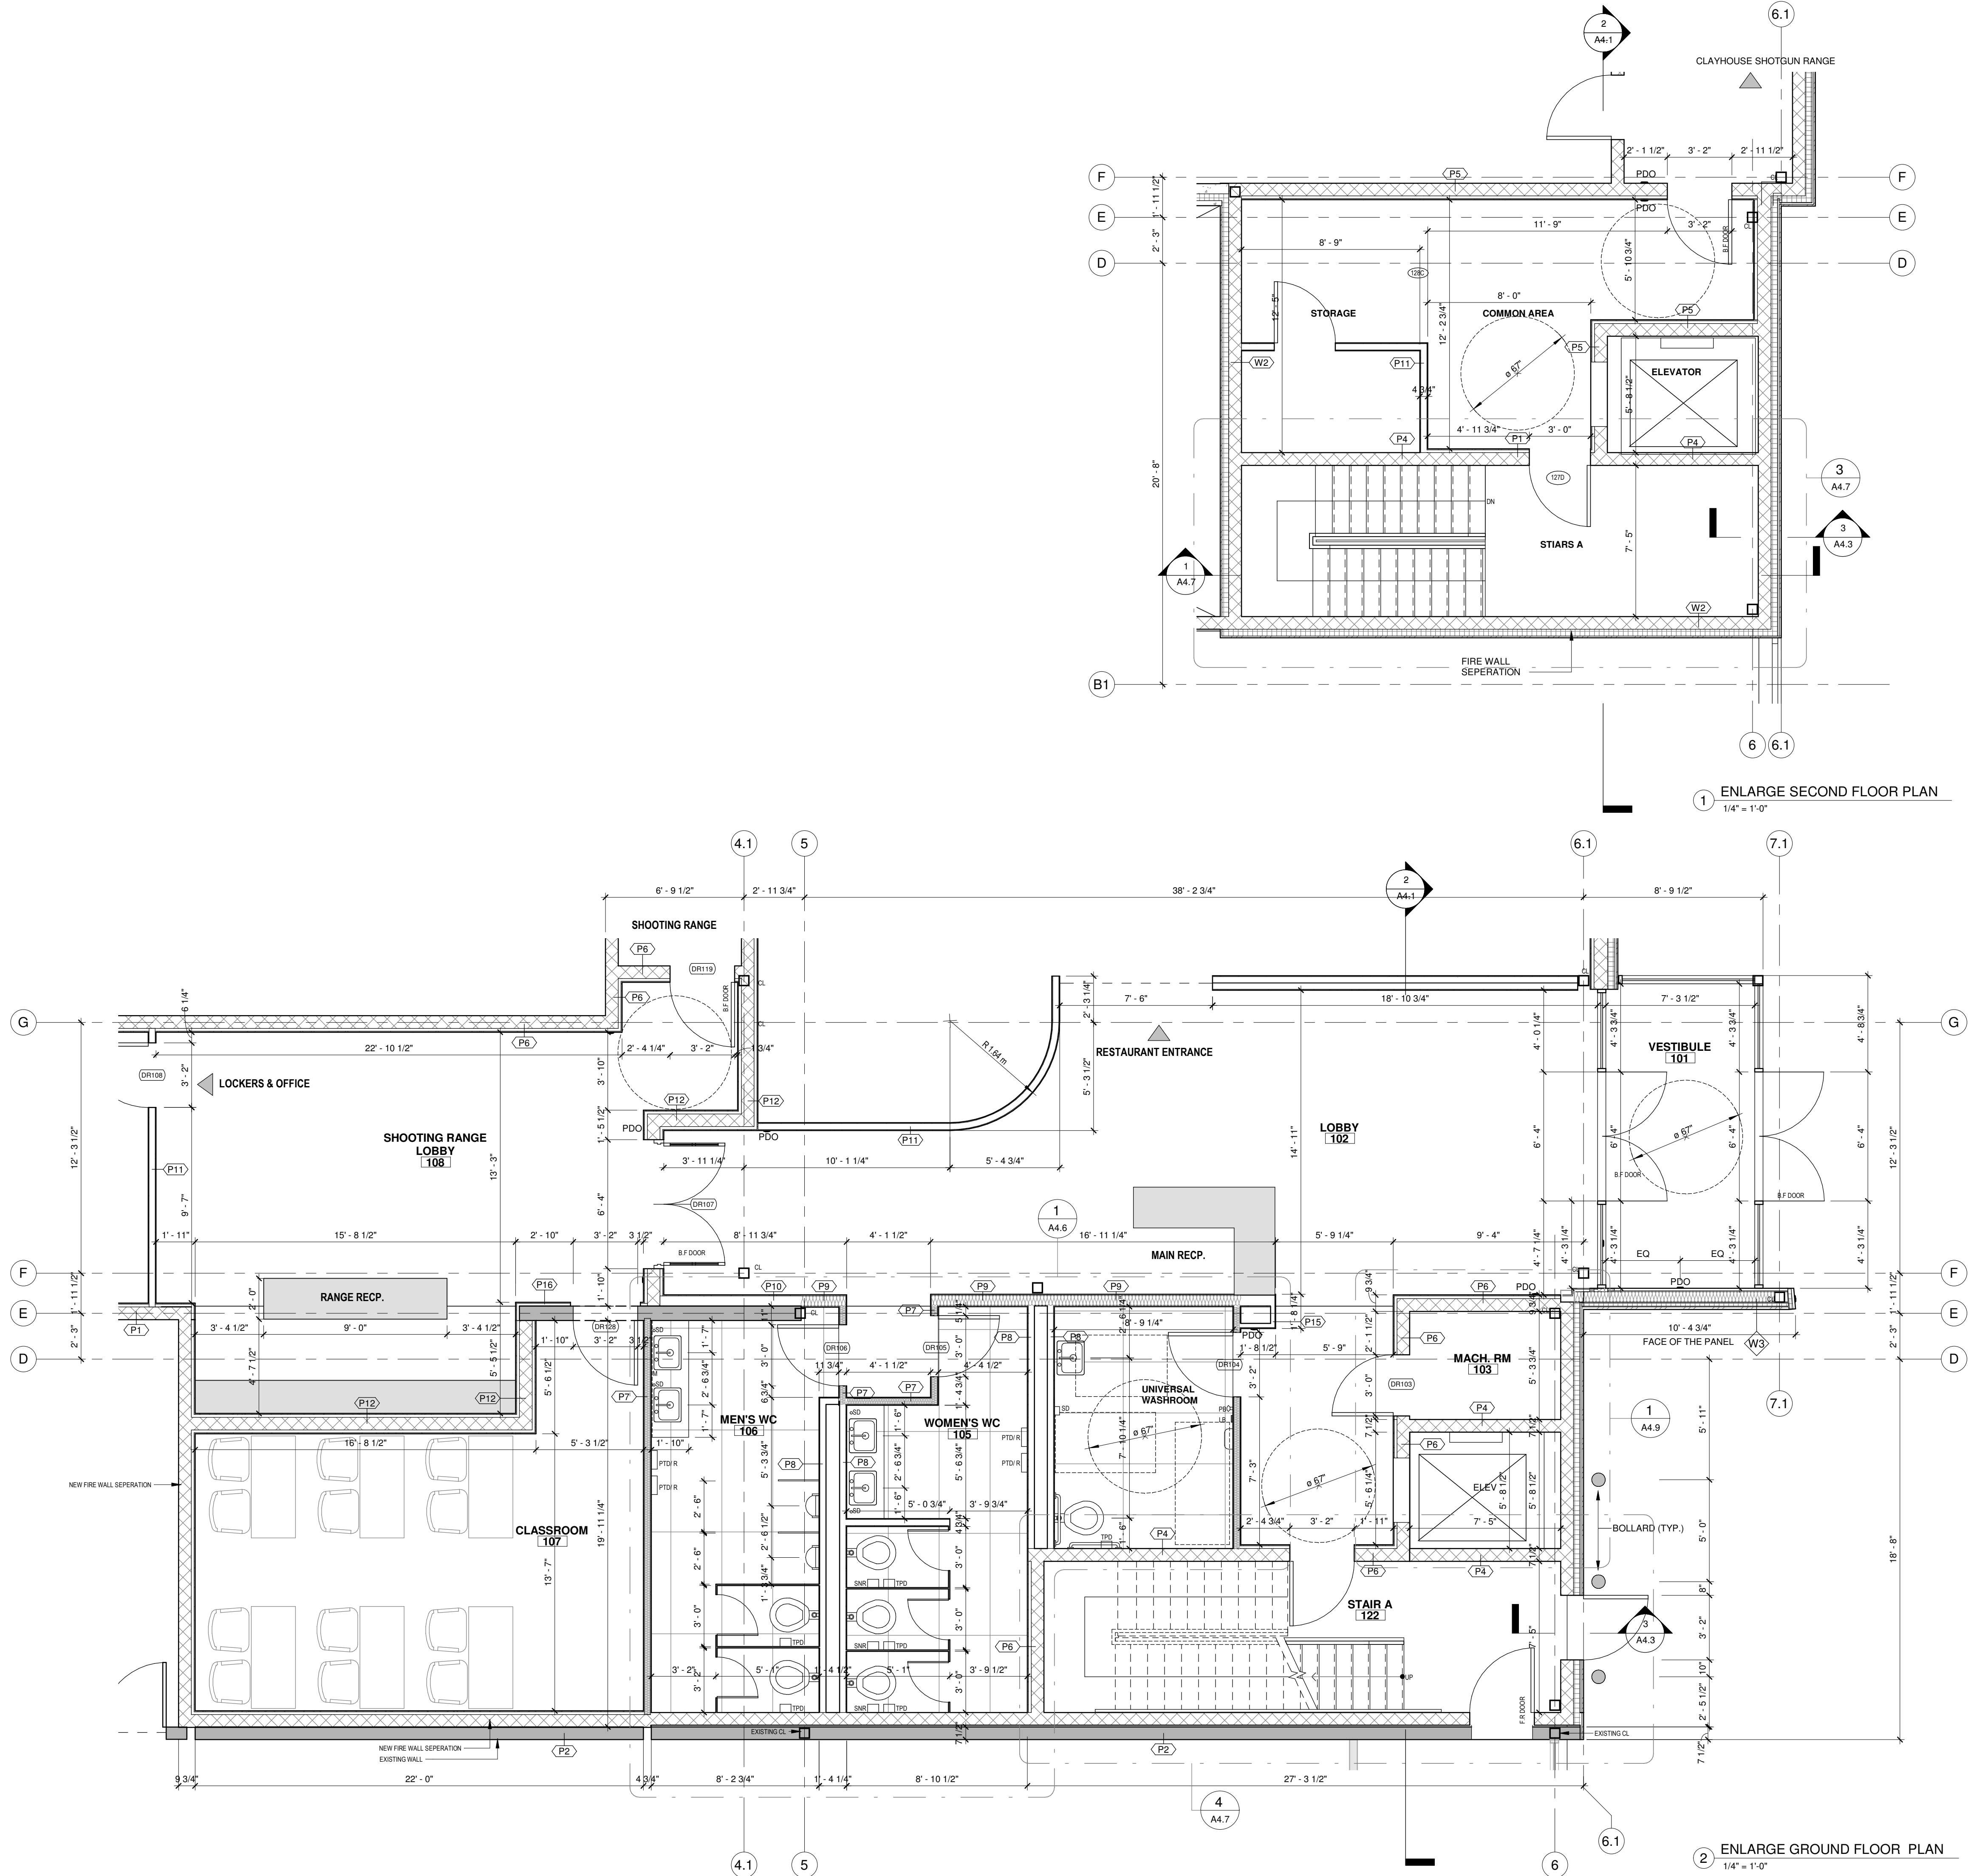

1	05/28/2025	ISSUED FOR PERMIT	HW
No.	Date:	Issued/Revision:	By

Client:



WANG ARCHITECTS INC.
3950 14th Ave, Unit 609
Markham, ON L3R 0A9
T: 905-604-6960
E: info@wangarchitects.ca
www.wangarchitects.ca




Project :
FIREARMS OUTLET CANADA


725 WESTNEY RD. S.,
AJAX, ON L1S 7J7

Drawing Name :
ENLARGE FLOOR PLAN


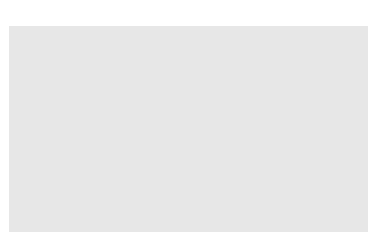


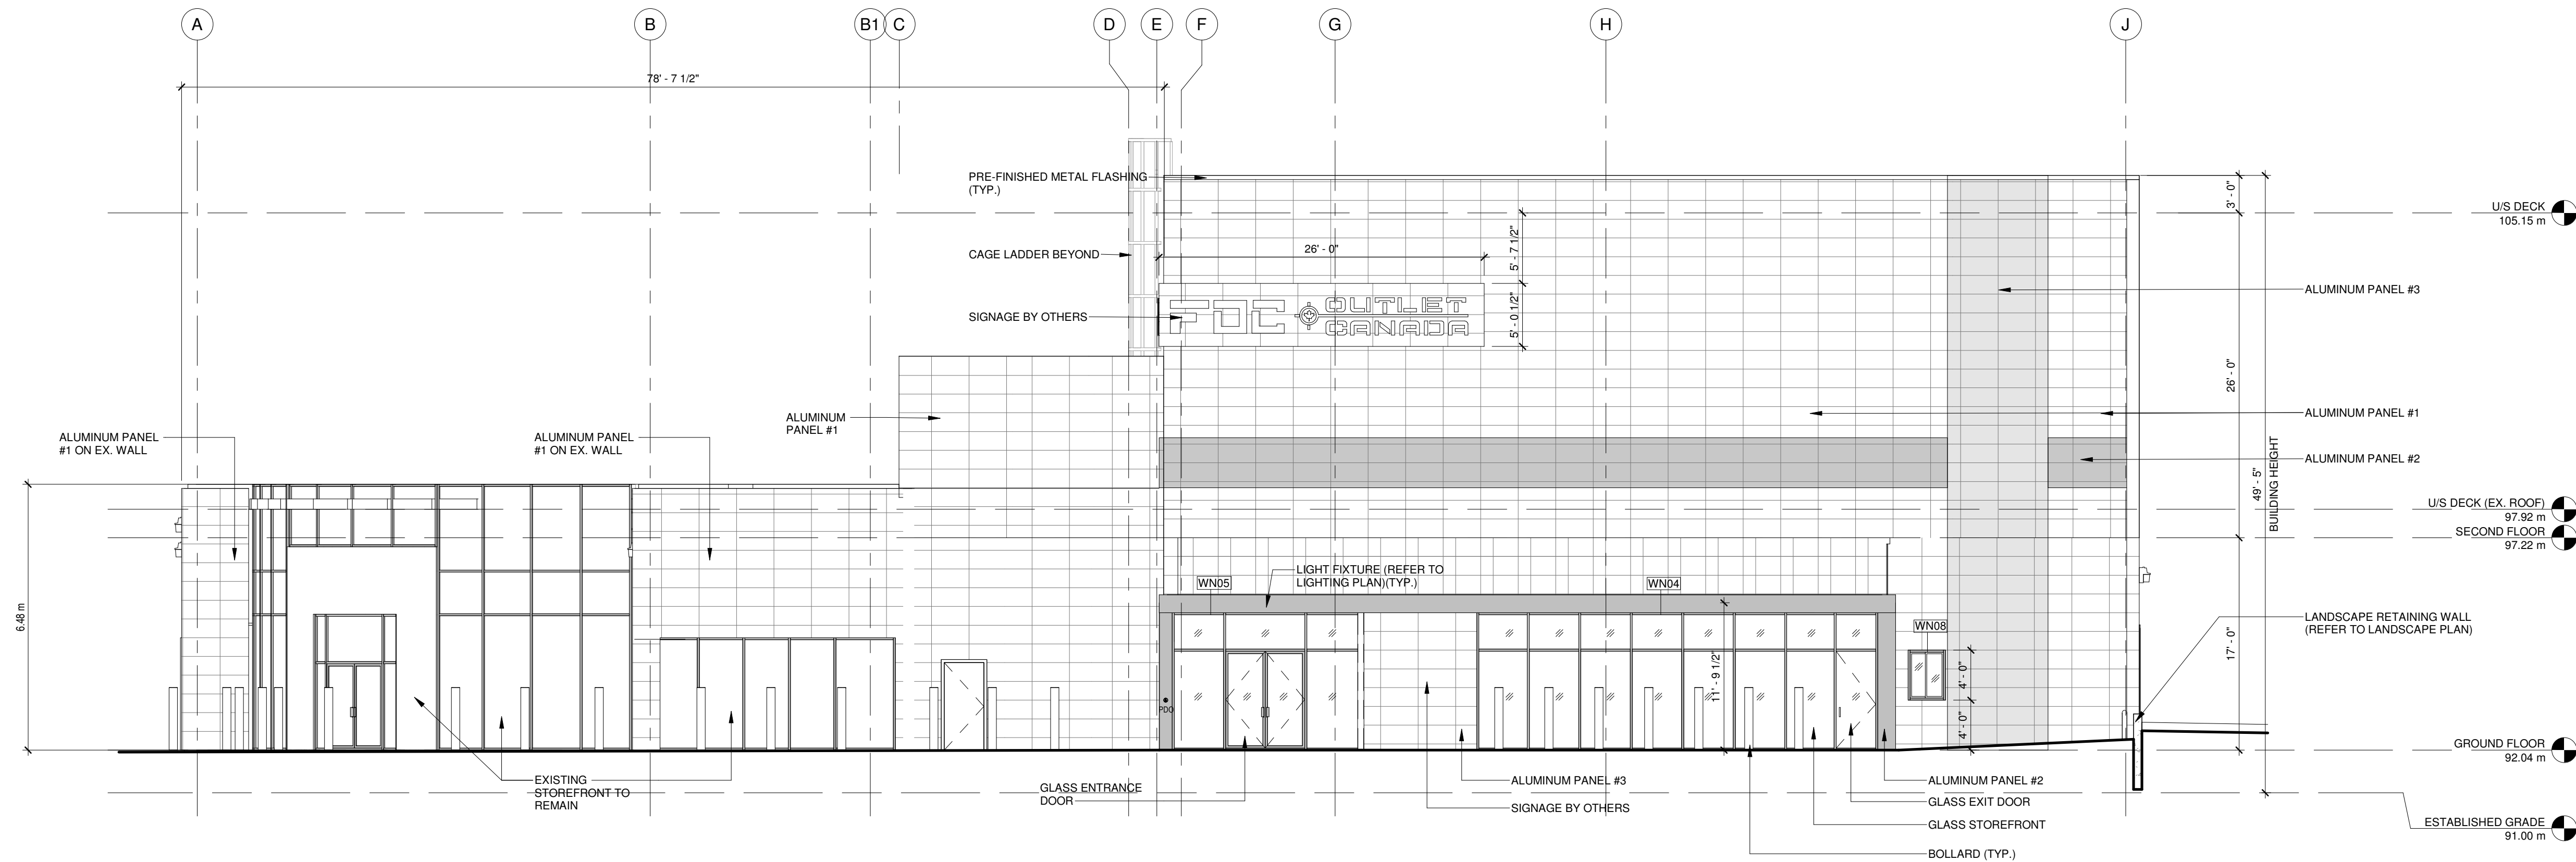Scale :	As indicated	Project No :	00026
Drawn by :	Author	Drawing No :	A2.9
Checked by :	Checker		

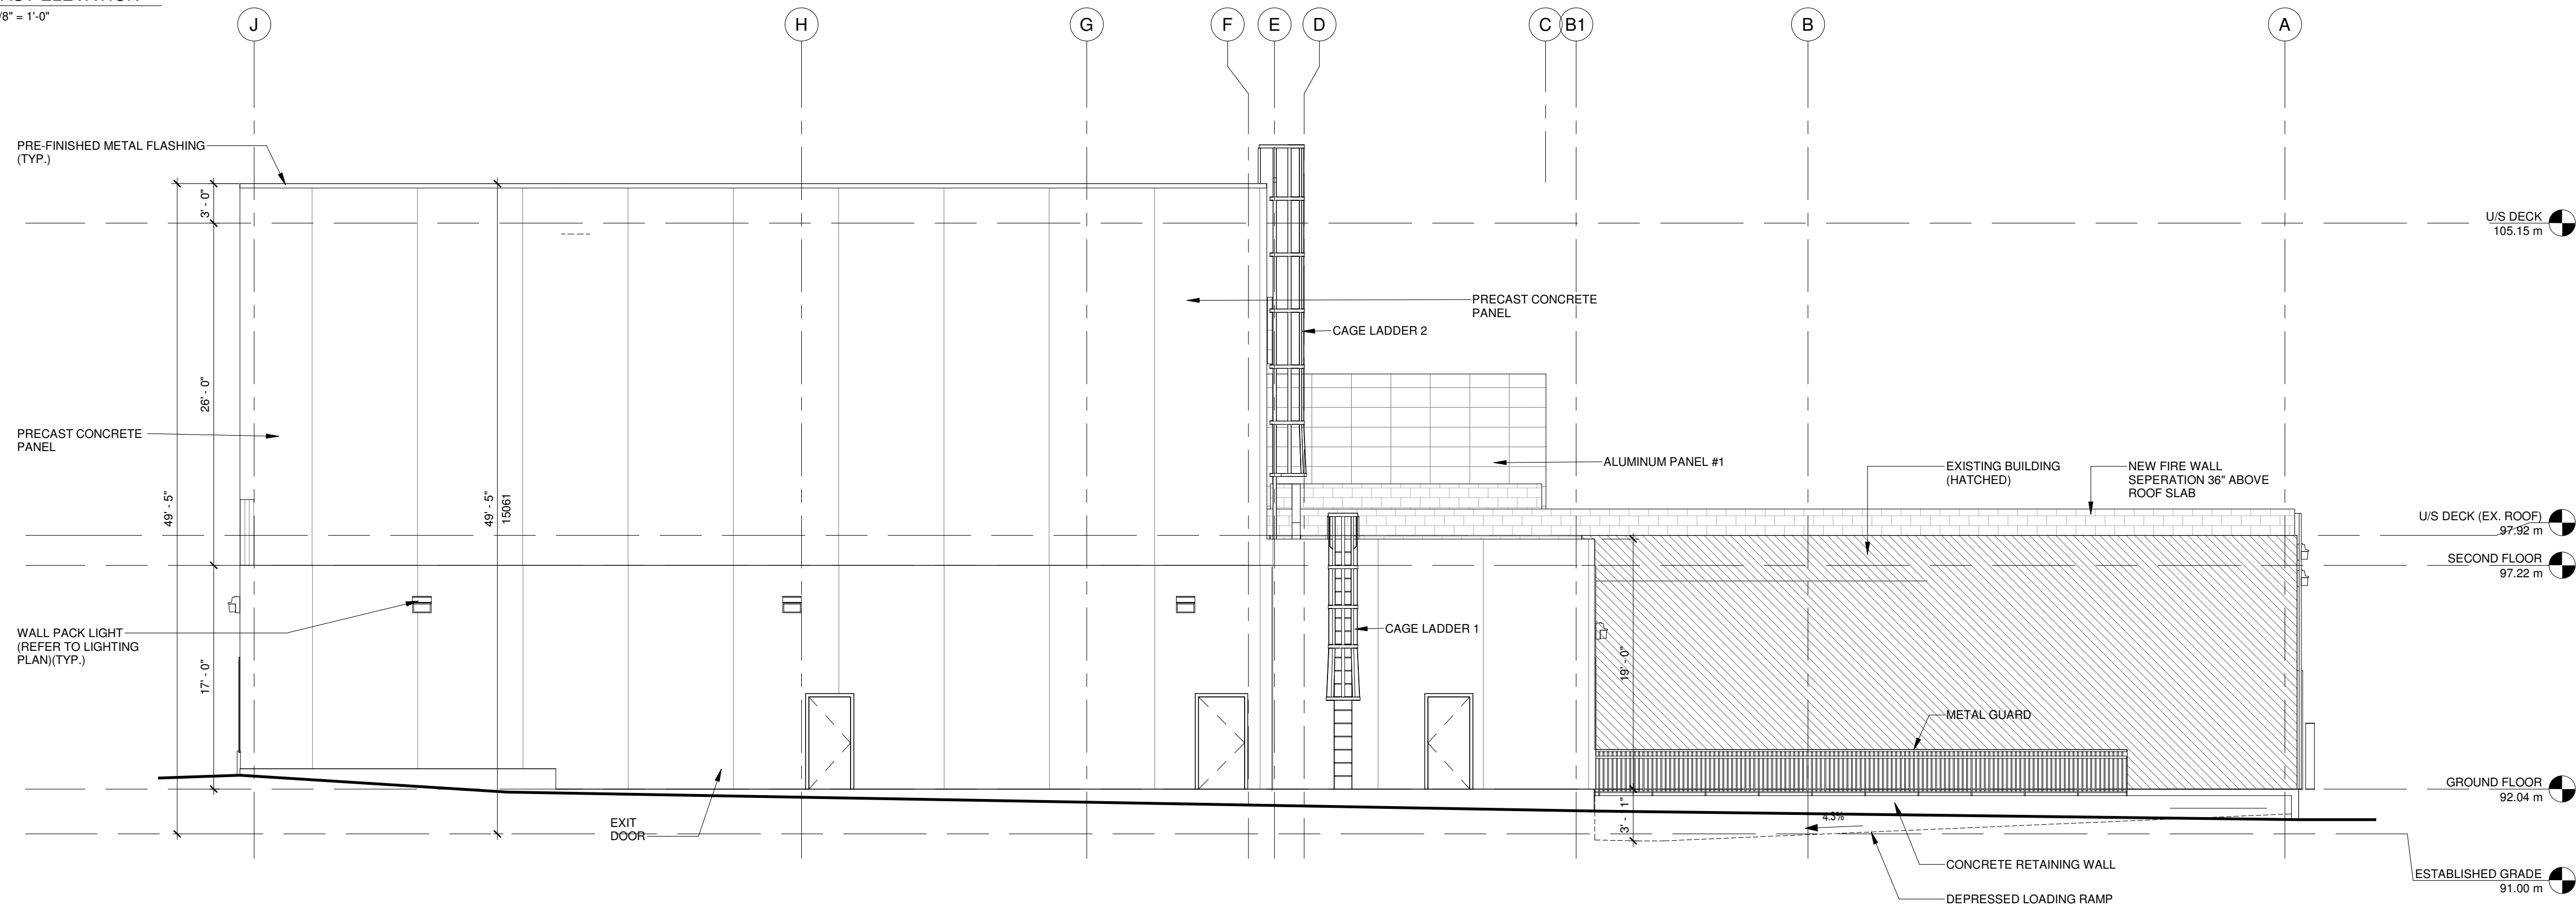

1 EAST ELEVATION
1/8" = 1'-0"



2 WEST ELEVATION
1/8" = 1'-0"

EXTERIOR WALL FINISH SCHEDULE			
PRECAST CONCRETE PANEL IN LIGHT GREY PROFORM CONCRETE	ALUMINUM PANEL #1 ALPOLIC ALUMINUM COMPOSITE PANEL OPT MICA PLATINUM	ALUMINUM PANEL #2 ALPOLIC ALUMINUM COMPOSITE PANEL CNC CHARCOAL	ALUMINUM PANEL #3 ALPOLIC ALUMINUM COMPOSITE PANEL TOR RED
			
* IMAGE FOR REFERENCE ONLY	* IMAGE FOR REFERENCE ONLY	* IMAGE FOR REFERENCE ONLY	* IMAGE FOR REFERENCE ONLY

Bird Friendly Design	Required	Proposed
Sum of total area of glazing on all elevation within 16 to 20m above grade (m²)		0
Sum of total area of treated glazing on all elevations (minimum 90% of total area of glazing within 16-20m above grade) with visual markers (m²)		0

9	05/28/2025	ISSUED FOR PERMIT	HW
8	03/19/2025	ISSUED FOR SPA	HW
7	01/13/2025	ISSUED FOR REVIEW	HW
6	06/21/2024	ISSUED FOR PRE-CON PHASE II	HW
5	06/17/2024	ISSUED FOR REVIEW	HW
4	12/19/2023	ISSUED FOR REVIEW	HW
3	12/18/2023	ISSUED FOR COORDINATION	HW
2	12/08/2023	ISSUED FOR REVIEW	HW
1	08/10/2023	ISSUED FOR REVIEW	HW
No.	Date:	Issued/Revision:	By

Client:

**FIREARMS
OUTLET CANADA**

W **WANG ARCHITECTS INC.**
3950 14th Ave, Unit 609
Markham, ON L3R 0A9
T: 905-604-6960
E: info@wangarchitects.ca
www.wangarchitects.ca



Project :
FIREARMS OUTLET CANADA

725 WESTNEY RD. S.,
AJAX, ON L1S 7J7


Drawing Name :
BUILDING ELEVATIONS

Scale : As indicated Project No : 00026


Drawn by : ZC Drawing No :

Checked by : HW

A3.1

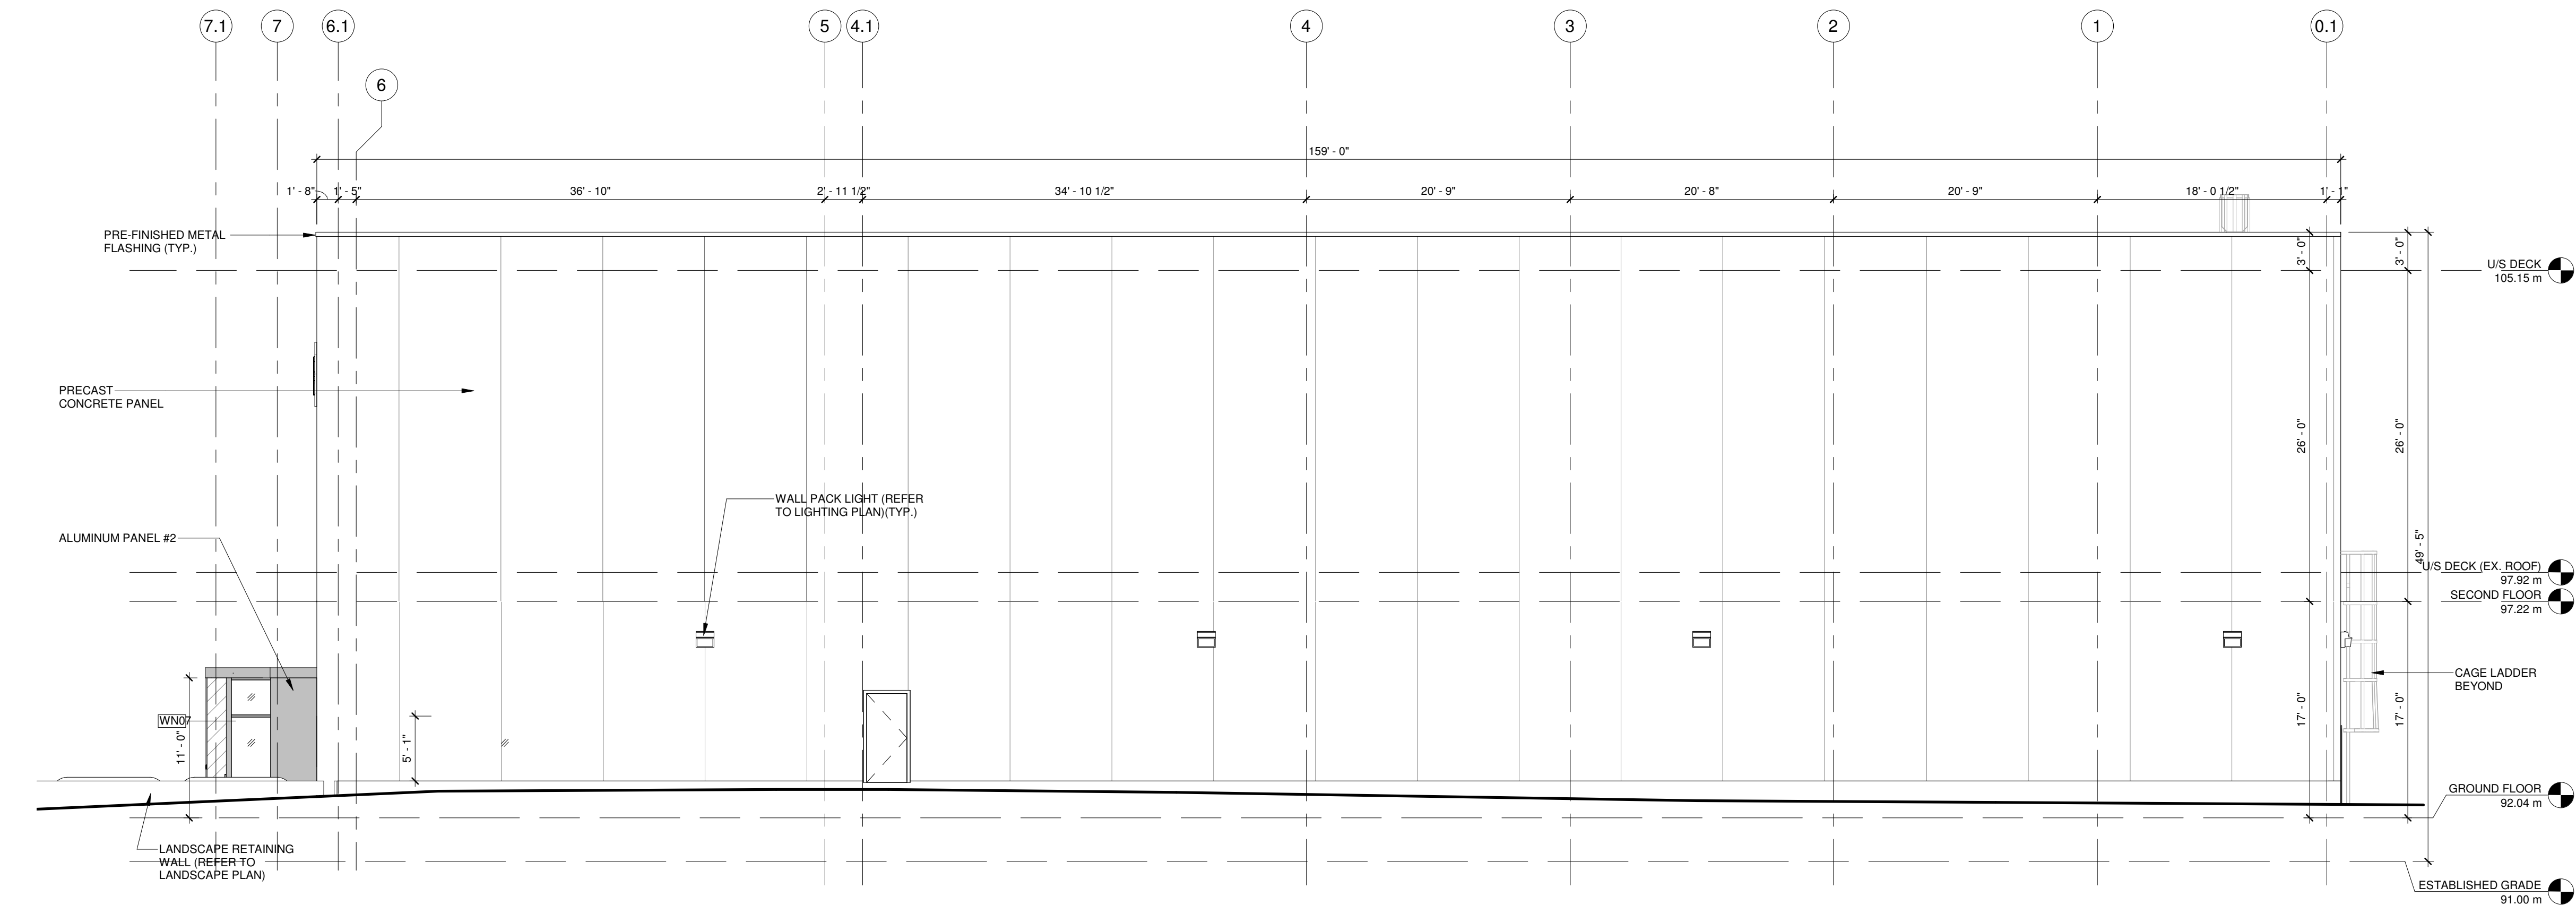

1 NORTH ELEVATION
1/8" = 1'-0"

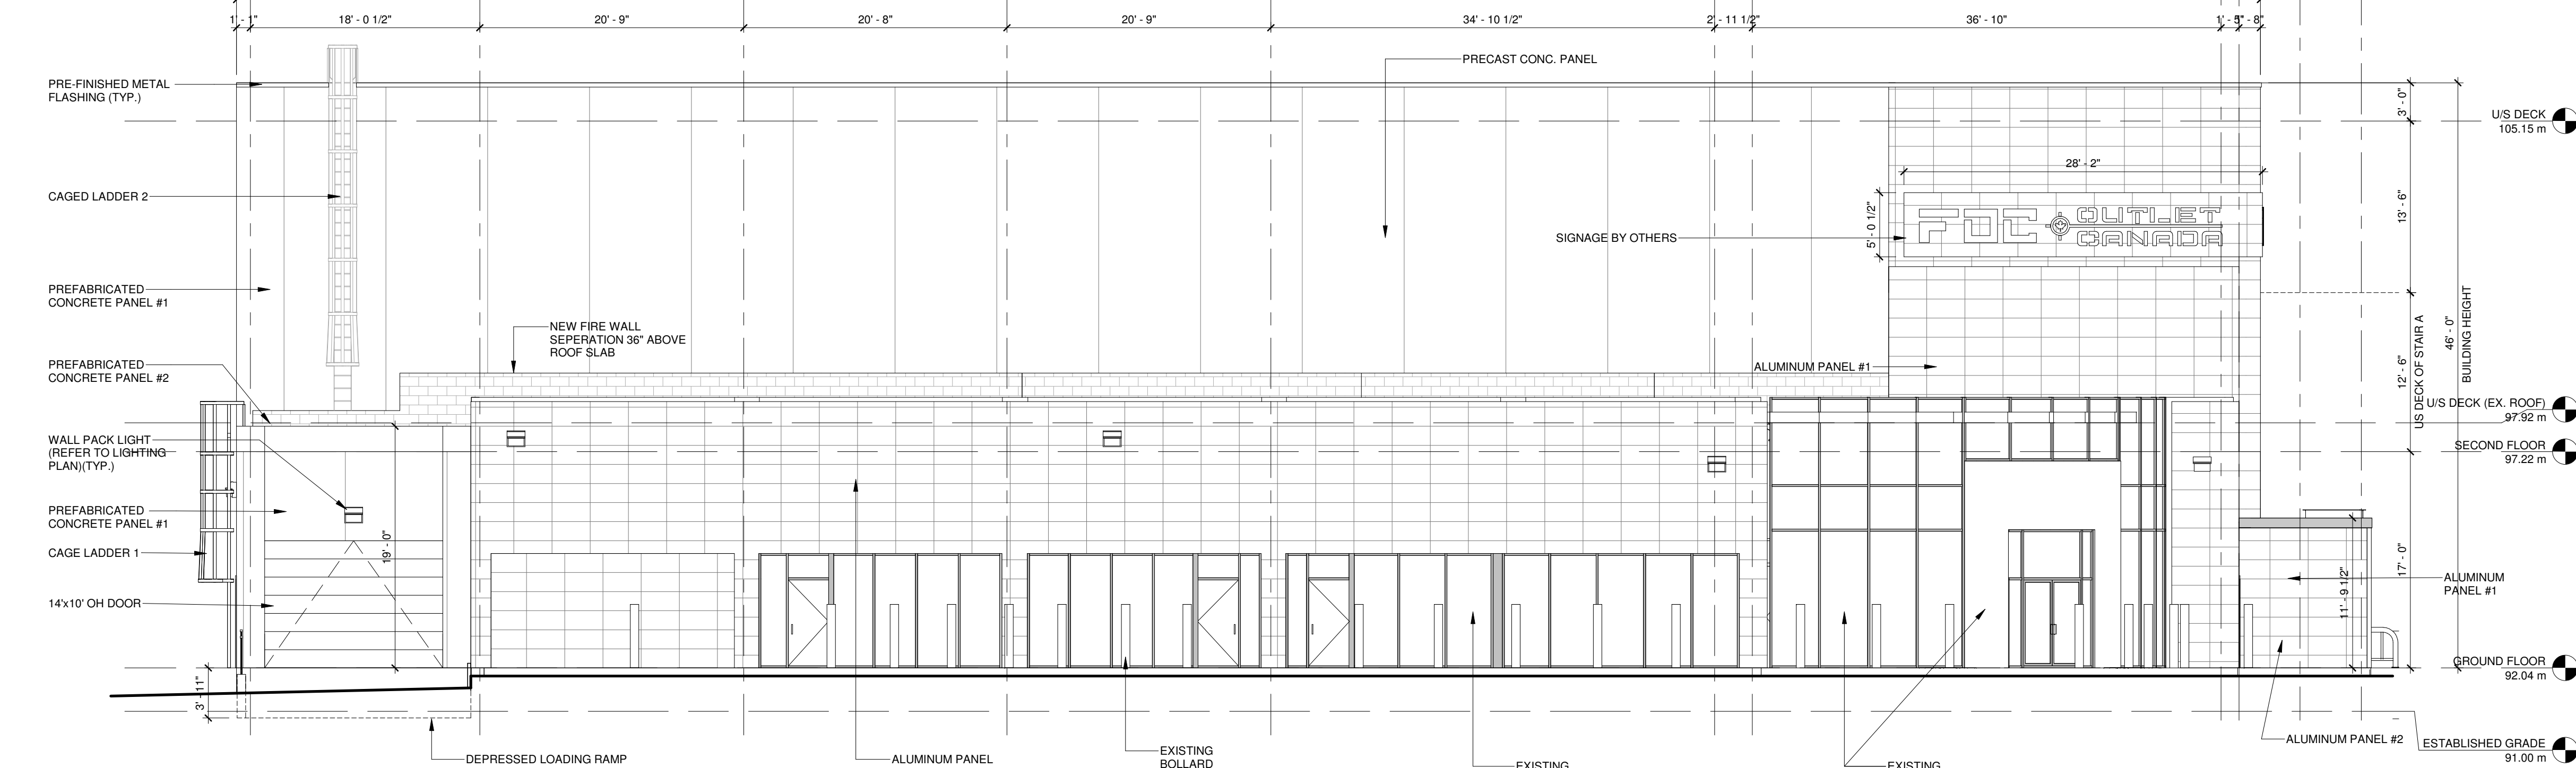

2 SOUTH ELEVATION
1/8" = 1'-0"

EXTERIOR WALL FINISH SCHEDULE			
PRECAST CONCRETE PANEL IN LIGHT GREY PROFORM CONCRETE	ALUMINUM PANEL #1 ALPOLIC ALUMINUM COMPOSITE PANEL OPT MICA PLATINUM	ALUMINUM PANEL #2 ALPOLIC ALUMINUM COMPOSITE PANEL CNC CHARCOAL	ALUMINUM PANEL #3 ALPOLIC ALUMINUM COMPOSITE PANEL TOR RED
* IMAGE FOR REFERENCE ONLY	* IMAGE FOR REFERENCE ONLY	* IMAGE FOR REFERENCE ONLY	* IMAGE FOR REFERENCE ONLY

9	05/28/2025	ISSUED FOR PERMIT	HW
8	03/19/2025	ISSUED FOR SPA	HW
7	01/13/2025	ISSUED FOR REVIEW	HW
6	06/21/2024	ISSUED FOR PRE-CON PHASE II	HW
5	06/17/2024	ISSUED FOR REVIEW	HW
4	12/19/2023	ISSUED FOR REVIEW	HW
3	12/18/2023	ISSUED FOR COORDINATION	HW
2	12/08/2023	ISSUED FOR REVIEW	HW
1	08/10/2023	ISSUED FOR REVIEW	HW
No.	Date:	Issued/Revision:	By

Client:

**FIREARMS
OUTLET CANADA**

W **WANG ARCHITECTS INC.**
3950 14th Ave, Unit 609
Markham, ON L3R 0A9
T: 905-604-6960
E: info@wangarchitects.ca
www.wangarchitects.ca



Project :

FIREARMS OUTLET CANADA

725 WESTNEY RD. S.,
AJAX, ON L1S 7J7


Drawing Name :

BUILDING ELEVATIONS


Scale : As indicated Project No : 00026

Drawn by : ZC Drawing No :

Checked by : HW A3.2

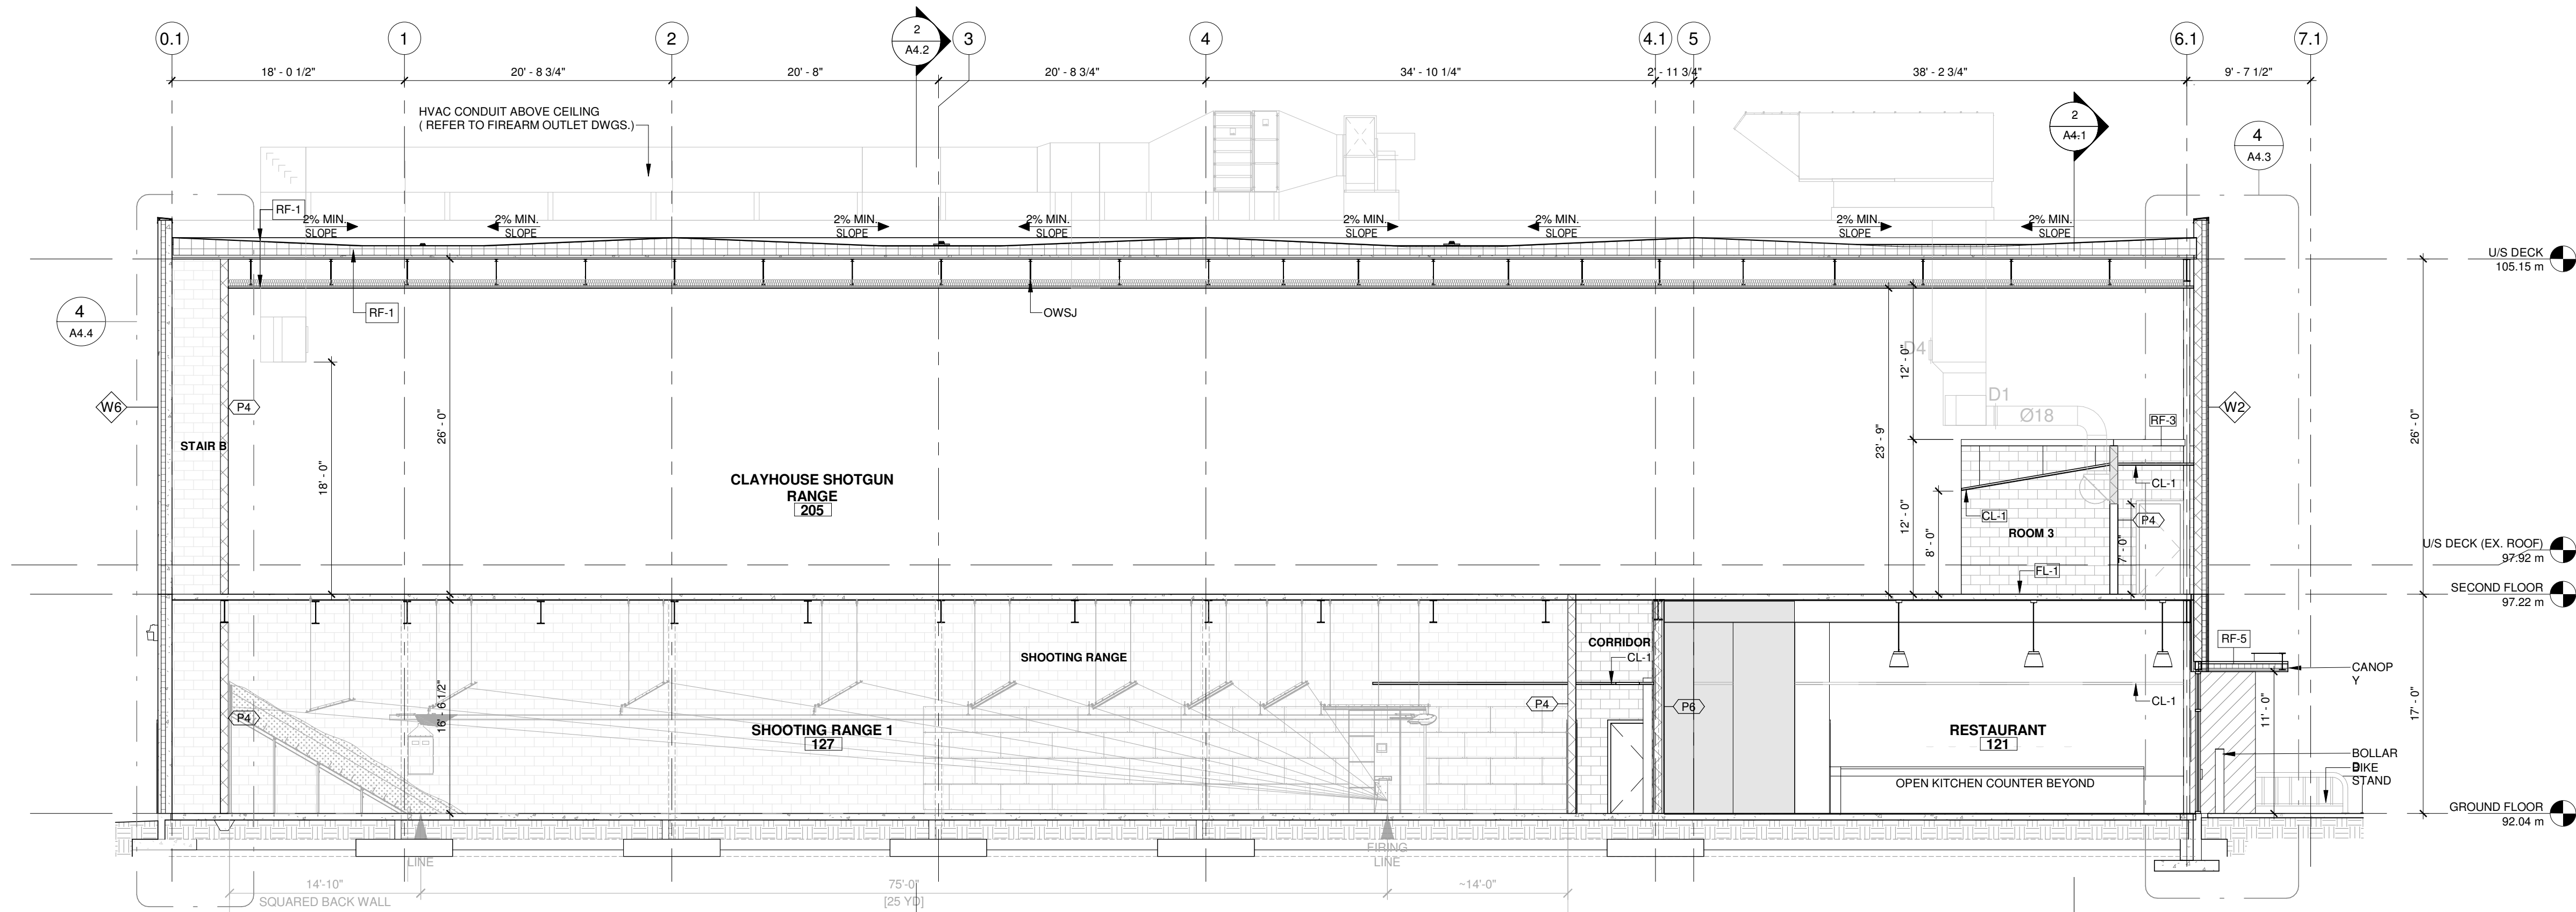

1 BUILDING SECTION 1
1/8" = 1'-0"

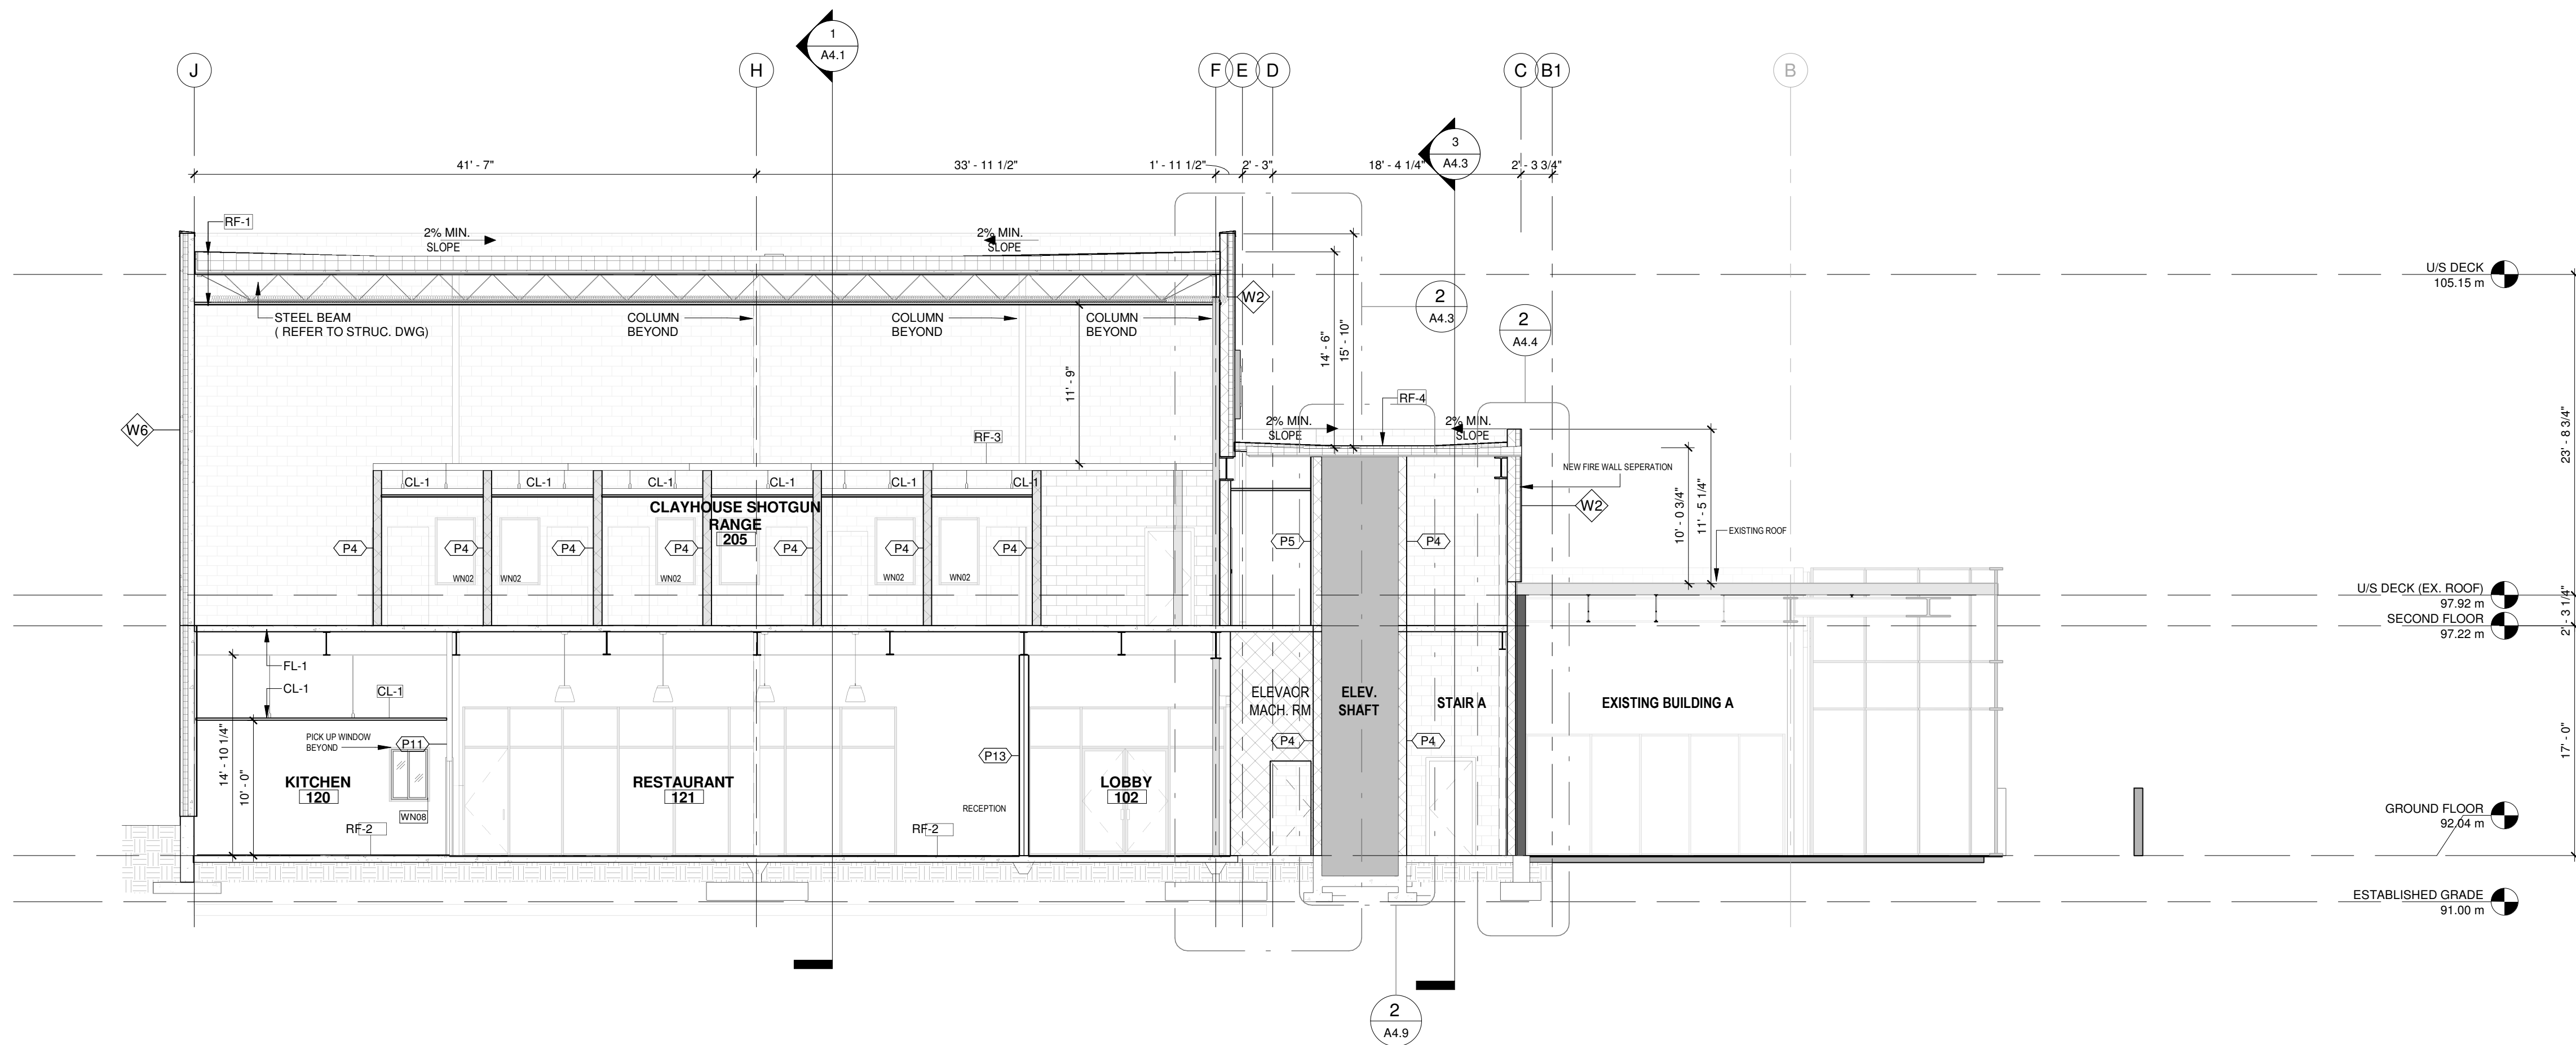

2 BUILDING SECTION 2
1/8" = 1'-0"

5	05/28/2025	ISSUED FOR PERMIT	HW
4	03/19/2025	ISSUED FOR SPA	HW
3	06/21/2024	ISSUED FOR PRE-CON PHASE II	HW
2	06/17/2024	ISSUED FOR REVIEW	HW
1	12/19/2023	ISSUED FOR REVIEW	HW
No.	Date:	Issued/Revision:	By

Client:

FIREARMS
OUTLET CANADA

W **WANG ARCHITECTS INC.**
3950 14th Ave, Unit 609
Markham, ON L3R 0A9
T: 905-604-6960
E: info@wangarchitects.ca
www.wangarchitects.ca



Project:

FIREARMS OUTLET CANADA

725 WESTNEY RD. S.,
AJAX, ON L1S 7J7

Drawing Name:


BUILDING SECTIONS

Scale: 1/8" = 1'-0" Project No: 00026


Drawn by: JW Drawing No:

Checked by: HW

A4.1

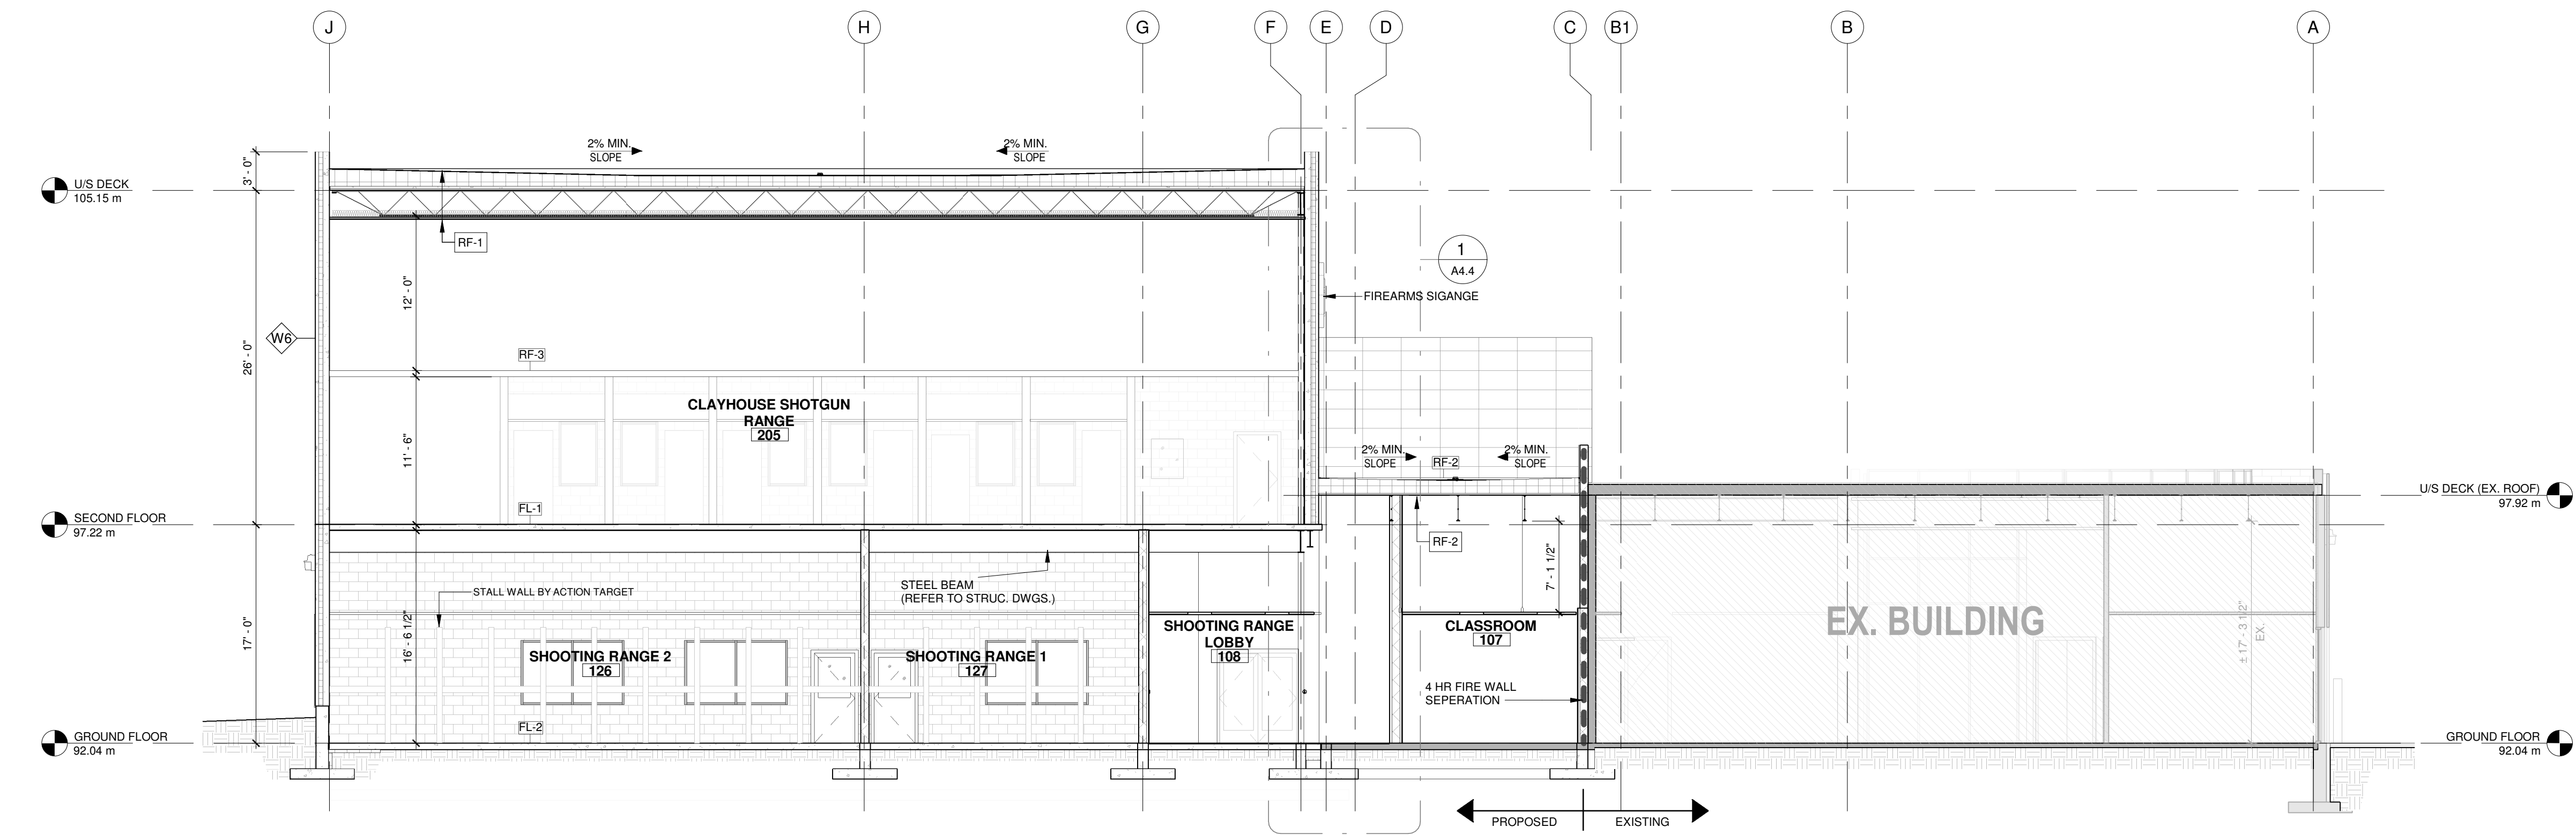

1 BUILDING SECTION 3
1/8" = 1'-0"

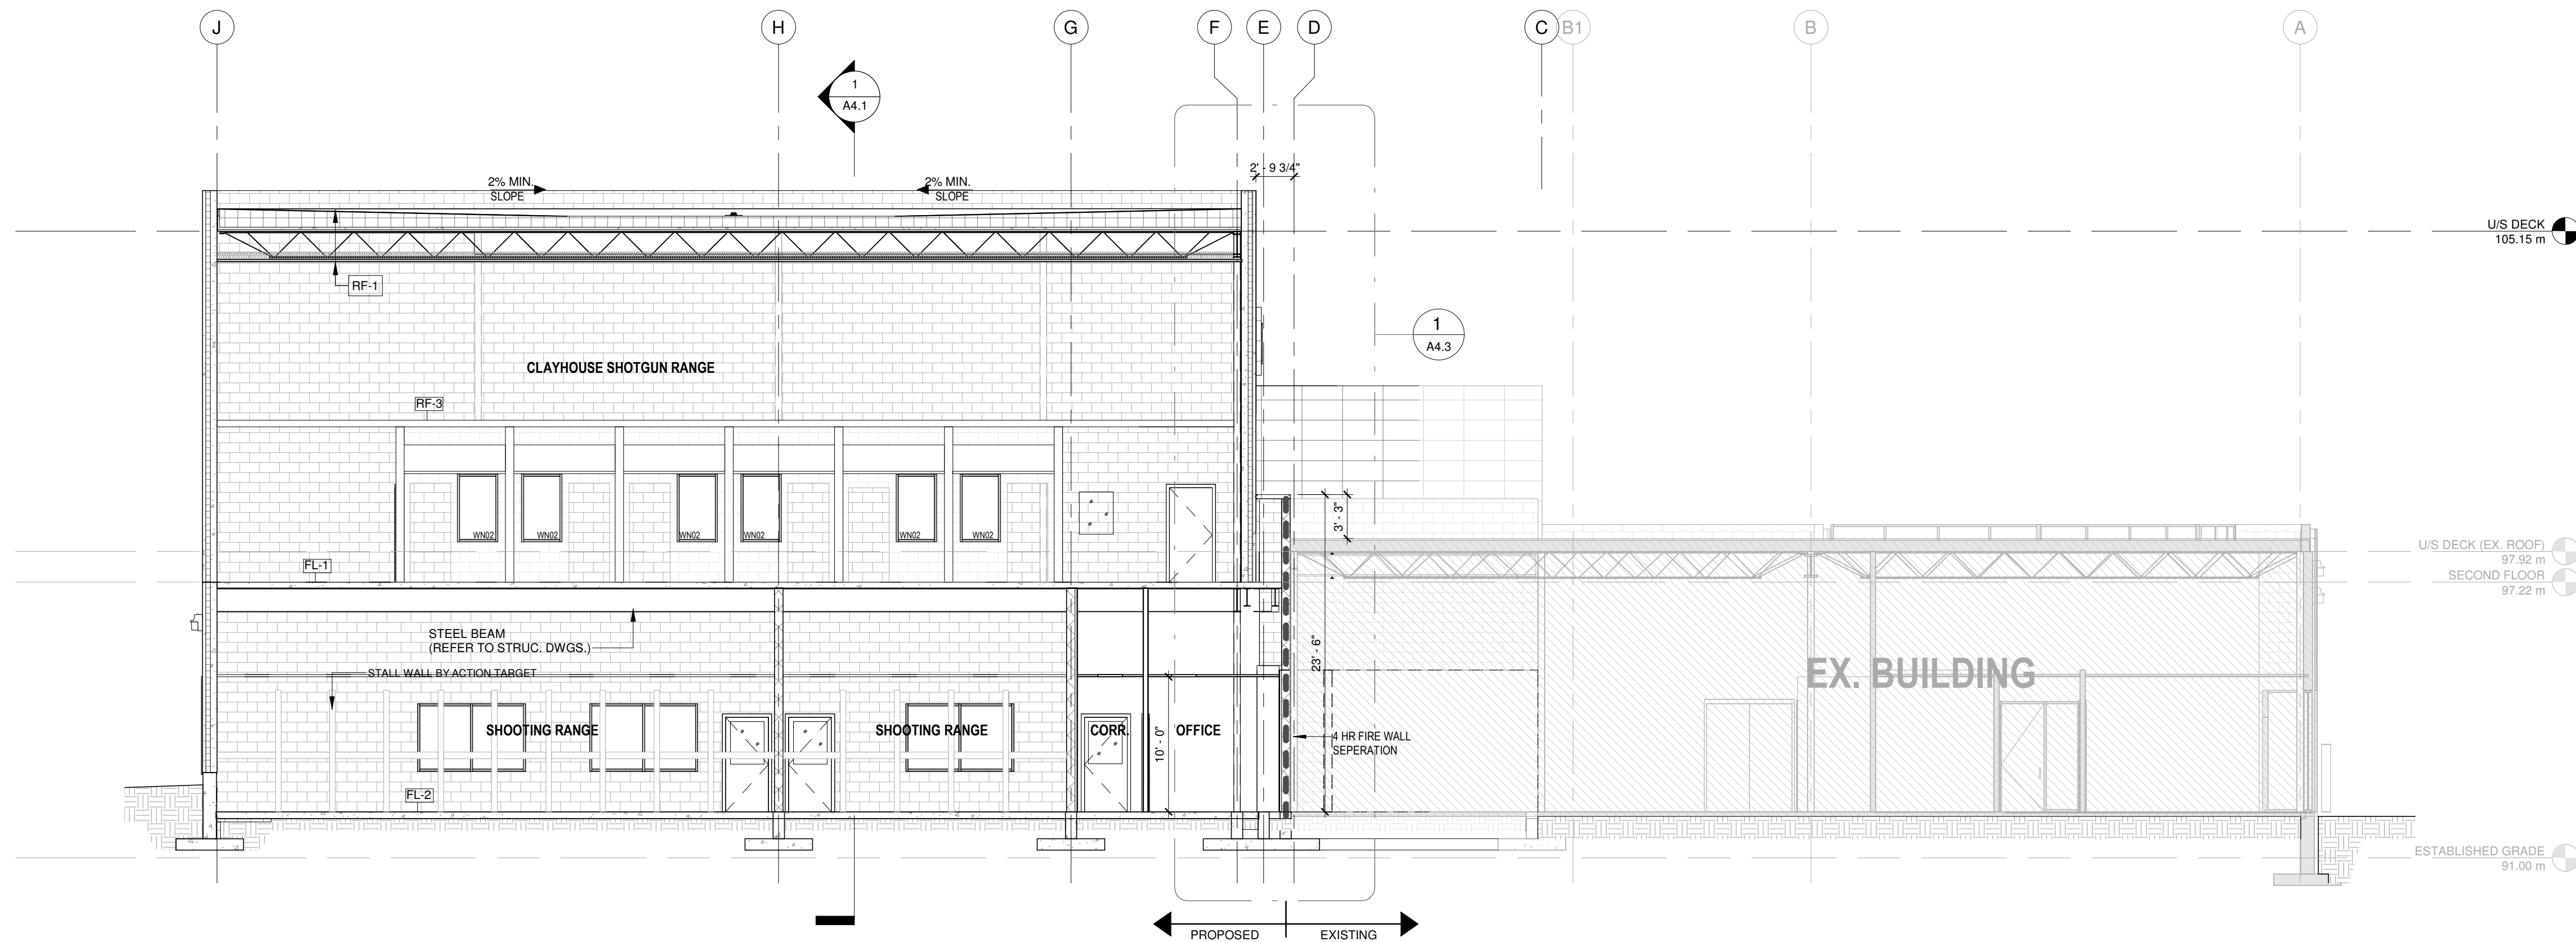


2 BUILDING SECTION 4
1/8" = 1'-0"

4	05/28/2025	ISSUED FOR PERMIT	HW
3	04/21/2024	ISSUED FOR PRE-CON PHASE II	HW
2	06/17/2024	ISSUED FOR REVIEW	HW
1	12/19/2023	ISSUED FOR REVIEW	HW
No.	Date:	Issued/Revision:	By

Client:

**FIREARMS
OUTLET CANADA**

W **WANG ARCHITECTS INC.**
3950 14th Ave, Unit 609
Markham, ON L3R 0A9
T: 905-604-6960
E: info@wangarchitects.ca
www.wangarchitects.ca

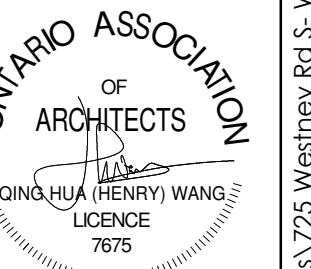

Project :
FIREARMS OUTLET CANADA

725 WESTNEY RD. S.,
AJAX, ON L1S 7J7





Drawing Name :
BUILDING SECTIONS

Scale : 1/8" = 1'-0" Project No : 00026

Drawn by : JW Drawing No :

Checked by : HW

A4.2

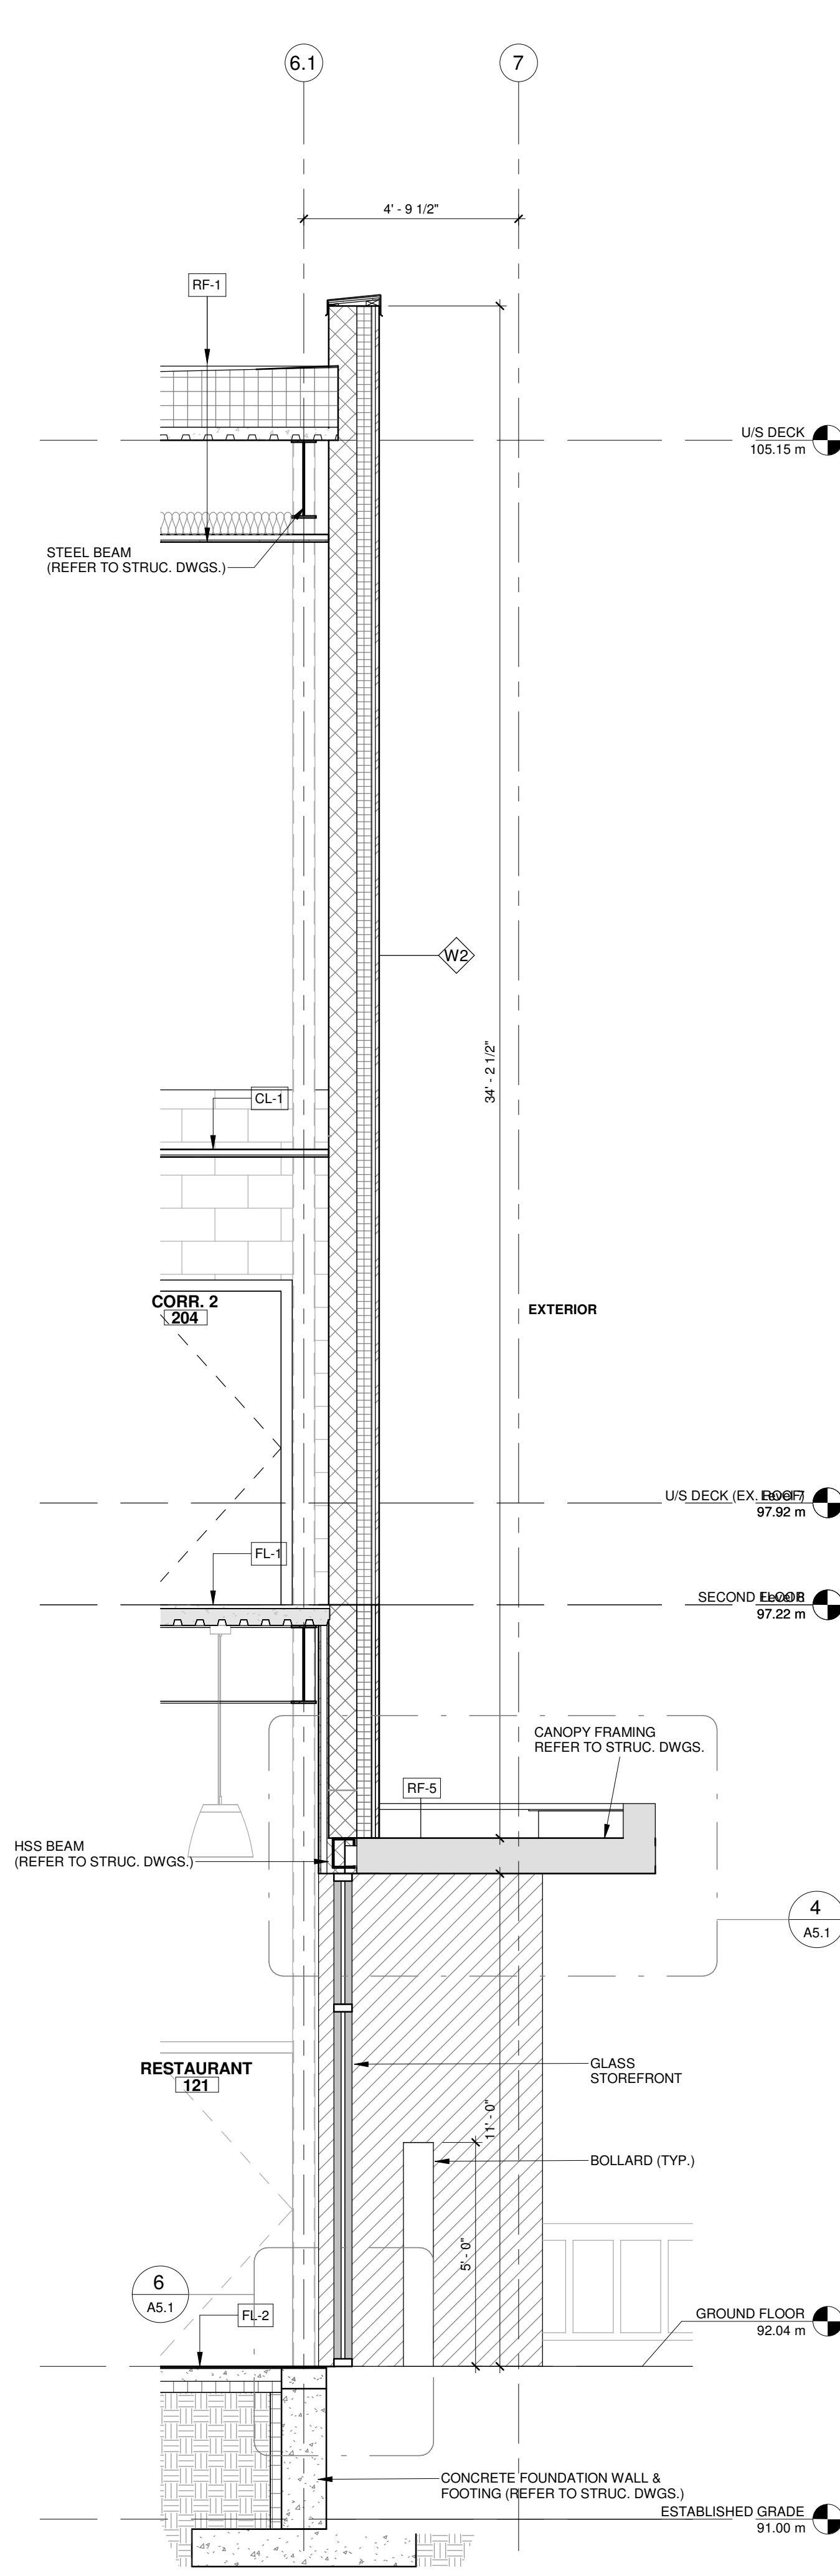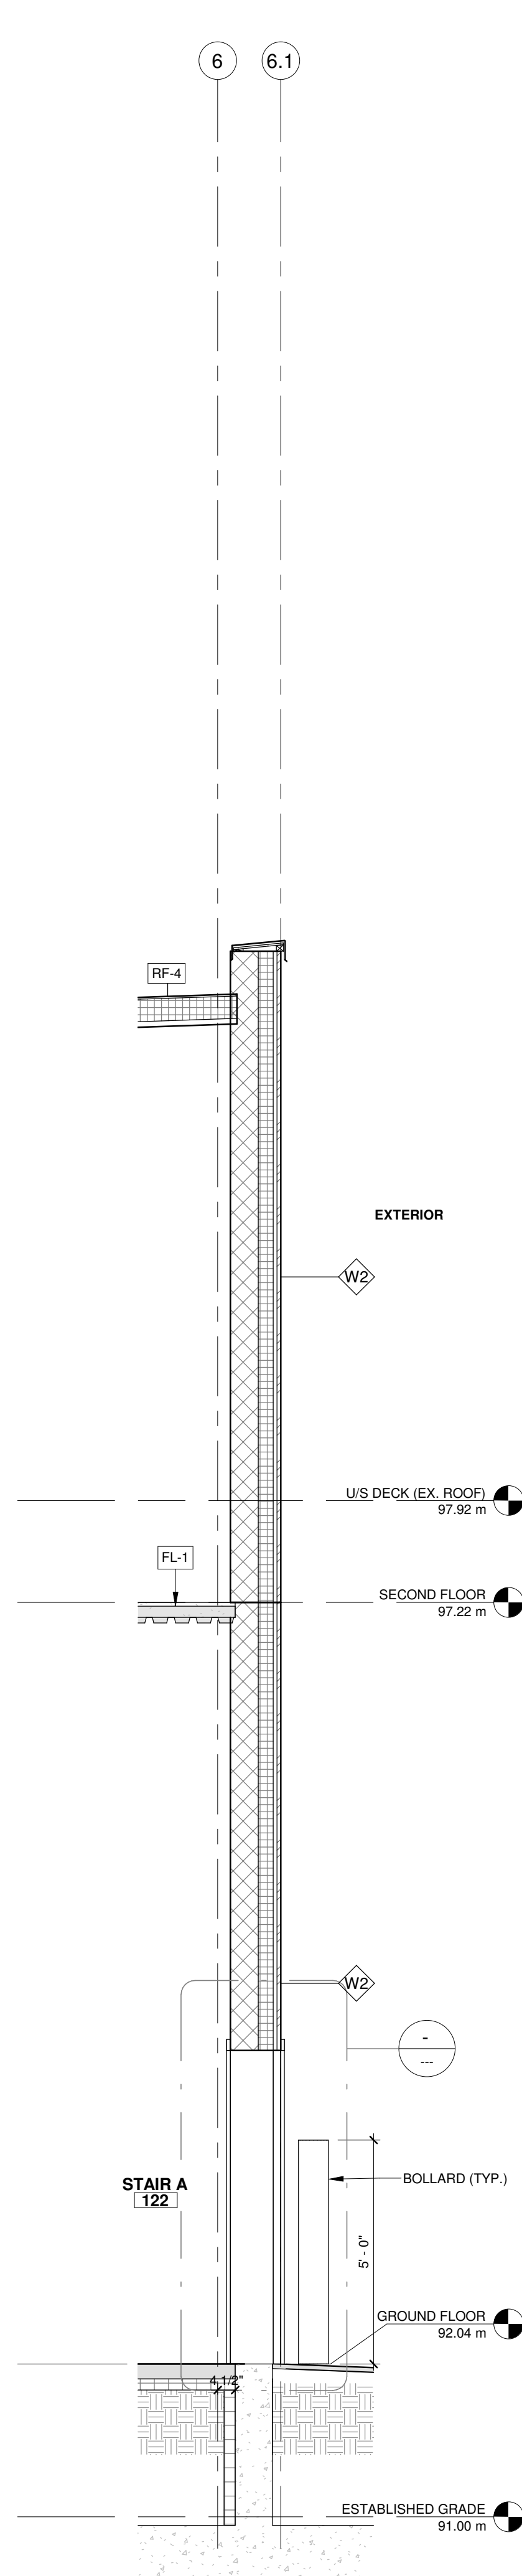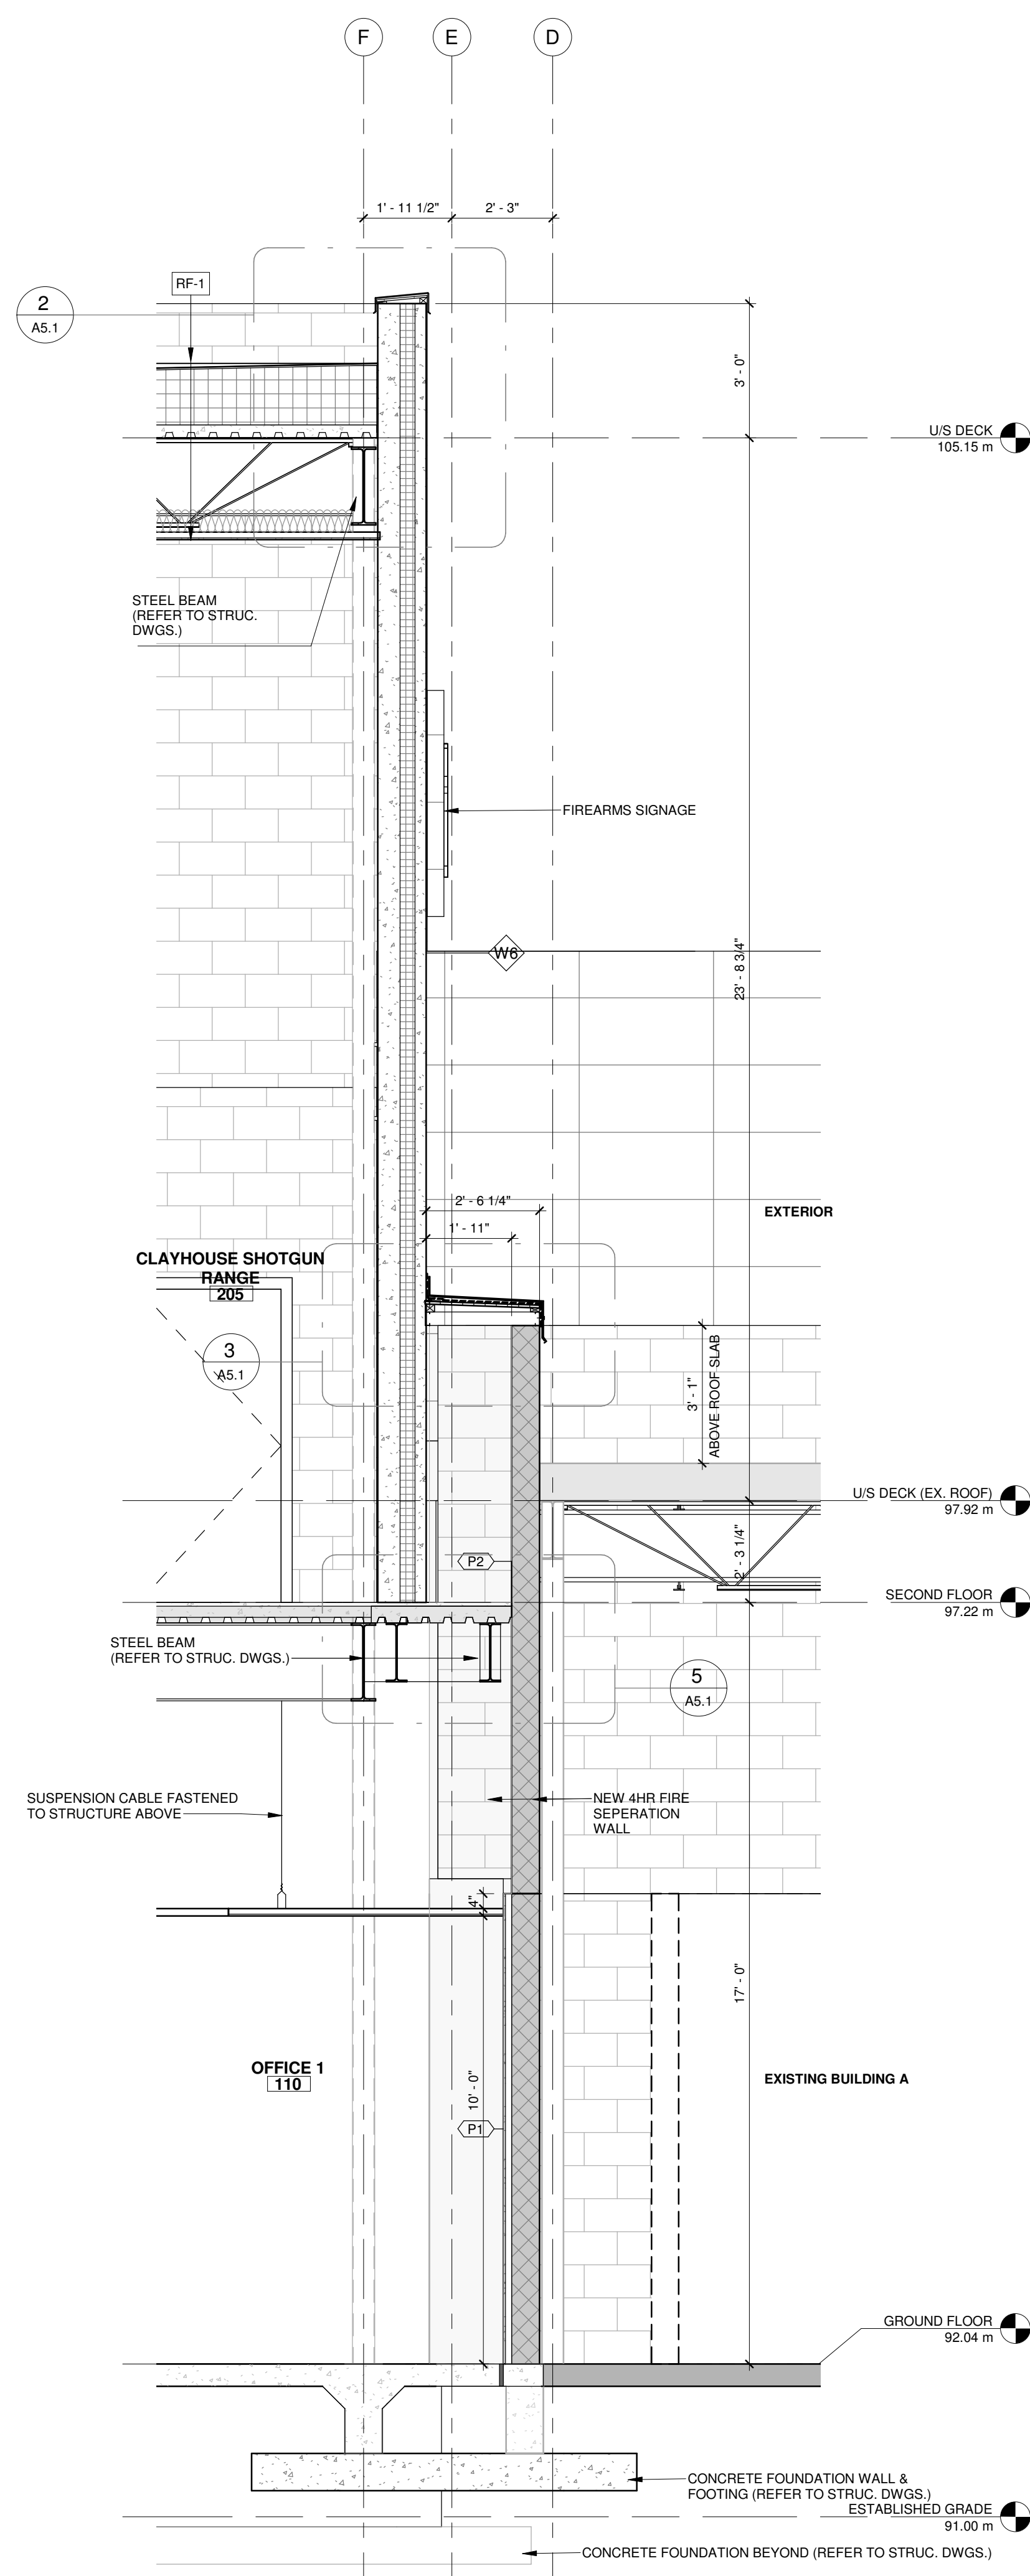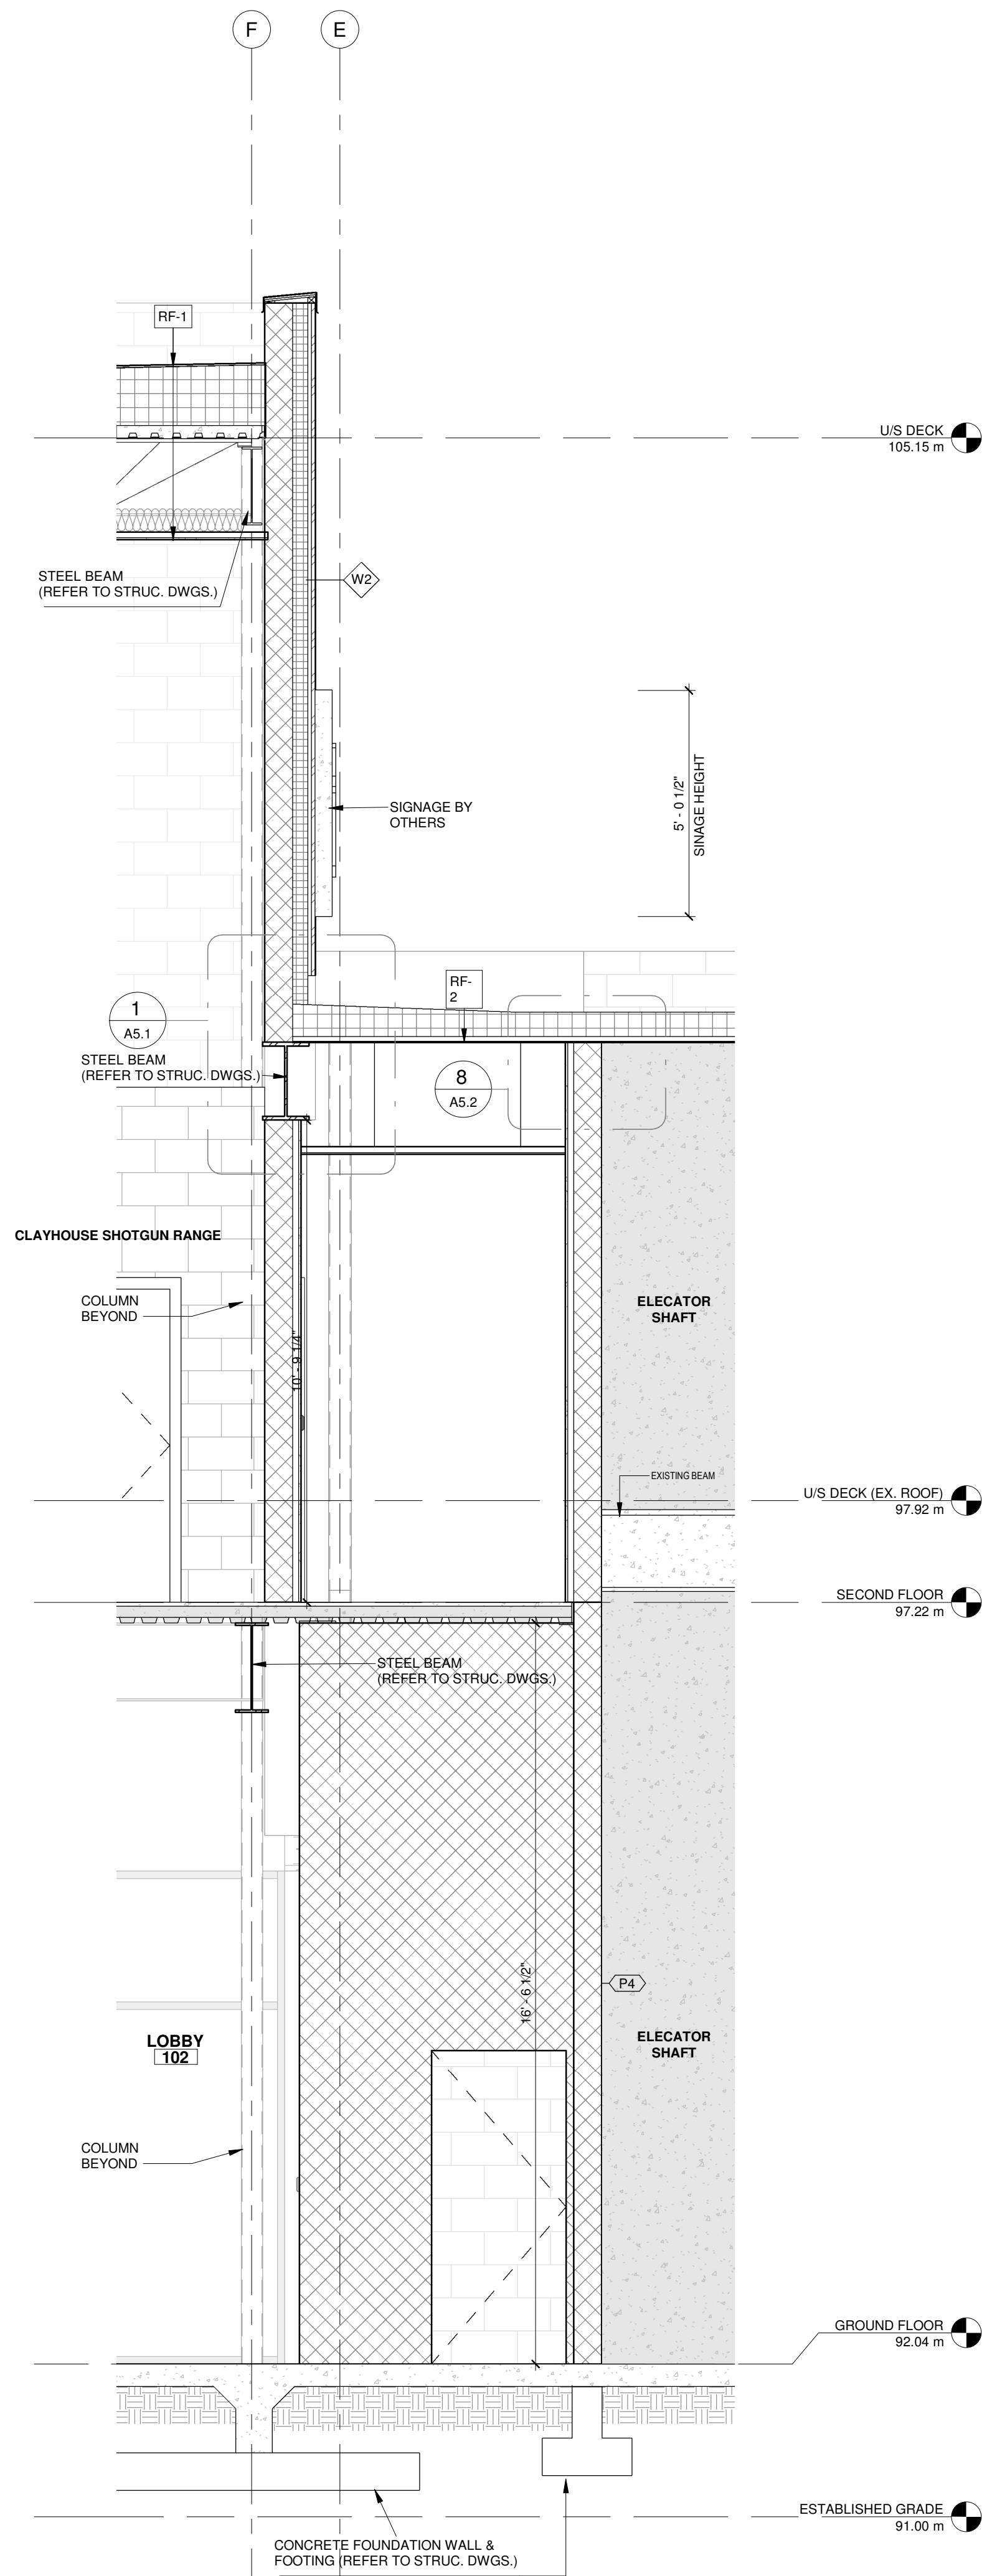





2 WALL SECTION 1
3/8" = 1'-0"

1 WALL SECTION 2
3/8" = 1'-0"

3 WALL SECTION 3
3/8" = 1'-0"

4 WALL SECTION 4
3/8" = 1'-0"

1	05/28/2025	ISSUED FOR PERMIT	HW
No.	Date:	Issued/Revision:	By
Client:			
FIREARMS OUTLET CANADA			
WANG ARCHITECTS INC. 3950 14th Ave, Unit 609 Markham, ON L3R 0A9 T: 905-604-6960 E: info@wangarchitects.ca www.wangarchitects.ca			
ONTARIO ASSOCIATION OF ARCHITECTS QING HUA (HENRY) WANG LICENCE 7675			
Project : FIREARMS OUTLET CANADA 725 WESTNEY RD. S., AJAX, ON L1S 7J7			
Drawing Name : WALL SECTION			
Scale : 3/8" = 1'-0"		Project No : 00026	
Drawn by : JW		Drawing No :	
Checked by : HW		A4.3	

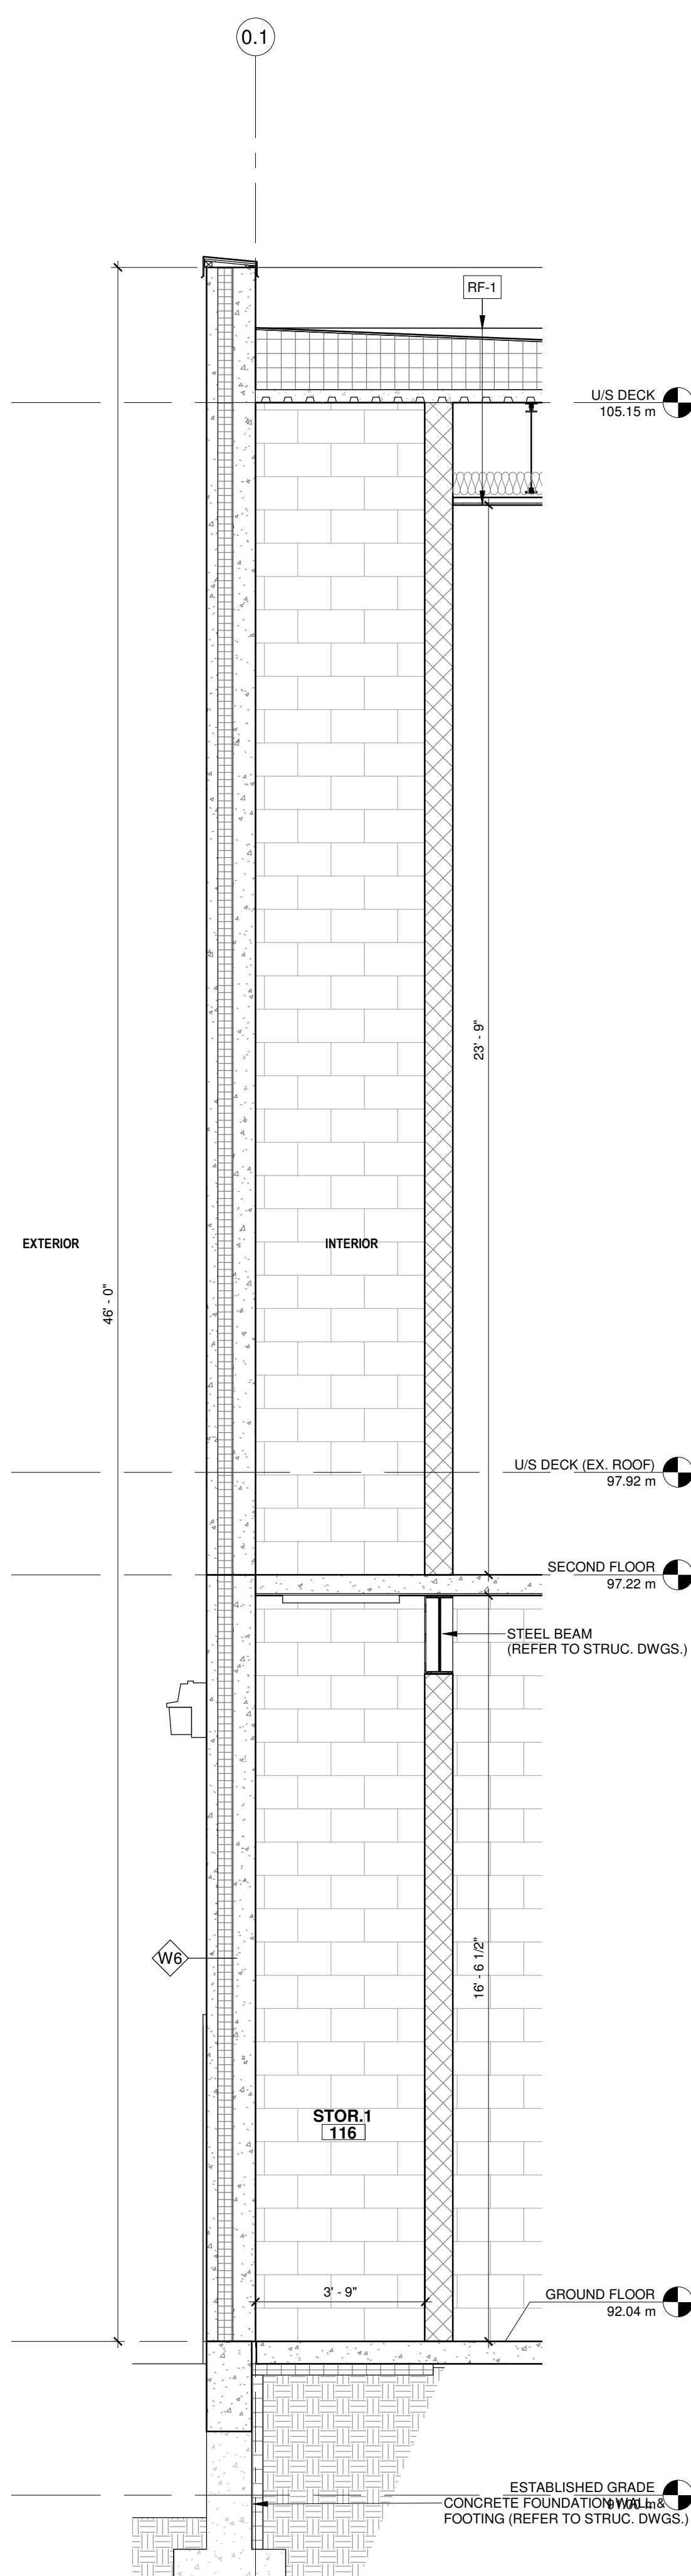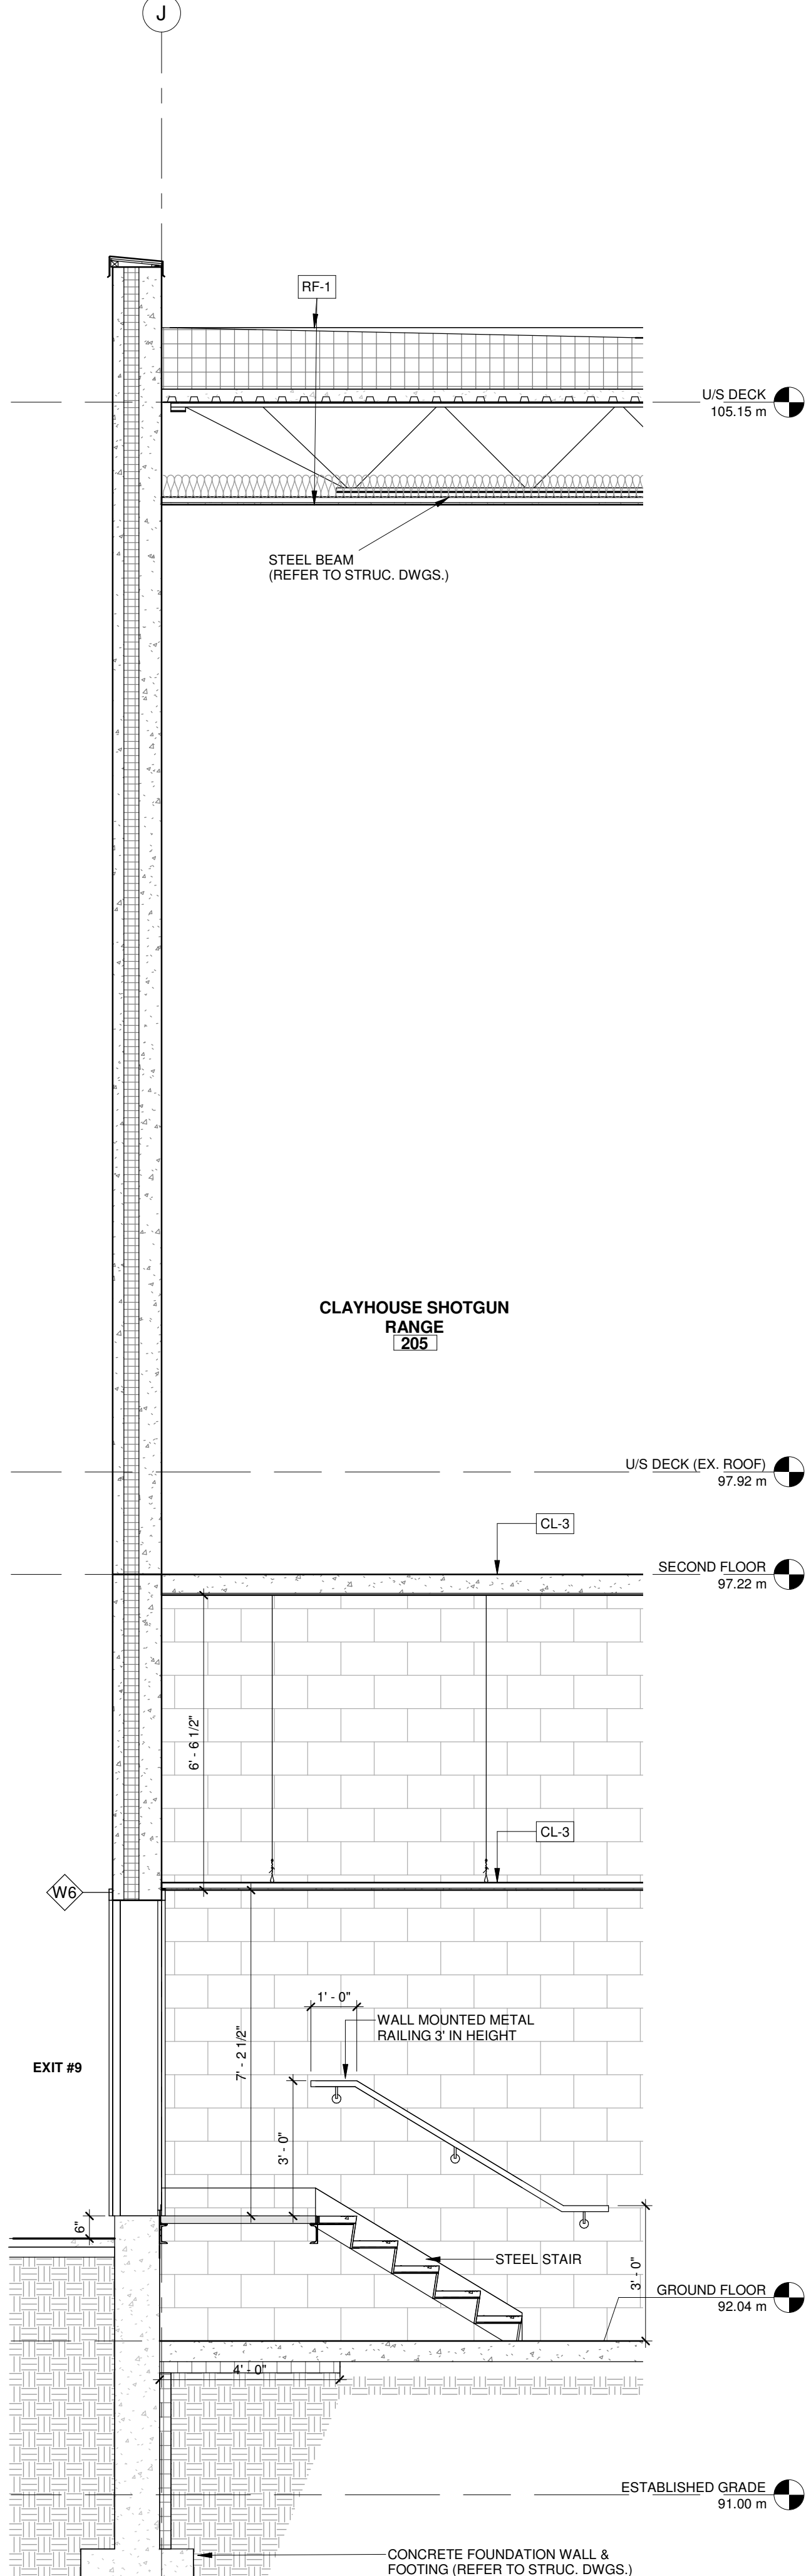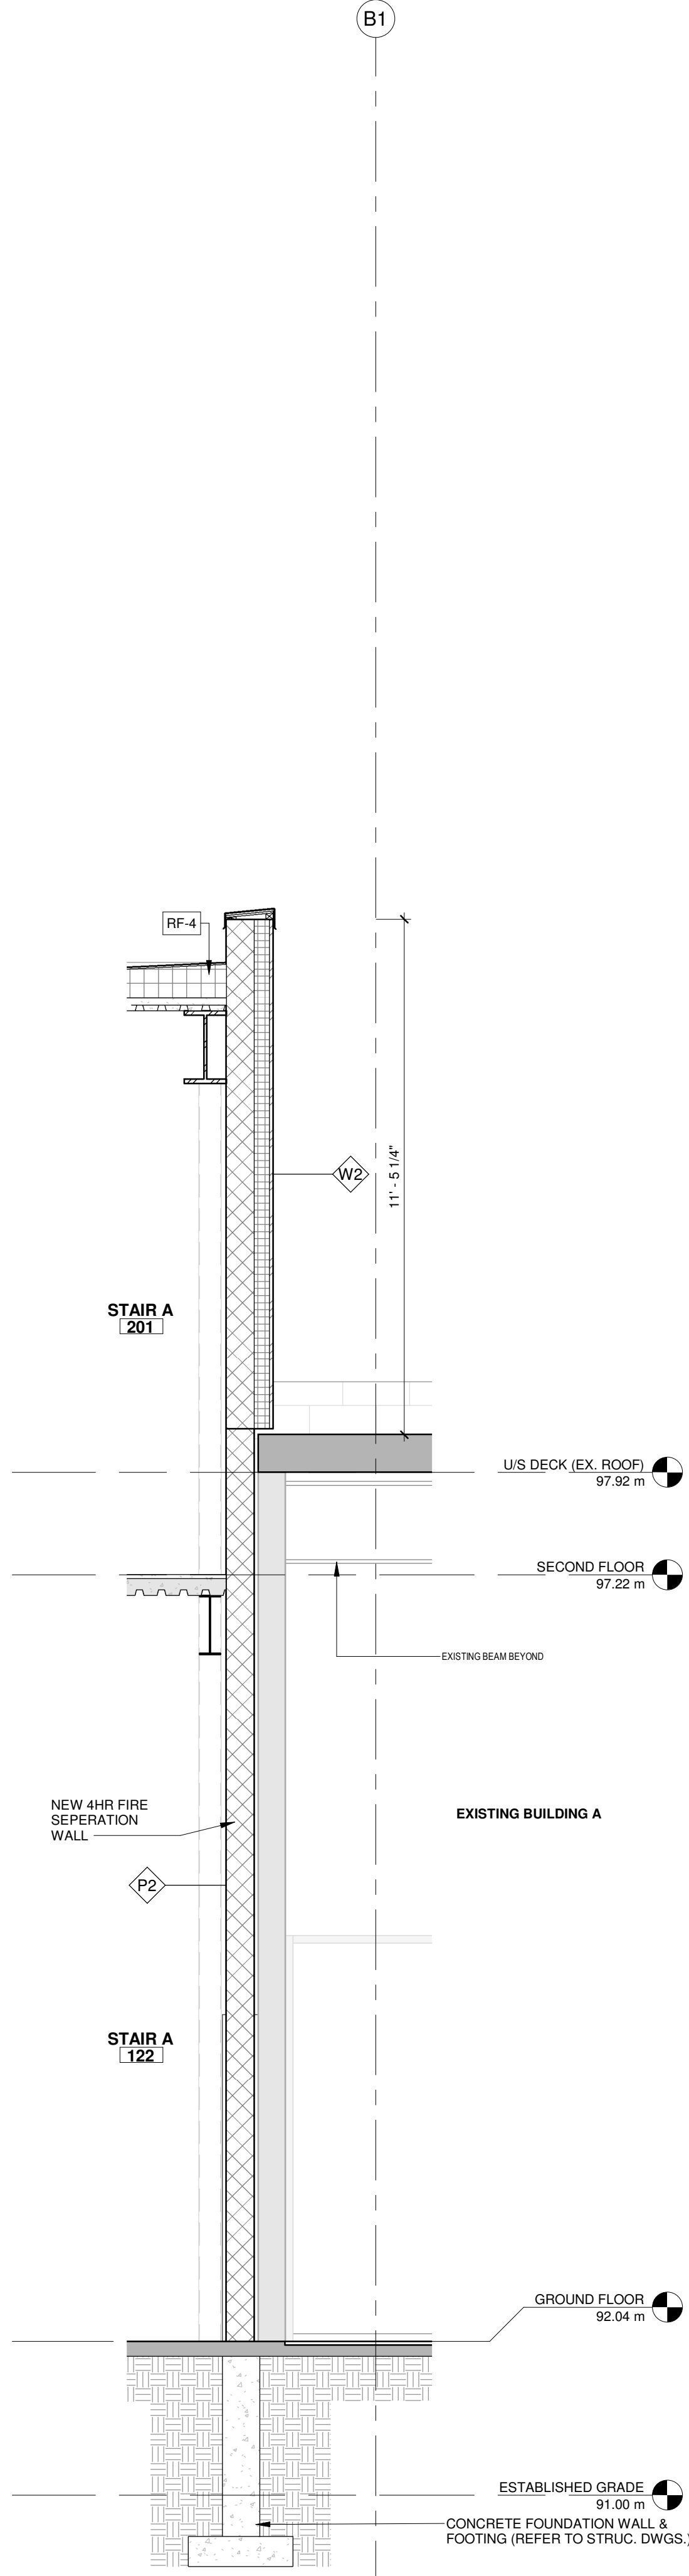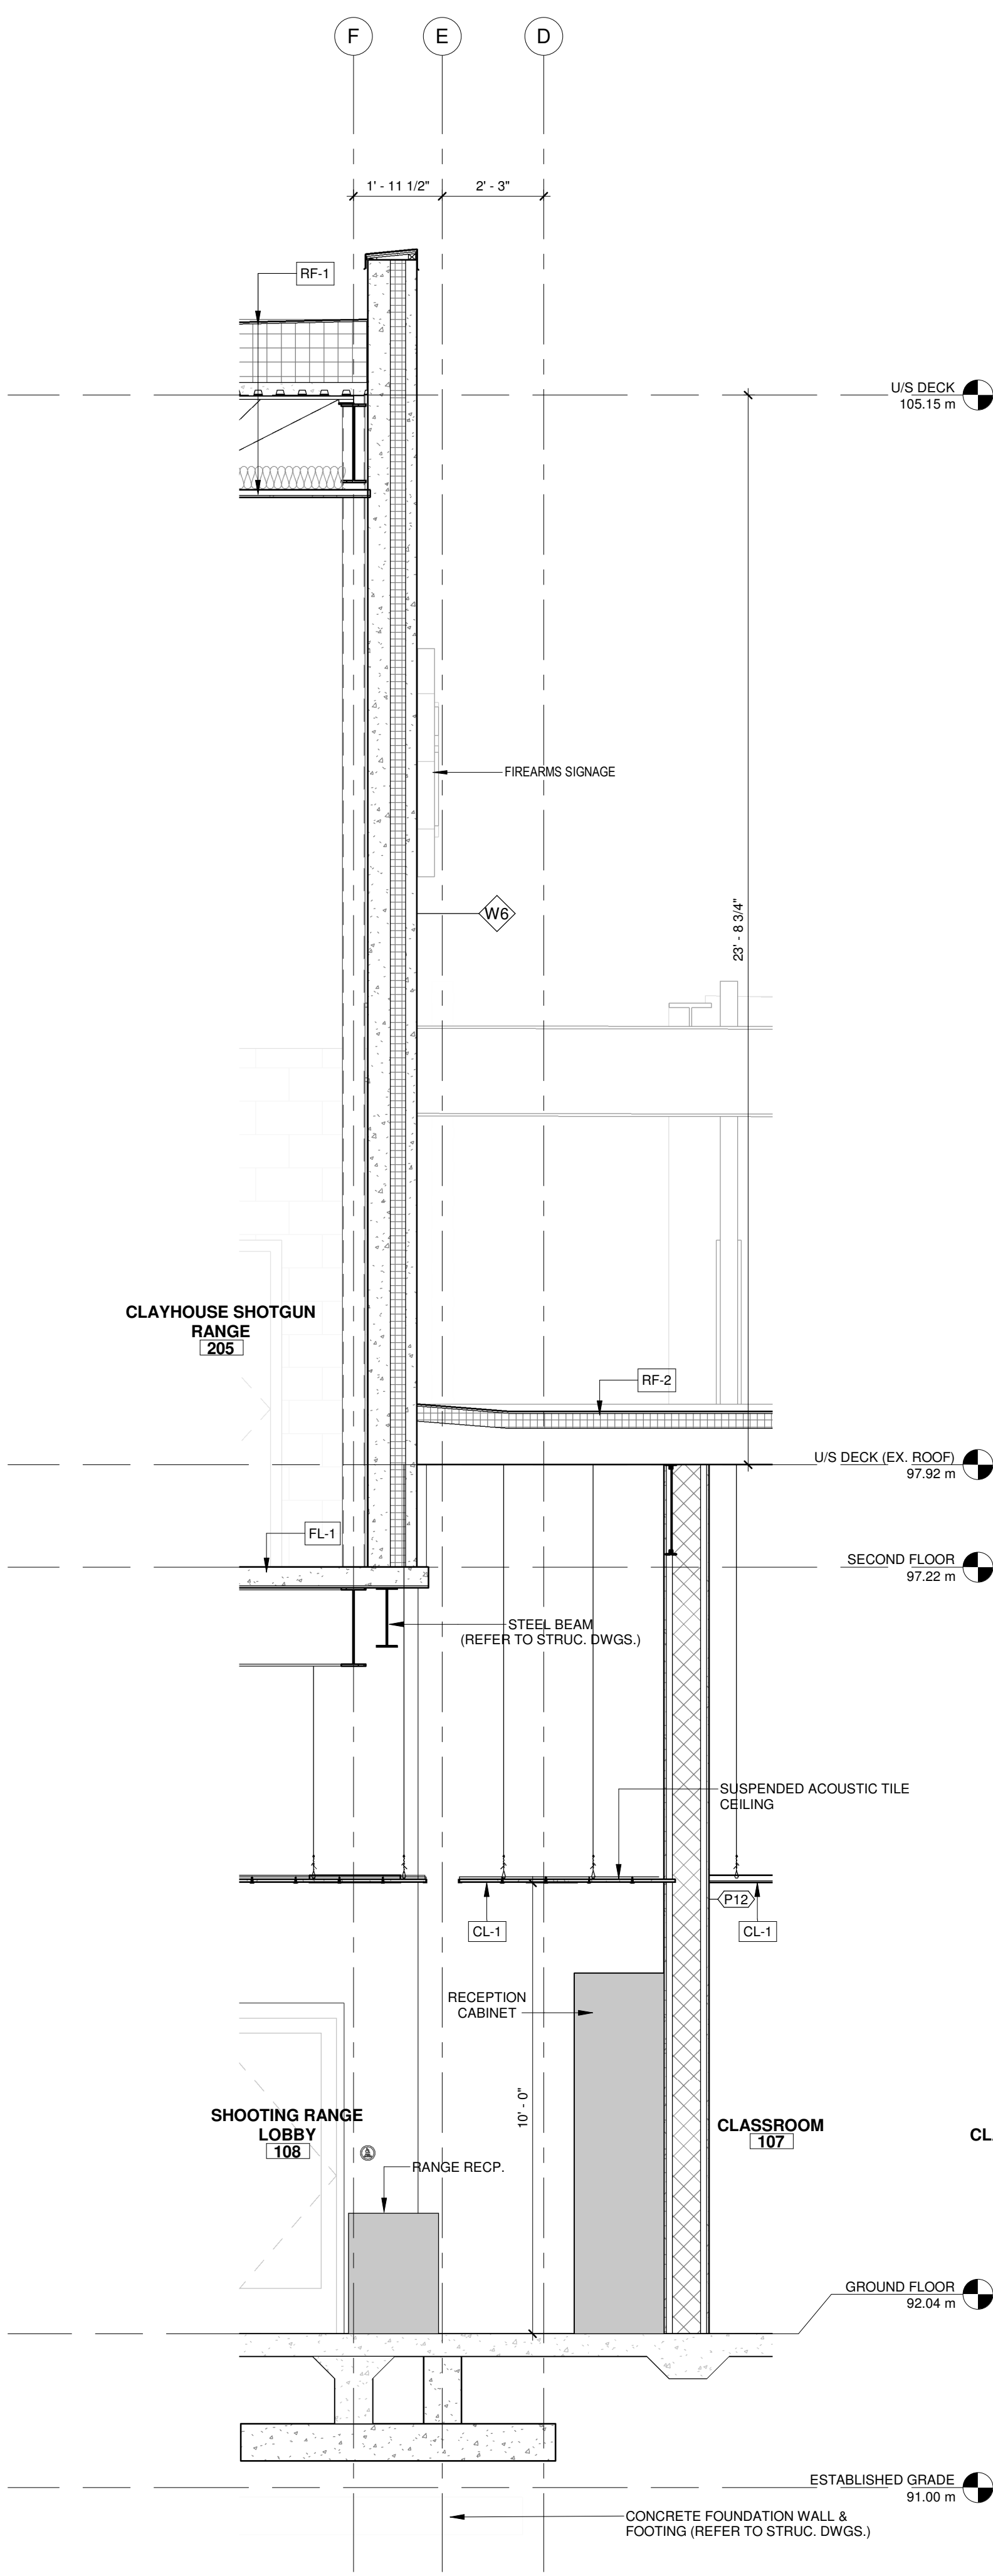

1 BUILDING SECTION 5
3/8" = 1'-0"

2 BUILDING SECTION 6
3/8" = 1'-0"

3 BUILDING SECTION 7
3/8" = 1'-0"

4 BUILDING SECTION 8
3/8" = 1'-0"

1	05/28/2025	ISSUED FOR PERMIT	HW
No.	Date:	Issued/Revision:	By

Client:

**FIREARMS
OUTLET CANADA**

W **WANG ARCHITECTS INC.**
3950 14th Ave, Unit 609
Markham, ON L3R 0A9
T: 905-604-6960
E: info@wangarchitects.ca
www.wangarchitects.ca



Project :

FIREARMS OUTLET CANADA

725 WESTNEY RD. S.,
AJAX, ON L1S 7J7

Drawing Name :

WALL SECTION

Scale : 3/8" = 1'-0" Project No : 00026



Drawn by : JW Drawing No :

Checked by : HW

A4.4

DOOR SCHEDULE																				
Mark	ROOM NAME	Door Type	Width	Height	Door Material	Door Finish	Glazing	Frame Material	Frame Finish	FIRE RATING	Latch	Lock	Self Closure	Exit Device	Privacy Lock	Door Stop	Weather Stripping	Kick Plates	Signage	REMARK
DR101	ENTRANCE	A	6'-4"	7'-9"	ALUM. FRAMED GLASS	CLEAR ANOD.	TSGL	ALUM.	CLEAR ANOD.		•	•	•			•				
DR102	VESTIBULE	A	6'-4"	7'-9"	ALUM. FRAMED GLASS	CLEAR ANOD.	TSGL	ALUM.	CLEAR ANOD.		•	•	•							
DR103	ELEVATOR MACHINE ROOM	C	3'-0"	7'-0"	HM	PT		PS	PT	45 MINS	•	•	•			•				REFER TO O.B.C. 3.8.3.12
DR104	UNIVERSAL WASHROOM	C	3'-0"	7'-0"	HM	PT		PS	PT		•	•	•		•					
DR105	WOMENS WASHROOM	C	3'-0"	7'-0"	HM	PT		PS	PT		•	•	•		•					
DR106	MENS WASHROOM	C	3'-0"	7'-0"	HM	PT		PS	PT		•	•	•		•					
DR107	SHOOTING RANGE ENTRANCE	A	6'-0"	7'-0"	ALUM. FRAMED GLASS	CLEAR ANOD.	TSGL	ALUM.	CLEAR ANOD.		•	•	•		•					
DR108	GUN LOCKER	D	3'-2"	7'-0"	HM	PT	•	PS	PT		•	•	•		•					
DR109	OFFICE 1	C	3'-2"	7'-0"	HM	PT		PS	PT		•	•	•		•					
DR110	OFFICE 2	C	3'-2"	7'-0"	HM	PT		PS	PT		•	•	•		•					
DR111	SERVICE CORRIDOR	D	3'-2"	7'-0"	HM	PT	•	PS	PT		•	•	•		•					
DR112	SERVICE CORRIDOR	C	3'-6"	7'-0"	HM	PT		PS	PT	3HR	•	•	•		•					
DR113	OFFICE 3	C	3'-2"	7'-0"	HM	PT		PS	PT		•	•	•		•					
DR114	ELECTRICAL ROOM	C	3'-6"	7'-0"	HM	PT		PS	PT	45 MINS	•	•	•		•					
DR115	MECHANICAL ROOM	C	3'-6"	7'-0"	HM	PT		PS	PT	45MINS	•	•	•		•					
DR116	STORAGE 1	C	3'-0"	7'-0"	HM	PT		PS	PT		•	•	•		•					
DR117	MECH. EXIT DOOR	C	3'-6"	7'-0"	INSUL. HM	PT		INSUL. PS	PT	1.5HR	•	•	•		•					
DR118	EXIT DOOR	C	3'-2"	7'-0"	INSUL. HM	PT		INSUL. PS	PT	1.5HR	•	•	•		•					acoustic door seals along the bottom
DR119	SHOOTING RANGE CORRIDOR	D	3'-2"	7'-0"	HM	PT	TSGL	PS	PT		•	•	•		•					
DR120	SHOOTING RANGE	D	3'-2"	7'-0"	HM	PT	TSGL	PS	PT		•	•	•		•					
DR121	SHOOTING RANGE	D	3'-2"	7'-0"	HM	PT	TSGL	PS	PT		•	•	•		•					
DR122	EXIT DOOR	C	3'-2"	7'-0"	INSUL. HM	PT		INSUL. PS	PT	1.5HR	•	•	•		•					acoustic door seals along the bottom
DR123	STAFF WASHROOM	C	2'-8"	7'-0"	HM	PT		PS	PT		•	•	•		•					
DR124	DOOR NEXT TO PICKUP WINDOW	B	3'-2"	7'-9"	ALUM	CLEAR ANOD.	TSGL	ALUM.	CLEAR ANOD.		•	•	•		•					
DR125	EXIT DOOR 6	C	3'-2"	7'-0"	INSUL. HM	PT		PS	PT		•	•	•		•					
DR126	STAIR A EXIT	C	3'-2"	7'-0"	HM	PT		PS	PT	3HR	•	•	•		•					
DR127	STAIR A INT.	C	3'-2"	7'-0"	HM	PT		PS	PT	45 MINS	•	•	•		•					
DR128	CLASSROOM	D	3'-2"	7'-0"	HM	PT	TSGL	PS	PT		•	•	•		•					
DR129	KITCHEN STORAGE	C	3'-0"	7'-0"	HM	PT		PS	PT		•	•	•		•					
DR130	STAIR C VESTIBULE	C	3'-2"	7'-0"	INSUL. HM	PT		INSUL. PS	PT	45 MINS	•	•	•		•					acoustic door seals along the bottom
DR131	STORAGE	C	3'-2"	7'-0"	HM	PT		PS	PT		•	•	•		•					
DR132	STORAGE	C	3'-2"	7'-0"	HM	PT		PS	PT		•	•	•		•					
DR133	GARBAGE ROOM		16'-0"	7'-0"																Roll-up door powered
DR134	EXIT 11	C	3'-2"	7'-0"	INSUL. HM	PF		INSUL. PS	PT	1.5HR	•	•	•		•					
DR201	STAIR A	C	3'-0"	7'-0"	HM	PT		PS	PT	45 MINS	•	•	•		•					
DR202	STORAGE	C	3'-0"	7'-0"	HM	PT		PS	PT		•	•	•		•					
DR203	LOBBY 2	D	3'-2"	7'-0"	HM	PT	TSGL	PS	PT		•	•	•		•					
DR204	CORR. 2	D	3'-2"	7'-0"	HM	PT	TSGL	PS	PT		•	•	•		•					
DR205	CORR. 2	D	3'-2"	7'-0"	HM	PT	TSGL	PS	PT		•	•	•		•					
DR206	STAIR B	C	3'-0"	7'-0"	INSUL. HM	PT		INSUL. PS	PT	45 MINS	•	•	•		•					acoustic door seals along the bottom
DR207	STORAGE	C	3'-0"	7'-0"	HM	PT		PS	PT		•	•	•		•					

JAMB DETAILS

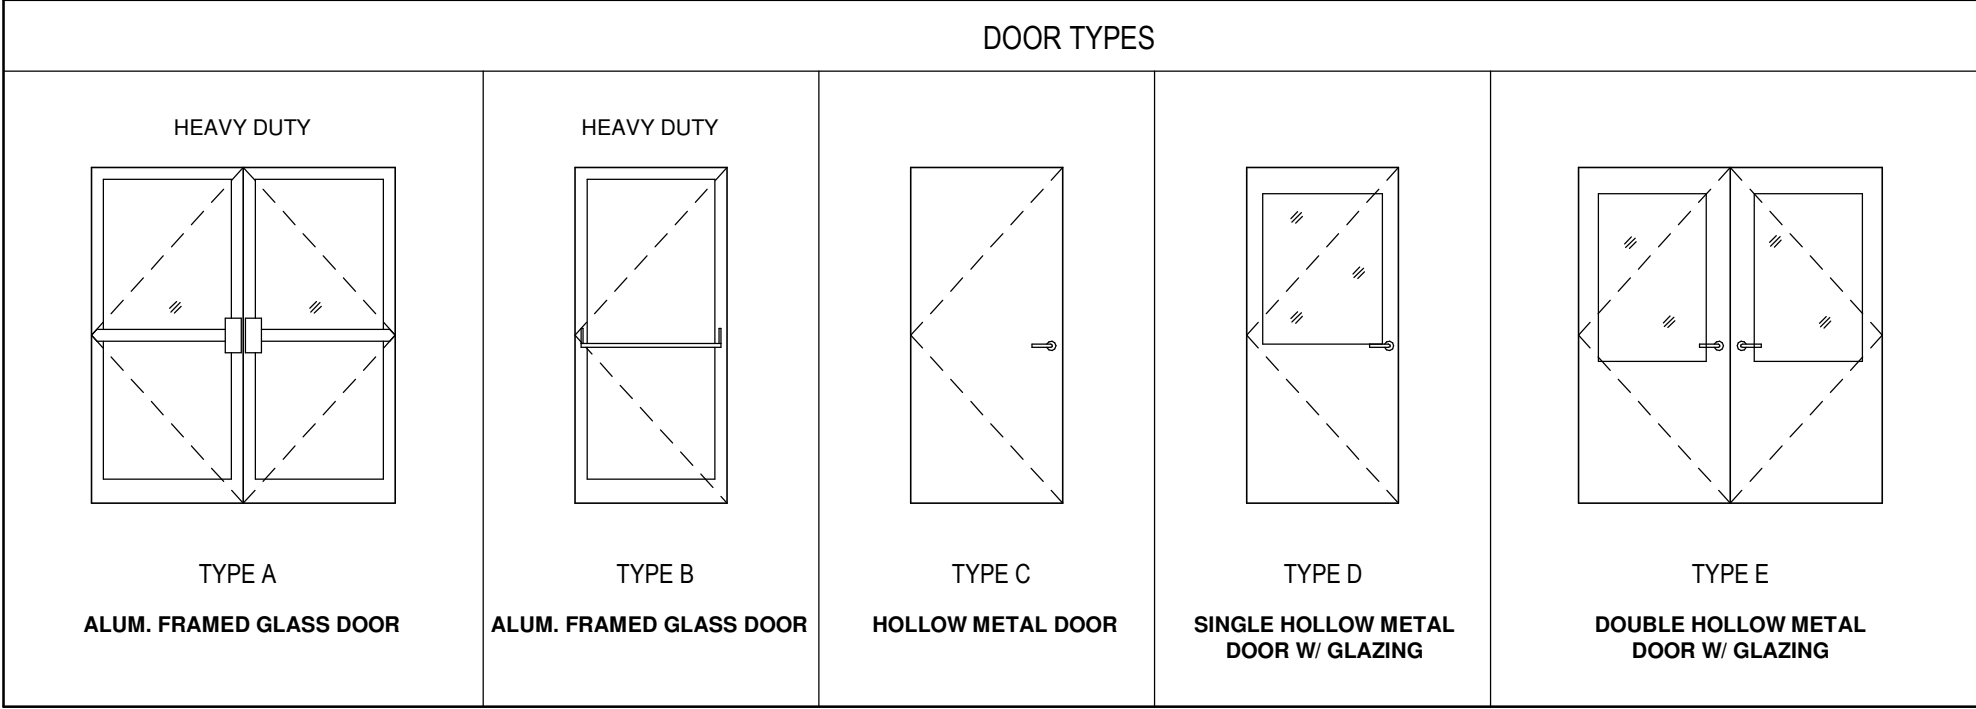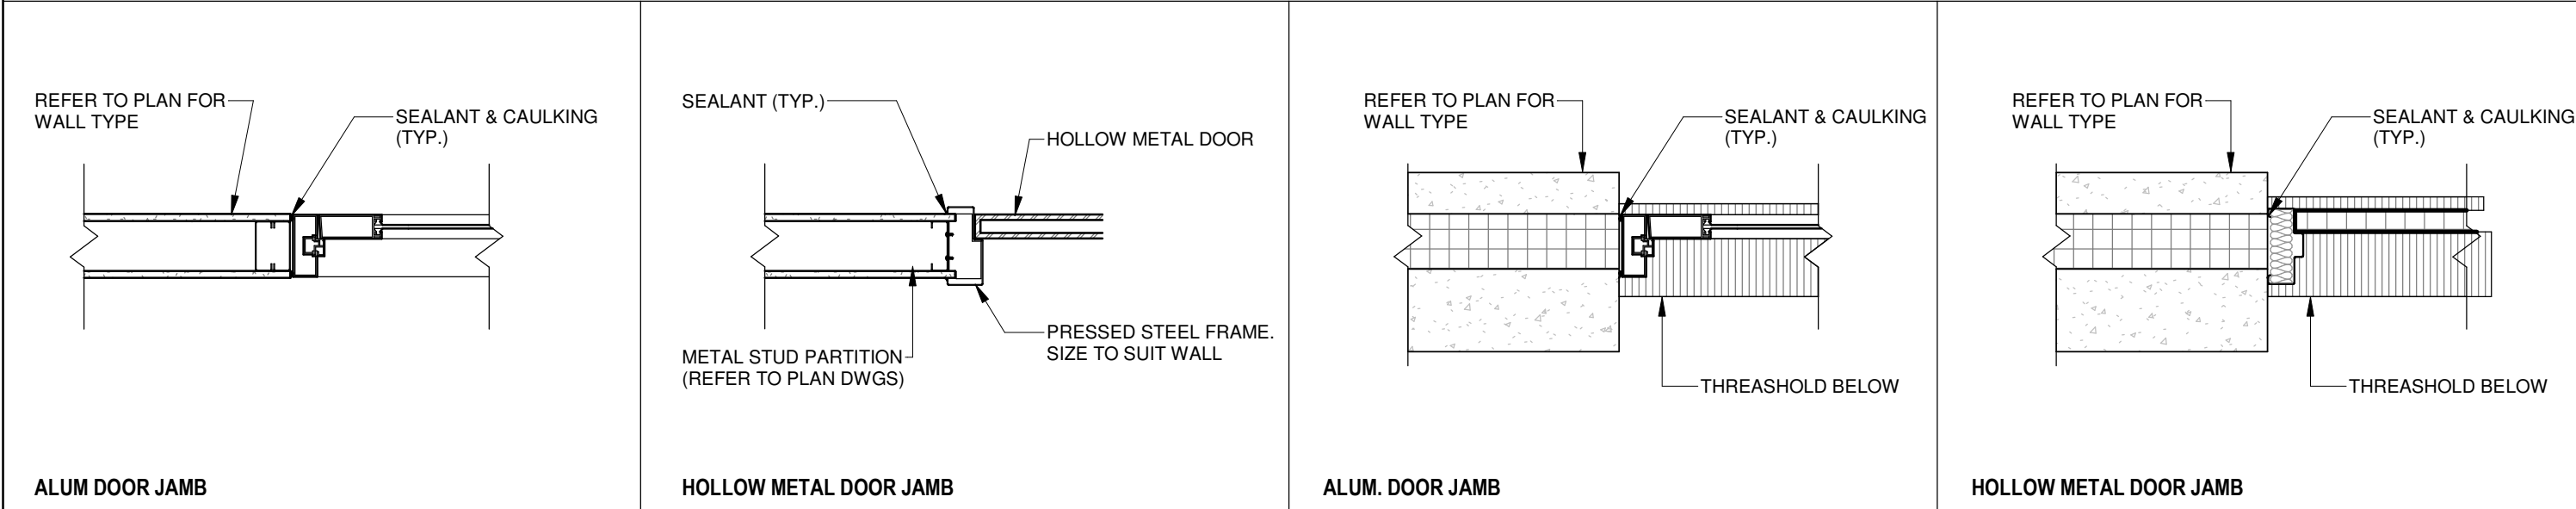

WINDOW SCHEDULE NOTES

- FOR LOCATION OF WINDOWS, REFER TO FLOOR PLAN DRAWINGS.
- ALL DIMENSIONS ARE IN IMPERIAL UNLESS OTHERWISE NOTED.
- READ THESE DRAWINGS IN CONJUNCTION WITH ALL INTERFACE DISCIPLINE DRAWINGS (STRUCTURAL, MECHANICAL, ELECTRICAL, AND LANDSCAPE DESIGN), AND WORK BETWEEN ALL TRADES SHALL BE COORDINATED PRIOR TO PROCEEDING WITH CONSTRUCTION.
- FIELD VERIFY ROUGH OPENING PRIOR TO ALL WINDOW FABRICATION AND INSTALLATIONS.

WINDOW SCHEDULE LEGEND

TYPE	DESCRIPTION	REMARK
SW-1	2" X 5' BLACK ANODIZED	SINGLE GLAZED STOREFRONT SYSTEM
SW-2	9" X 5' BLACK ANODIZED	SINGLE GLAZED STOREFRONT SYSTEM
GL-1	LOW-E INSULATED CLEAR GLASS	LAMINATED SAFETY GLASS
GL-2	CLEAR TEMPERED GLASS	
GL-3	WIRED GLASS	

ROOM FINISH SCHEDULE

ROOM		FLOOR		WALLS								CEILING		REMARKS
NO	NAME	MAT.	FINISH	NORTH		SOUTH		EAST		WEST		MAT.	FINISH	
				MAT.	FIN.	MAT.	FIN.	MAT.	FIN.	MAT.	FIN.			
GROUND FLOOR- REFER TO DWG. A2.7														
101	VESTIBULE	CON	CFT	GL	-	GB	ALUM PANEL	GL	-	GL	-	GL	PT	REFER TO ID DWGS.
102	LOBBY	CON	CFT	GB	ST	GB	ST	GL	ST	CON / BLK	WP / ST	-	-	REFER TO ID DWGS.
103	MACHINE ROOM	CON	PC	CON / BLK	PT	CON / BLK	PT	CON / BLK	PT	CON / BLK	PT	EC	PT	
104	UNIVERSAL WASHROOM	CON	CFT	GB	CWT	CON / BLK	CWT	GB	CWT	GB	CWT	GB	PT	
105	WOMEN'S WASHROOM	CON	CFT	GB	CWT	CON / BLK	CWT	STUD W. CON / BLK	CWT	GB	CWT	GB	PT	
106	MEN'S WASHROOM	CON	CFT	GB	CWT	CON / BLK	CWT	GB	CWT	GB	CWT	GB	PT	
107	CLASSROOM	CON	PC	GB	PT	CON / BLK	PT	GB	PT	CON / BLK	PT	AT	PF	
108	SHOOTING RANGE LOBBY	CON	PC	GB	PT	GB	PT	GB	PT	GB	PT	AT	PF	REFER TO ID DWGS.
109	GUN LOCKER ROOM	CON	PC	GB	PT	GB	PT	GB	PT	GB	PT	AT	PF	
110	OFFICE 1	CON	PC	GB	PT	GB	PT	GB	PT	GB	PT	AT	PF	
111	OFFICE 2	CON	PC	GB	PT	GB	PT	GB	PT	GB	PT	AT	PF	
112	SERVICE CORRIDOR	CON	PC	CON / BLK	PT	CON / BLK	PT	CON / BLK	PT	CON / BLK	PT	EC	PT	
113	OFFICE 3	CON	PC	CON / BLK	PT	CON / BLK	PT	CON / BLK	PT	CON / BLK	PT	AT	PF	
114	ELECTRICAL ROOM	CON	PC	CON / BLK	PT	CON / BLK	PT	CON / BLK	PT	CON / BLK	PT	EC	PT	
115	MECHANICAL ROOM	CON	PC	CON / BLK	PT	CON / BLK	PT	CON / BLK	PT	CON / BLK	PT	EC	PT	
116	STORAGE 1	CON	PC	CON / BLK	PT	CON / BLK	PT	CON / BLK	PT	PRECAST	PT	EC	PT	
117	CORRIDOR	CON	PC	CON / BLK	PT	CON / BLK	PT	CON / BLK	PT	PRECAST	PT	AT	PF	
118	STORAGE (KITCHEN)	CON	PC	GB	PT	GB	PT	GB	PT	CON / BLK	PT	EC	PT	
119	STAFF WASHROOM	CON	CFT	PRECAST	CWT	GB	CWT	GB	CWT	GB	CWT	GB	PT	
120	KITCHEN	CON	CFT	GB	PT	GB	PT	GB	PT	GB	PT	AT	PF	REFER TO ID DWGS.
121	RESTAURANT	CON	CFT	GB	WP / BR / PT	GB	WP / PT	GL / GB	WP / BR / PT	GB	WP / ST	-	-	REFER TO ID DWGS.
122	STAIR A	CON	PC	CON / BLK	PT	CON / BLK	PT	CON / BLK	PT	CON / BLK	PT	EC	PT	
123	STAIR B	CON	PC	PRECAST	PT	CON / BLK	PT	CON / BLK	AWP	PRECAST	PT	AP	PF	
124	STAIR C	CON	PC	PRECAST	PT	CON / BLK	AWP	CON / BLK	PT	CON / BLK	AWP	AP	PF	
125	GARBAGE ROOM	CON	PC	CON / BLK	-	CON / BLK	-	CON / BLK	-	PRECAST	-	EC	-	
126	SHOOTING RANGE 1	CON	PC	CON / BLK	-	CON / BLK	-	CON / BLK	-	CON / BLK	-	-	-	REFER TO ACTION TARGET DWGS.
127	SHOOTING RANGE 2	CON	PC	CON / BLK	-	CON / BLK	-	CON / BLK	-	CON / BLK	-	-	-	REFER TO ACTION TARGET DWGS.
128	STORAGE 2	CON	PC	CON / BLK	PT	CON / BLK	PT	CON / BLK	PT	CON / BLK	PT	EC	-	
129	STORAGE 3	CON	PC	CON / BLK	PT	CON / BLK	PT	CON / BLK	PT	CON / BLK	PT	EC	-	
GROUND FLOOR- REFER TO DWG. A2.8														
201	STAIR A	CON	PC	CON / BLK	PT	CON / BLK	PT	CON / BLK	PT	CON / BLK	PT	EC	PT	
202	STORAGE 2	CON	PC	CON / BLK	PT	CON / BLK	PT	CON / BLK	PT	GB	PT	AT	PF	
203	LOBBY 2	CON	PC	GB	PT	GB	PT	GB	PT	GB	PT	AT	PF	
204	CORRIDOR 2	CON	PC	CON / BLK	PT	CON / BLK	PT	PRECAST	PT	CON / BLK	PT	AT	PF	
205	CLAYHOUSE SHOT GUN RANGE	CON	PC	PRECAST	-	PRECAST	-	PRECAST	-	CON / BLK	-	-	-	REFER TO ACTION TARGET DWGS.
206	STAIR B	CON	PC	CON / BLK	AWP	CON / BLK	PT	CON / BLK	AWP	PRECAST	PT	AP	PF	
207	STORAGE 3	CON	PC	CON / BLK	PT	CON / BLK	PT	CON / BLK	PT	PRECAST	PT	EC	PT	

DOOR & WINDOW SCHEDULES NOTES

- READ ARCHITECTURAL DRAWINGS IN CONJUNCTION WITH THE ARCHITECTURAL SPECIFICATIONS INTERFACE DISCIPLINE (CIVIL, STRUCTURAL, MECHANICAL, HVAC, PLUMBING AND ELECTRICAL) AND WORK BETWEEN TRADES SHALL BE COORDINATED PRIOR TO PROCEEDING WITH CONSTRUCTION.
- DIRECTIONS OF SWING AND ORIENTATION FOR ALL DOORS ARE TO BE DETERMINED FROM FLOOR PLANS.
- ALL EXISTING DOORS ARE NOT NUMBERED.
- ALL EXTERIOR METAL DOORS SHALL BE INSULATED AND WEATHER STRIPPED AND THE CAVITY BEHIND AND AROUND THE FRAMES SHALL BE FILLED W/ POLYURETHANE INSULATION.
- DOOR AND WINDOW ASSEMBLIES TO MEET THE REQUIREMENTS OF SB10 OF THE OBC.
- DOOR AND WINDOW MANUFACTURER(S) TO SITE VERIFY ALL ROUGH OPENING DIMENSIONS PRIOR TO FABRICATION.
- ALL METAL DOORS ARE TO BE INSTALLED W/ MIN. 3 HINGES. HEAVY-DUTY HINGES THROUGHOUT.
- GLASS DOORS AND WINDOWS SHALL BE CONSTRUCTED W/ TEMPERED SAFETY GLASS.
- GLASS DOORS WITHIN A BARRIER-FREE PATH OF TRAVEL SHALL BE INSTALLED W/ LEVER TYPE DOOR HANDLES.
- ALL EXIT DOOR SHALL BE INSTALLED WITH EXIT HARDWARE THAT COMPLIES WITH OBC 3.3.1.12 AND 3.4.6.16.
- OPAQUE STRIPS SHALL COMPLY WITH O.B.C. 3.8.3.3.(15).


DOOR, WINDOW & ROOM FINISHSCHEDULES ABBREVIATIONS

ANOD ALUM AP AT AW AWP BLK BR CFT CON CON/BLK DBL DR DTGL EC EXT FFE GLV GB GL GWG HM ID INSUL INT LH MIN.	ANODIZED ALUMINUM ACOUSTIC PANEL ACOUSTIC TILES ACOUSTIC WALL ACOUSTIC WALL PANEL BLOCK DECORATIVE BRICK CERAMIC FLOOR TILE CONCRETE CONCRETE BLOCK CERAMIC WALL TILES DOUBLE DOOR DOUBLE TEMPERED GLASS EXPOSED CEILING EXTERIOR FINISH FLOOR ELEVATION GALVANIZED GYPSUM BOARD GLASS GEORGIAN WIRED GLASS HOLLOW METAL INTERIOR DESIGN INSULATED INTERIOR LEFT HAND MINUTE	PC PP PRECAST PS PT RH RM RO ST TC TEMP TSQL UNL WP	POLISHED CONCRETE PREFINISHED PRECAST WALL PRESSED STEEL PAINT RIGHT HAND ROOM ROUGH OPENING STONE TILE T-BAR CEILING TEMPERED GLASS TEMPERED SAFETY GLASS UNIVERSAL WASHROOM WALL PANEL
--	--	--	---


1	05/28/2025	ISSUED FOR PERMIT	HW
No.	Date:	Issued/Revision:	By

Client:




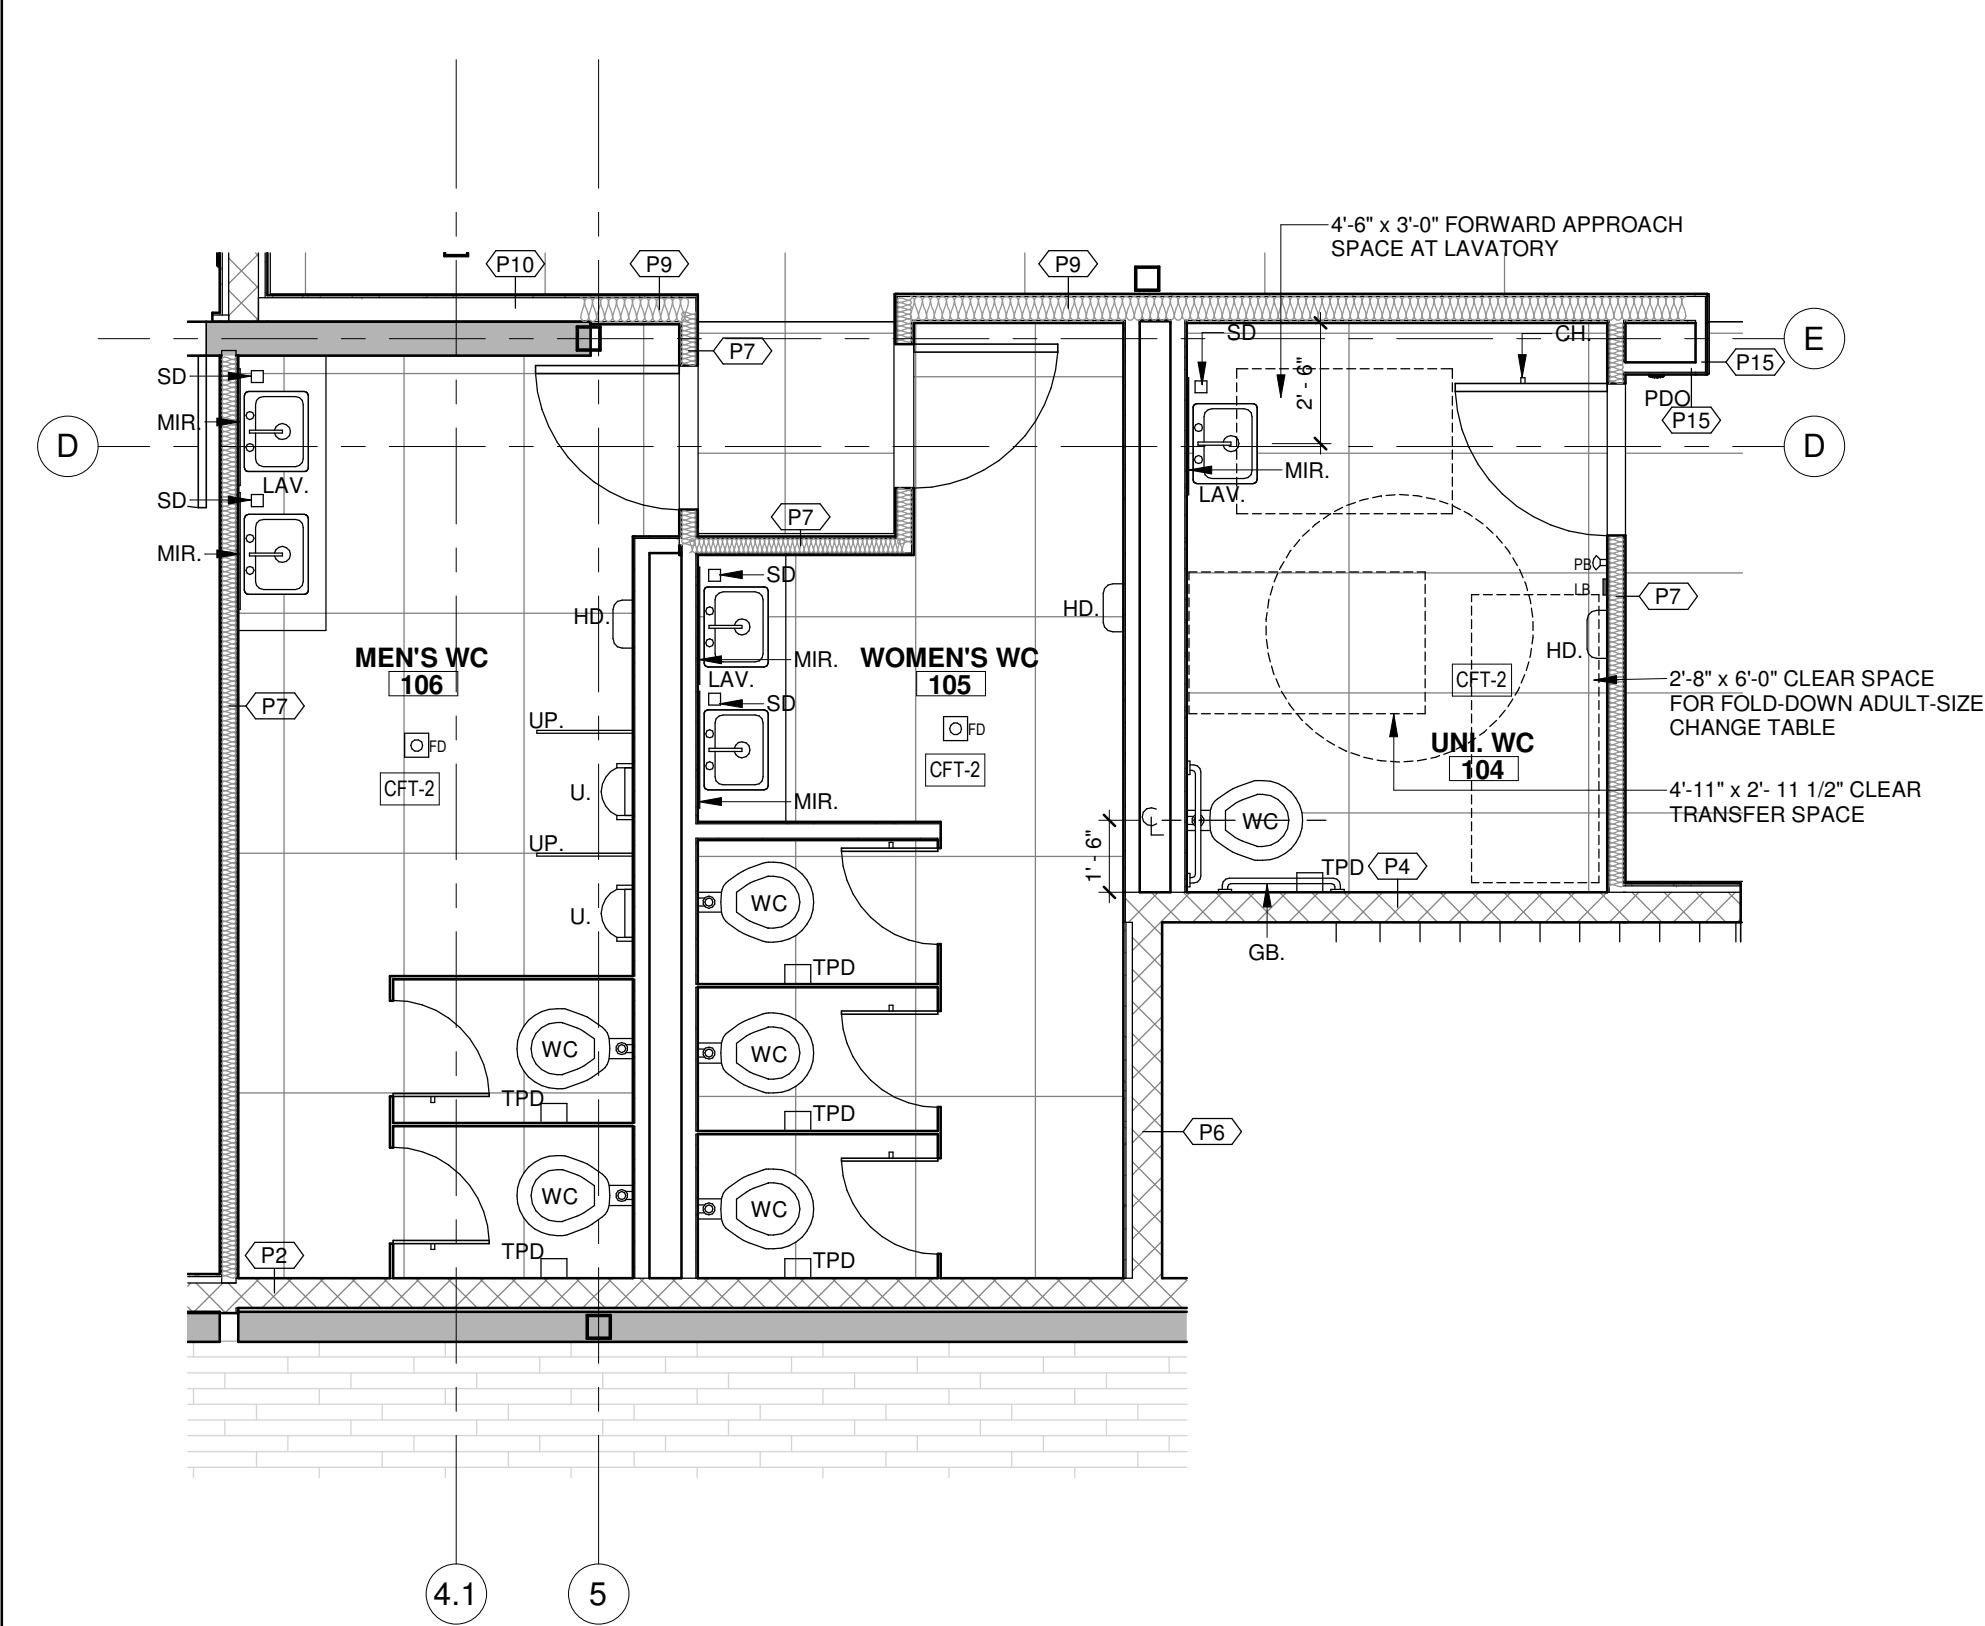


1 ENLARGE PLAN - UNIVERSAL WASHROOM
1/4" = 1'-0"

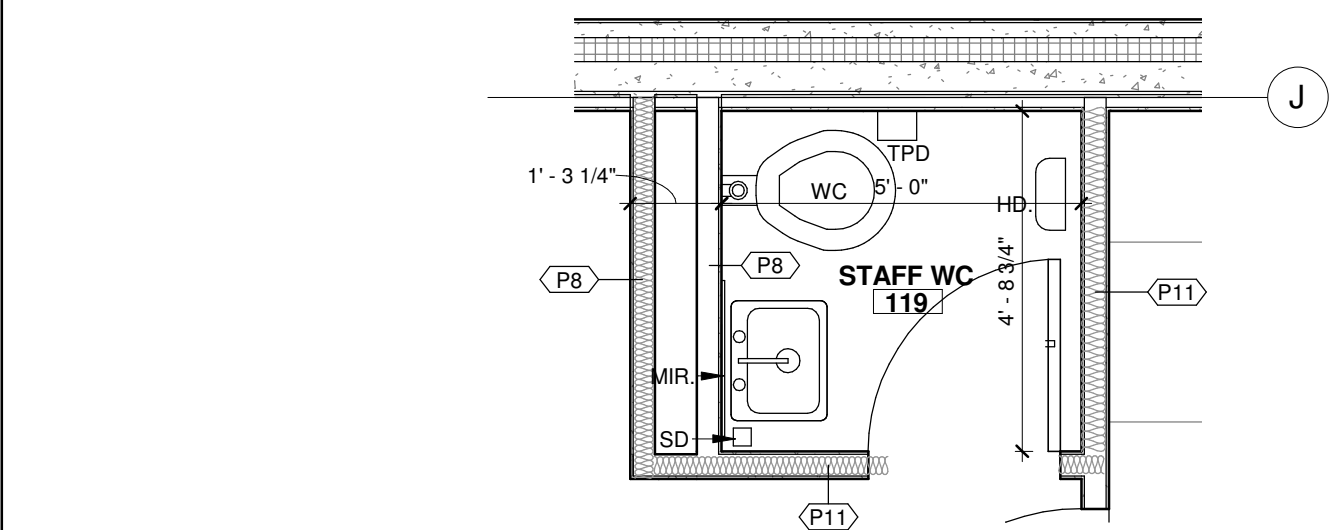


2 STAFF WASHROOM
3/8" = 1'-0"

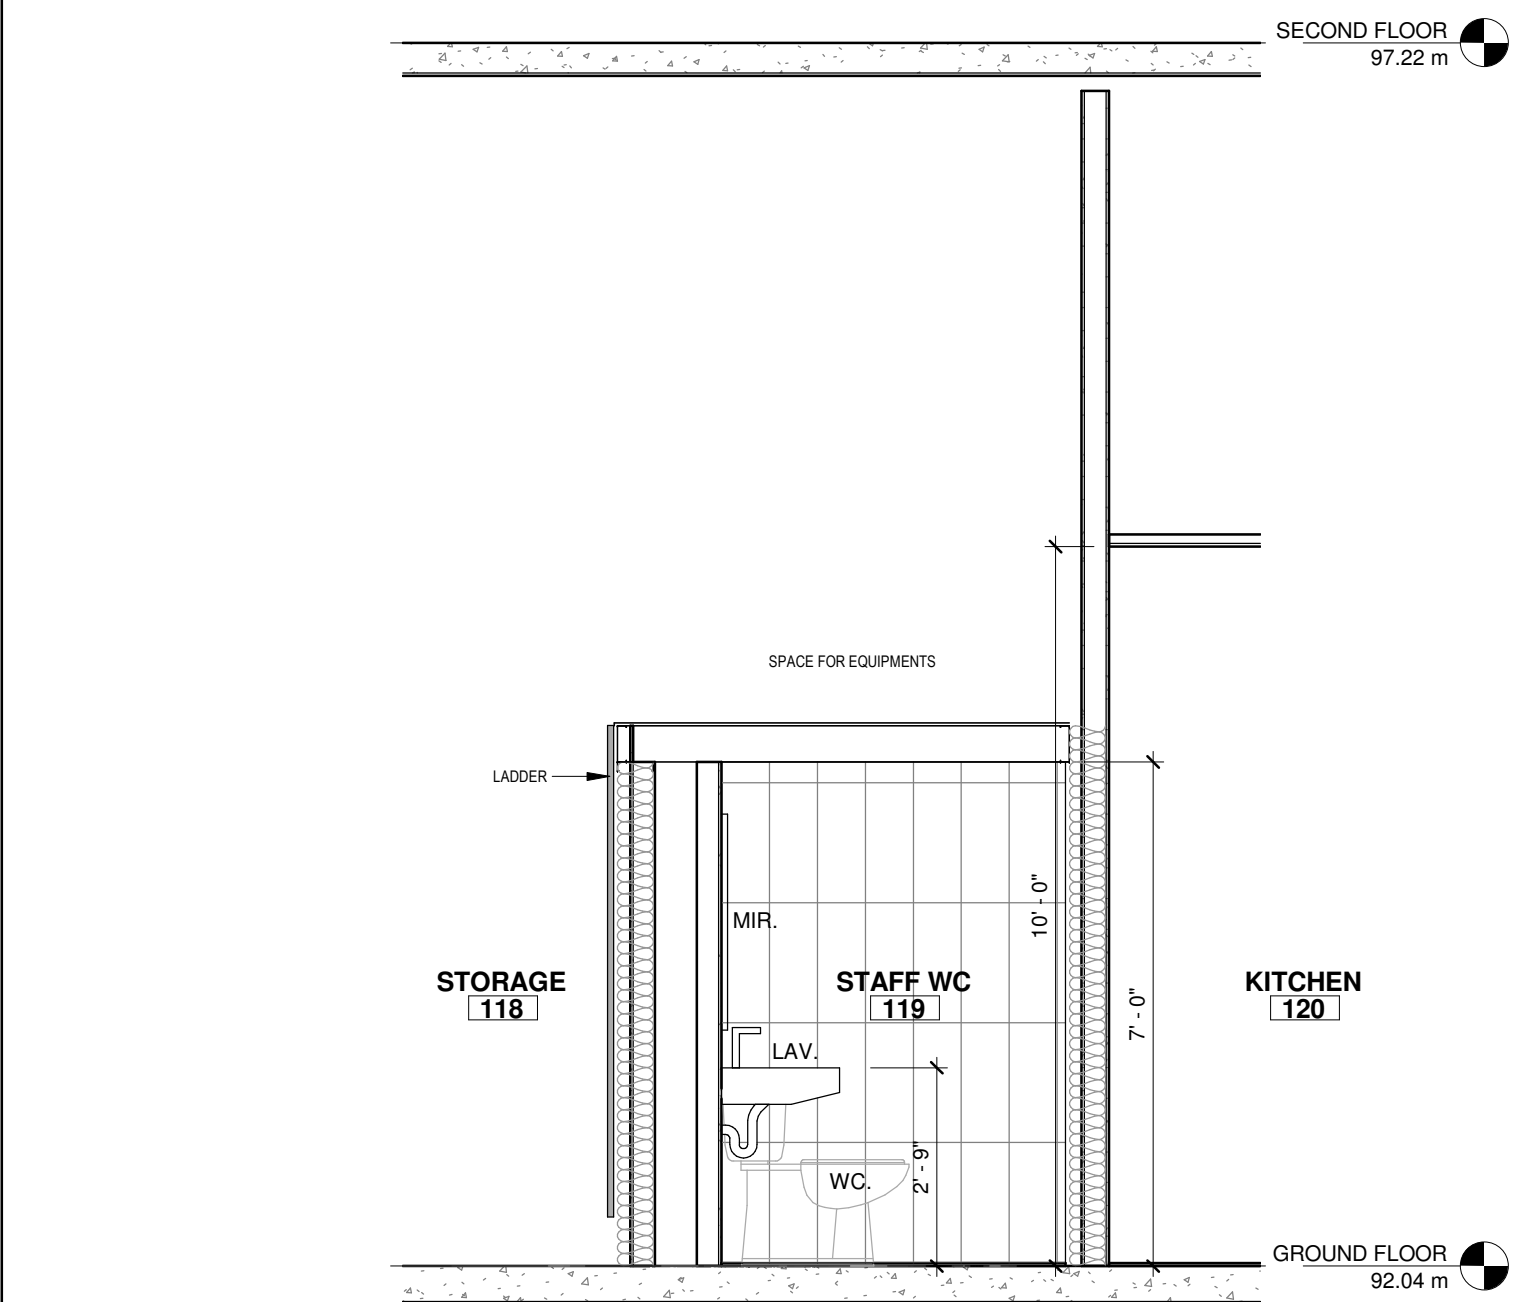


3 STAFF WASHROOM SECTION PLAN
3/8" = 1'-0"

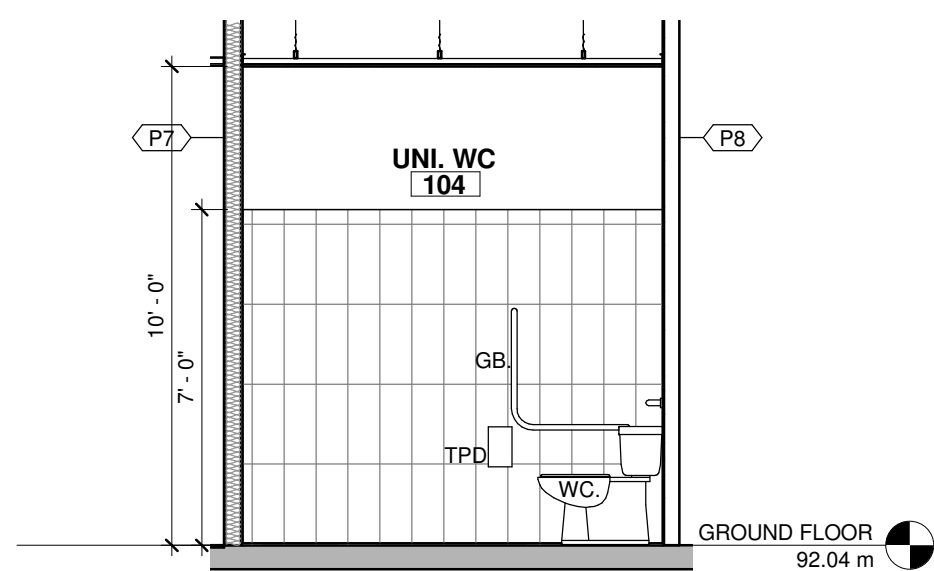


4 UNIVERSAL WASHROOM ELEVATION - SOUTH
1/4" = 1'-0"

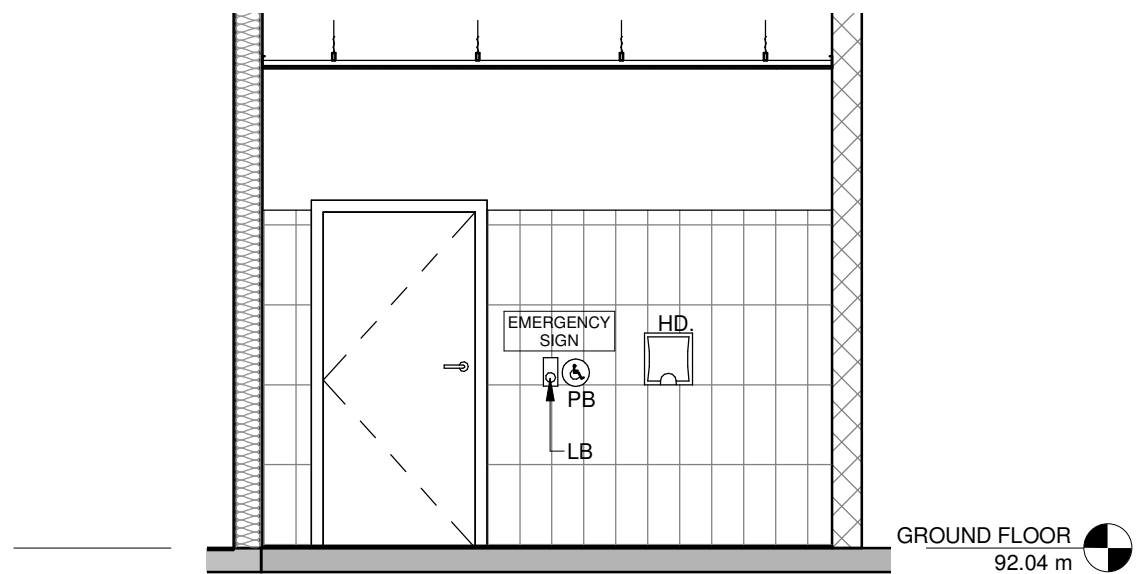


5 UNIVERSAL WASHROOM ELEVATION - EAST
1/4" = 1'-0"

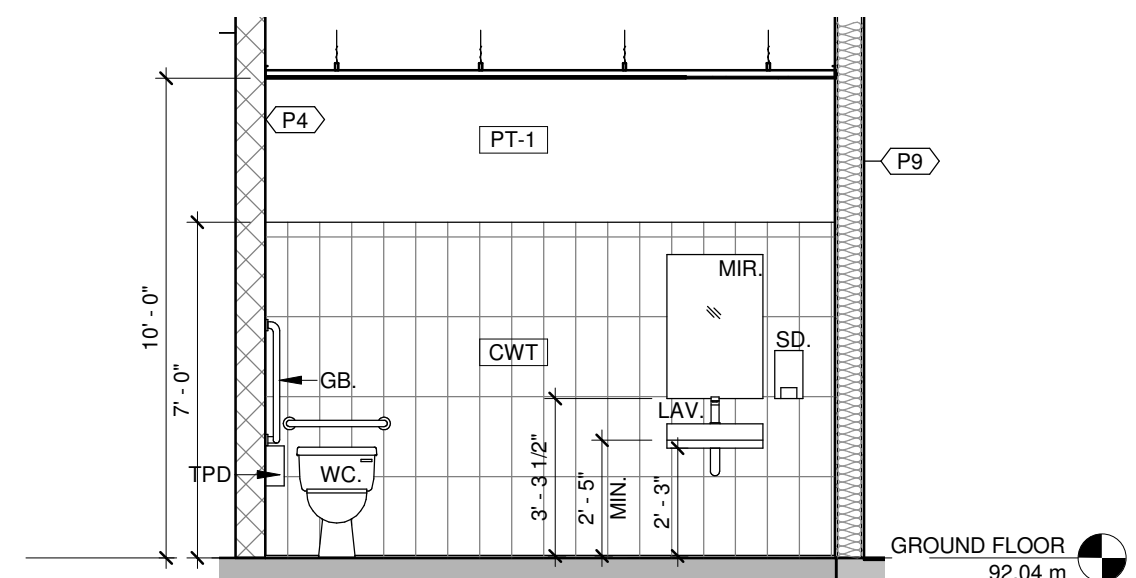


6 UNIVERSAL WASHROOM ELEVATION - WEST
1/4" = 1'-0"

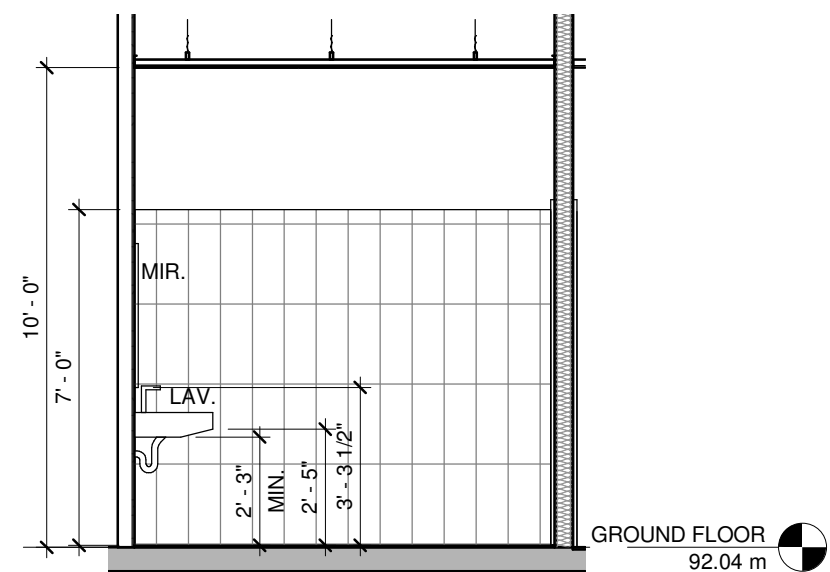


7 UNIVERSAL WASHROOM ELEVATION - NORTH
1/4" = 1'-0"

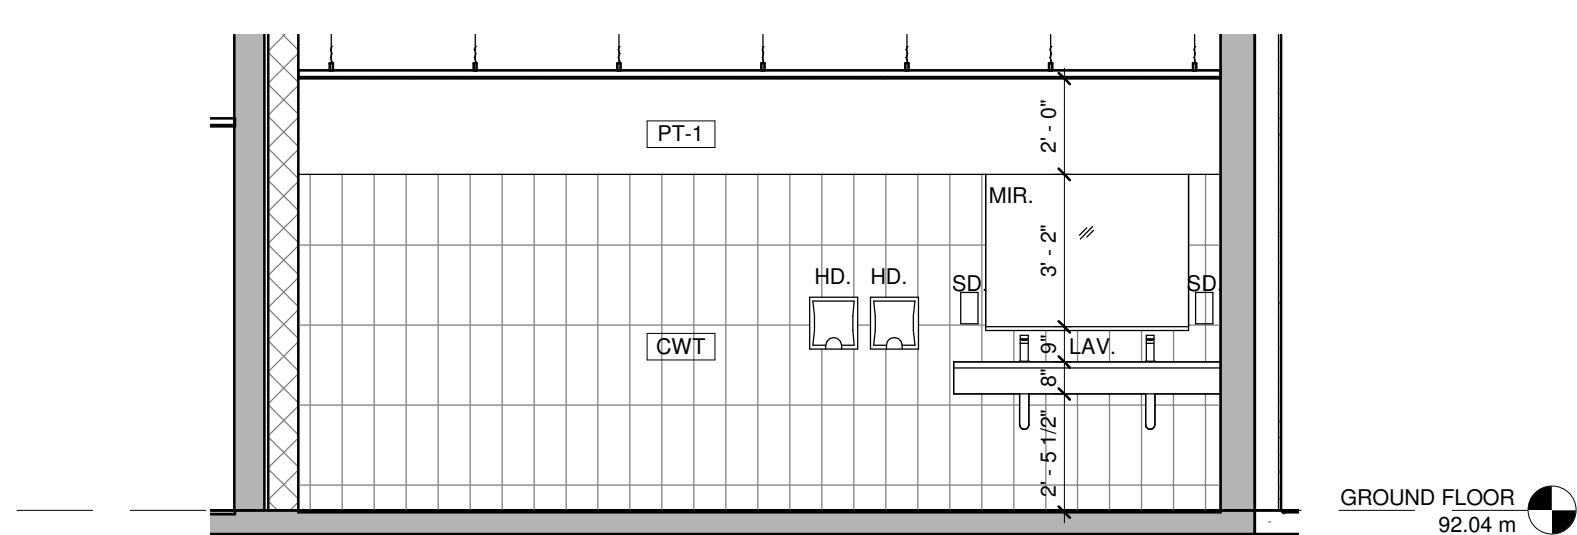


8 MEN WASHROOM ELEVATION - WEST
1/4" = 1'-0"

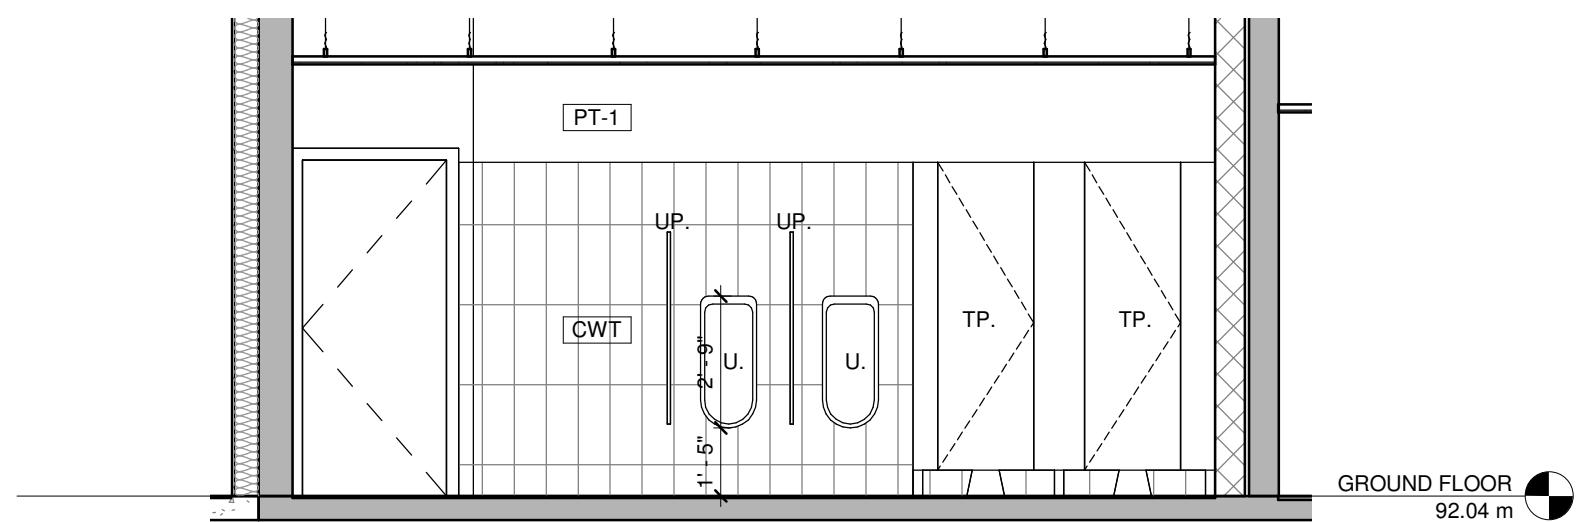


10 MEN WASHROOM ELEVATION - EAST
1/4" = 1'-0"

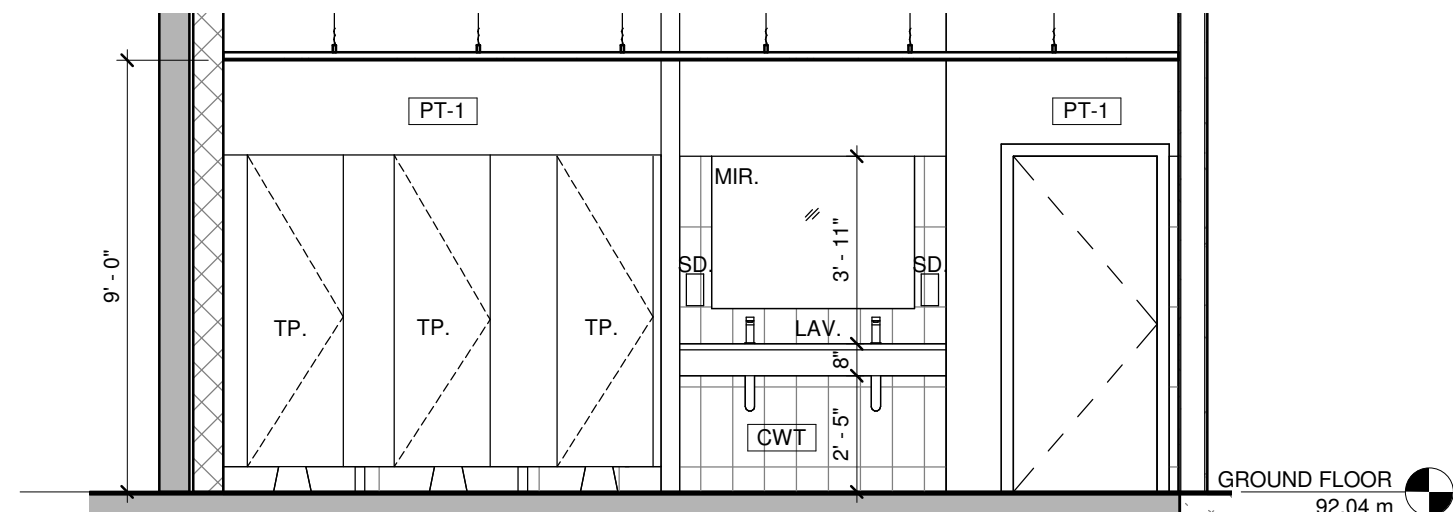


12 WOMEN WASHROOM ELEVATION - WEST
1/4" = 1'-0"

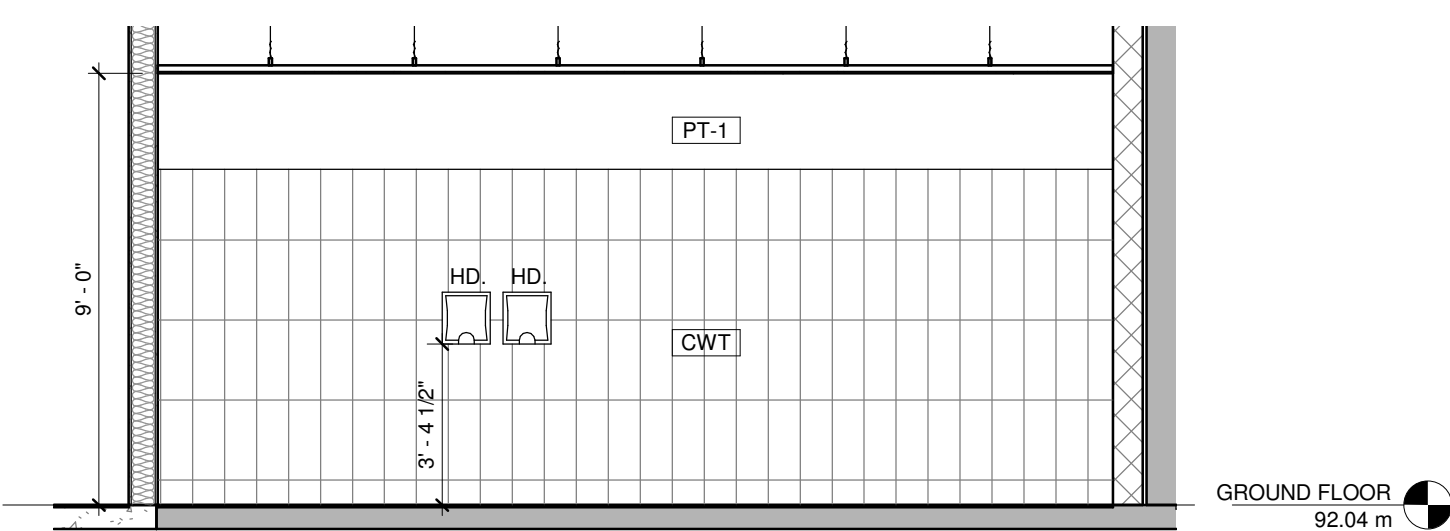


14 WOMEN WASHROOM ELEVATION - EAST
1/4" = 1'-0"

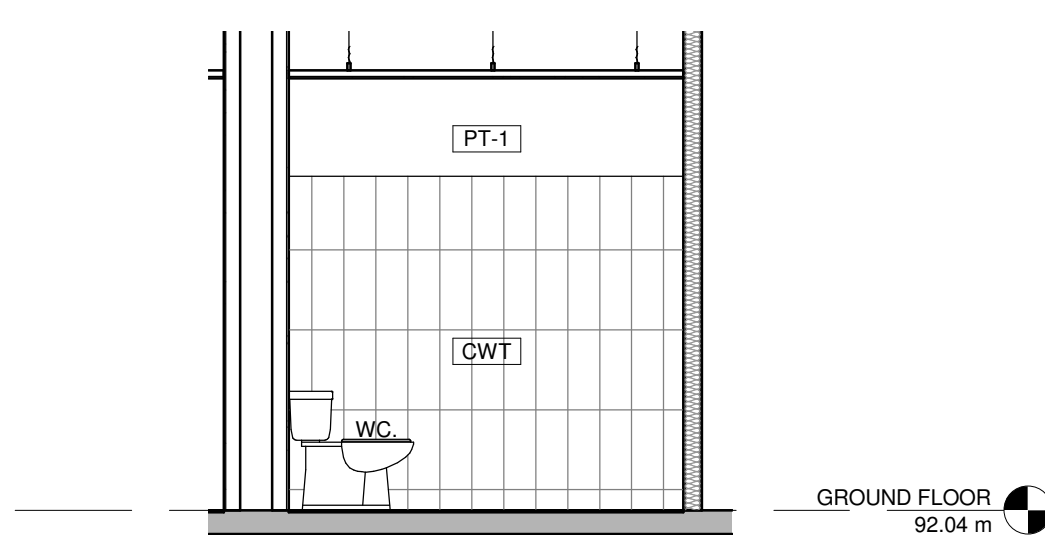


9 MEN WASHROOM ELEVATION - SOUTH
1/4" = 1'-0"

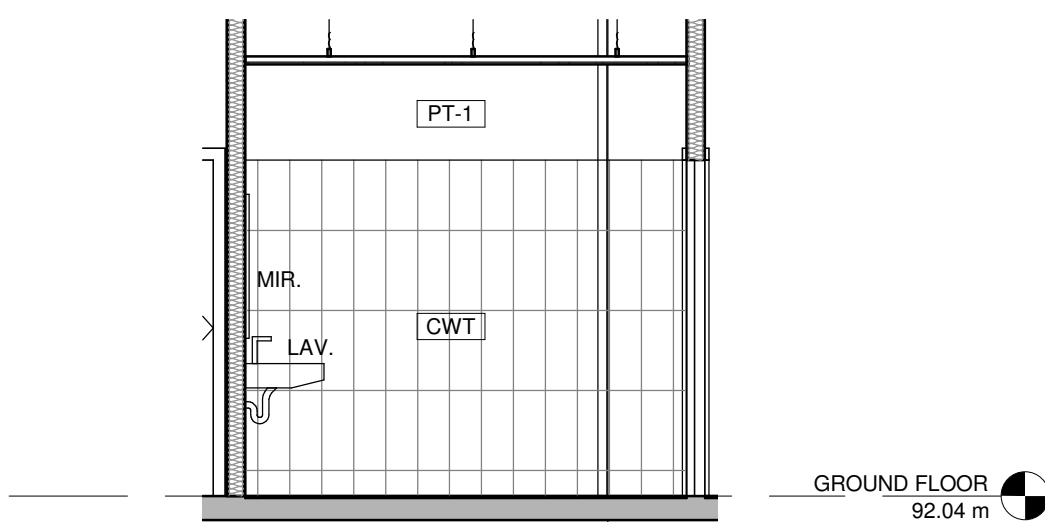

11 MEN WASHROOM ELEVATION - NORTH
1/4" = 1'-0"

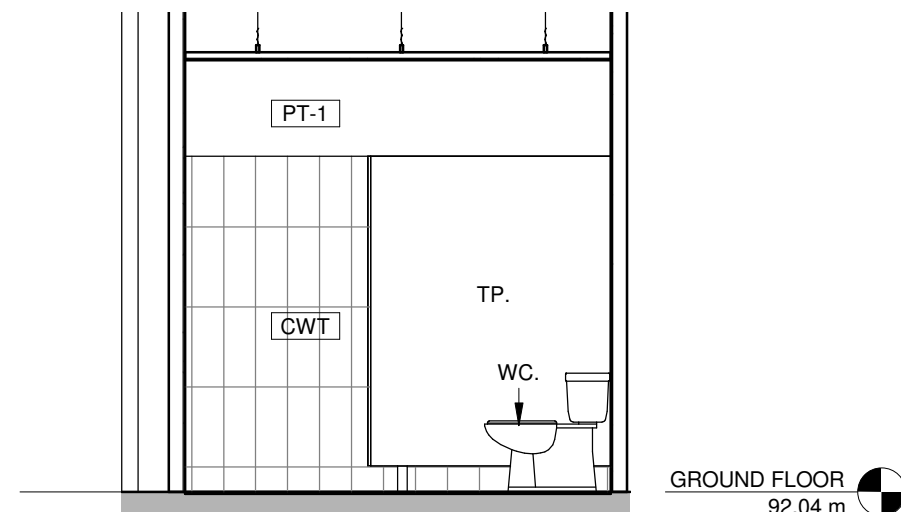

13 WOMEN WASHROOM ELEVATION - SOUTH
1/4" = 1'-0"

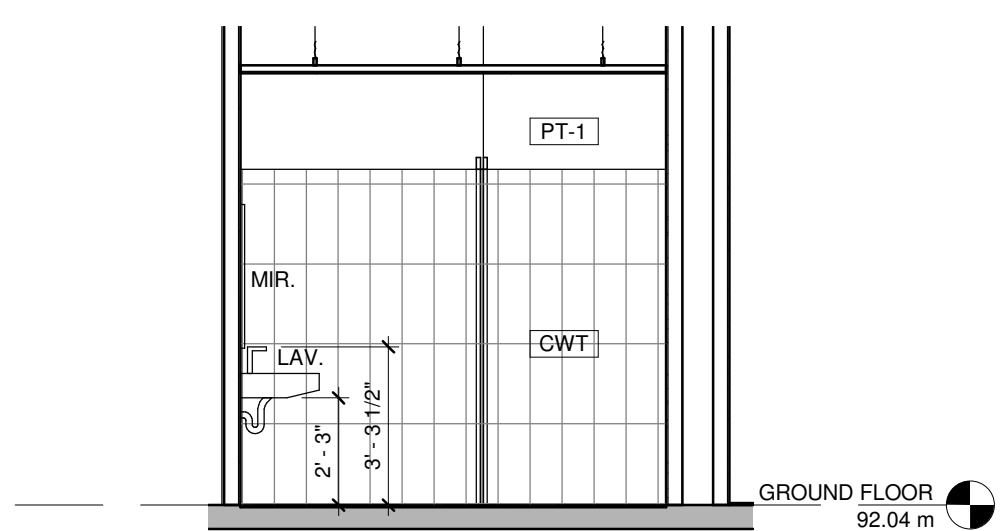

15 WOMEN WASHROOM ELEVATION - NORTH
1/4" = 1'-0"

- NOTES**
1. FOR GENERAL NOTES AND LEGEND AND WALL TYPES, REFER TO DRAWING A1.2.
 2. READ ARCHITECTURAL DRAWINGS IN CONJUNCTION WITH ALL OTHER CONSULTANTS' DRAWINGS. WORK BETWEEN TRADES SHALL BE COORDINATED PRIOR TO PROCEEDING WITH CONSTRUCTION.
 3. ROOM FINISH REFER TO ROOM FINISH SCHEDULE ON DRAWING A5.1.
 4. ALL FIXTURES IN UNIVERSAL WASHROOM SHALL COMPLY WITH CBC 3.8.3.12.
 5. FOR FLOOR DRAIN LOCATIONS REFER TO MECHANICAL DDRAWINGS TYPICAL.

- ABBREVIATIONS**
- | | |
|------|----------------------------------|
| TPD | TOILET PAPER DISPENSER |
| SND | SANITARY NAPKIN DISPENSER |
| PB | PUSH BUTTON |
| PDO | POWER DOOR OPERATION |
| PTDR | PAPER TOWEL DISPENSER/RECEPTACLE |
| SMR | SANITARY NAPKIN RECEPTACLE |
| SD | SOAP DISPENSER |
| MIR | MIRROR |
| CH | COAT HOOK |
| GB | GRAB BARS |
| WC | FLOOR MOUNTED WATER CLOSET |
| UP | URINAL PARTITION |
| U | URINAL |
| TP | TOILET PARTITION |
| LAV | LAVATORY |

FINISH LEGEND		
GRAPHICS	TYPE MARKS	FINISH MATERIALS
	PC	POLISHED CONCRETE
	CFT	30"X60" TILE GE.PI.WHT.1224
	CFT-2	OLYMPIA TILES 18" X36" WA.BR.GRY.1836.MT
	CWT	OLYMPIA TILES 12" X 24" GRIGIO (GREY) VE.LF.GRY.1224.MT
	FD	FLOOR DRAIN

1	05/28/2025	ISSUED FOR PERMIT	HW
No.	Date:	Issued/Revision:	By

Client:

**FIREARMS
OUTLET CANADA**

W **WANG ARCHITECTS INC.**
3950 14th Ave, Unit 609
Markham, ON L3R 0A9
T: 905-604-6960
E: info@wangarchitects.ca
www.wangarchitects.ca



Project :

FIREARMS OUTLET CANADA

725 WESTNEY RD. S.,
AJAX, ON L1S 7J7

Drawing Name :


WASHROOM DETAIL

Scale : As indicated Project No : 00026


Drawn by : JW Drawing No :

Checked by : HW


A4.6

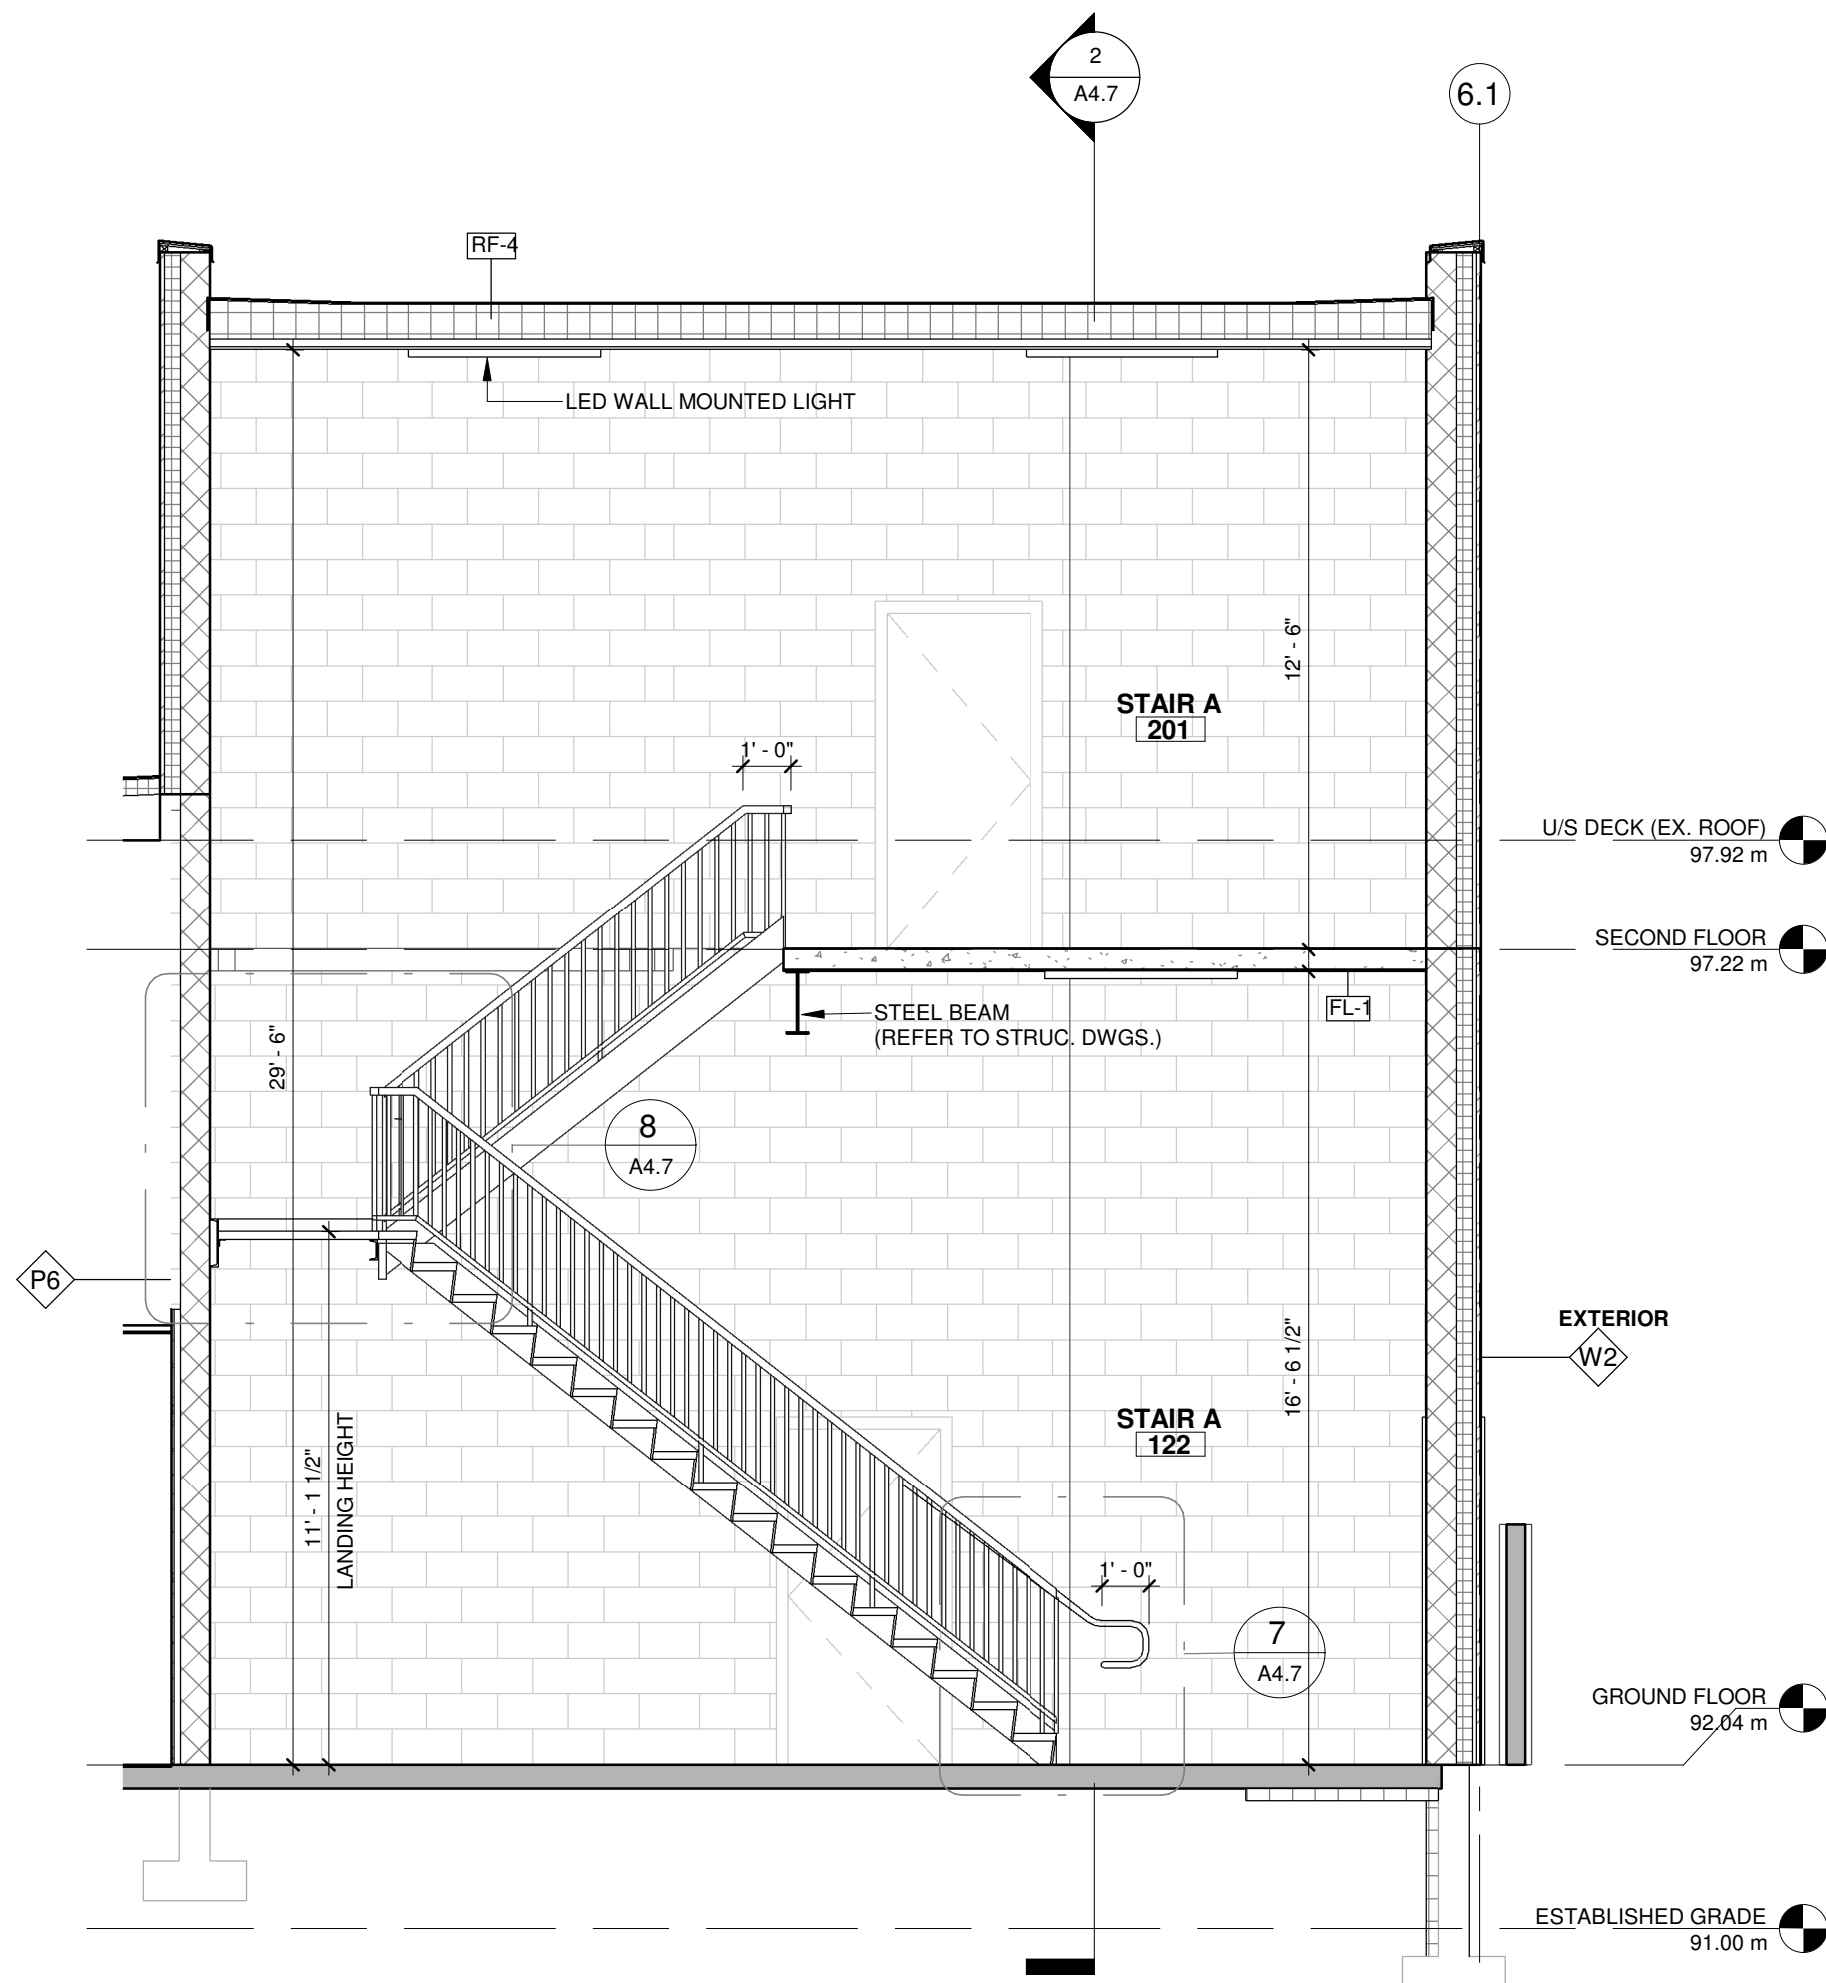


1 STAIR A SECTION A
1/4" = 1'-0"

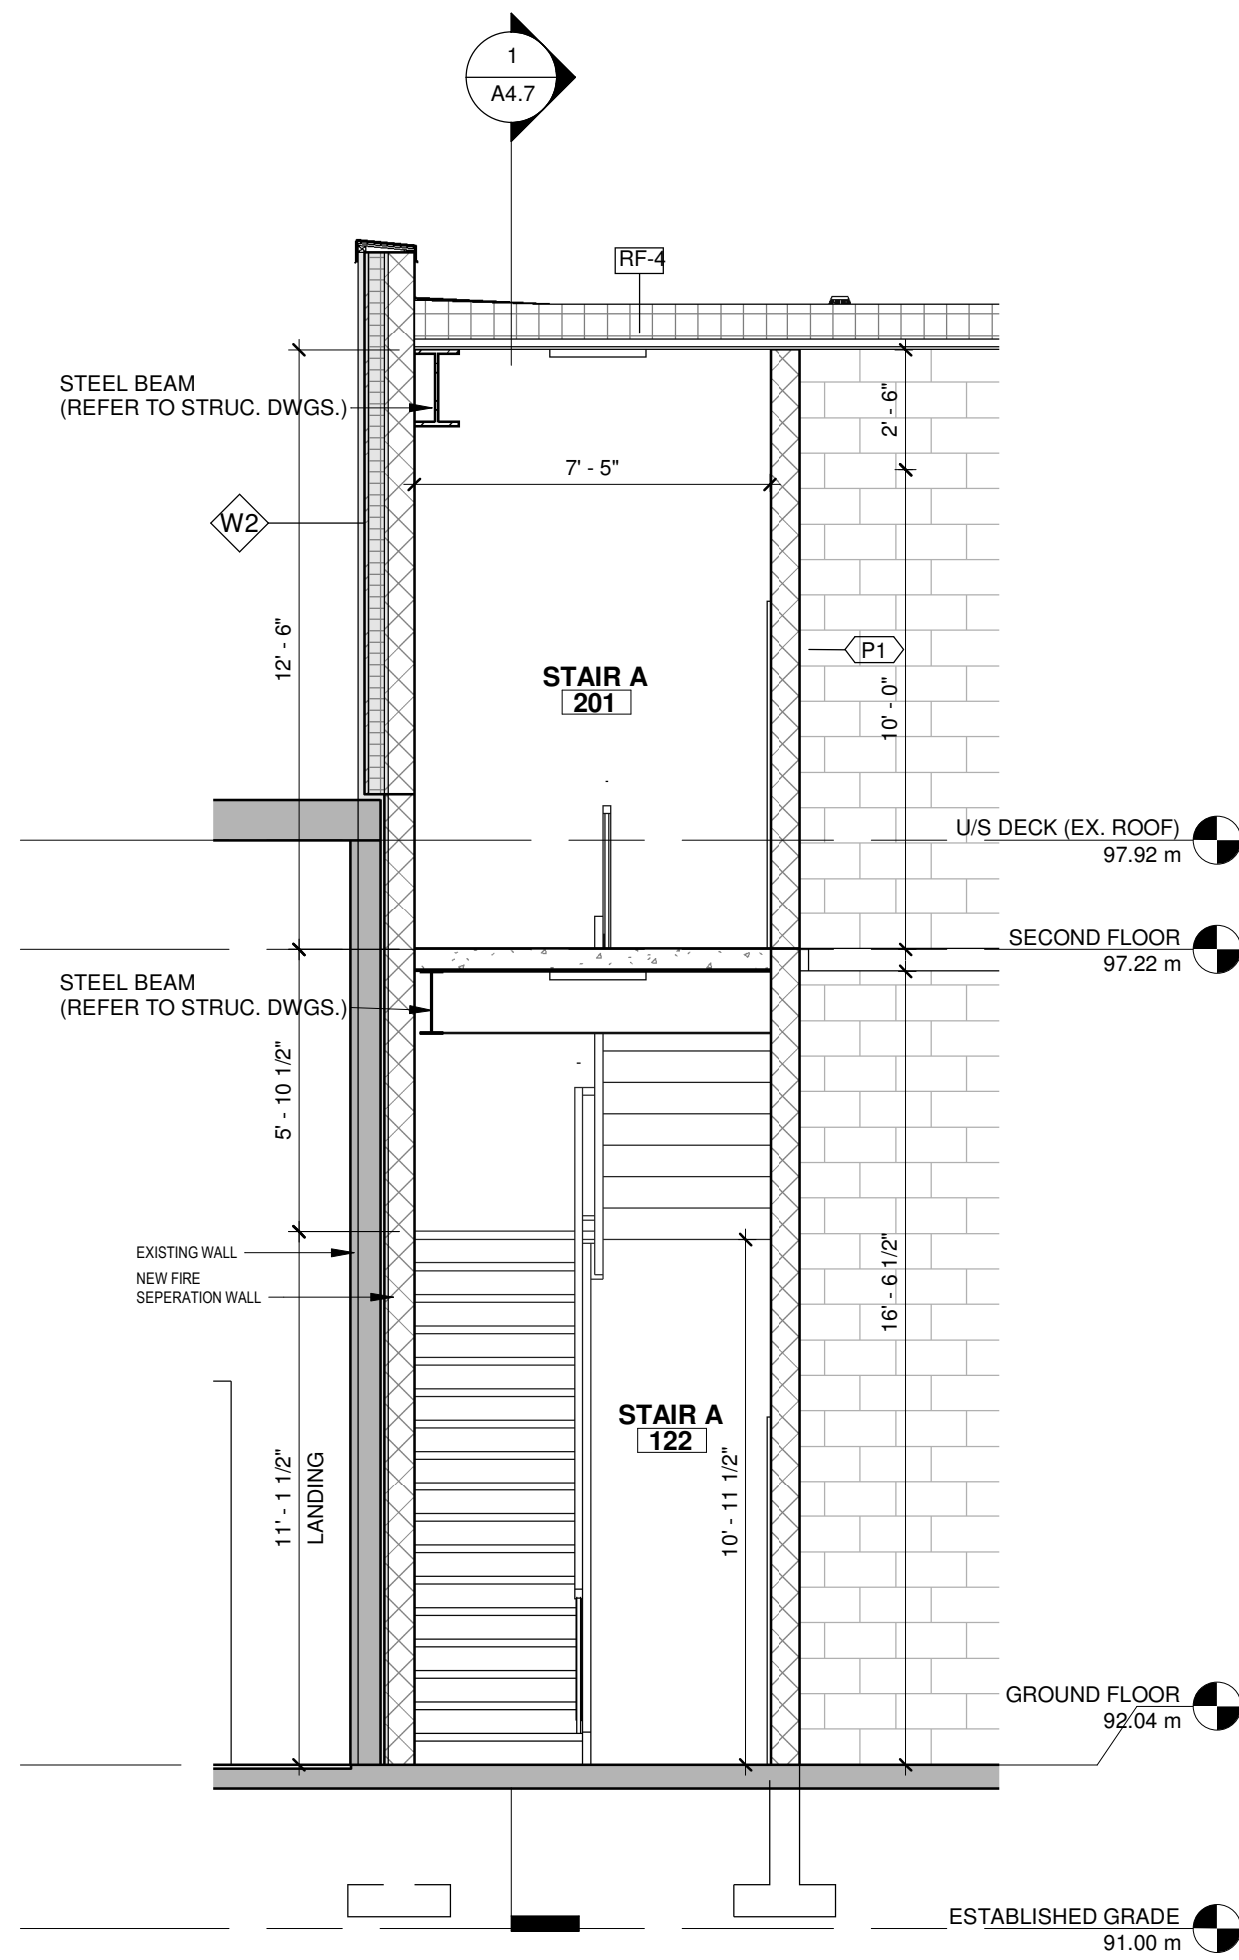


2 STAIR A SECTION B
1/4" = 1'-0"

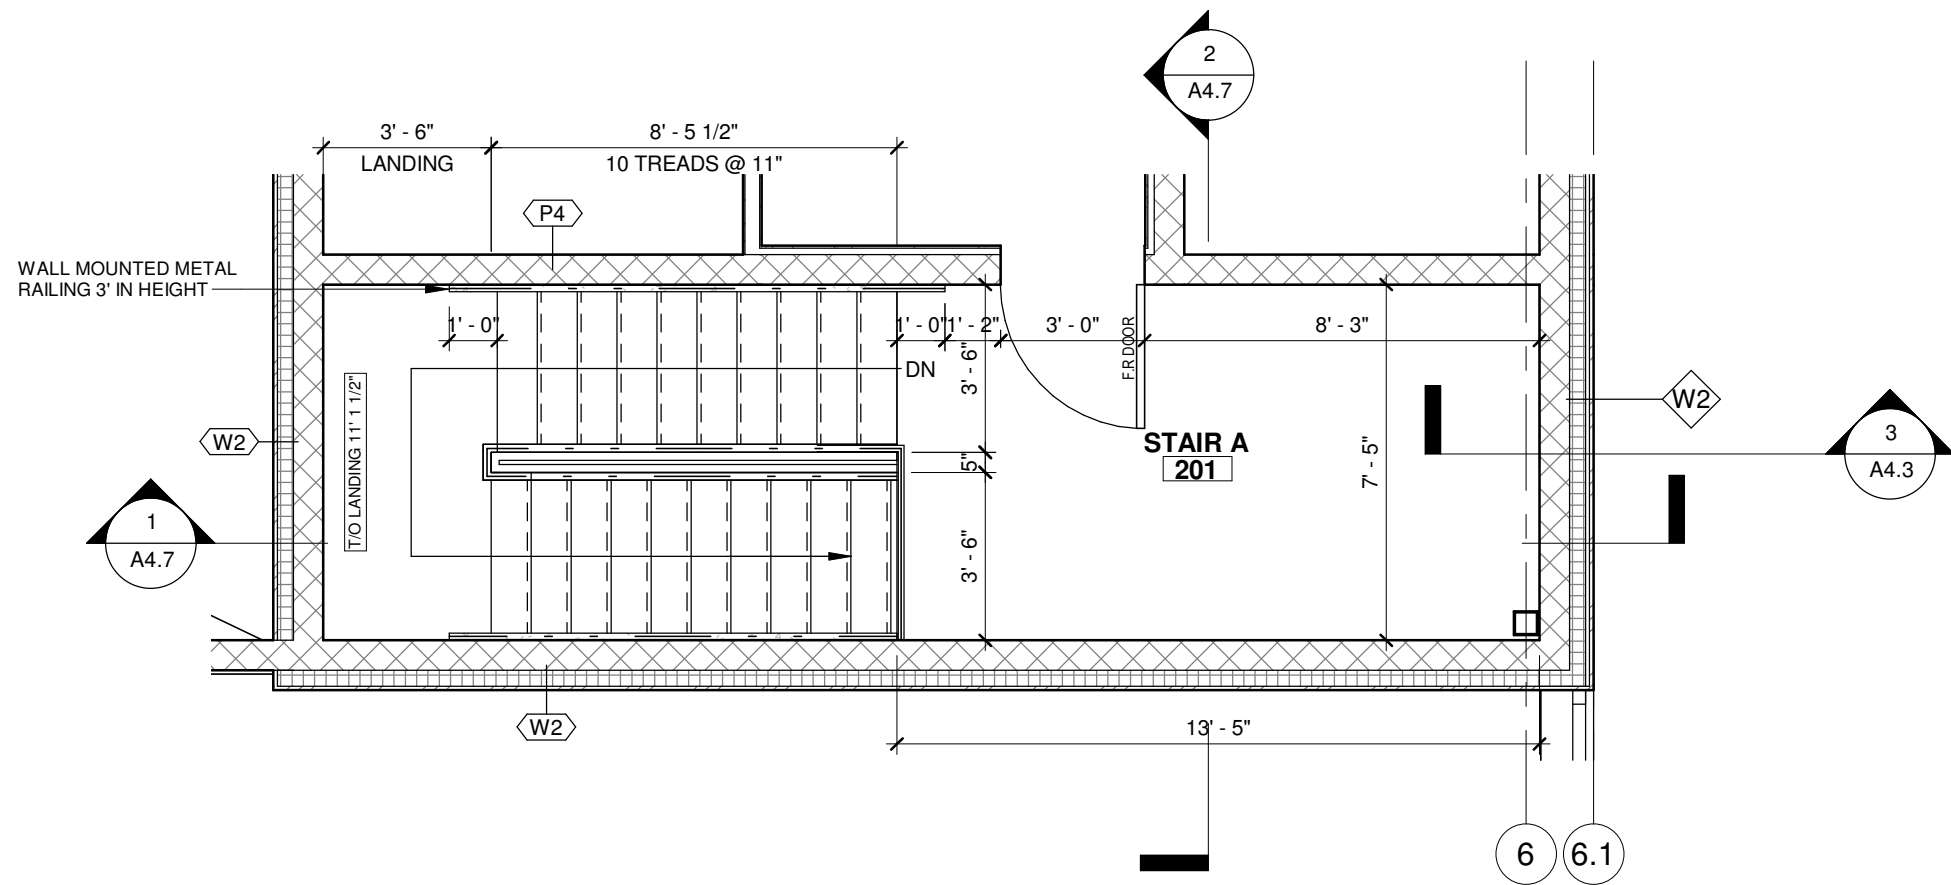


3 STAIR A SECOND FLOOR PLAN
1/4" = 1'-0"

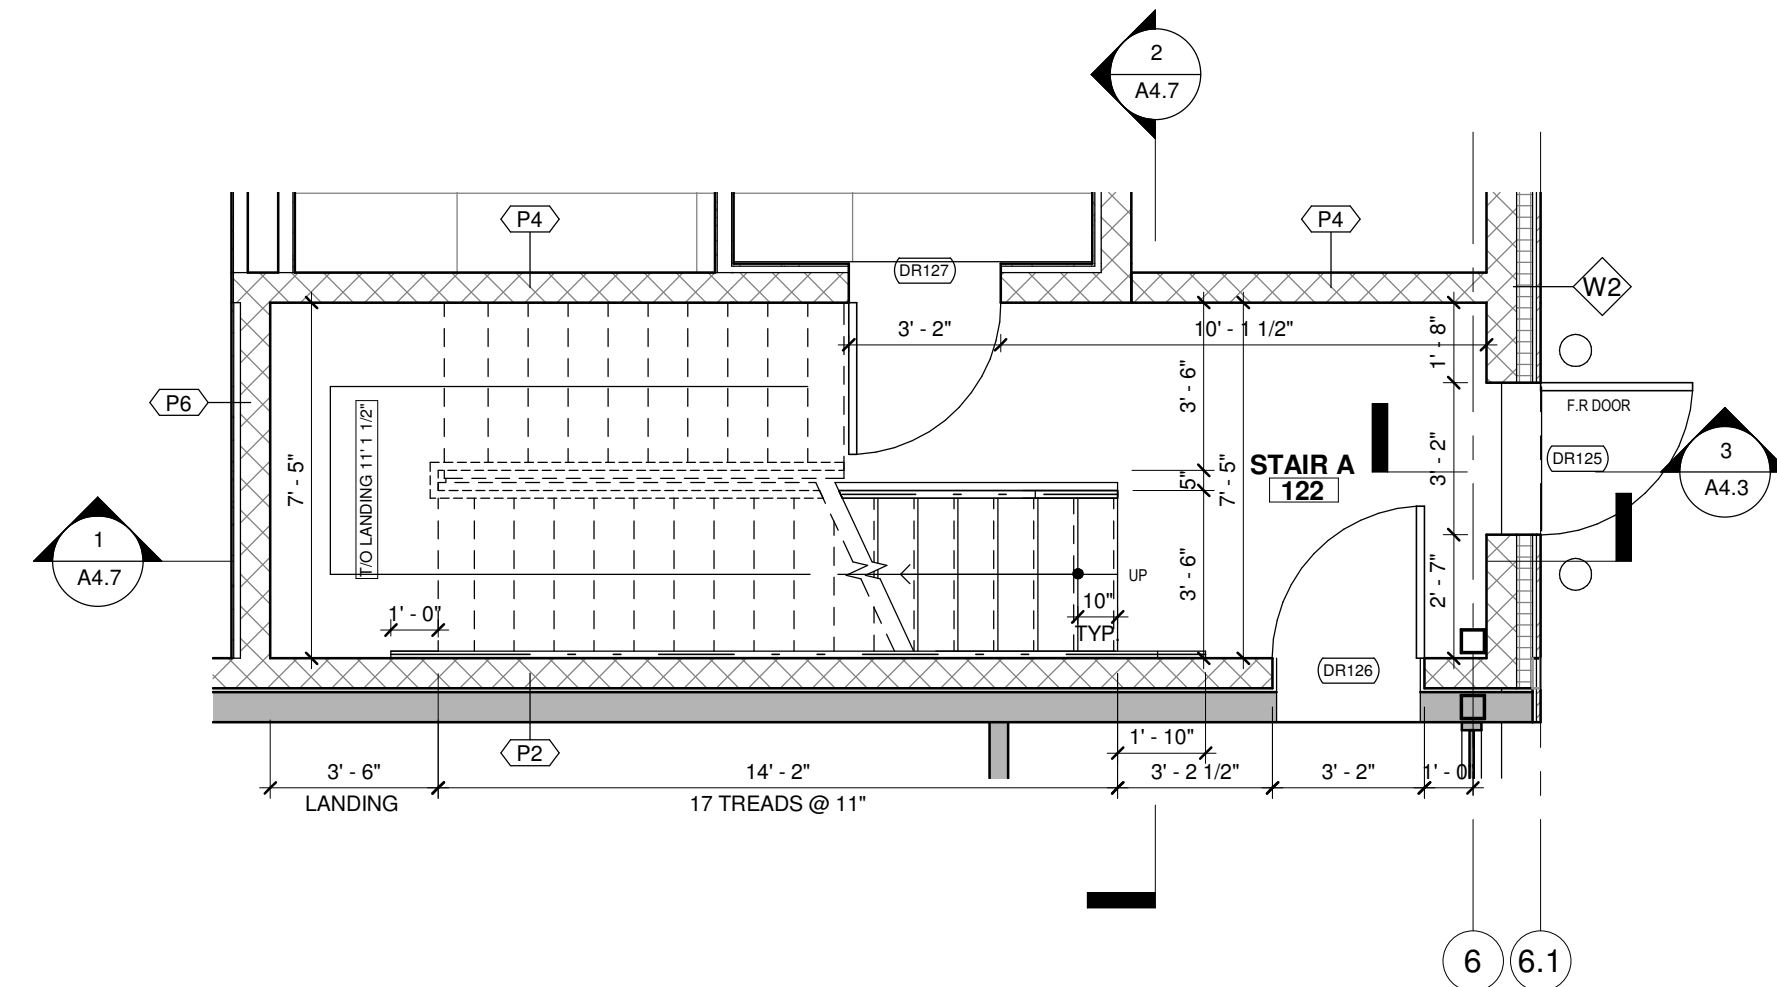


4 STAIR A GROUND FLOOR PLAN
1/4" = 1'-0"

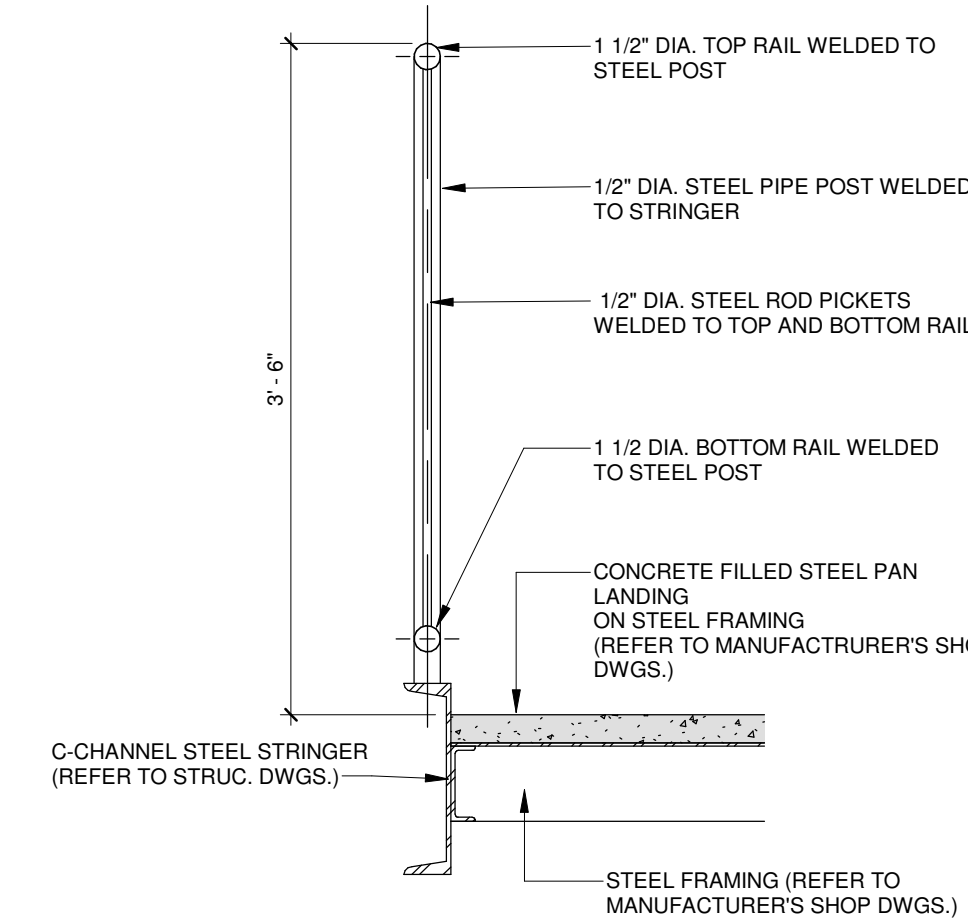


5 SECTION RAILING DETAIL
1" = 1'-0"

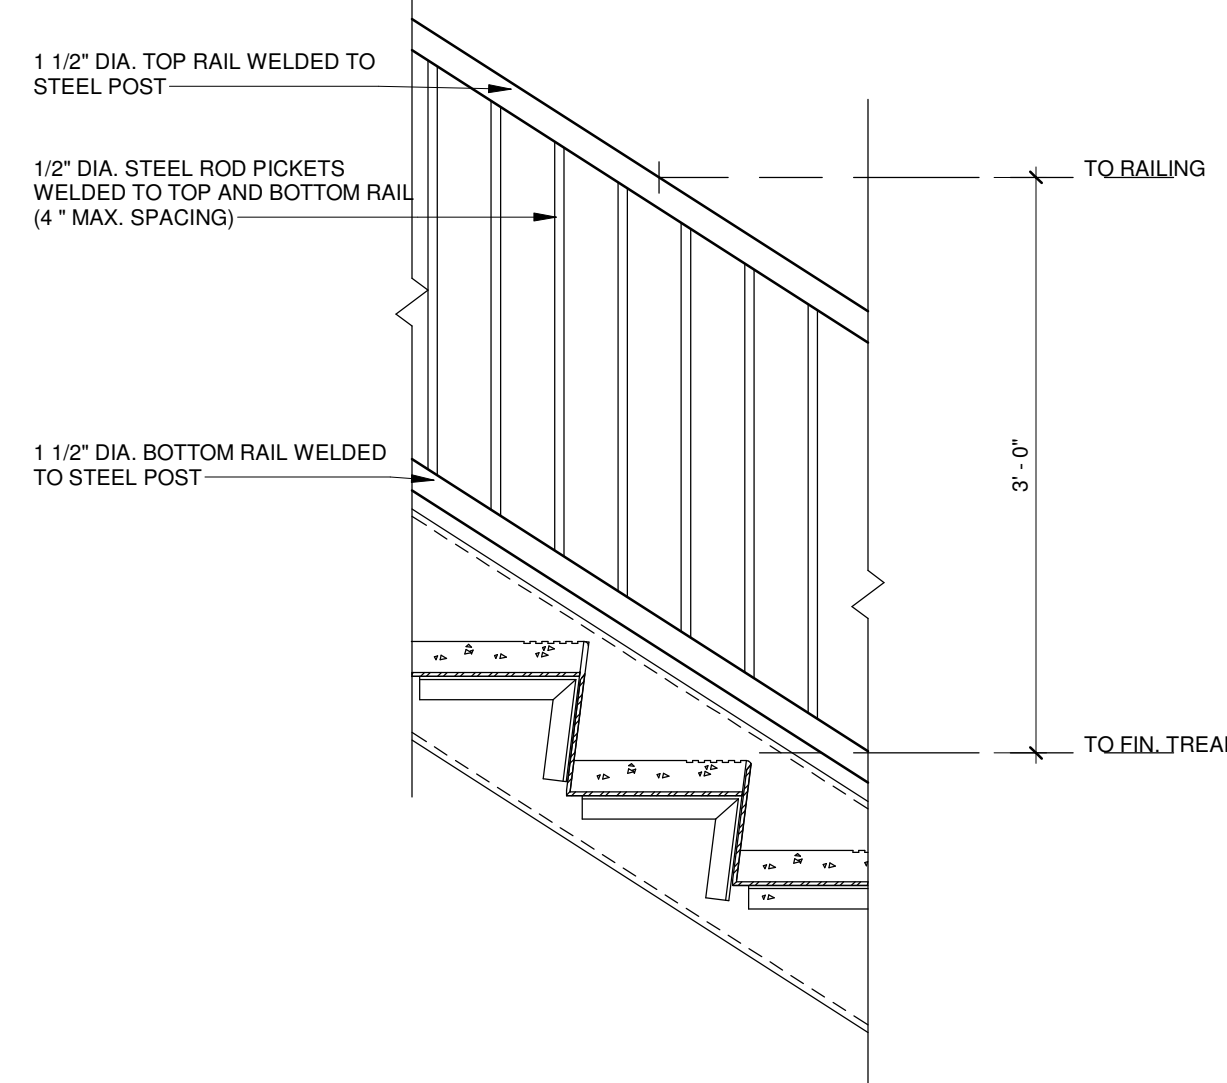

6 RAILING DETAIL
1" = 1'-0"

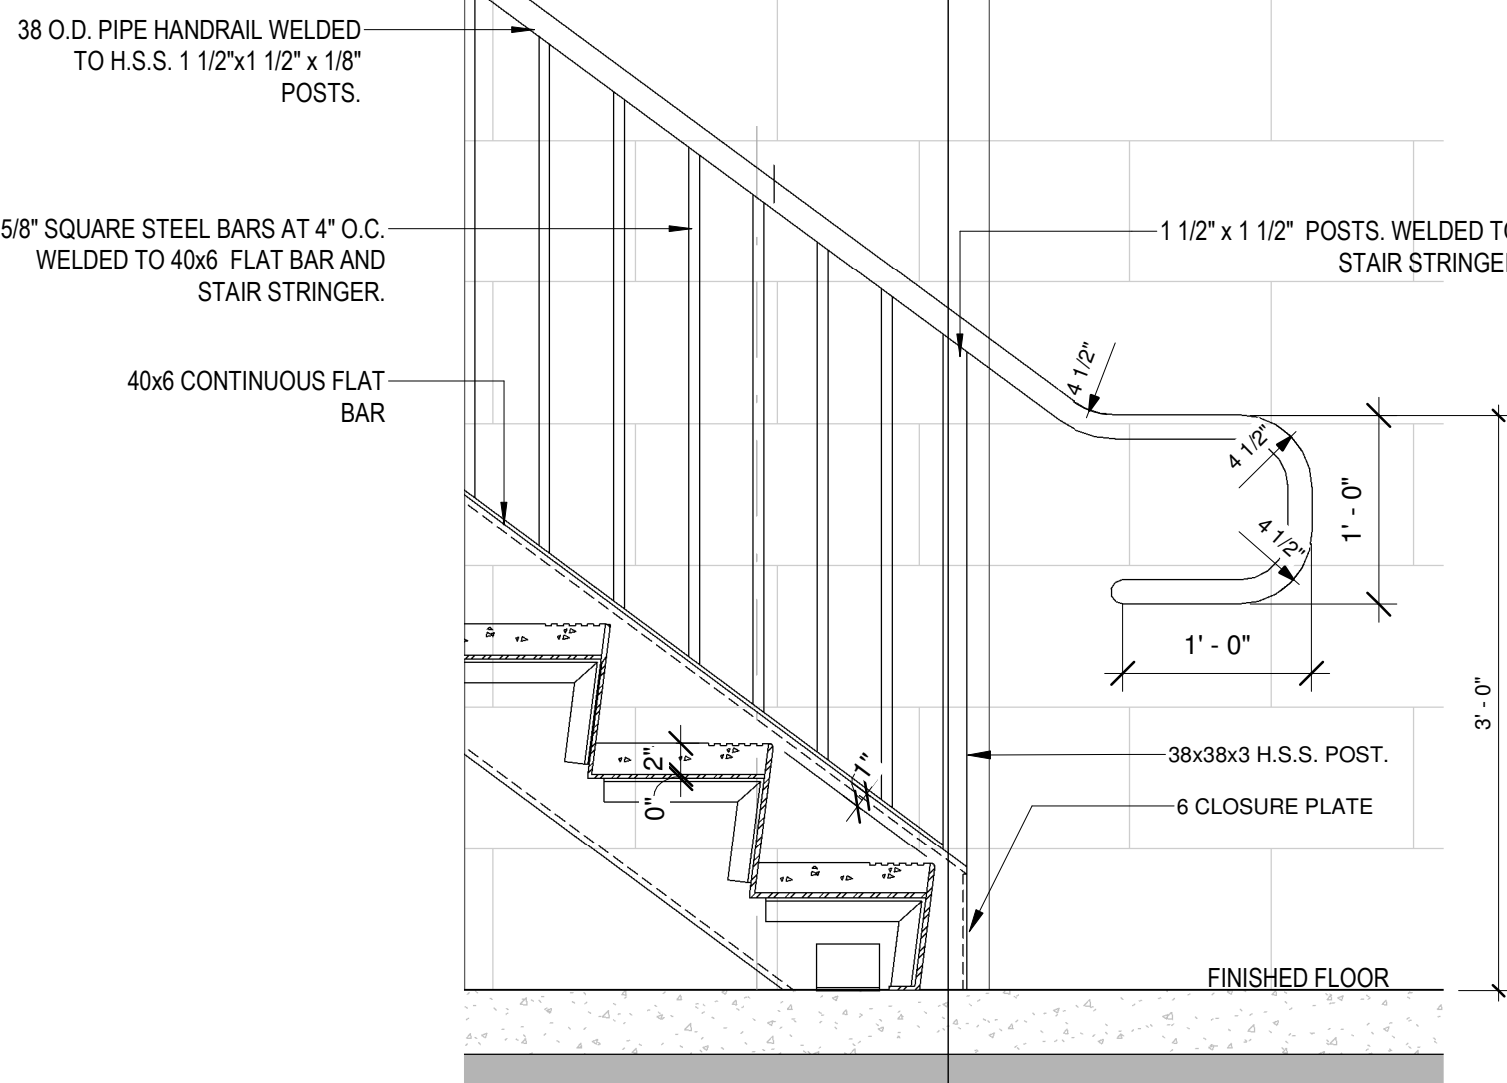

7 STEEL STAIR DETAIL
1" = 1'-0"

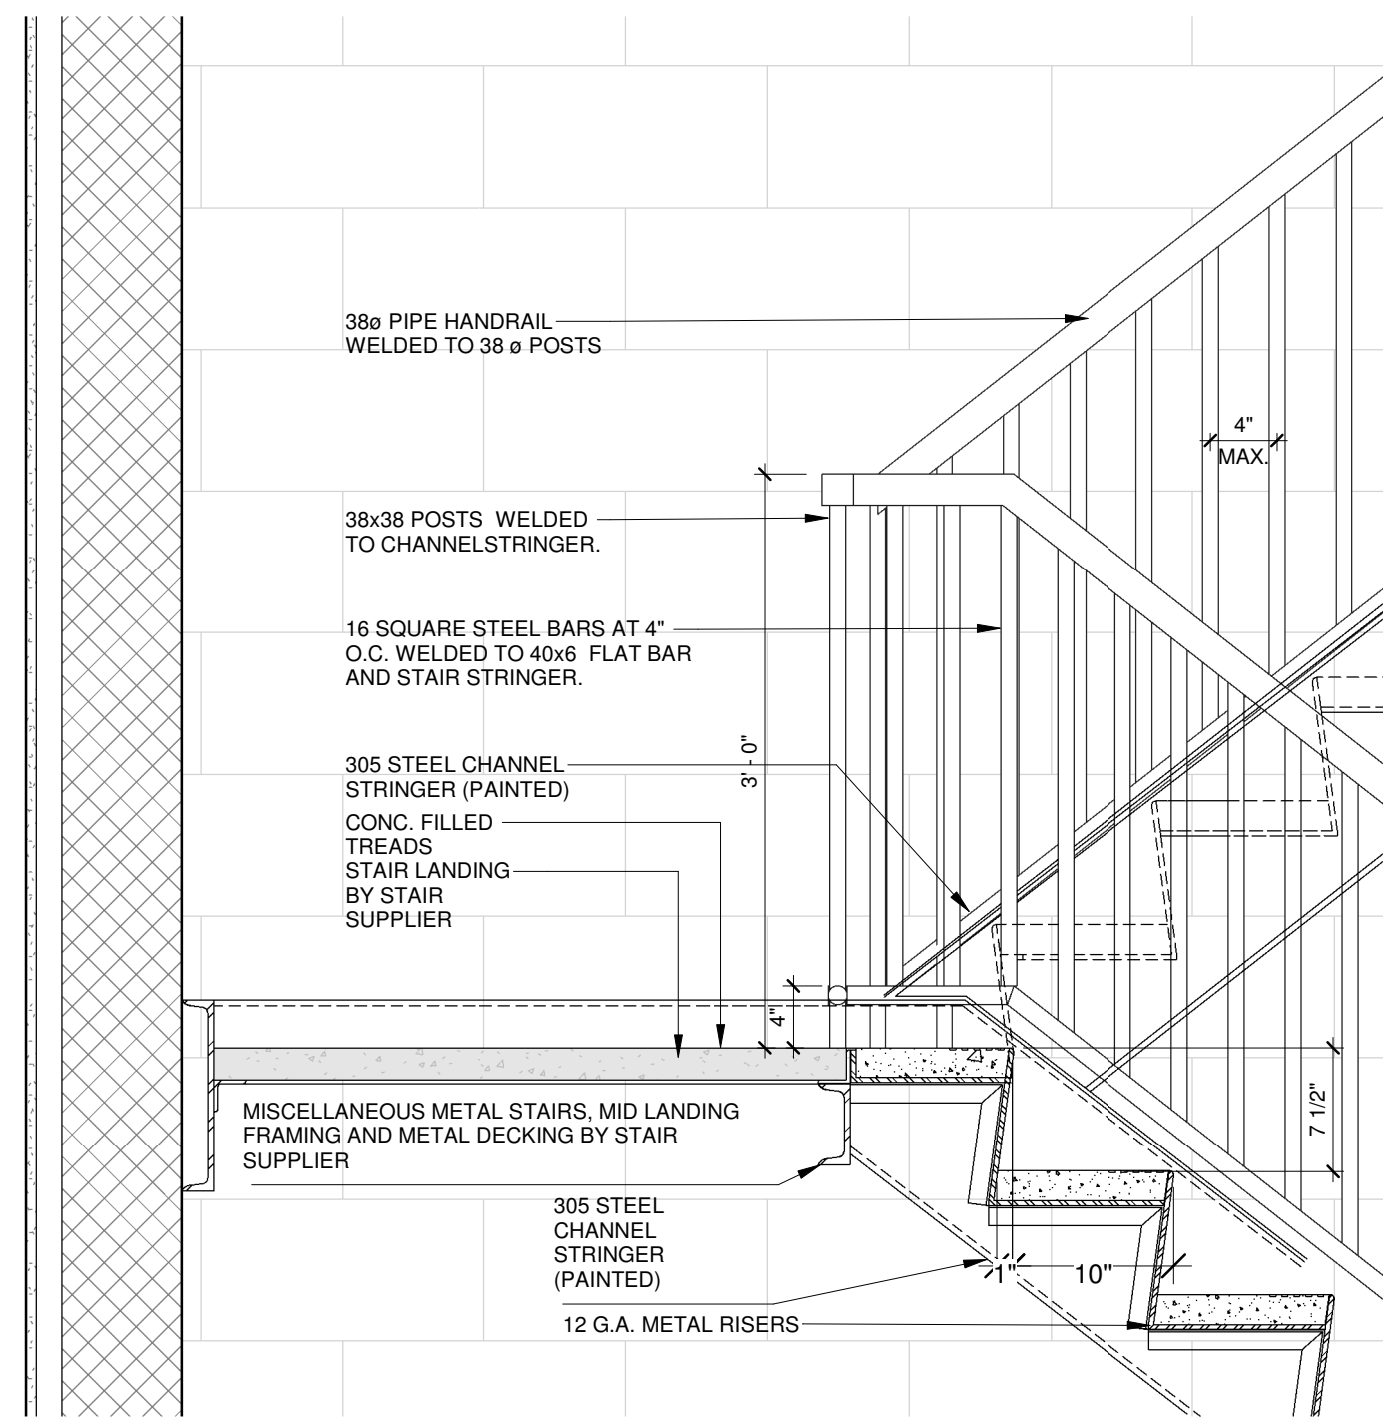

8 STEEL STAIR LANDING DETAIL
1" = 1'-0"

1	05/28/2025	ISSUED FOR PERMIT	HW
No.	Date:	Issued/Revision:	By

Client:

FIREARMS
OUTLET CANADA

W **WANG ARCHITECTS INC.**
3950 14th Ave, Unit 609
Markham, ON L3R 0A9
T: 905-604-6960
E: info@wangarchitects.ca
www.wangarchitects.ca




Project :
FIREARMS OUTLET CANADA


725 WESTNEY RD. S.,
AJAX, ON L1S 7J7

Drawing Name :
STAIR A DETAILS


Scale :	As indicated	Project No :	00026
Drawn by :	JW	Drawing No :	A4.7
Checked by :	HW		

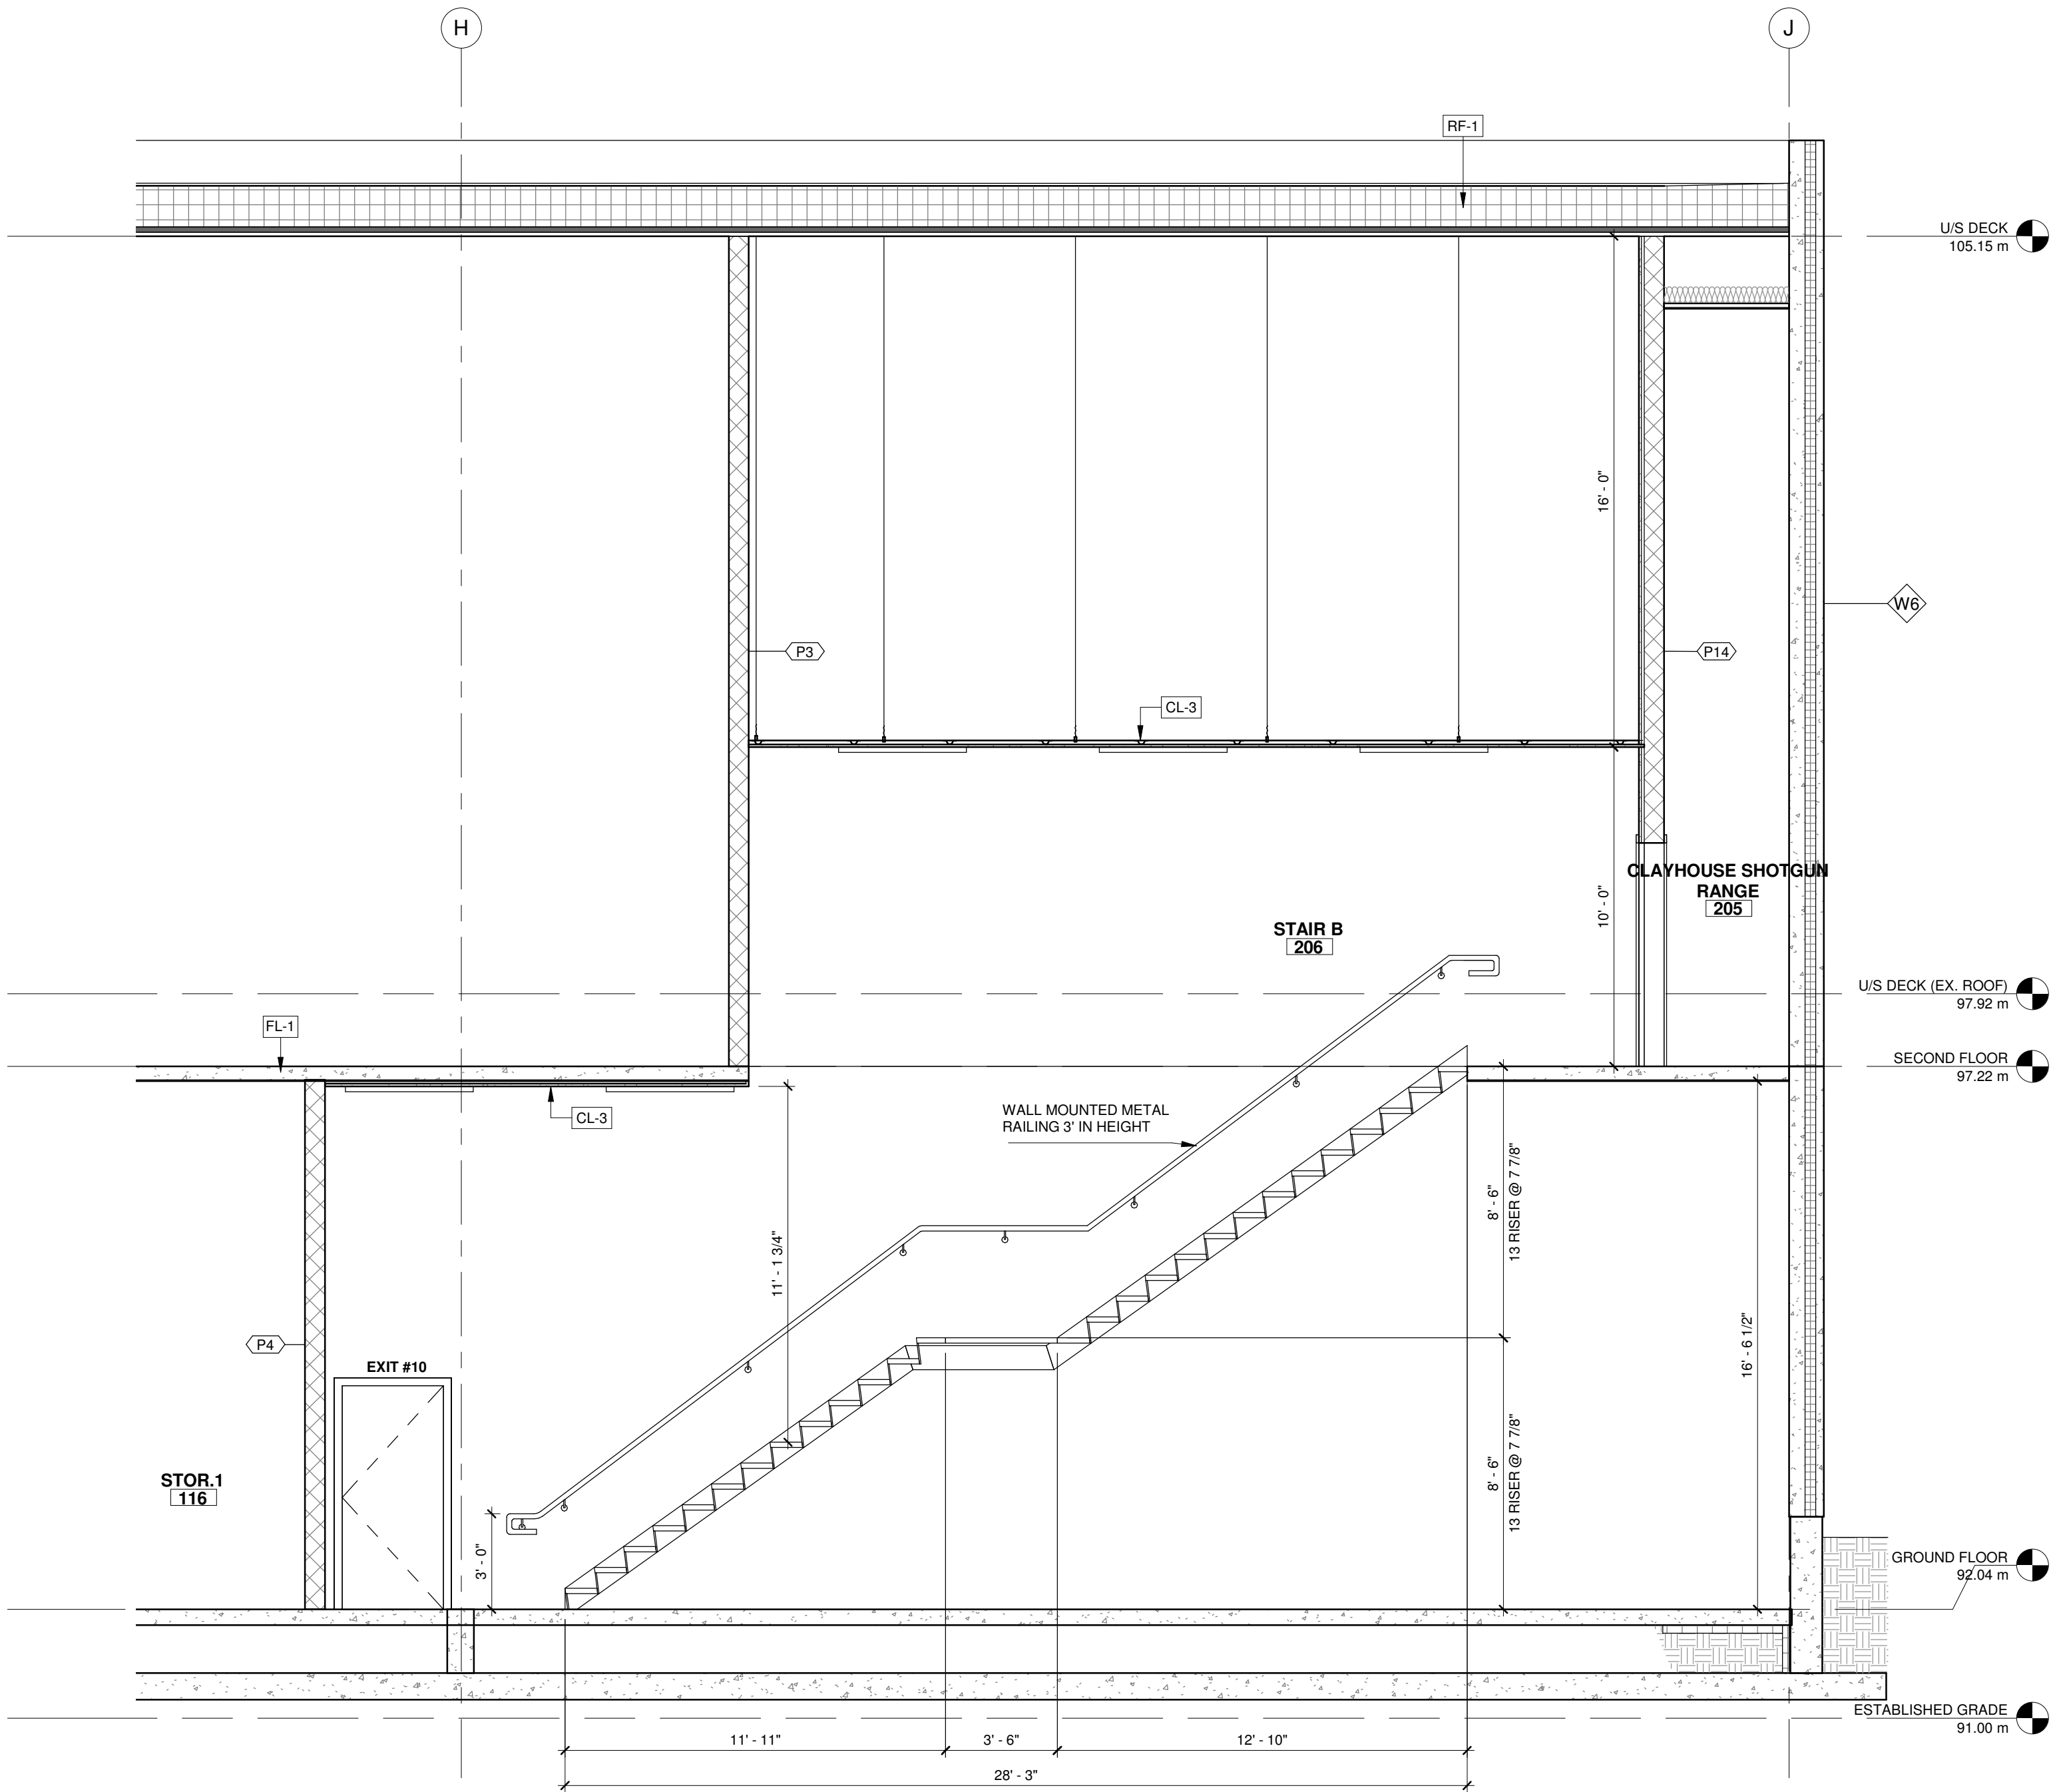


1 STAIR B SECTION
1/4" = 1'-0"

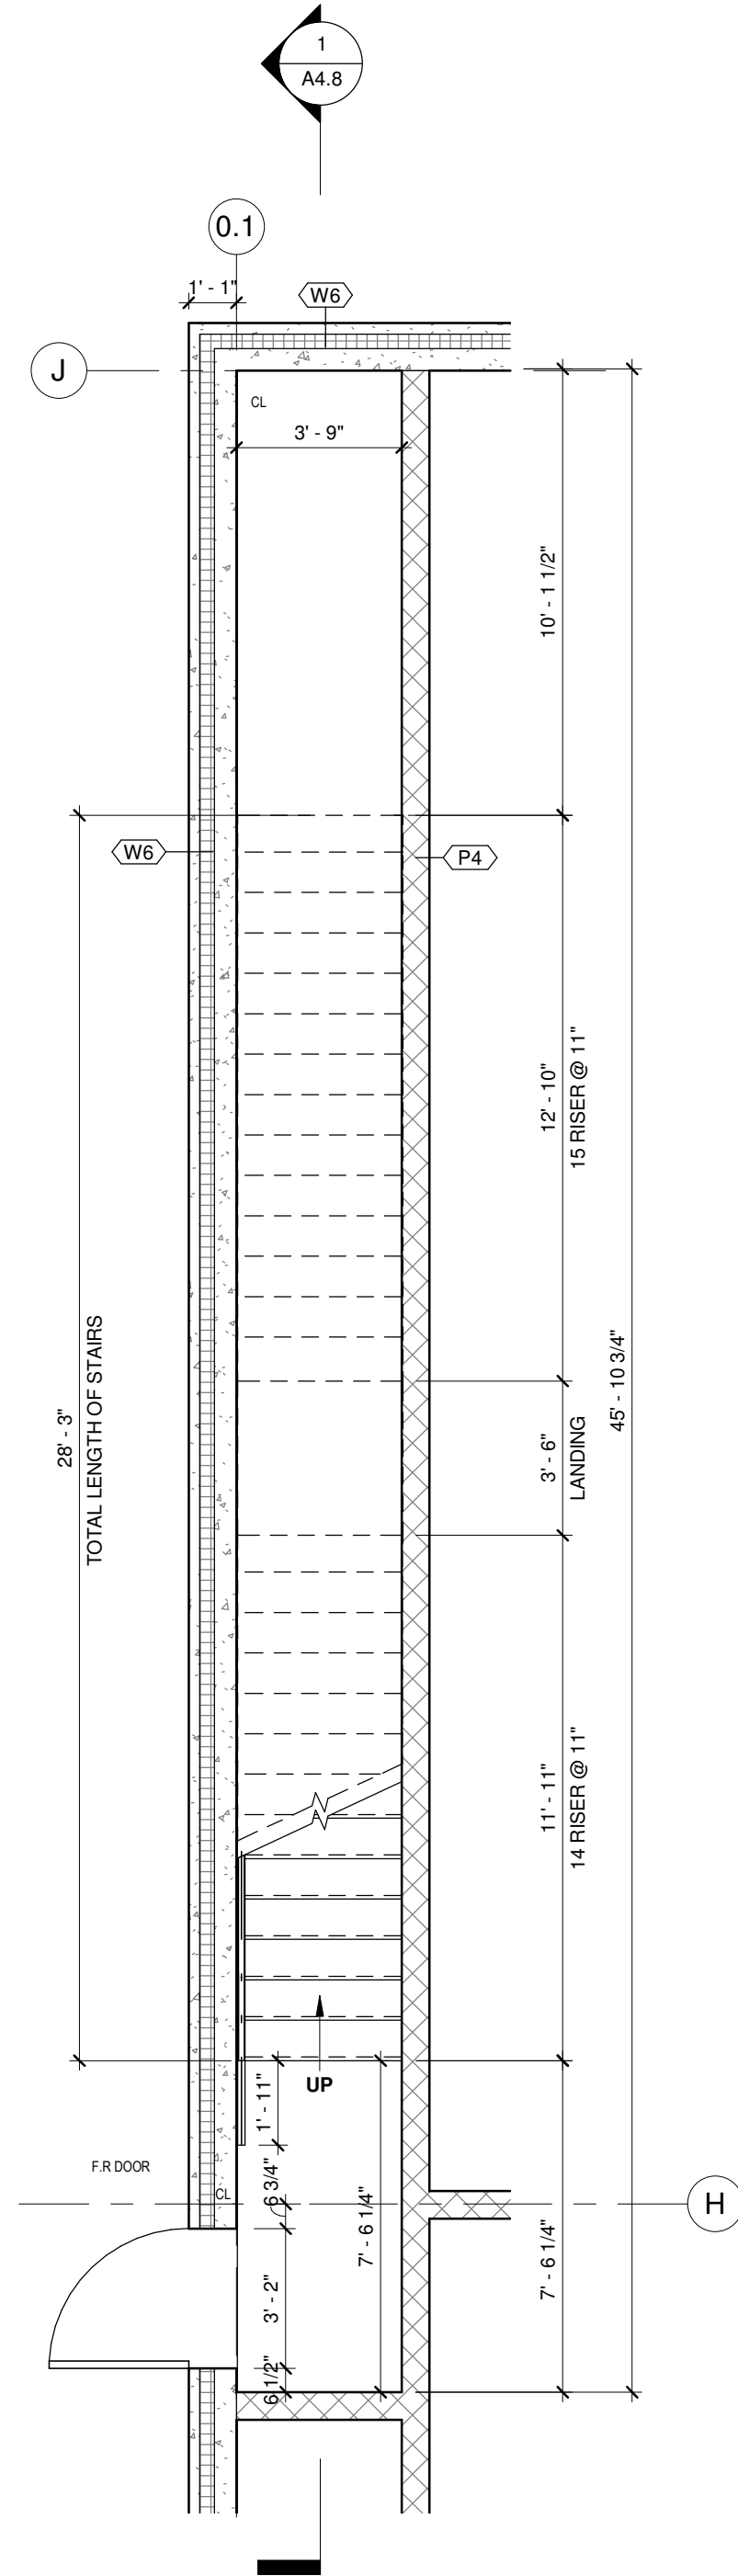

2 STAIR B GROUND FLOOR PLAN
1/4" = 1'-0"

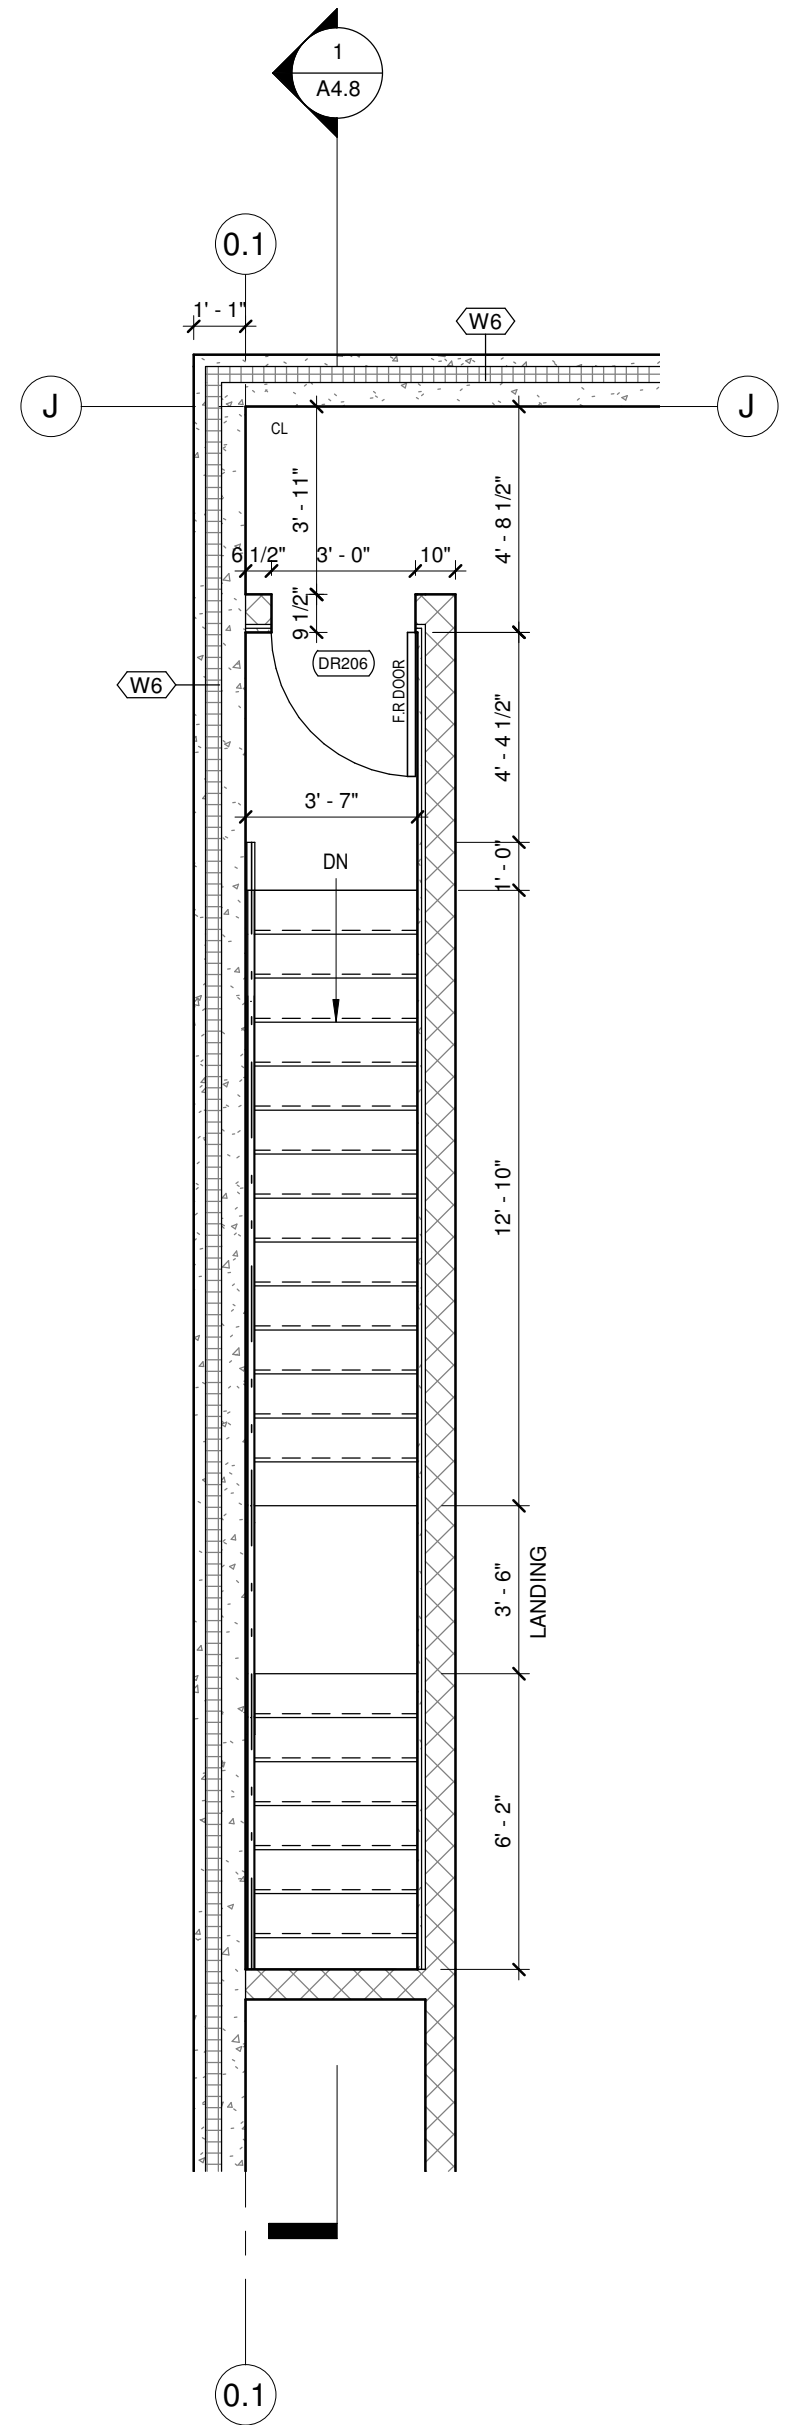

3 STAIR B SECOND FLOOR PLAN
1/4" = 1'-0"

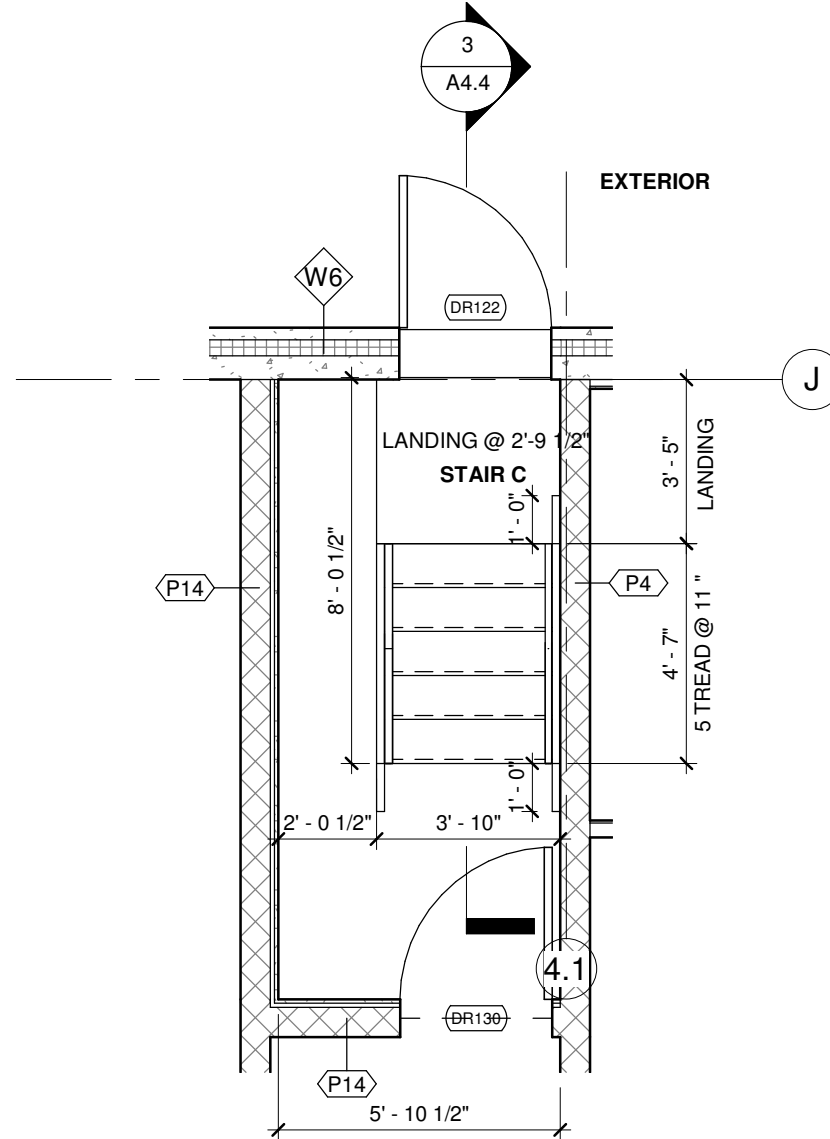

4 STAIR C ENLARGE PLAN
1/4" = 1'-0"

1	05/28/2025	ISSUED FOR PERMIT	HW
No.	Date:	Issued/Revision:	By

Client:

FIREARMS
OUTLET CANADA

W **WANG ARCHITECTS INC.**
3950 14th Ave, Unit 609
Markham, ON L3R 0A9
T: 905-604-6960
E: info@wangarchitects.ca
www.wangarchitects.ca

ONTARIO ASSOCIATION
OF
ARCHITECTS
QING HUA (HENRY) WANG
LICENCE
7675

Project :
FIREARMS OUTLET CANADA

725 WESTNEY RD. S.,
AJAX, ON L1S 7J7


Drawing Name :
STAIR B DETAILS

Scale : 1/4" = 1'-0" Project No : 00026

Drawn by : JW Drawing No :

Checked by : HW


A4.8

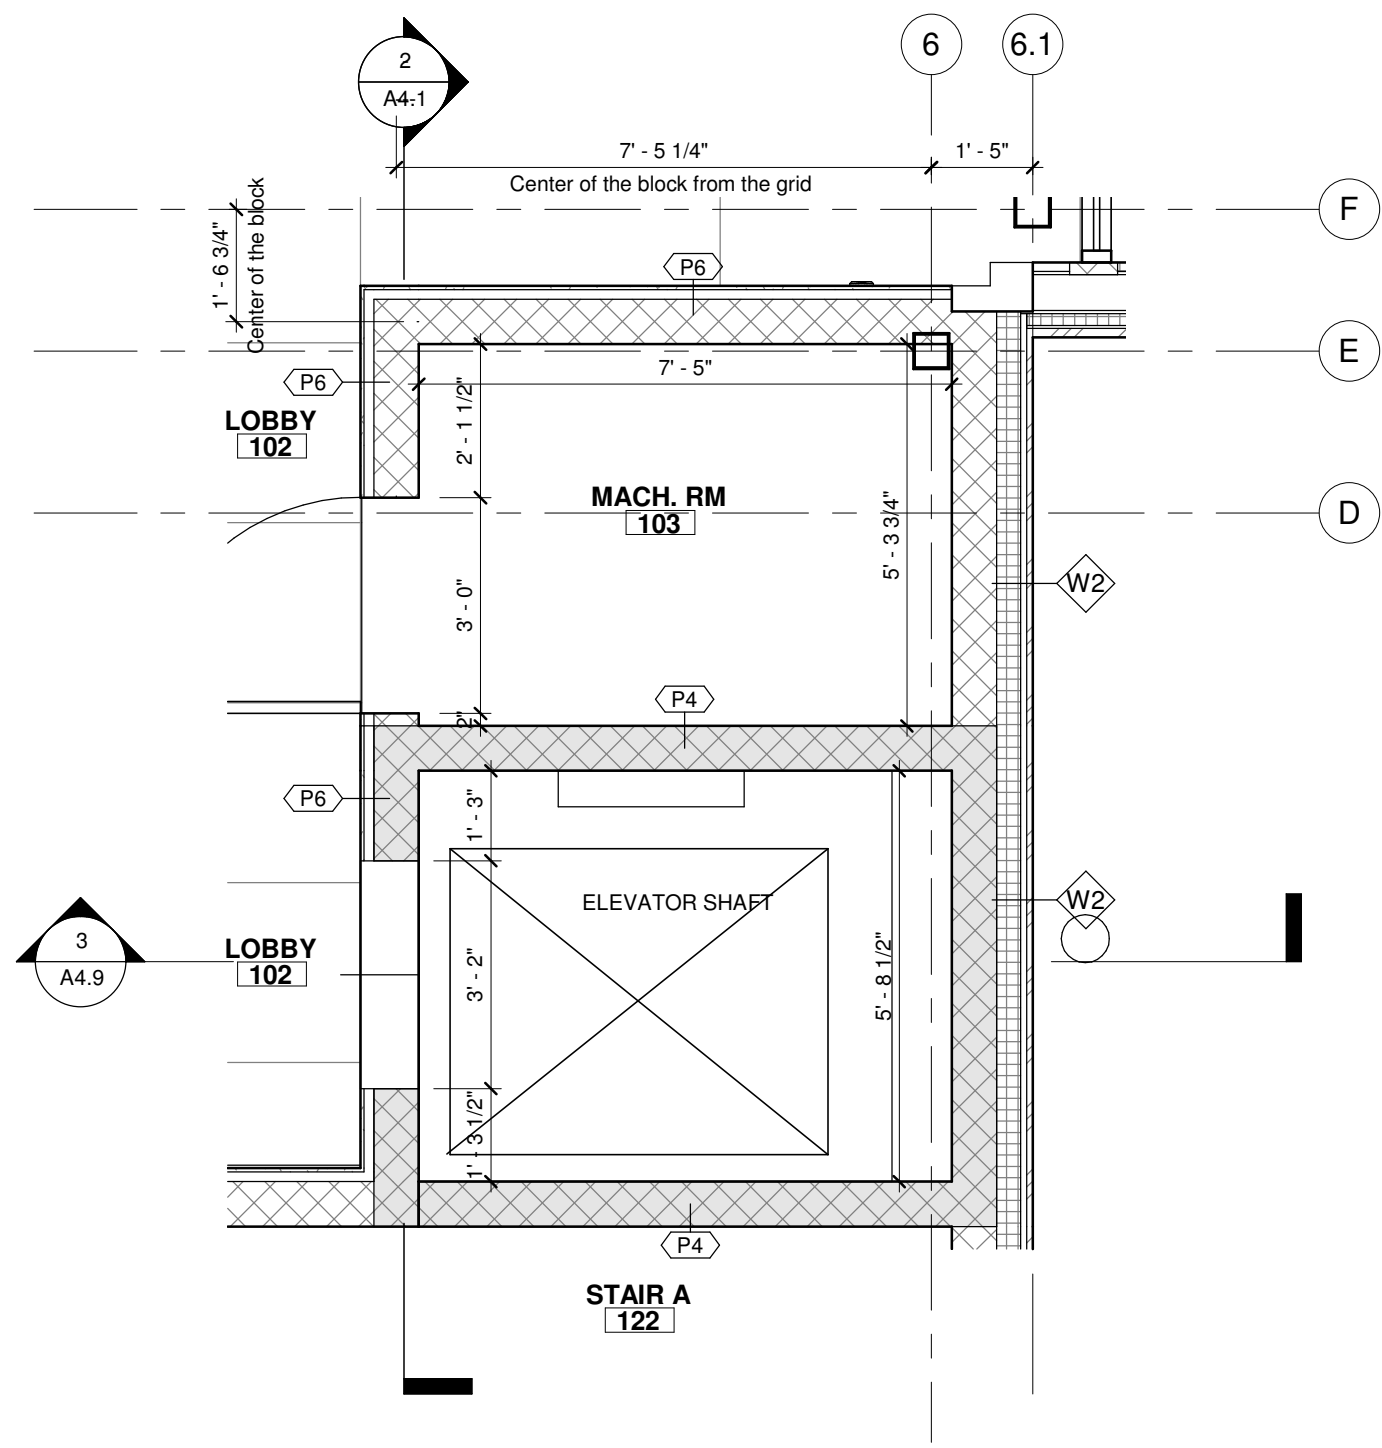


ELEVATOR MANUFACTURE: FEDERAL ELEVATOR
TYPE: SERENUS LULA ELEVATOR - TYPE A LEFT

NOTE:
1. INDICATES DIMENSIONS REQUIRED BY MANUFACTURE'S PRODUCT CUTSHEET.
CONFIRM W/ MANUFACTURE'S PRODUCT CUTSHEET PRIOR TO COMPLETING WORK.
2. REFER TO MANUFACTURE'S SHOP DRAWINGS

1 ENLARGE ELEVATOR PLAN
3/8" = 1'-0"

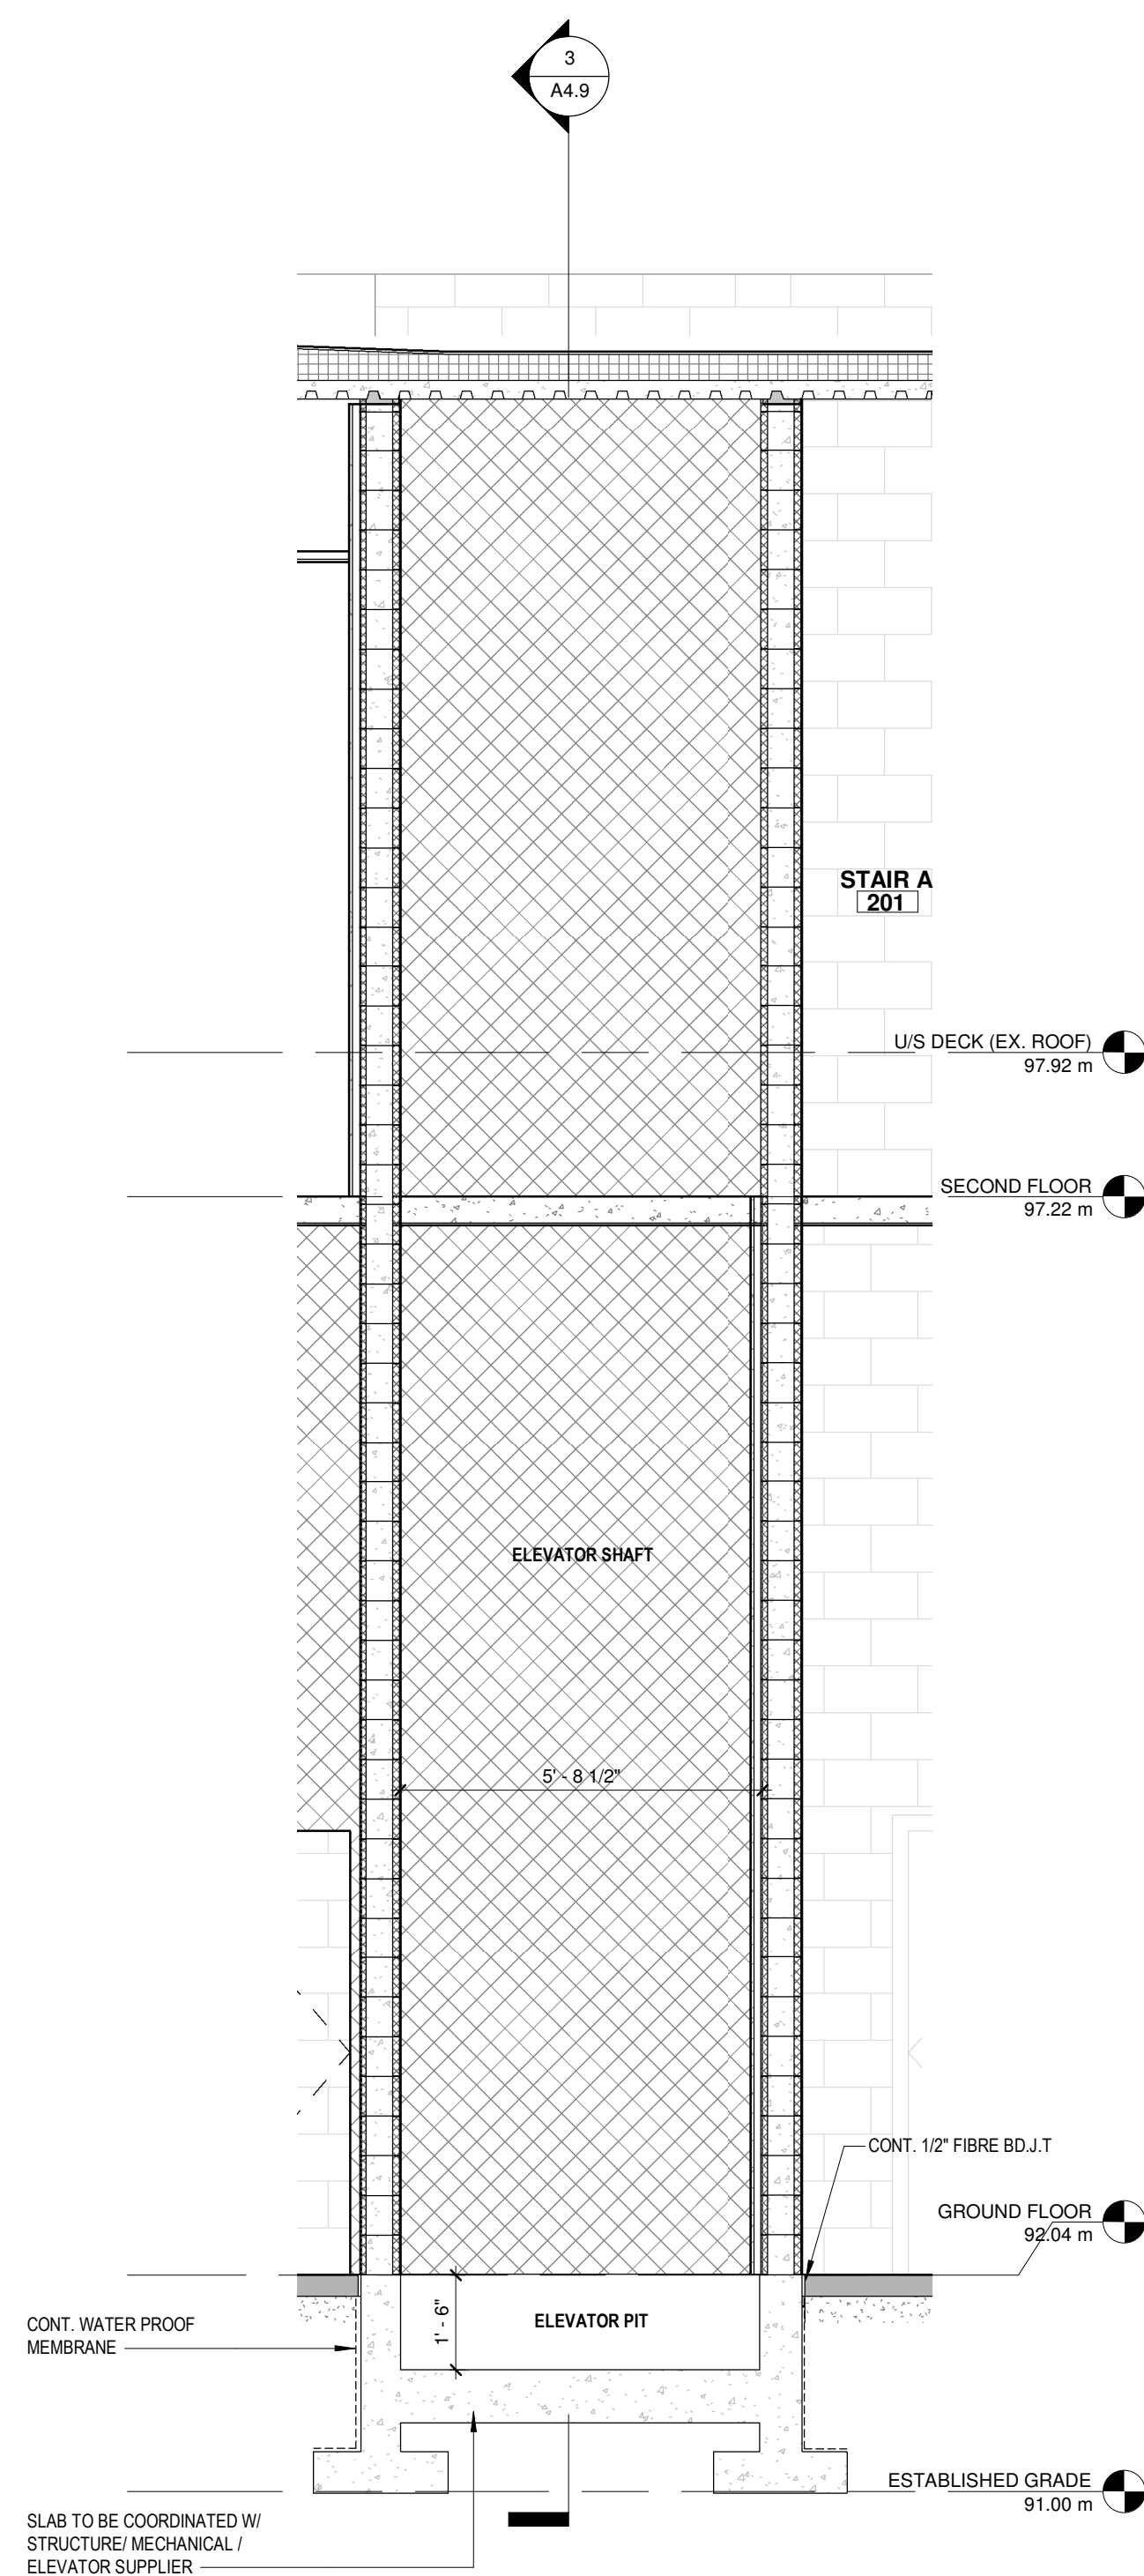

2 BUILDING SECTION 2 - Callout 3
3/8" = 1'-0"

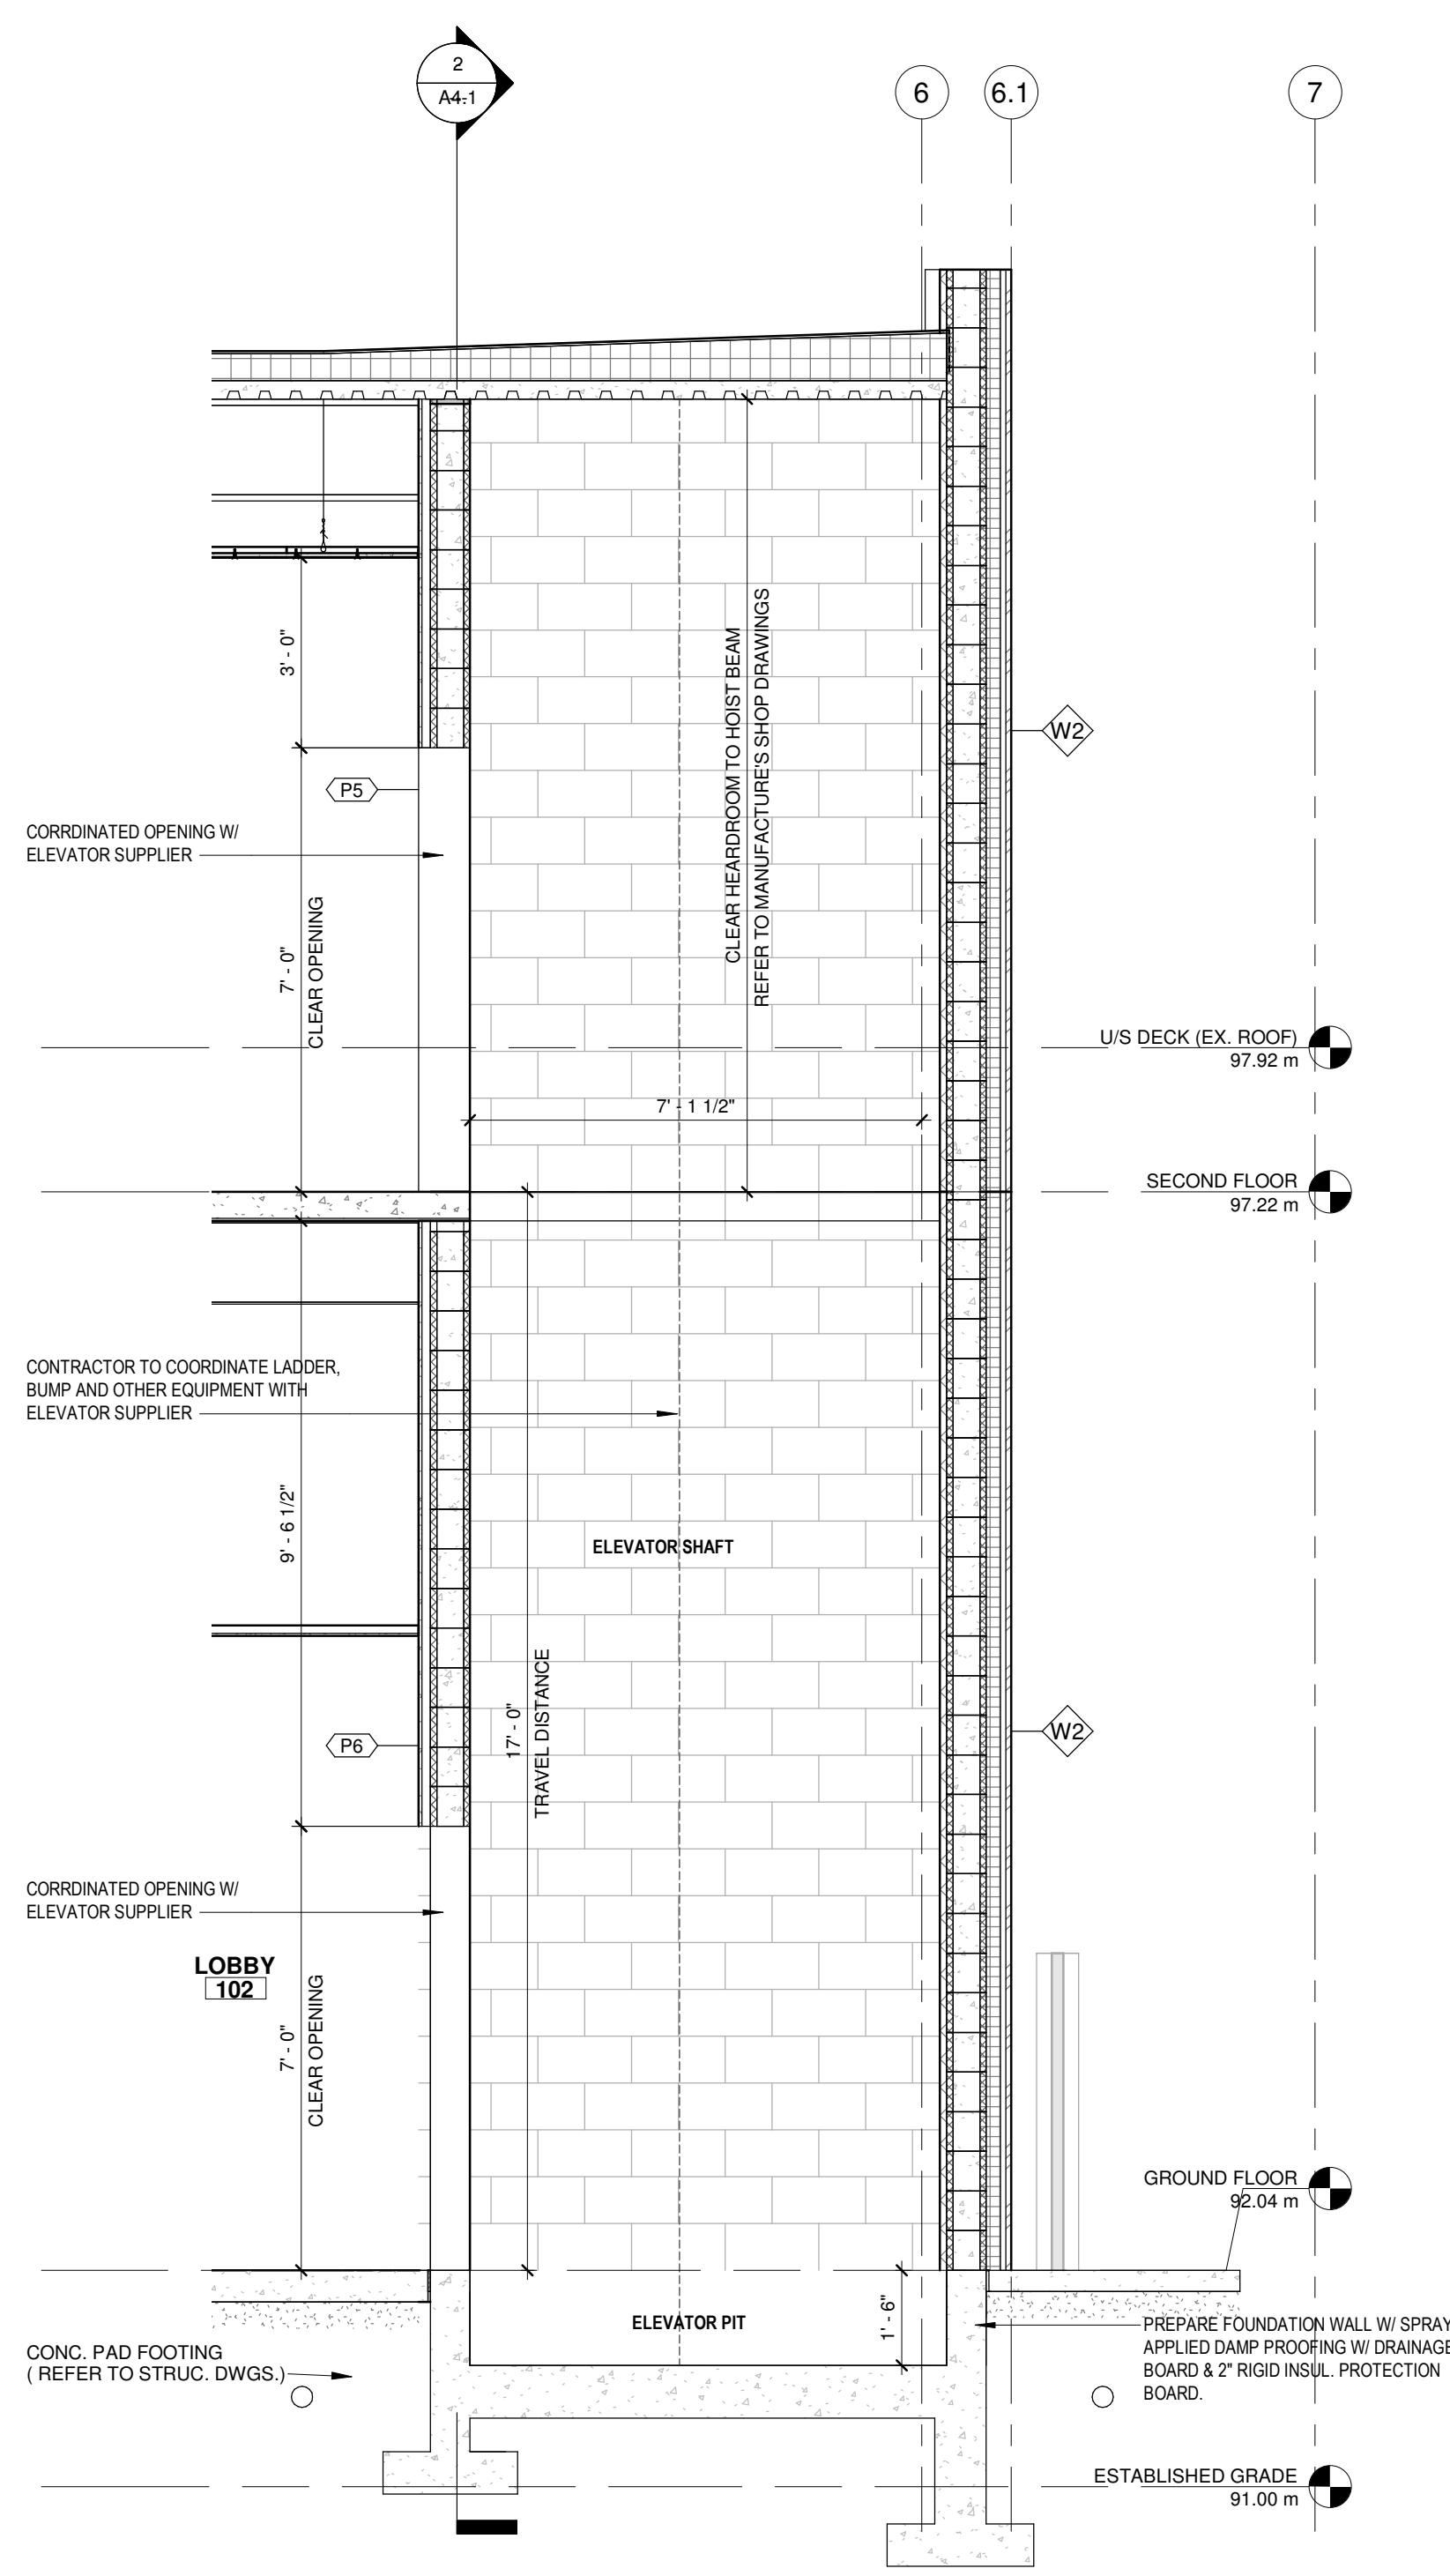

NOTES:
1. REFER TO MANUFACTURE'S SHOP DRAWINGS
NOTE:
REFER TO MECH. DWGS. FOR PIT DRAIN

3 ELEVATOR SECTION
3/8" = 1'-0"

1	05/28/2025	ISSUED FOR PERMIT	HW
No.	Date:	Issued/Revision:	By

Client:

FIREARMS
OUTLET CANADA

W **WANG ARCHITECTS INC.**
3950 14th Ave, Unit 609
Markham, ON L3R 0A9
T: 905-604-6960
E: info@wangarchitects.ca
www.wangarchitects.ca



Project :
FIREARMS OUTLET CANADA

725 WESTNEY RD. S.,
AJAX, ON L1S 7J7




Drawing Name :
ELEVATOR SHAFT SECTION

Scale : 3/8" = 1'-0" Project No : 00026

Drawn by : JW Drawing No :

Checked by : HW

A4.9

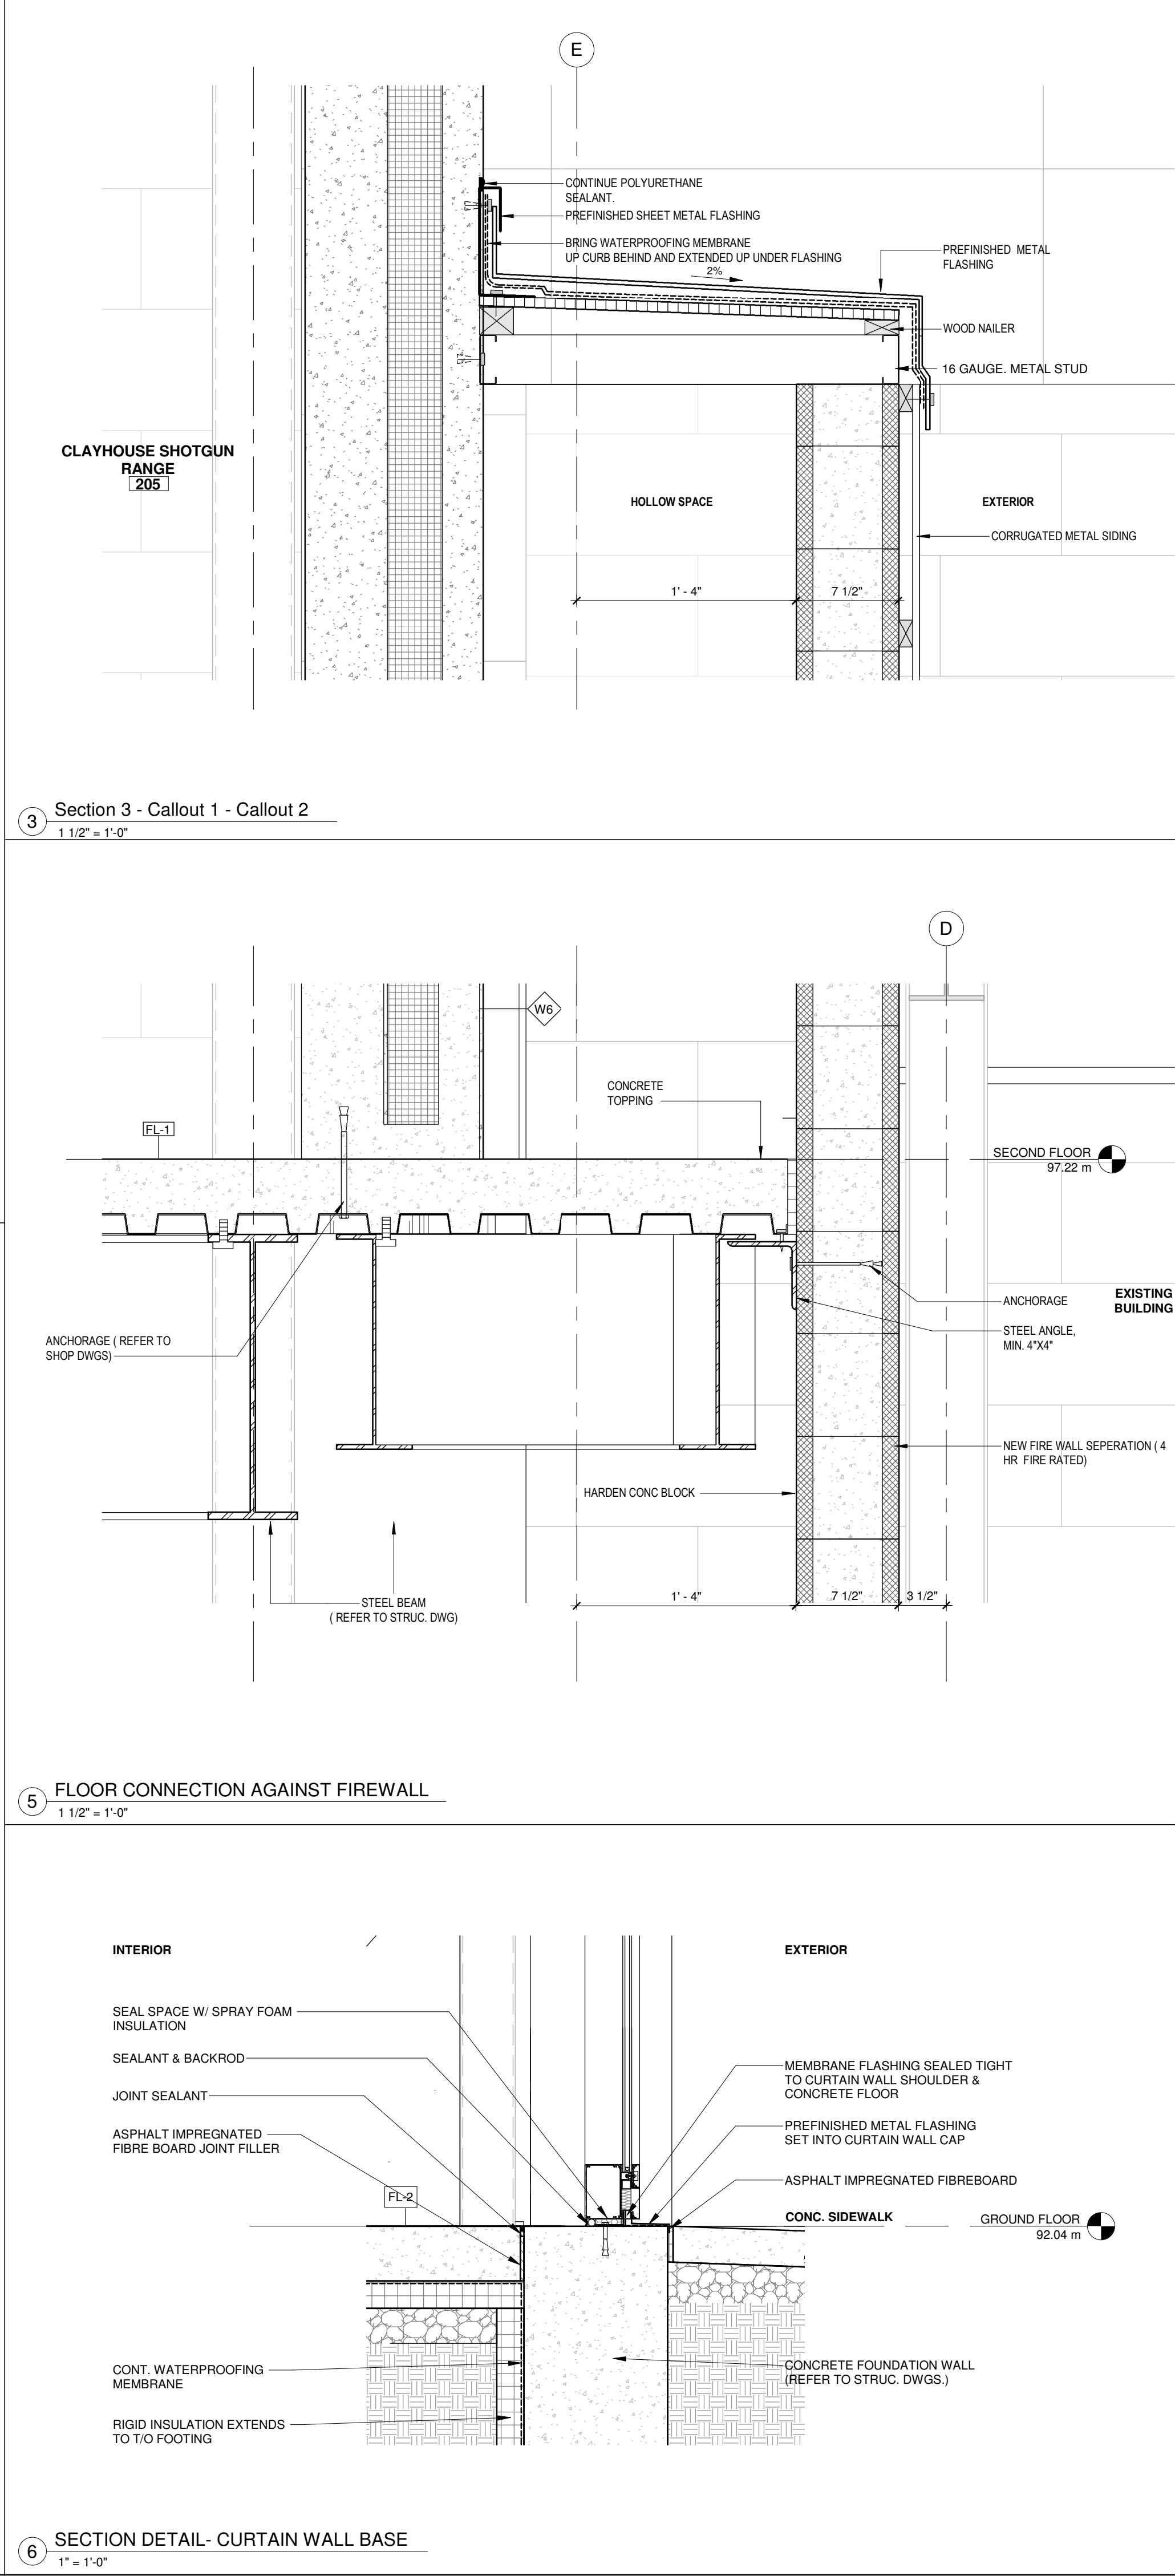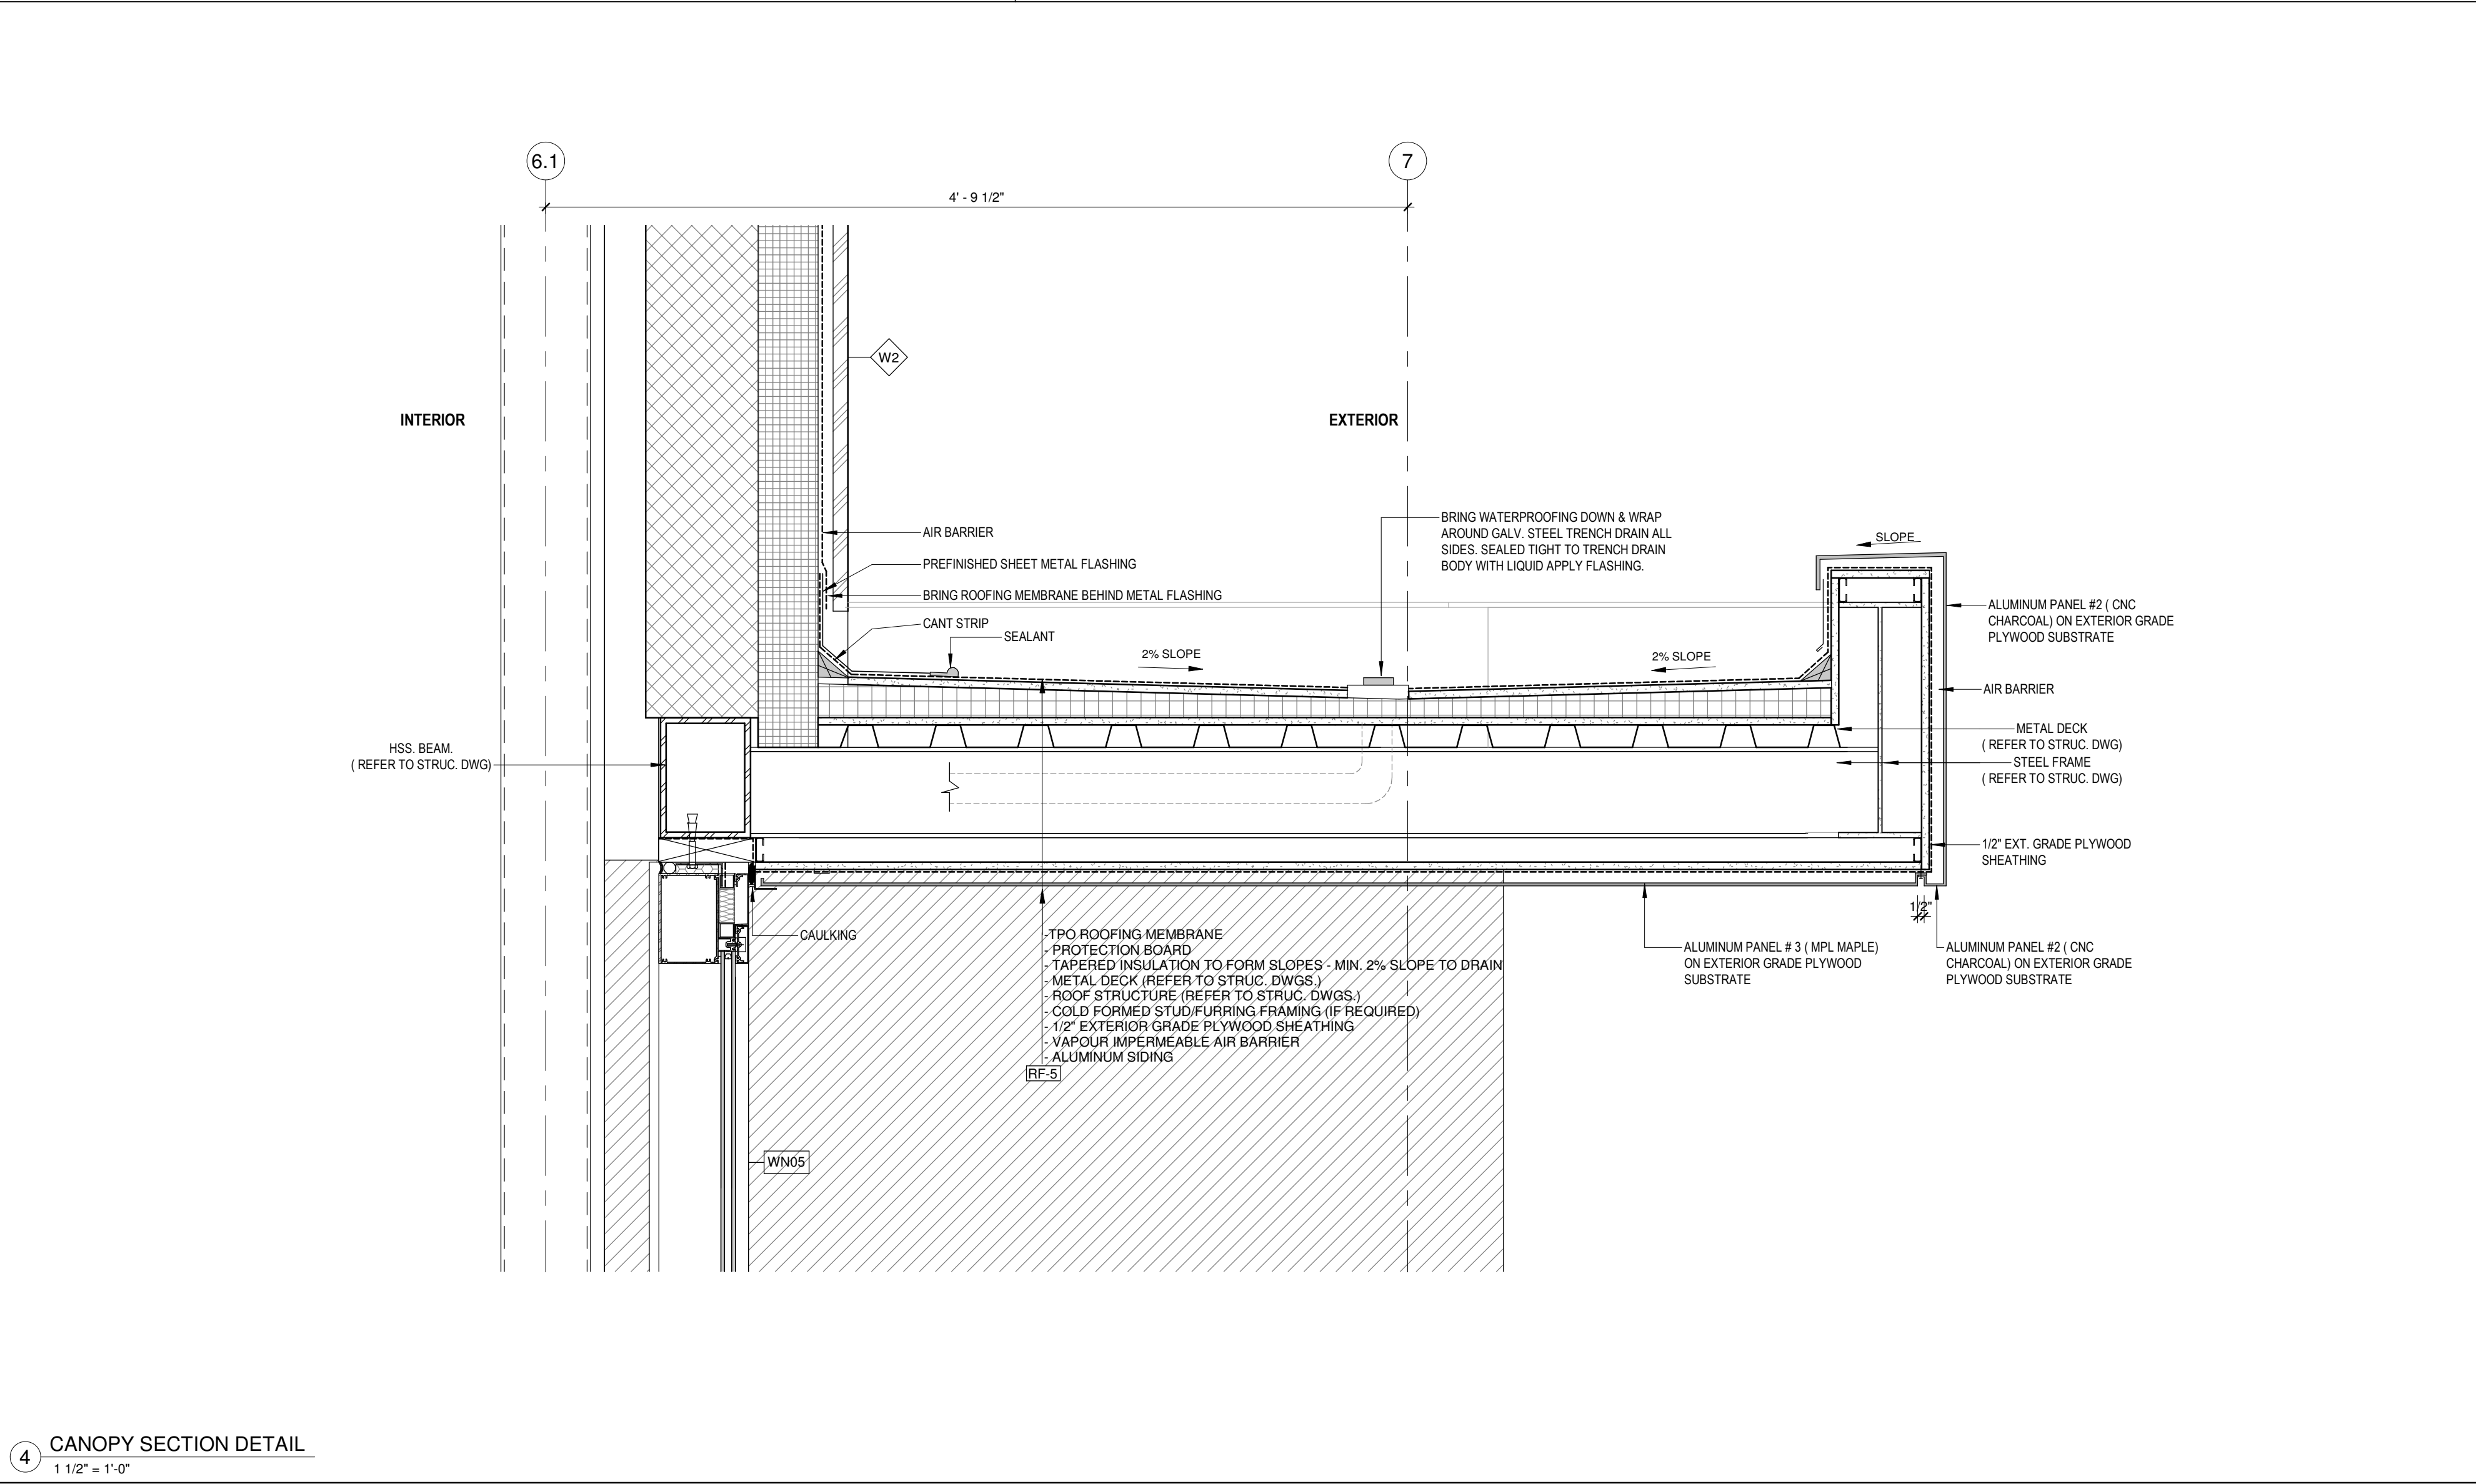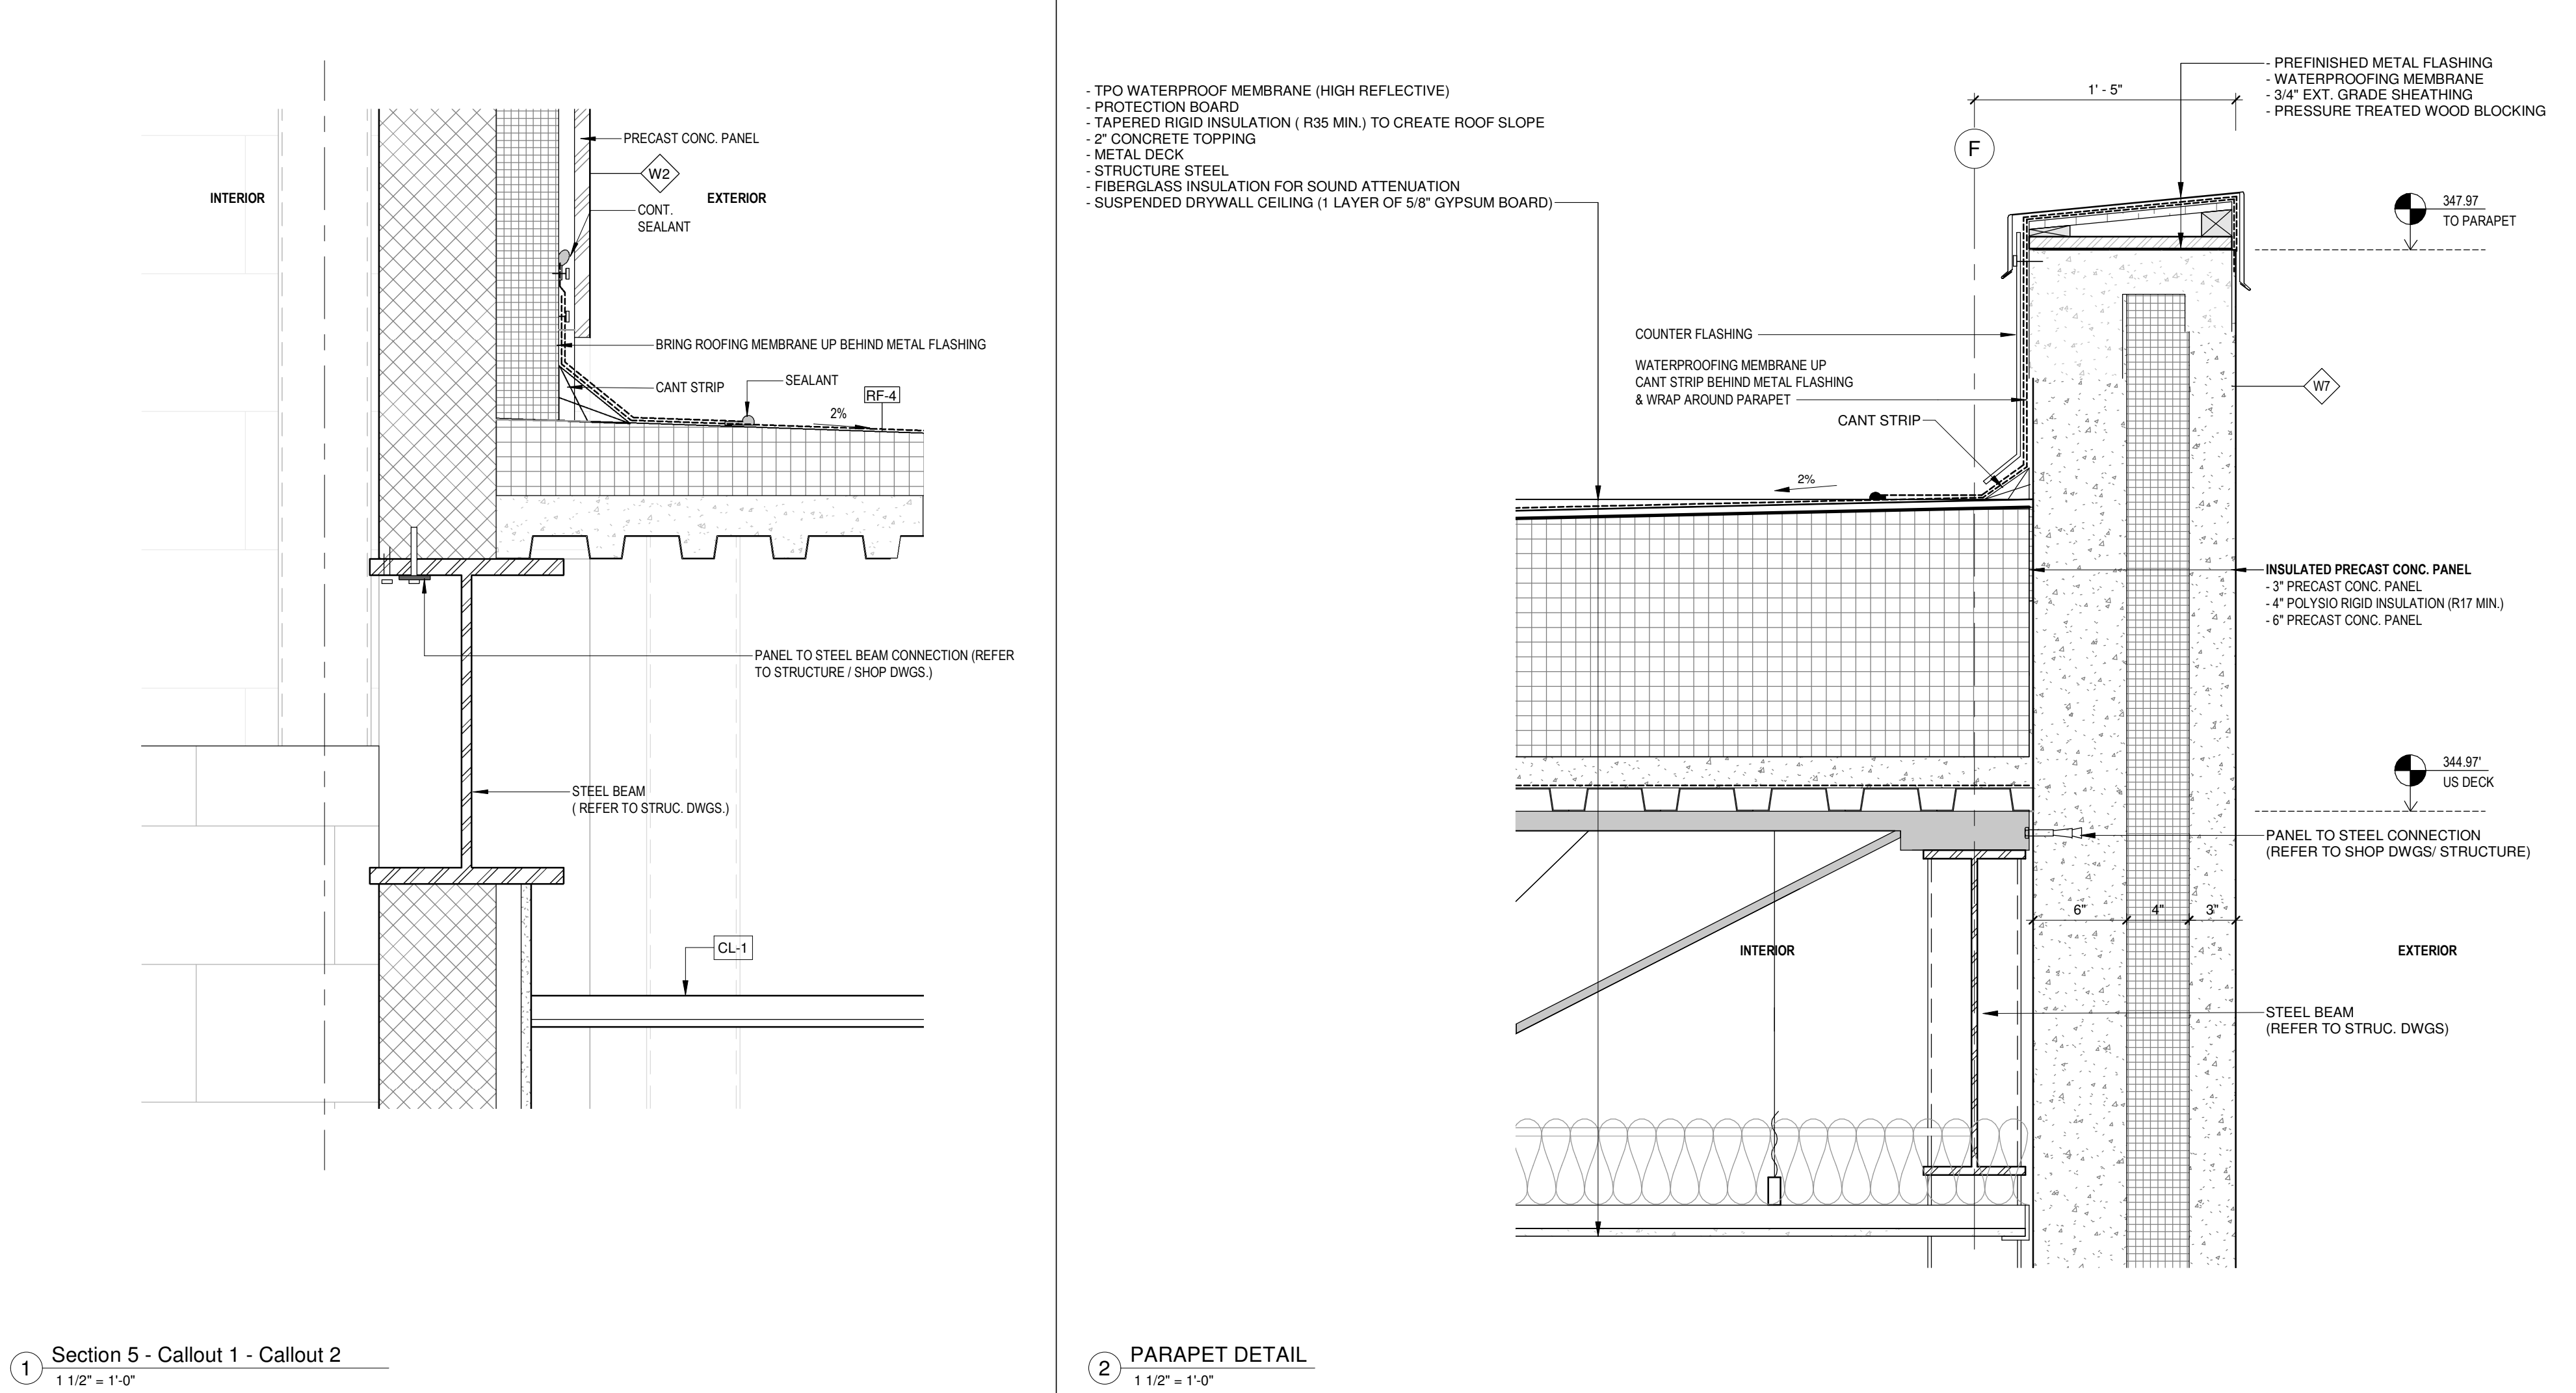

1	05/28/2025	ISSUED FOR PERMIT	HW
No.	Date:	Issued/Revision:	By
Client:			

FIREARMS OUTLET CANADA

WANG ARCHITECTS INC.
3950 14th Ave, Unit 609
Markham, ON L3R 0A9
T: 905-604-6960
E: info@wangarchitects.ca
www.wangarchitects.ca

ONTARIO ASSOCIATION OF ARCHITECTS
LI QING HUA (HENRY) WANG
LICENCE 7675














Project : FIREARMS OUTLET CANADA


725 WESTNEY RD. S.,
AJAX, ON L1S 7J7

Drawing Name : WALL SECTION DETAILS


Scale :	As indicated	Project No :	00026
Drawn by :	JW	Drawing No :	A5.1
Checked by :	HW		

C:\Users\Henry\Documents\725 Westney Rd S - WORKING DRAWING- TENDER Henry.v4

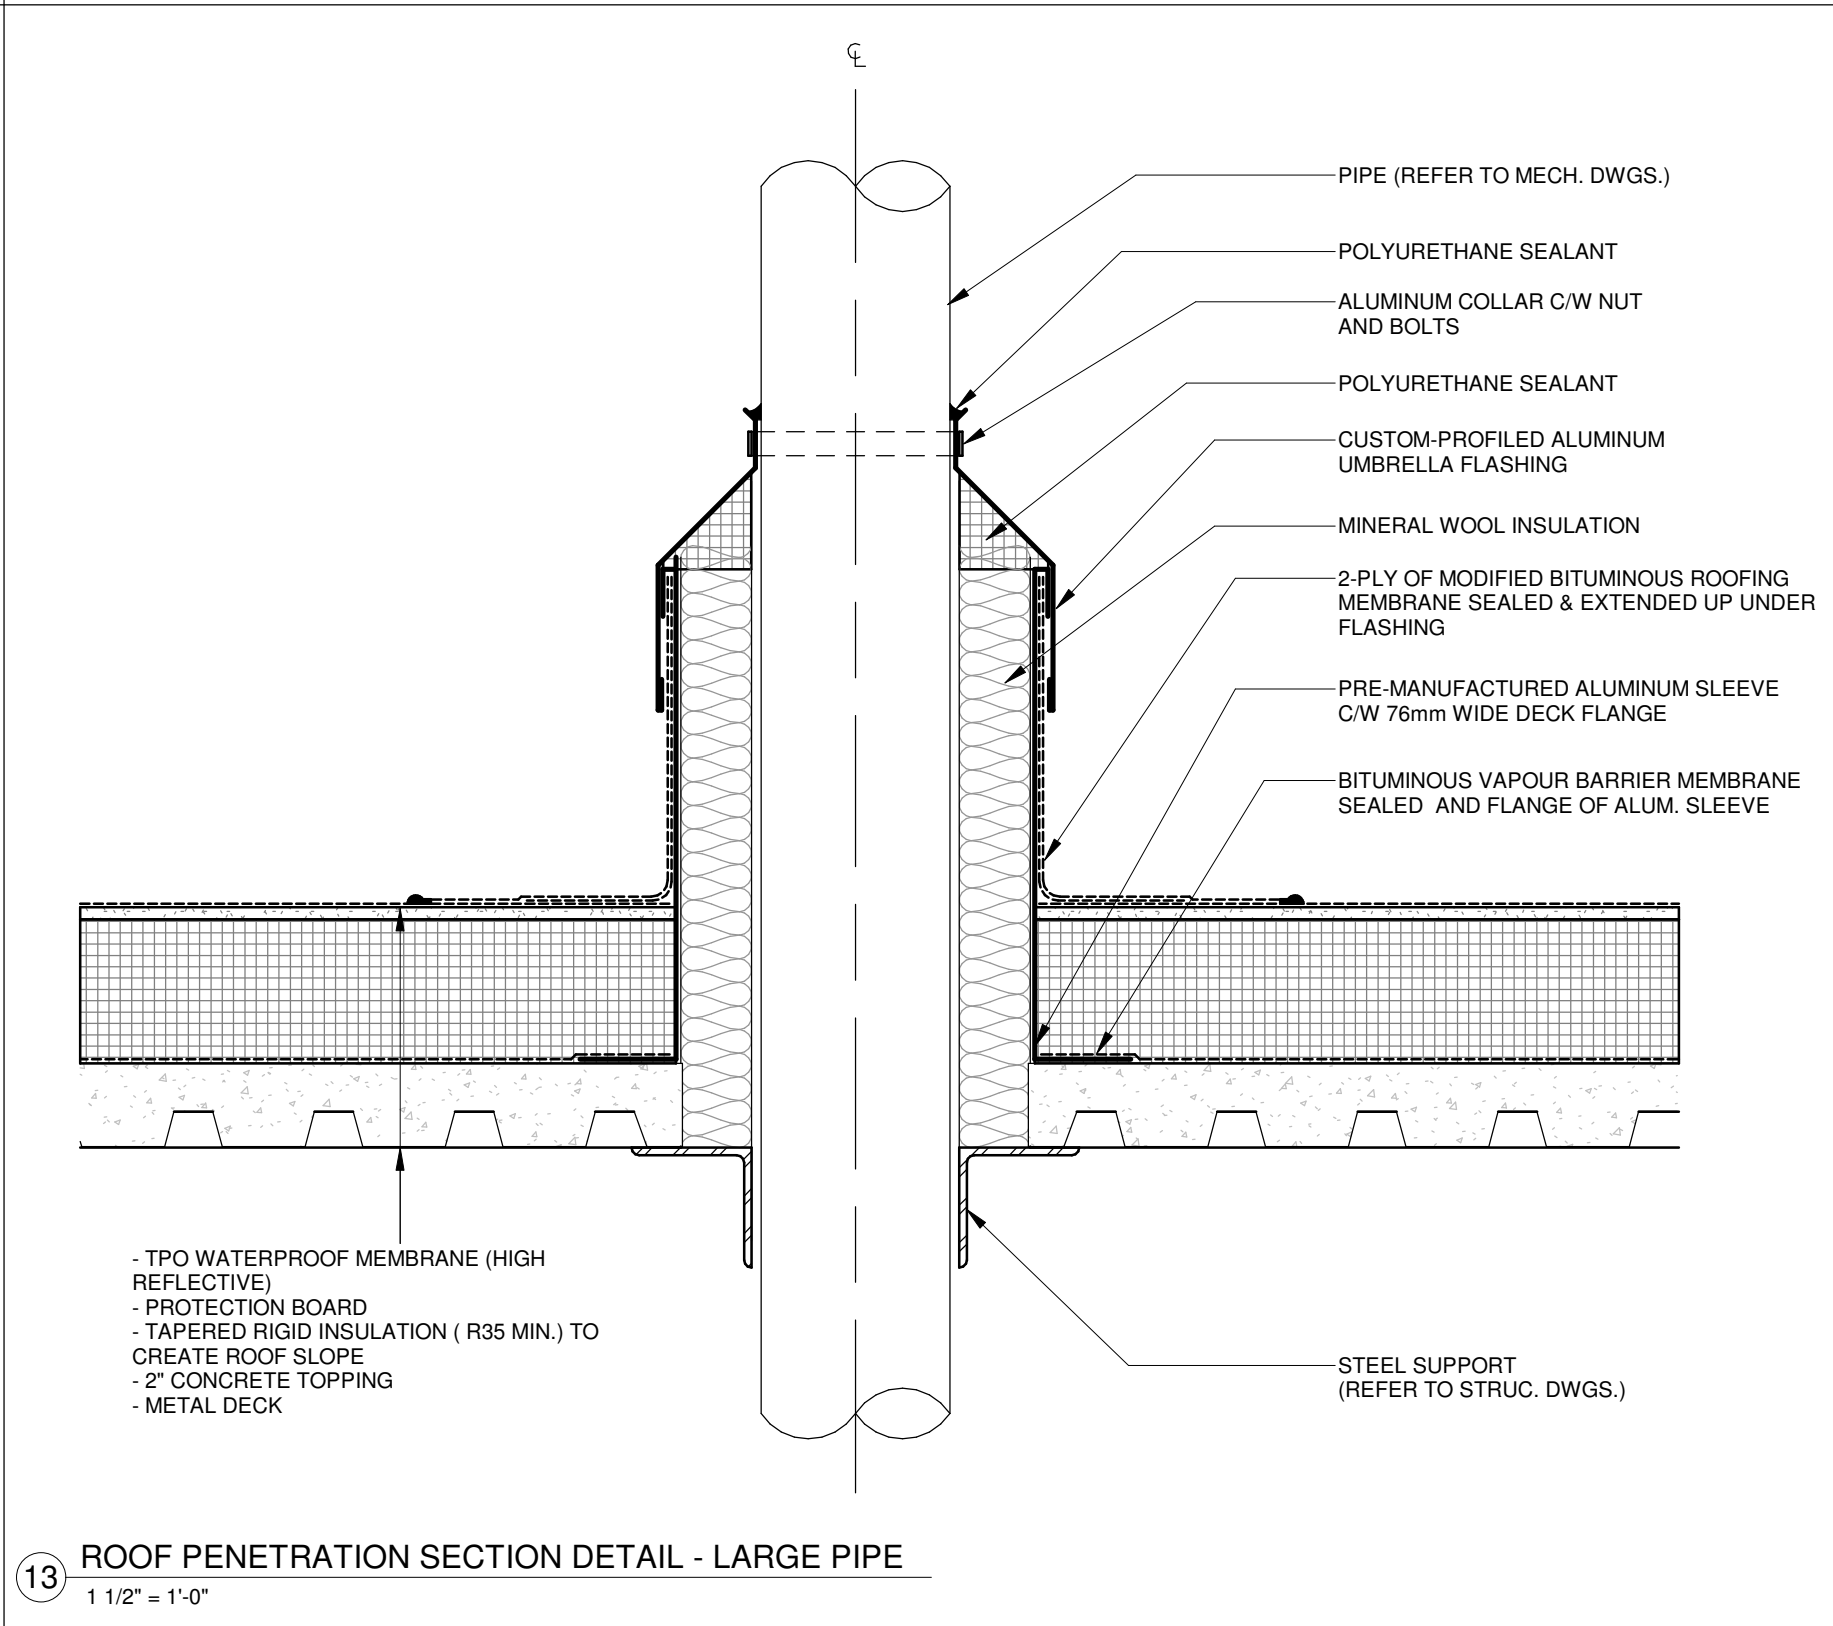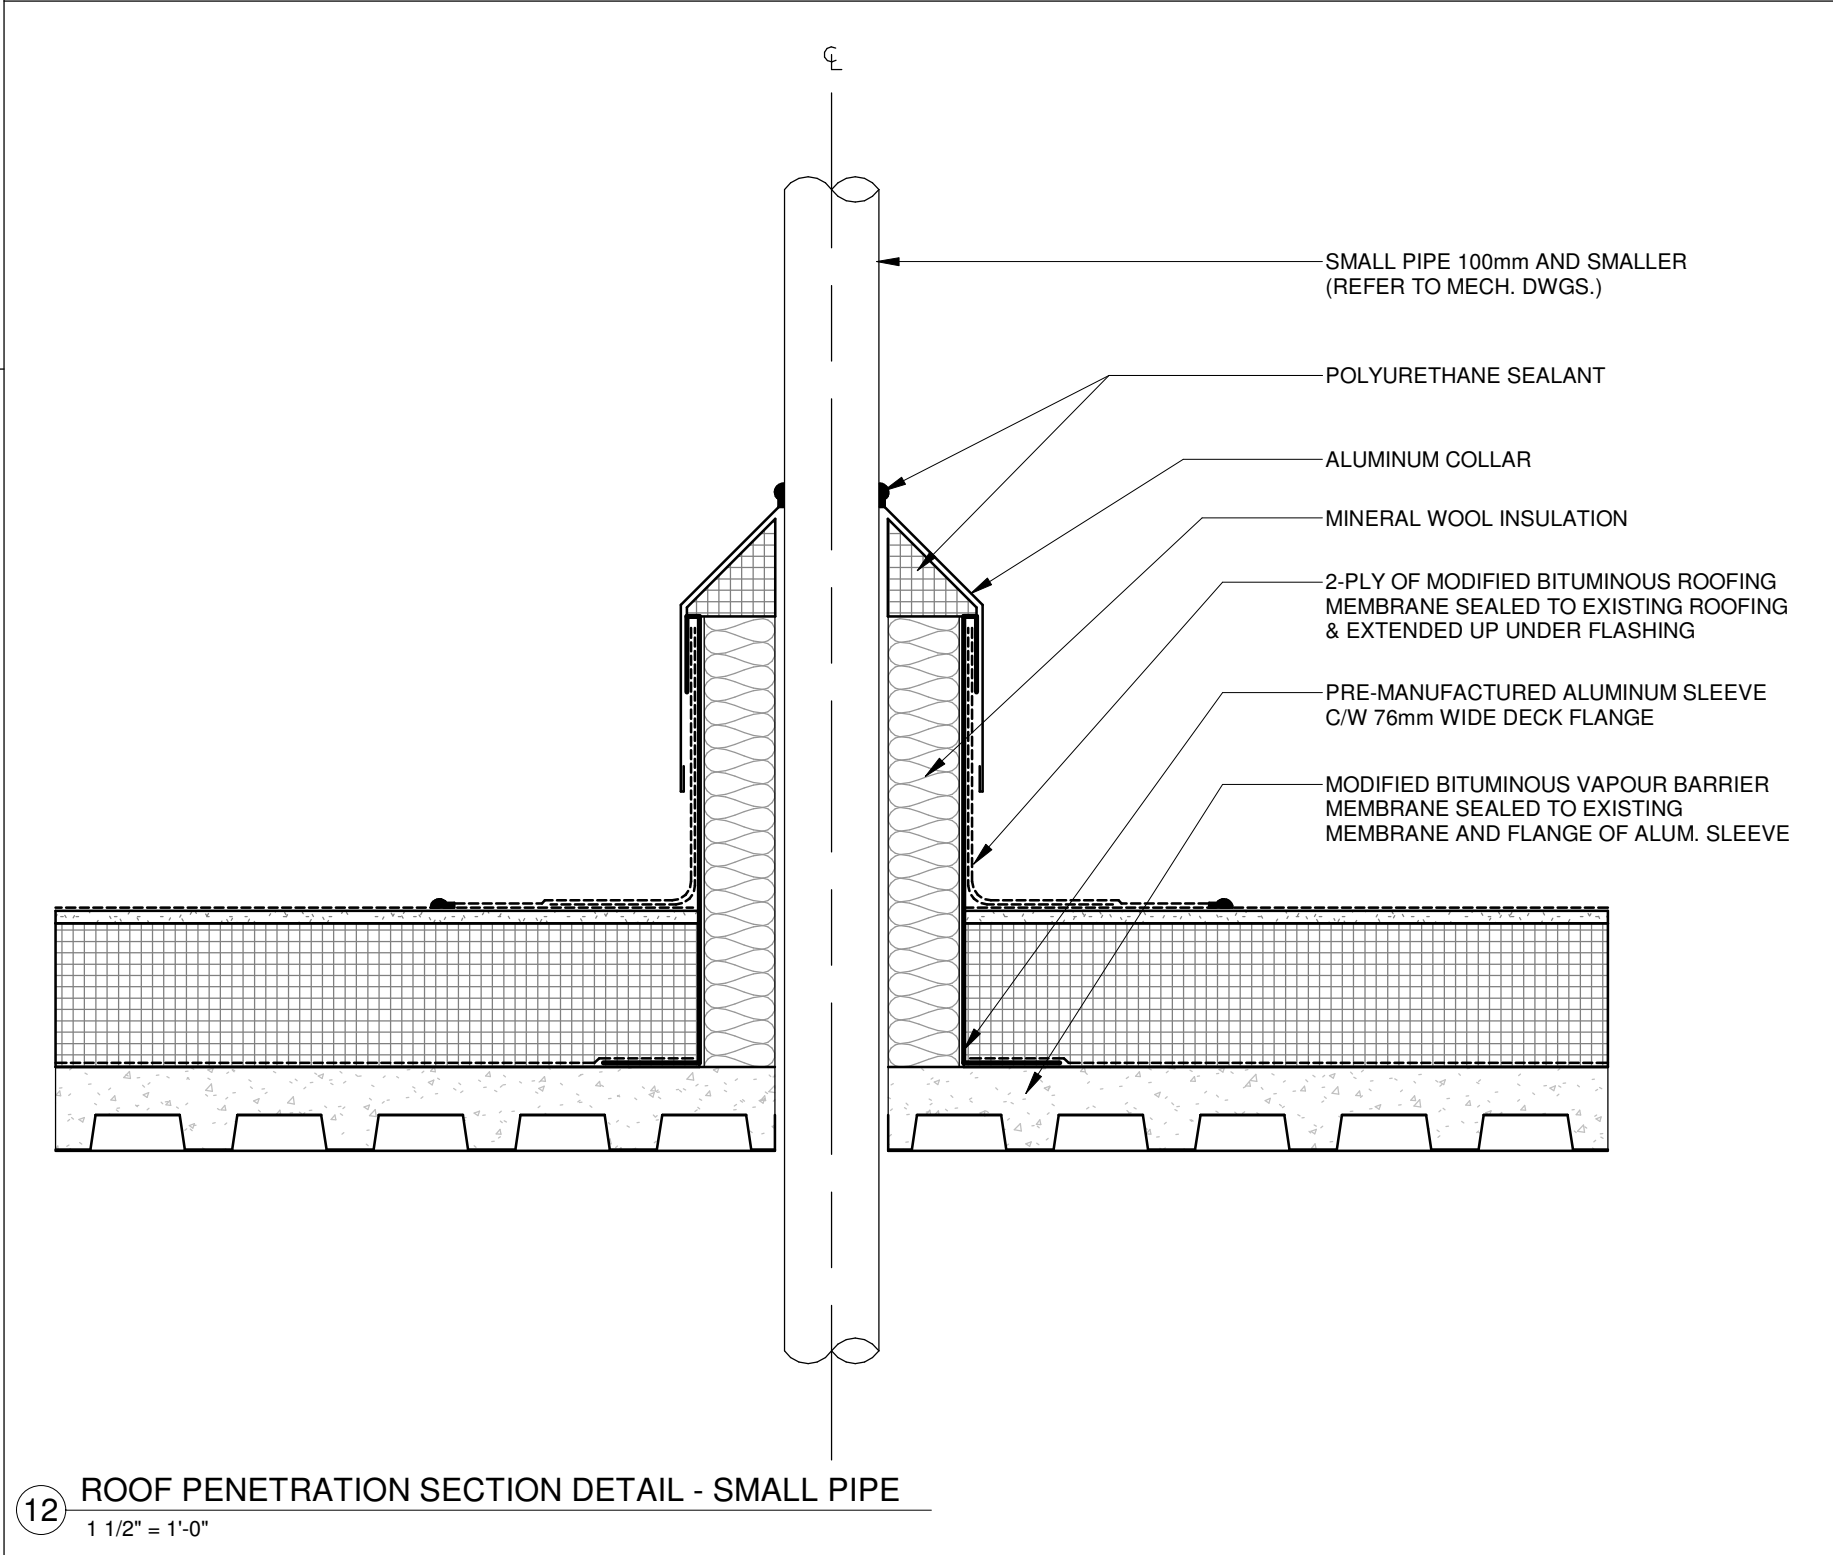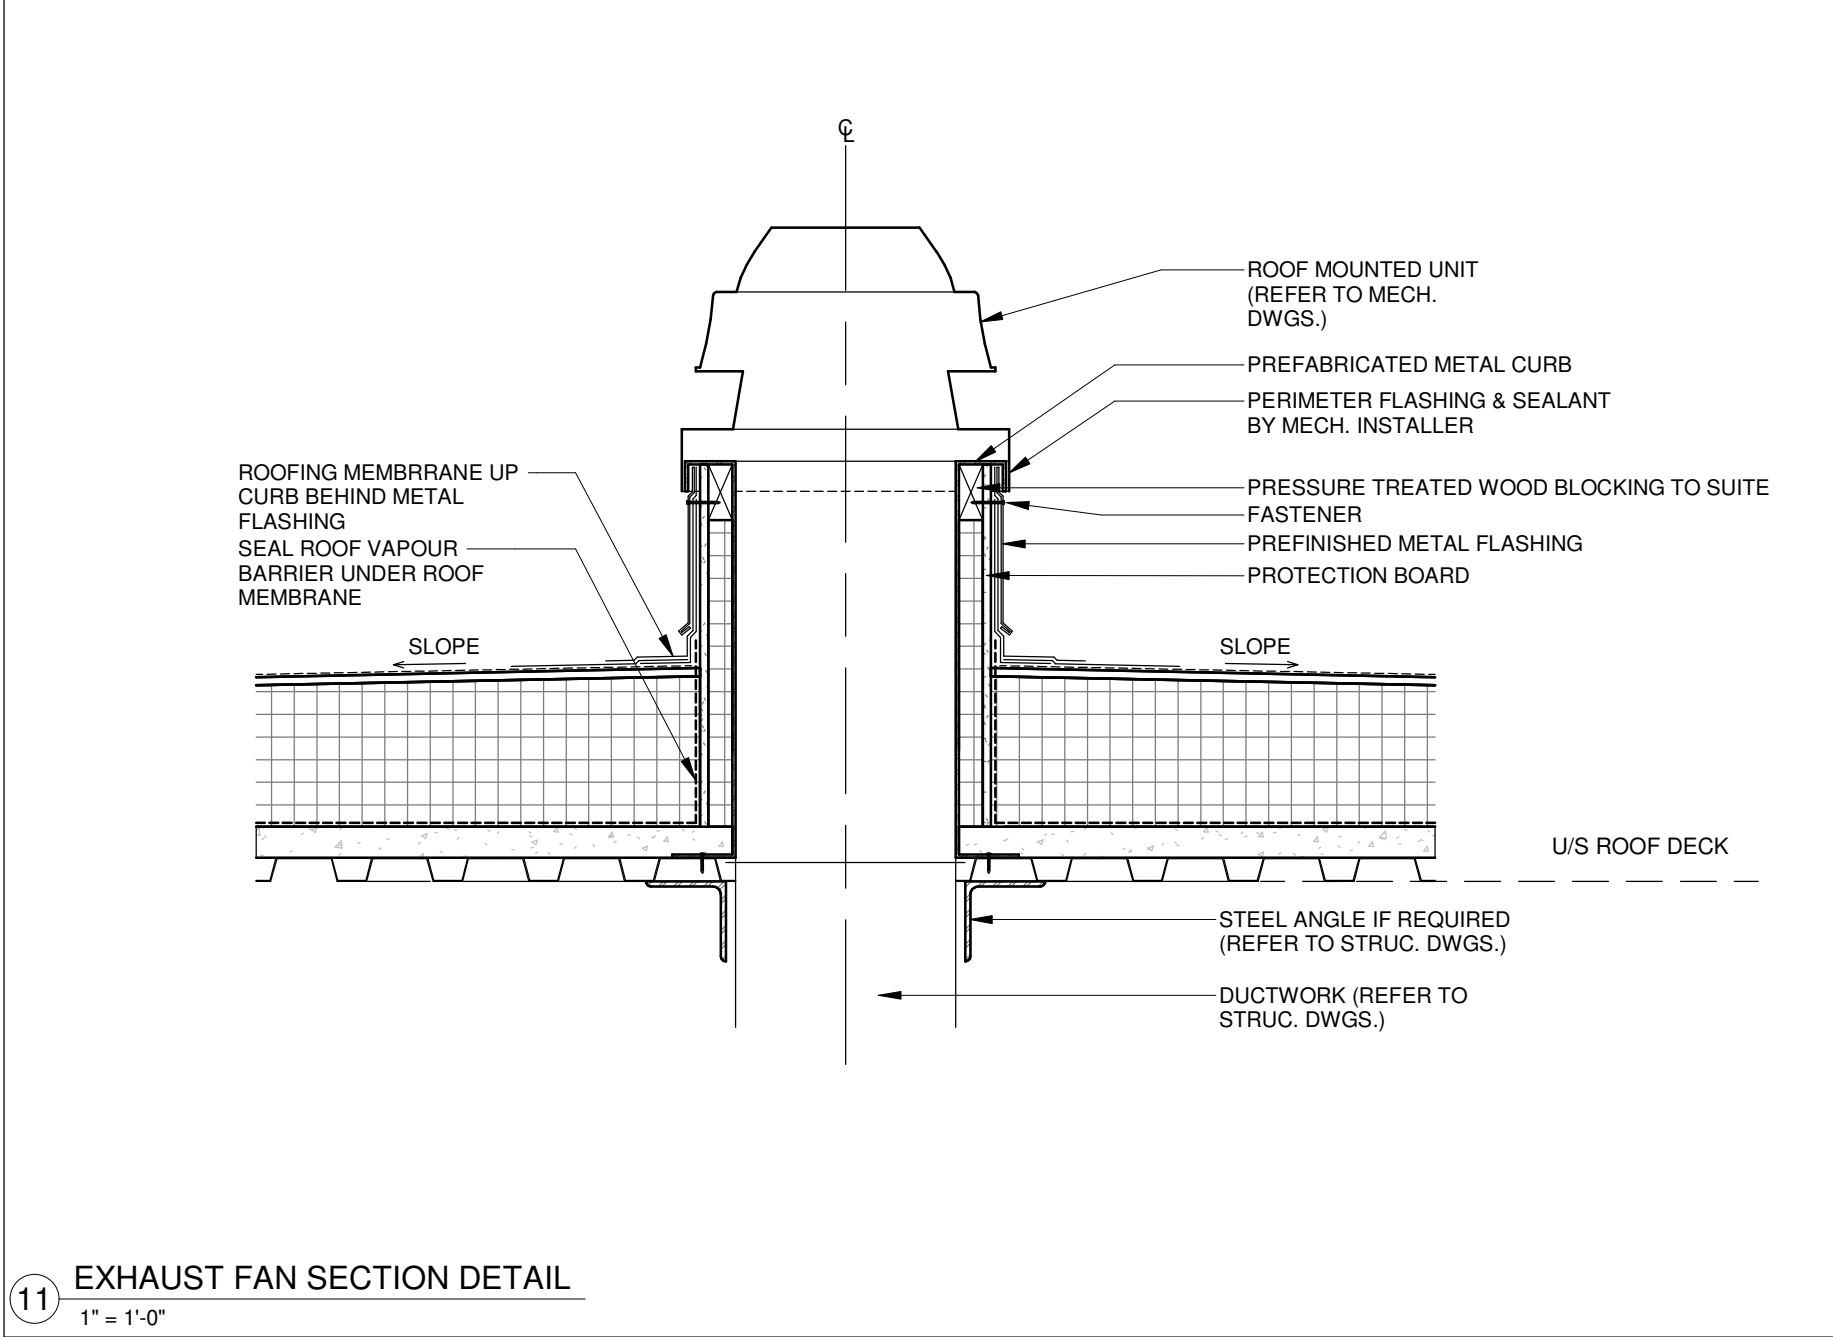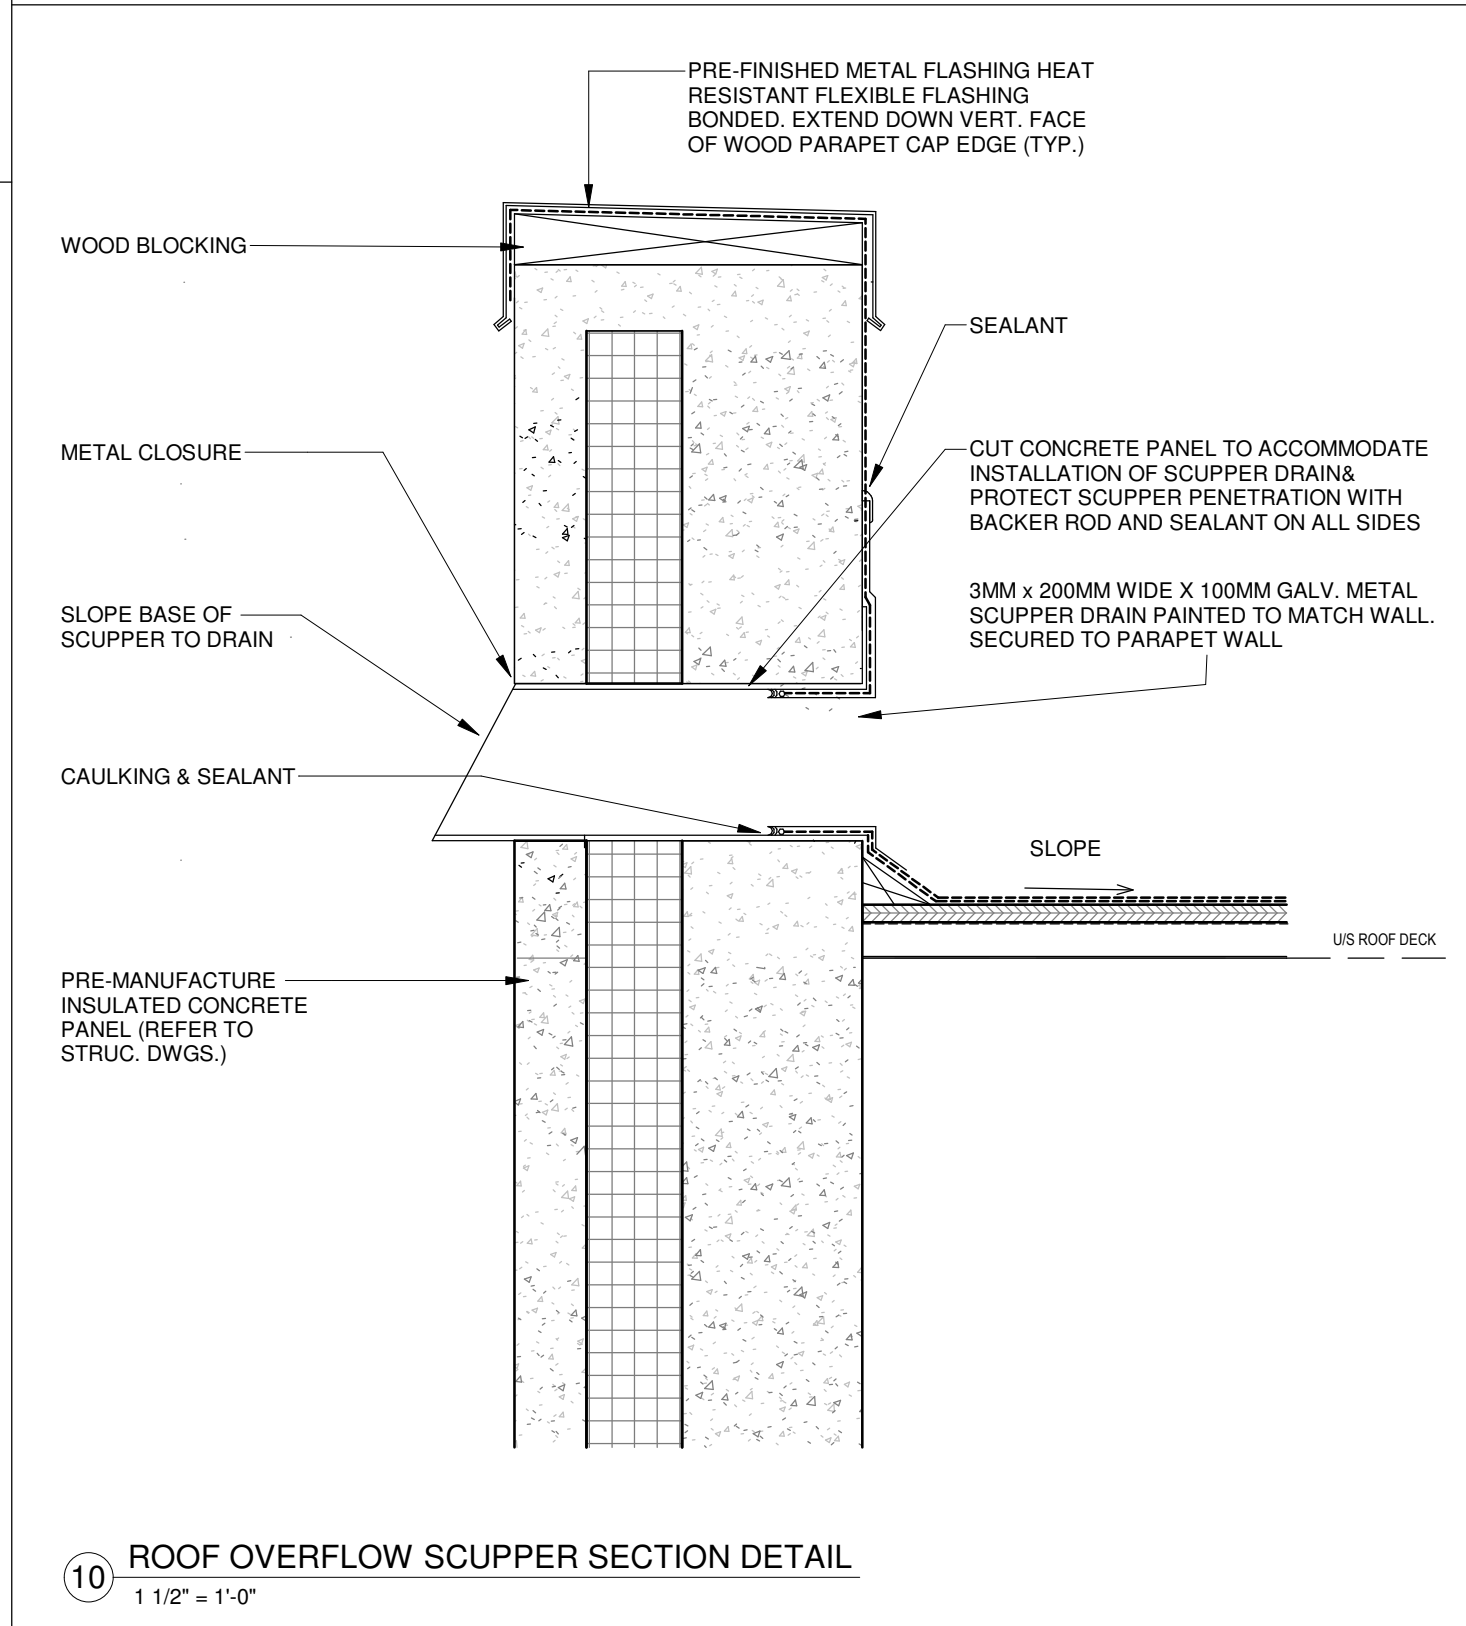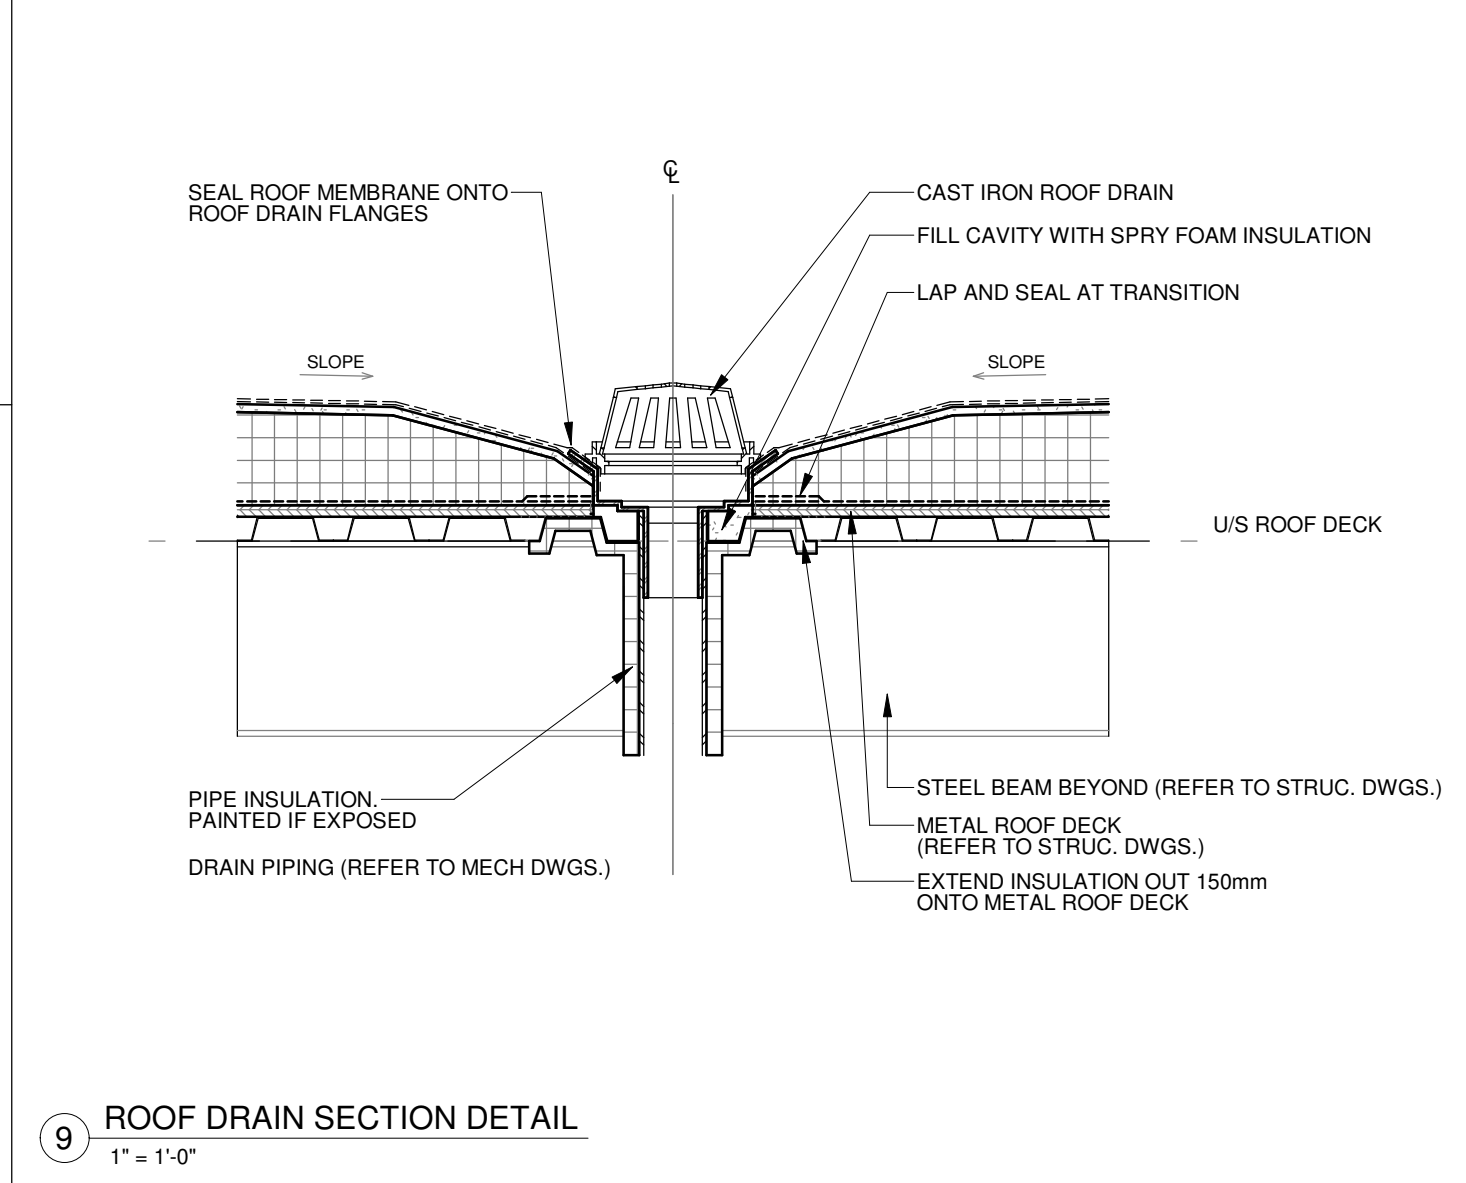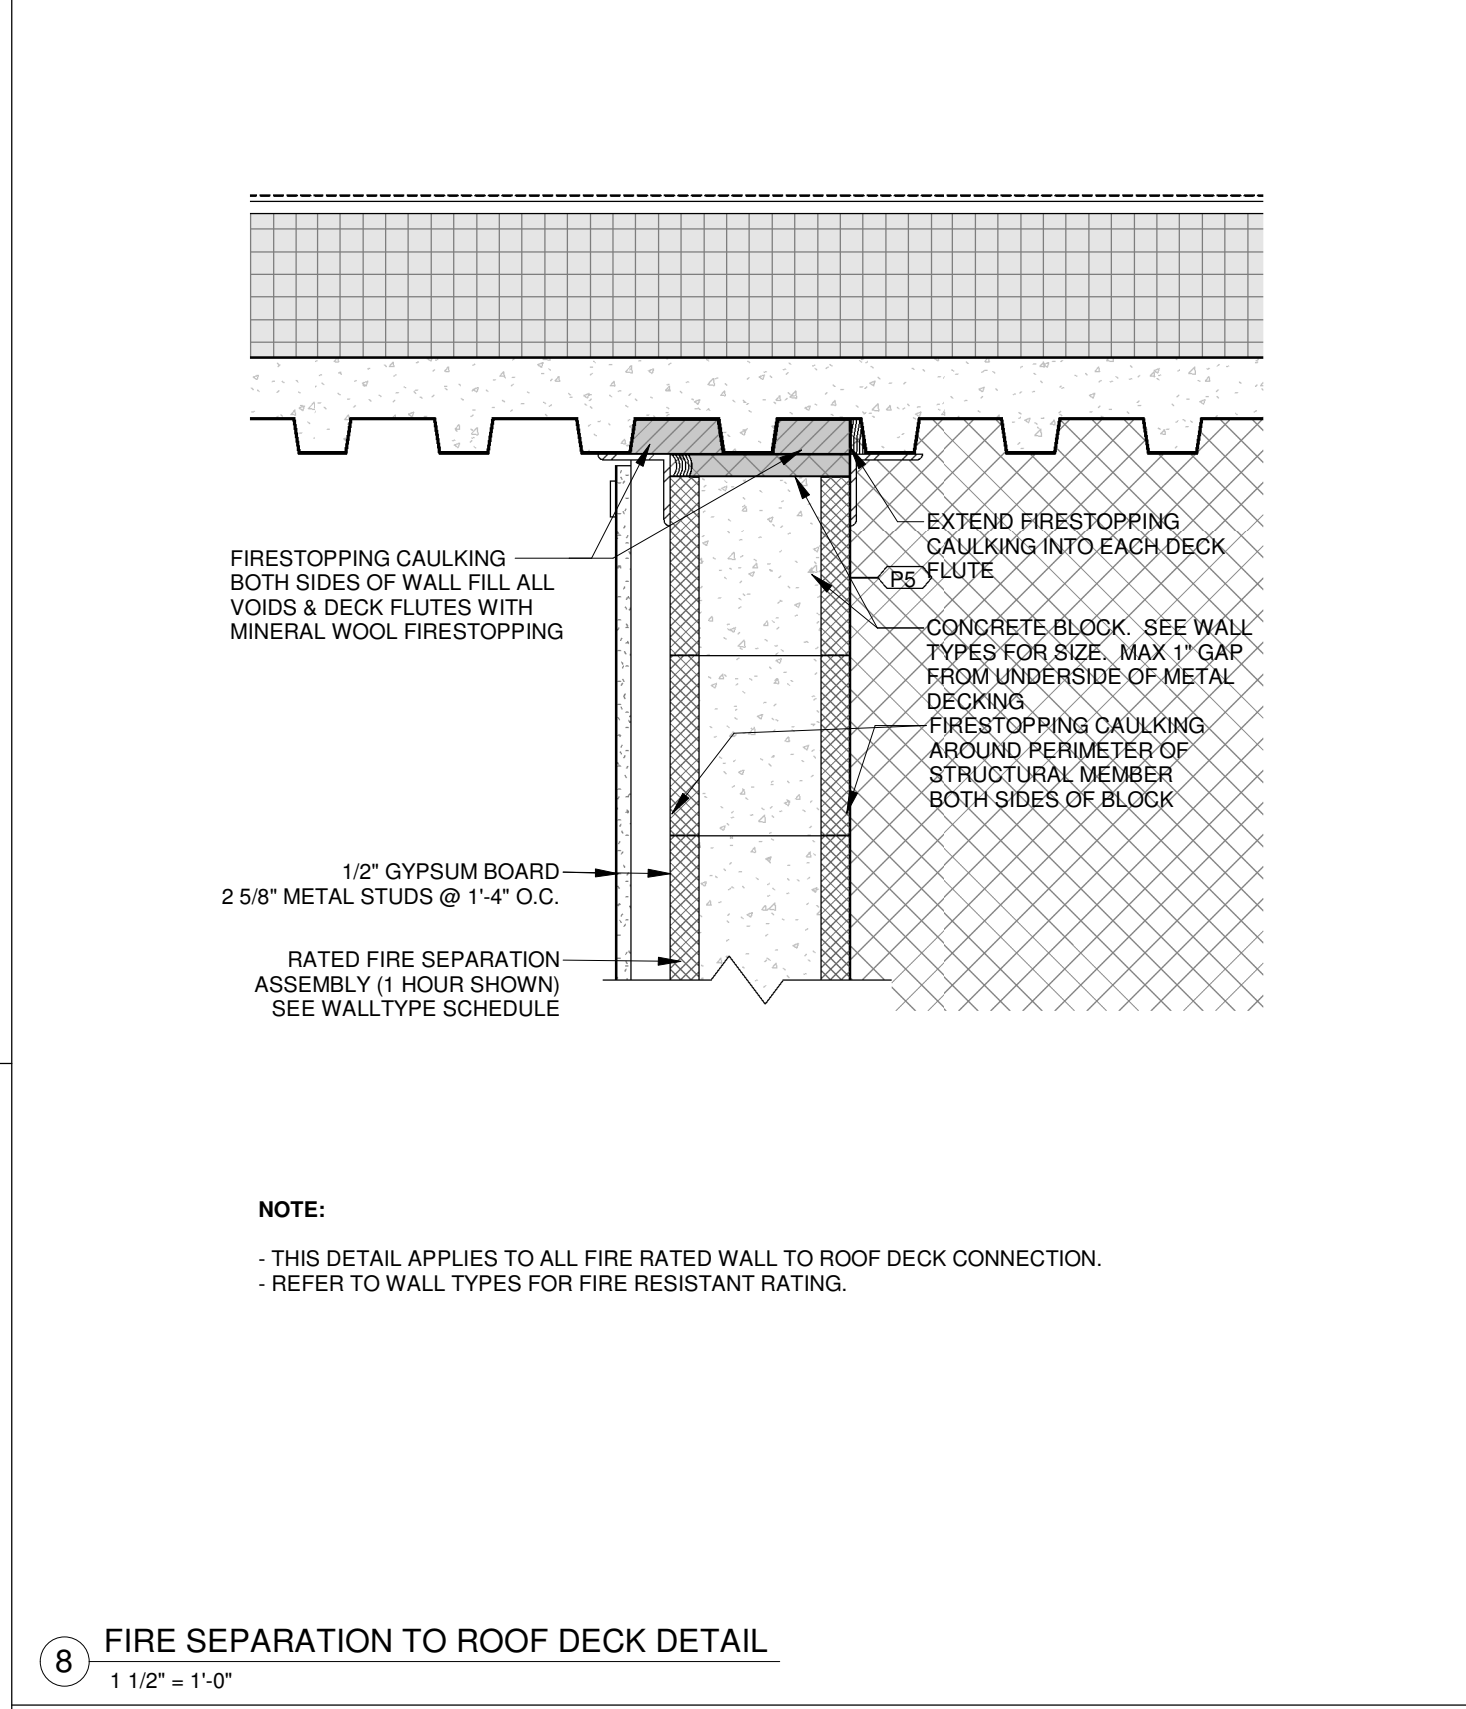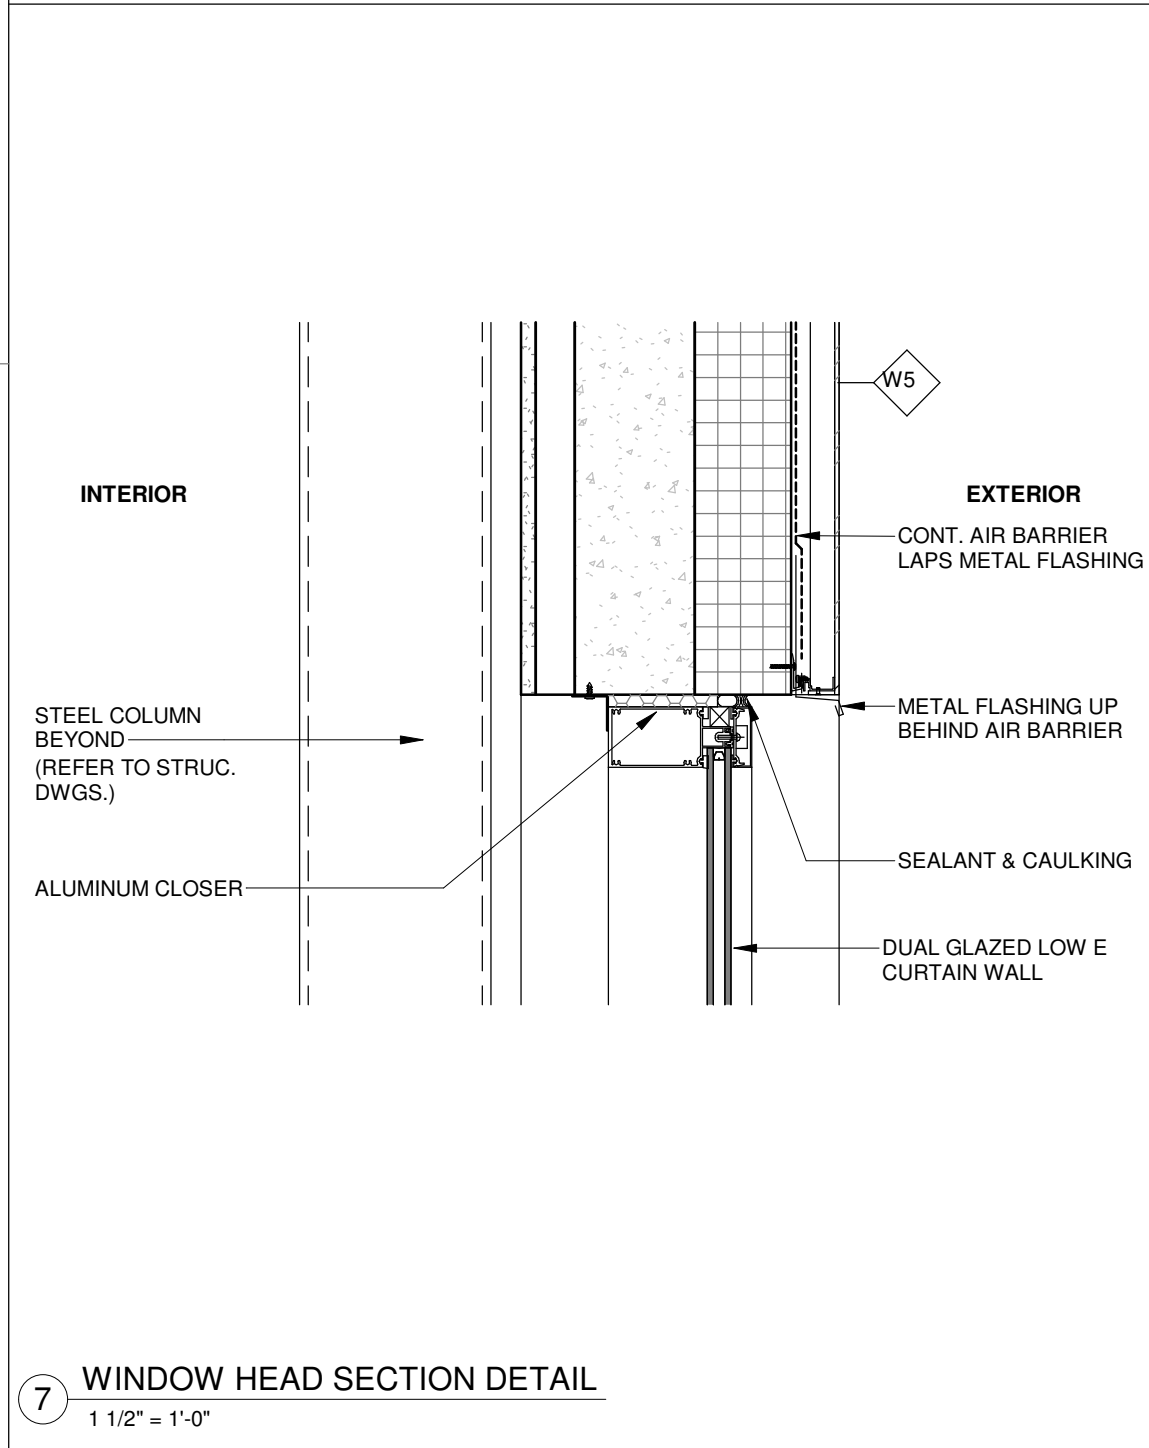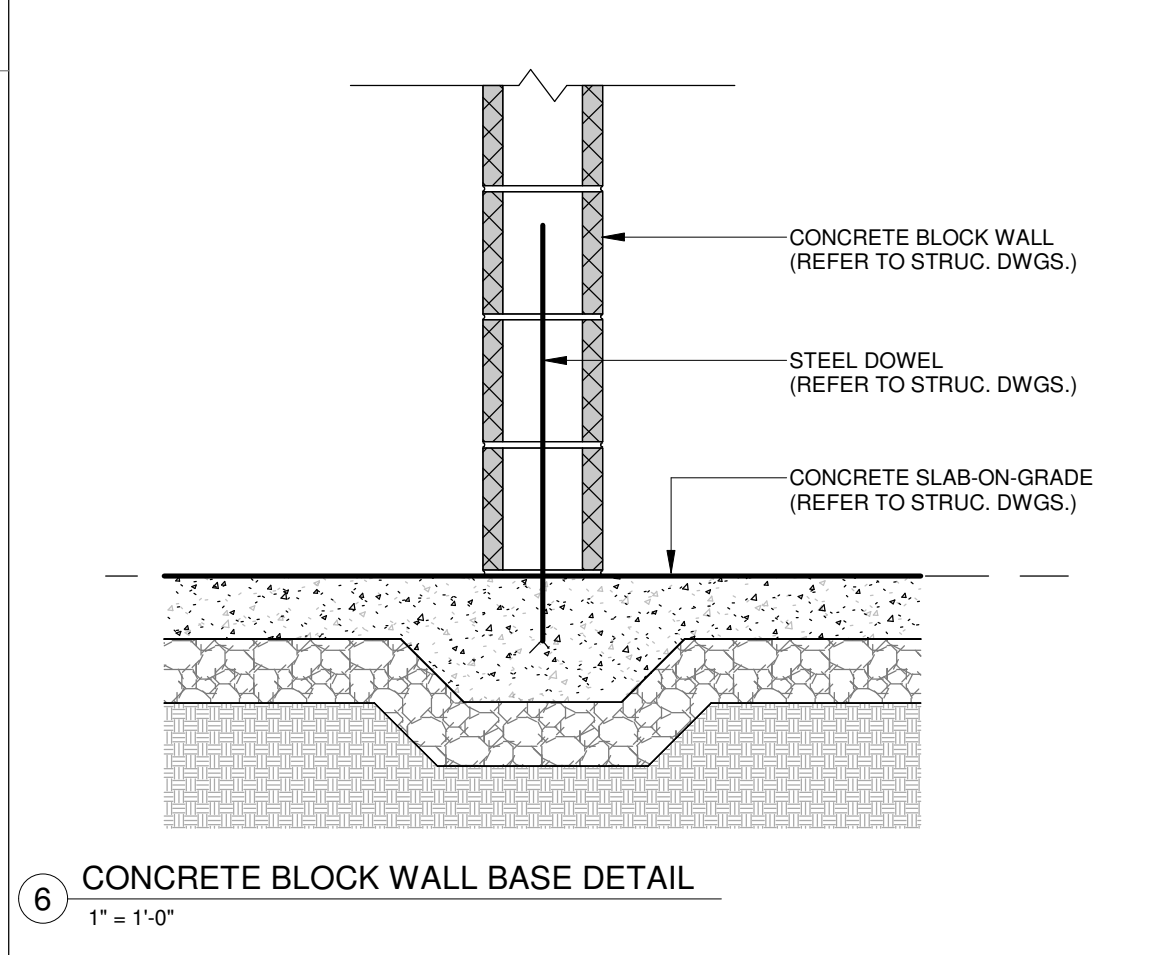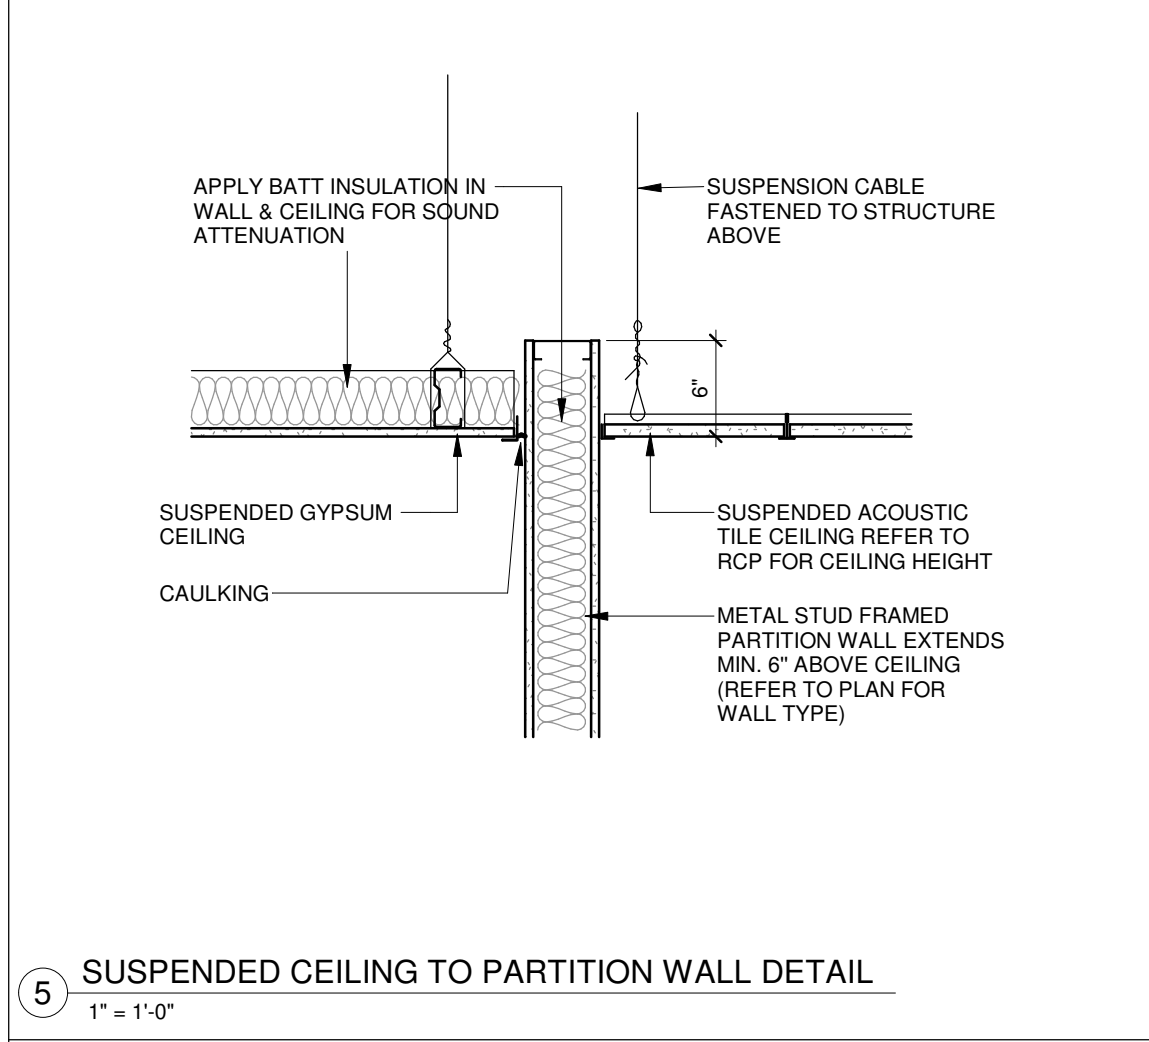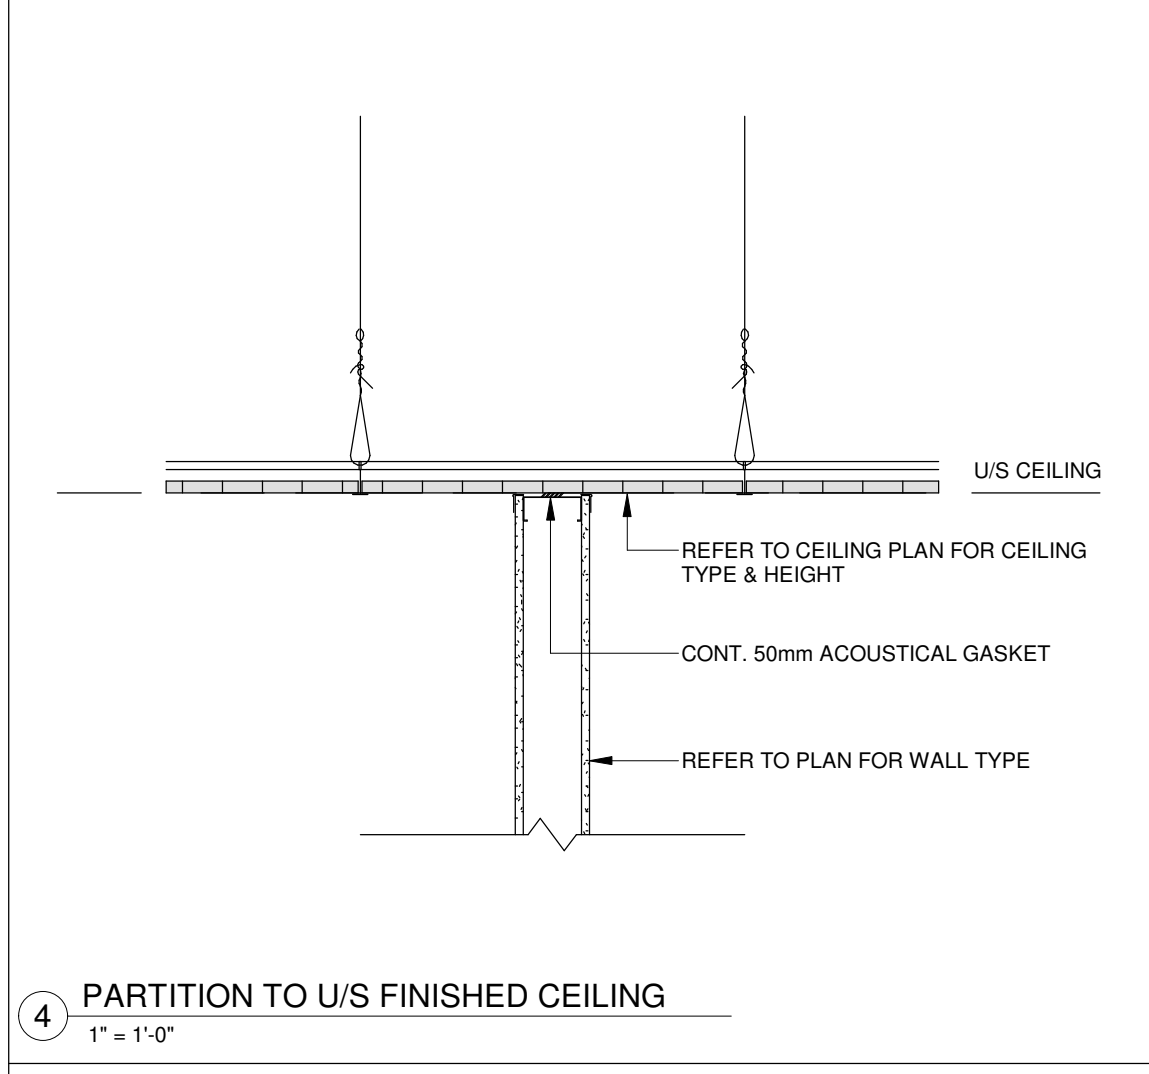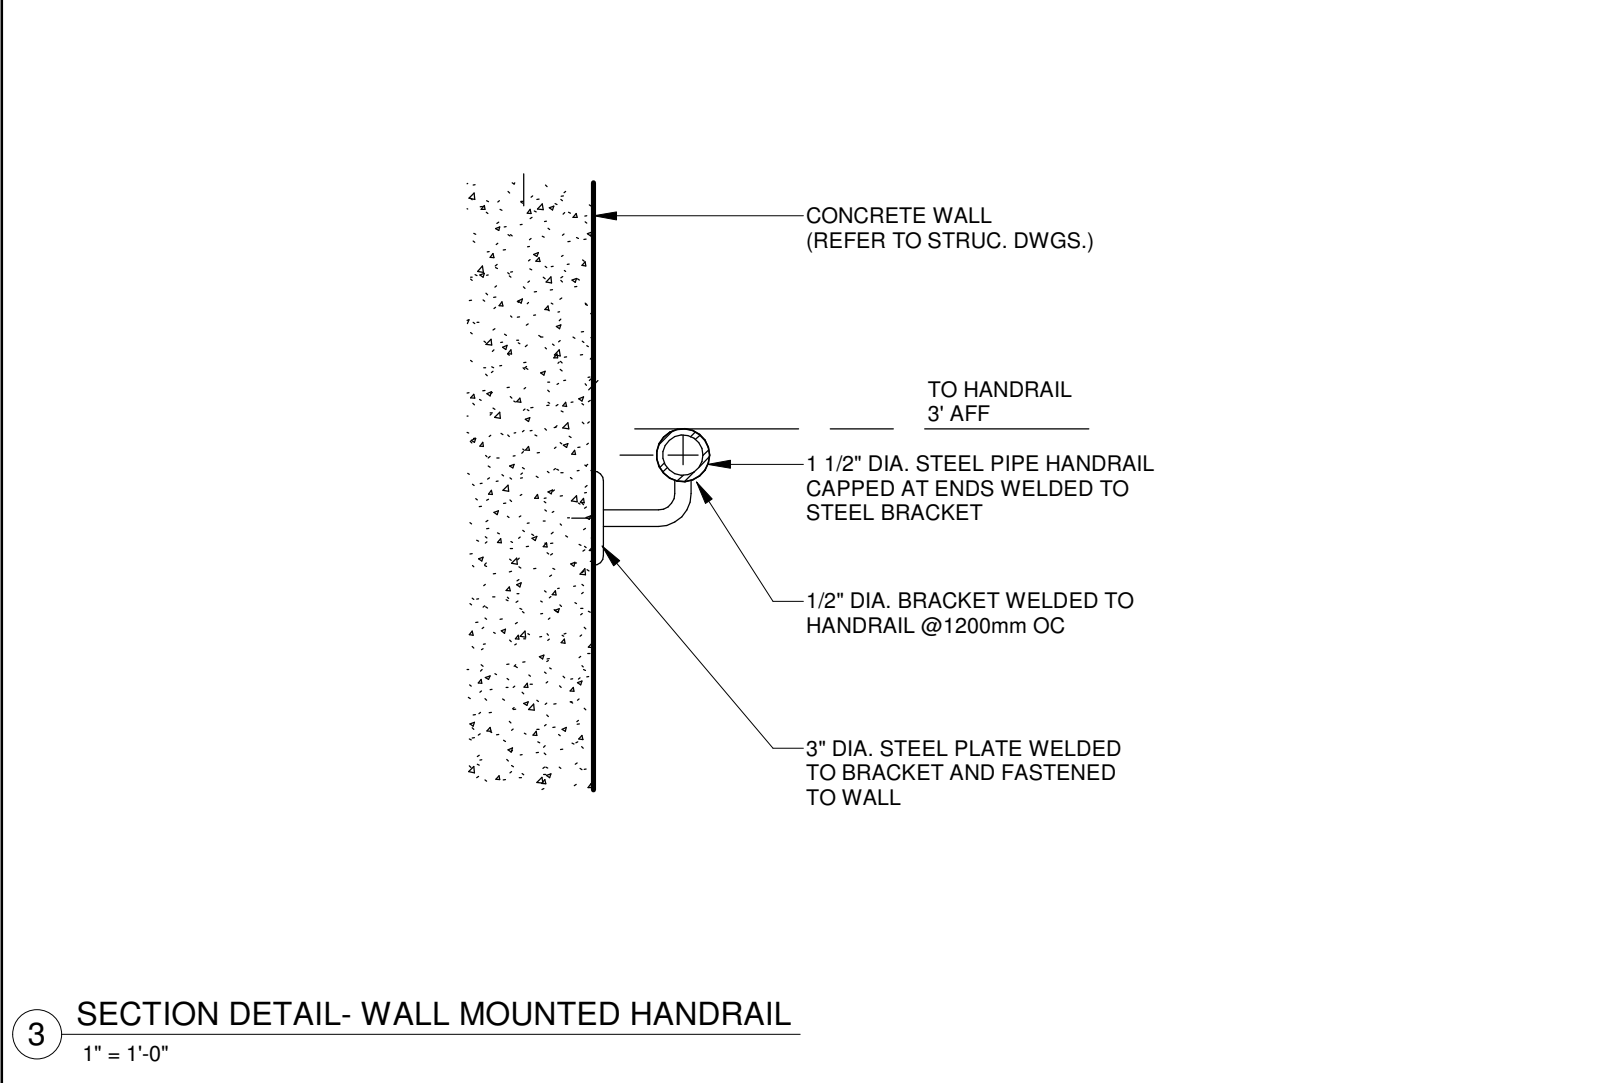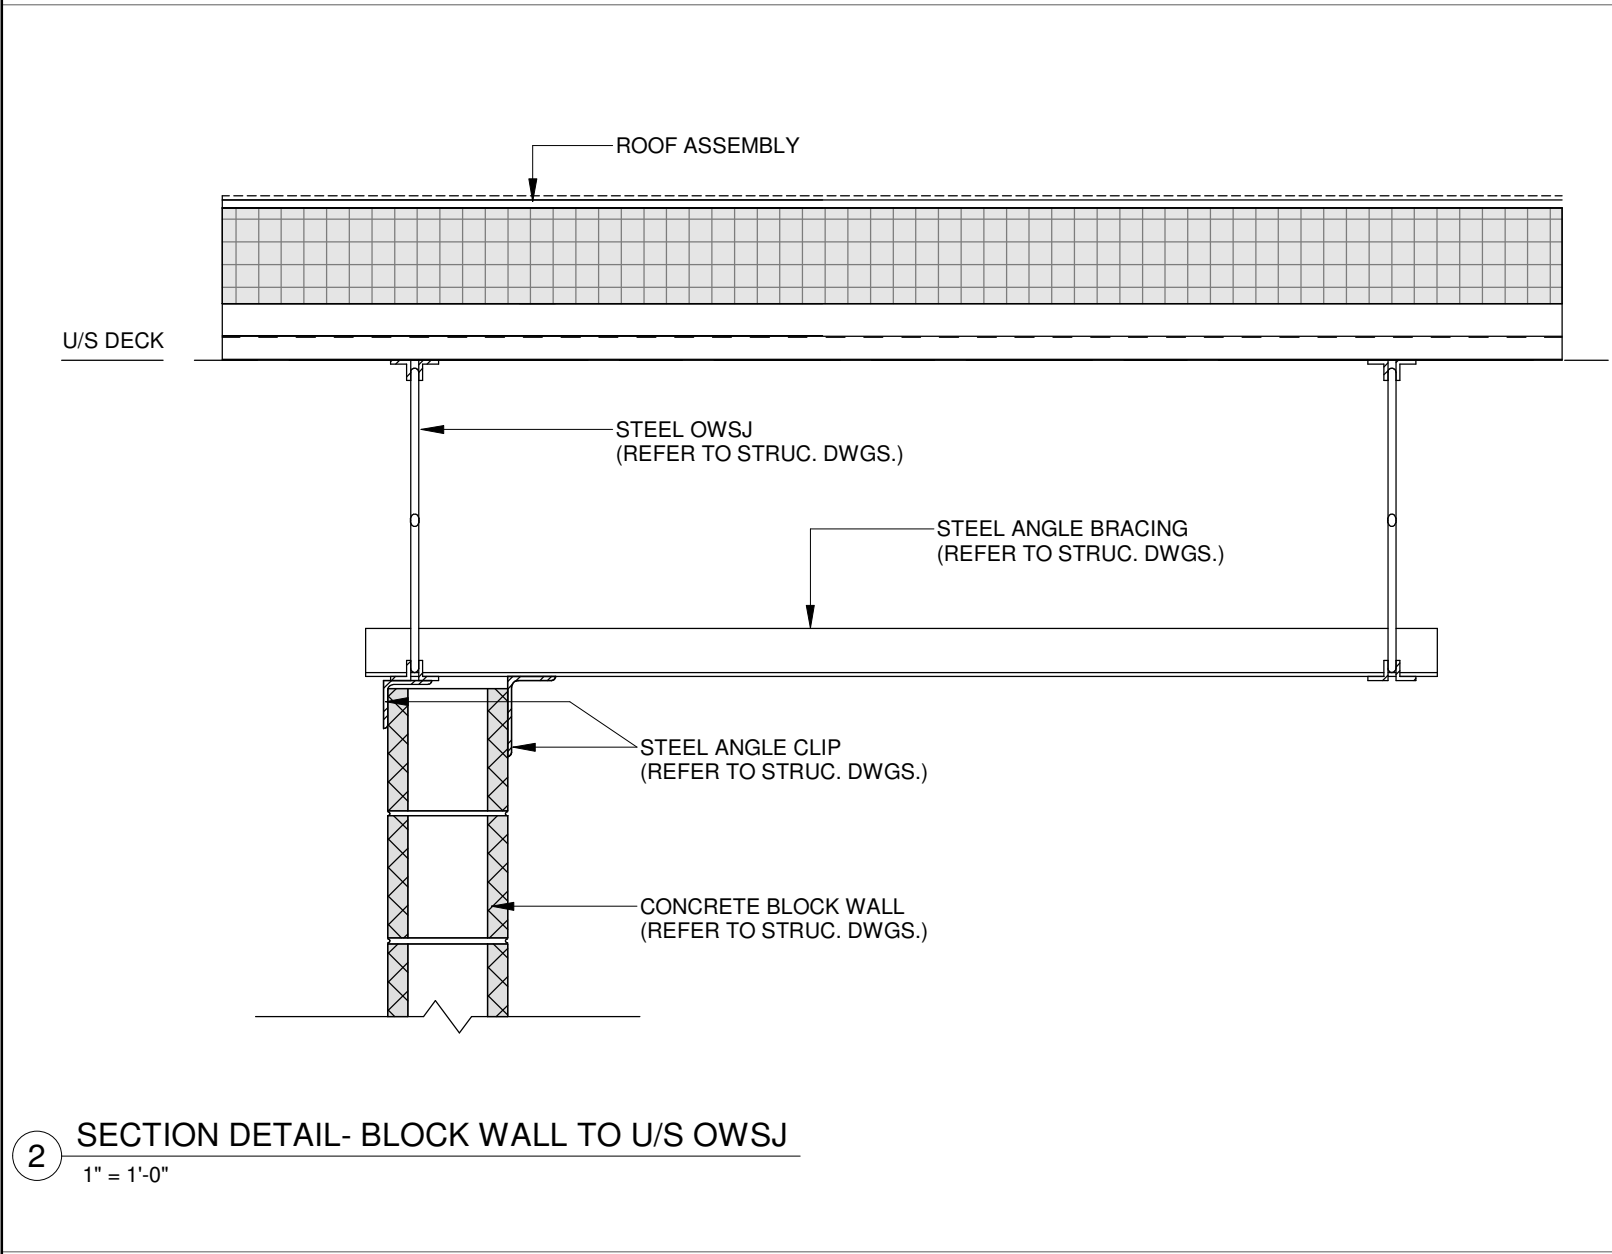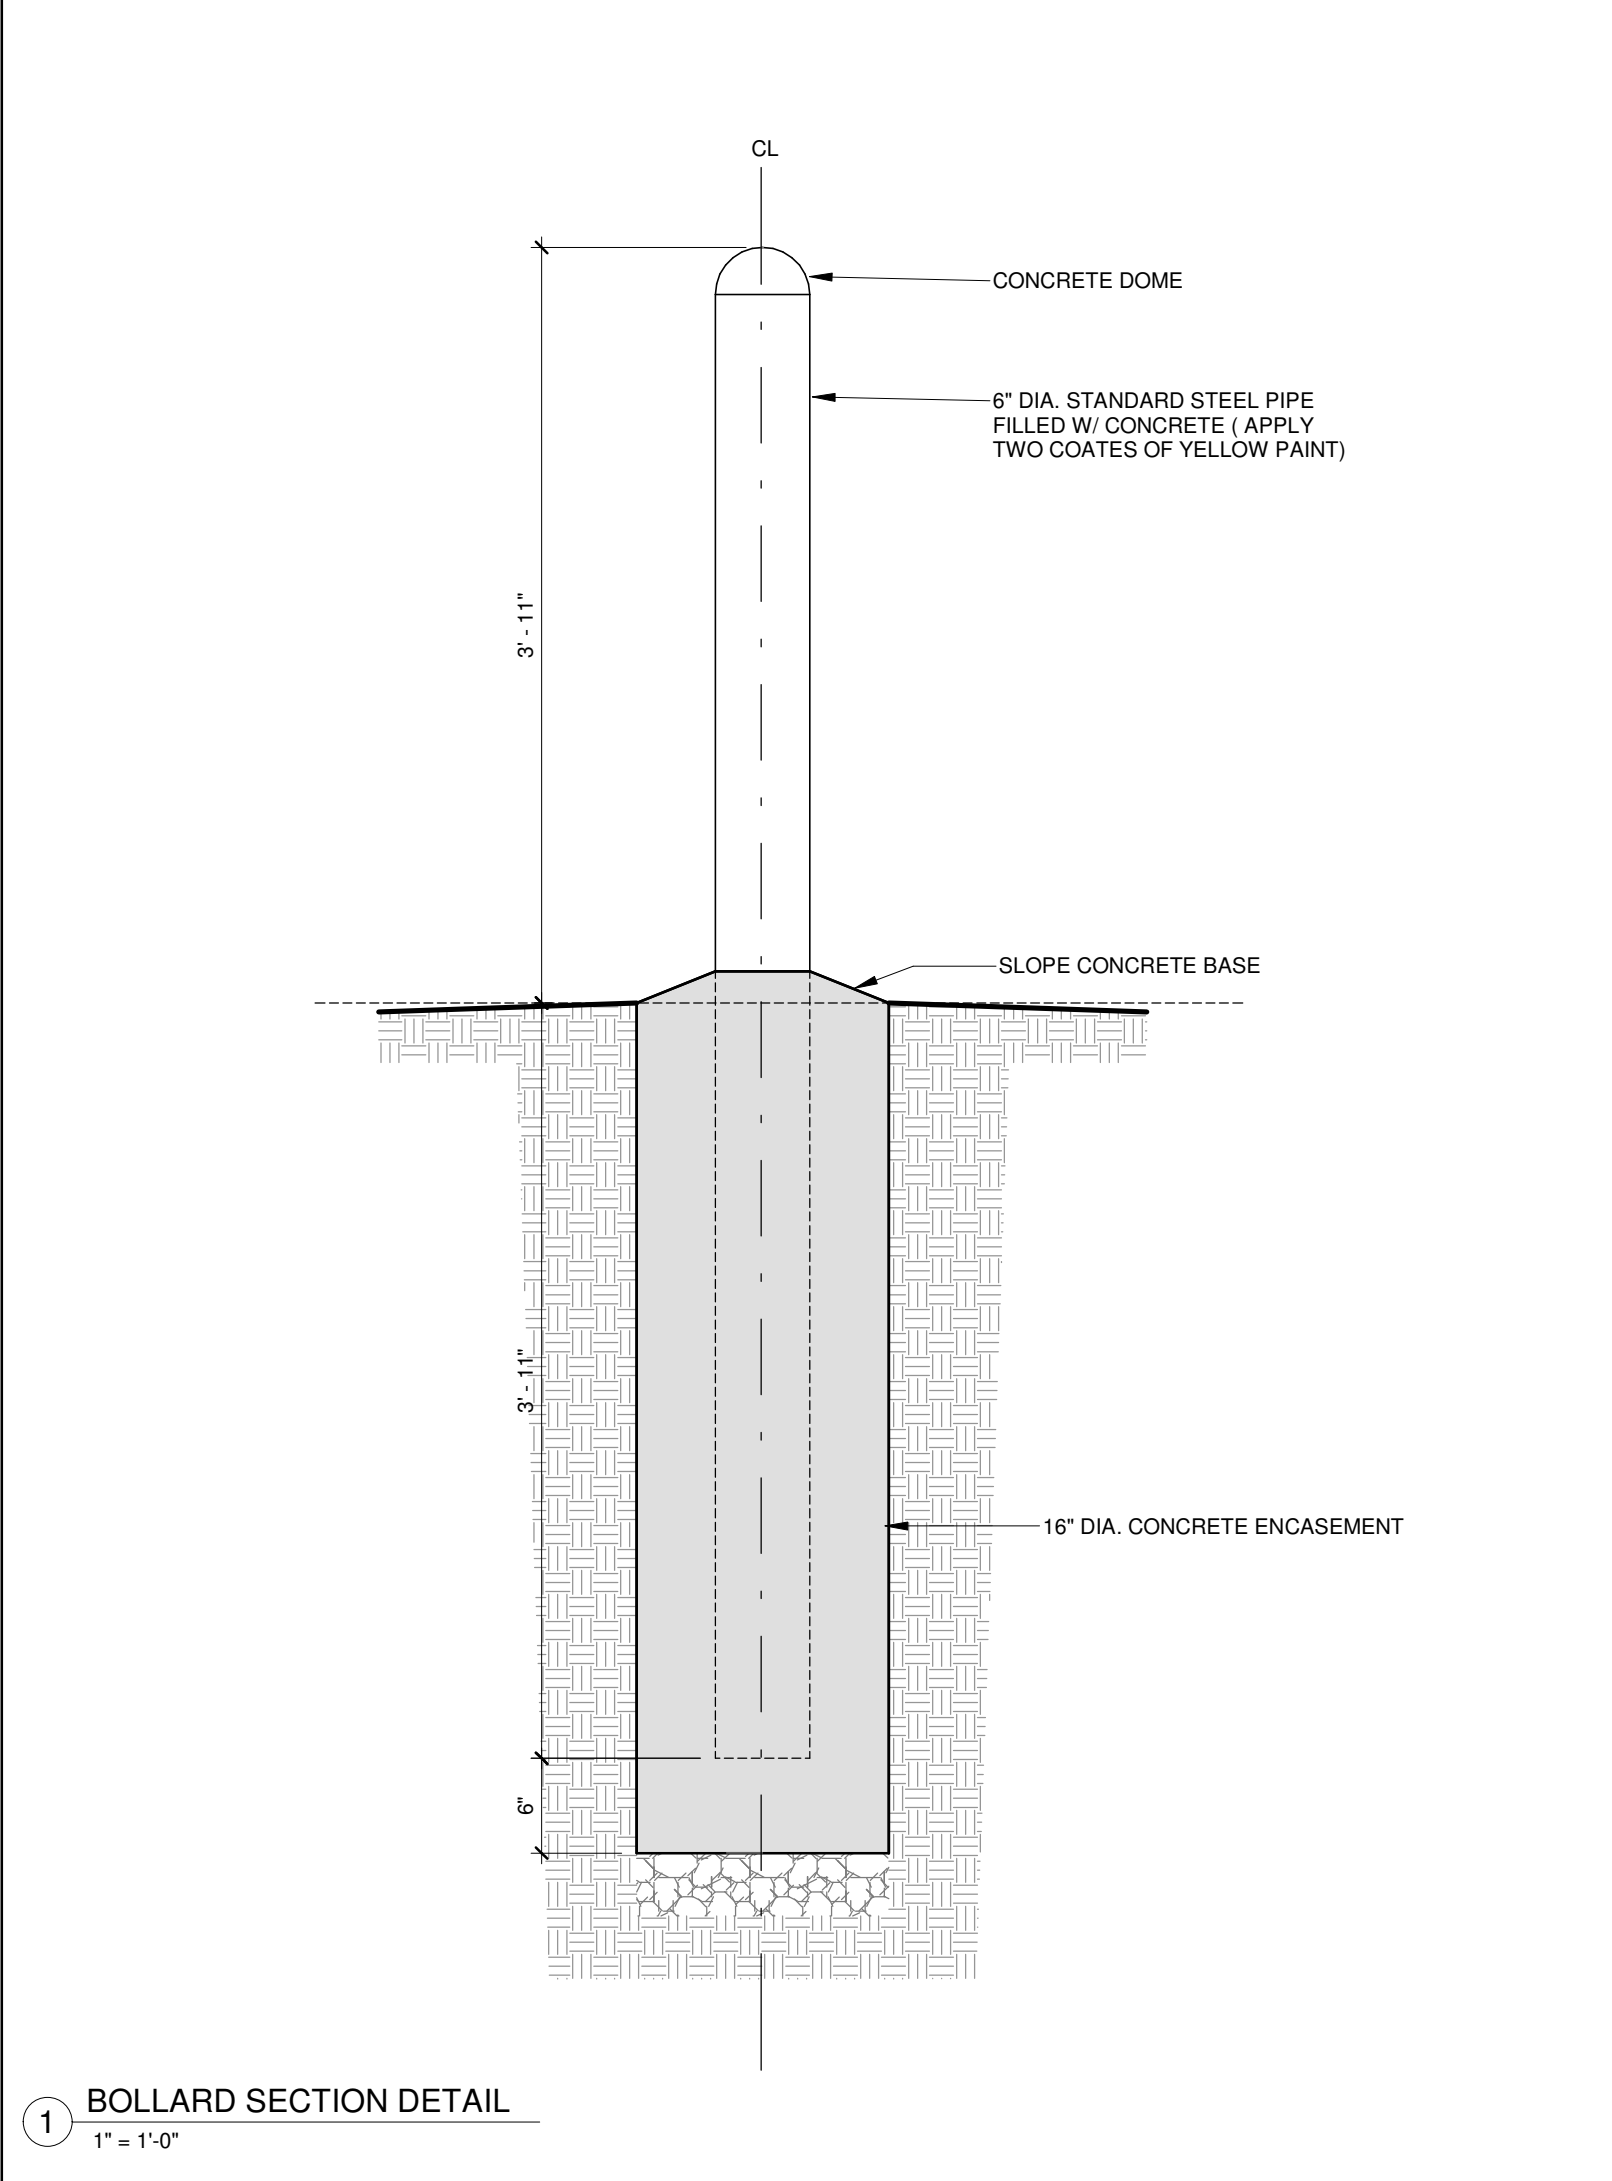


1	05/28/2025	ISSUED FOR PERMIT	HW
No.	Date:	Issued/Revision:	By
Client:			
FIREARMS OUTLET CANADA			
WANG ARCHITECTS INC. 3950 14th Ave, Unit 609 Markham, ON L3R 0A9 T: 905-604-6960 E: info@wangarchitects.ca www.wangarchitects.ca			
 ONARIO ASSOCIATION OF ARCHITECTS QING HUA (HENRY) WANG LICENCE 7675			
Project : FIREARMS OUTLET CANADA 725 WESTNEY RD. S., AJAX, ON L1S 7J7			
Drawing Name : SECTION DETAILS			
Scale : As indicated		Project No : 00026	
Drawn by : JW		Drawing No :	
Checked by : HW		A5.2	


C:\Users\henry\Documents\725 Westney Rd S - WORKING DRAWING- TENDER_henry.rvt

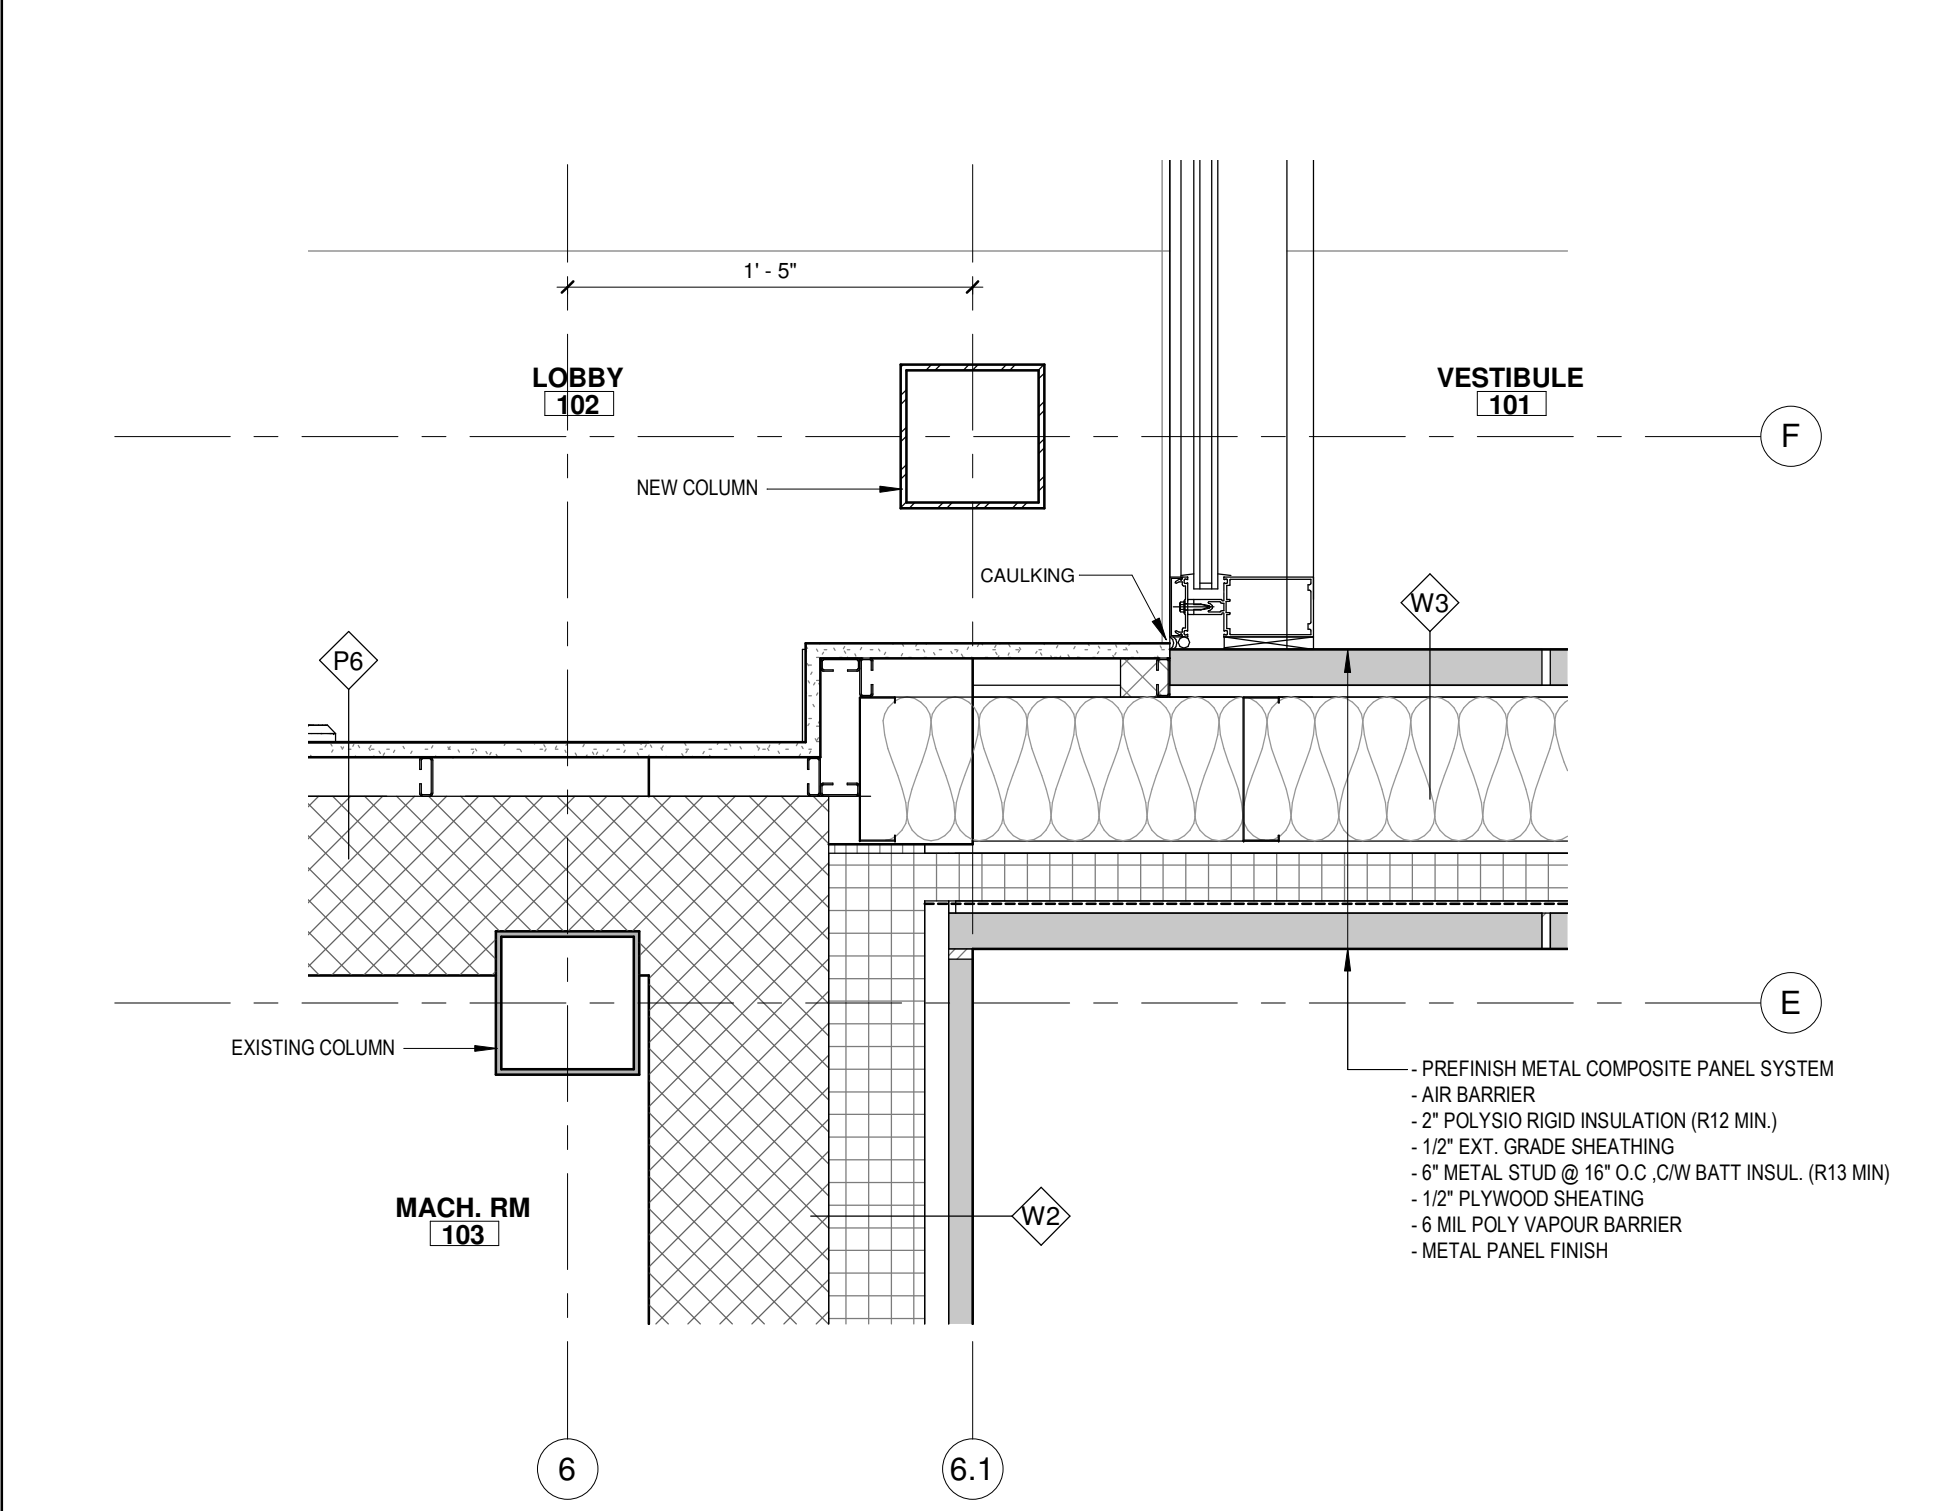


1 PLAN DETAIL 1
1 1/2" = 1'-0"

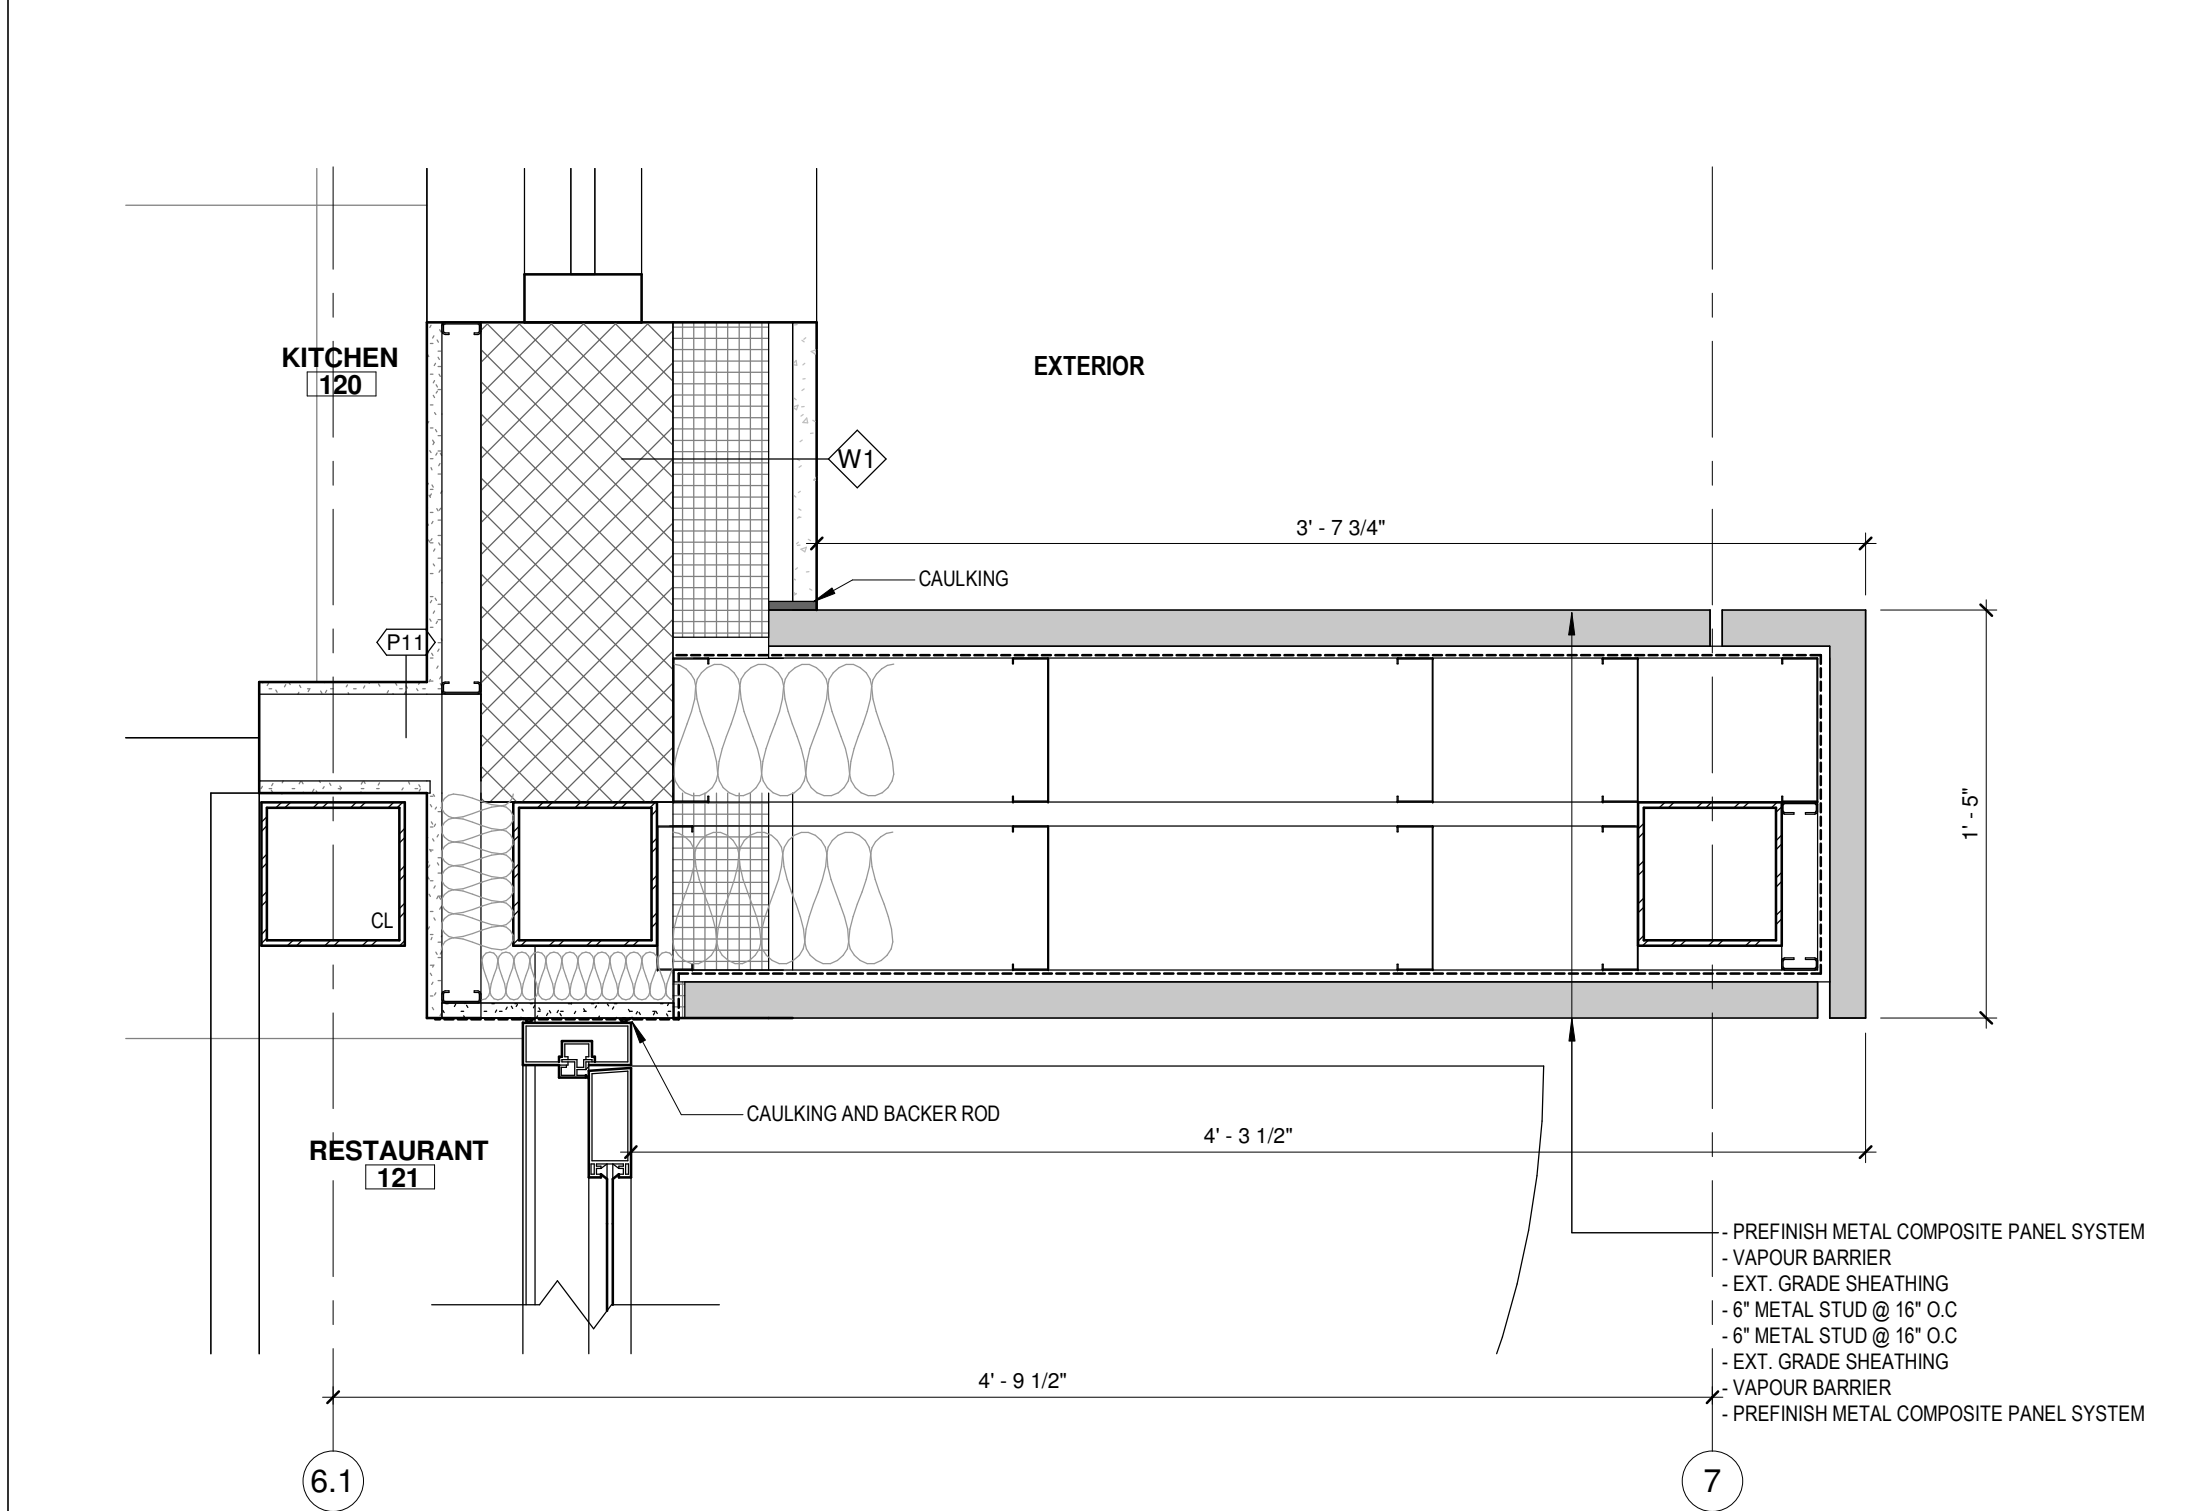


2 PLAN DETAIL 2
1 1/2" = 1'-0"

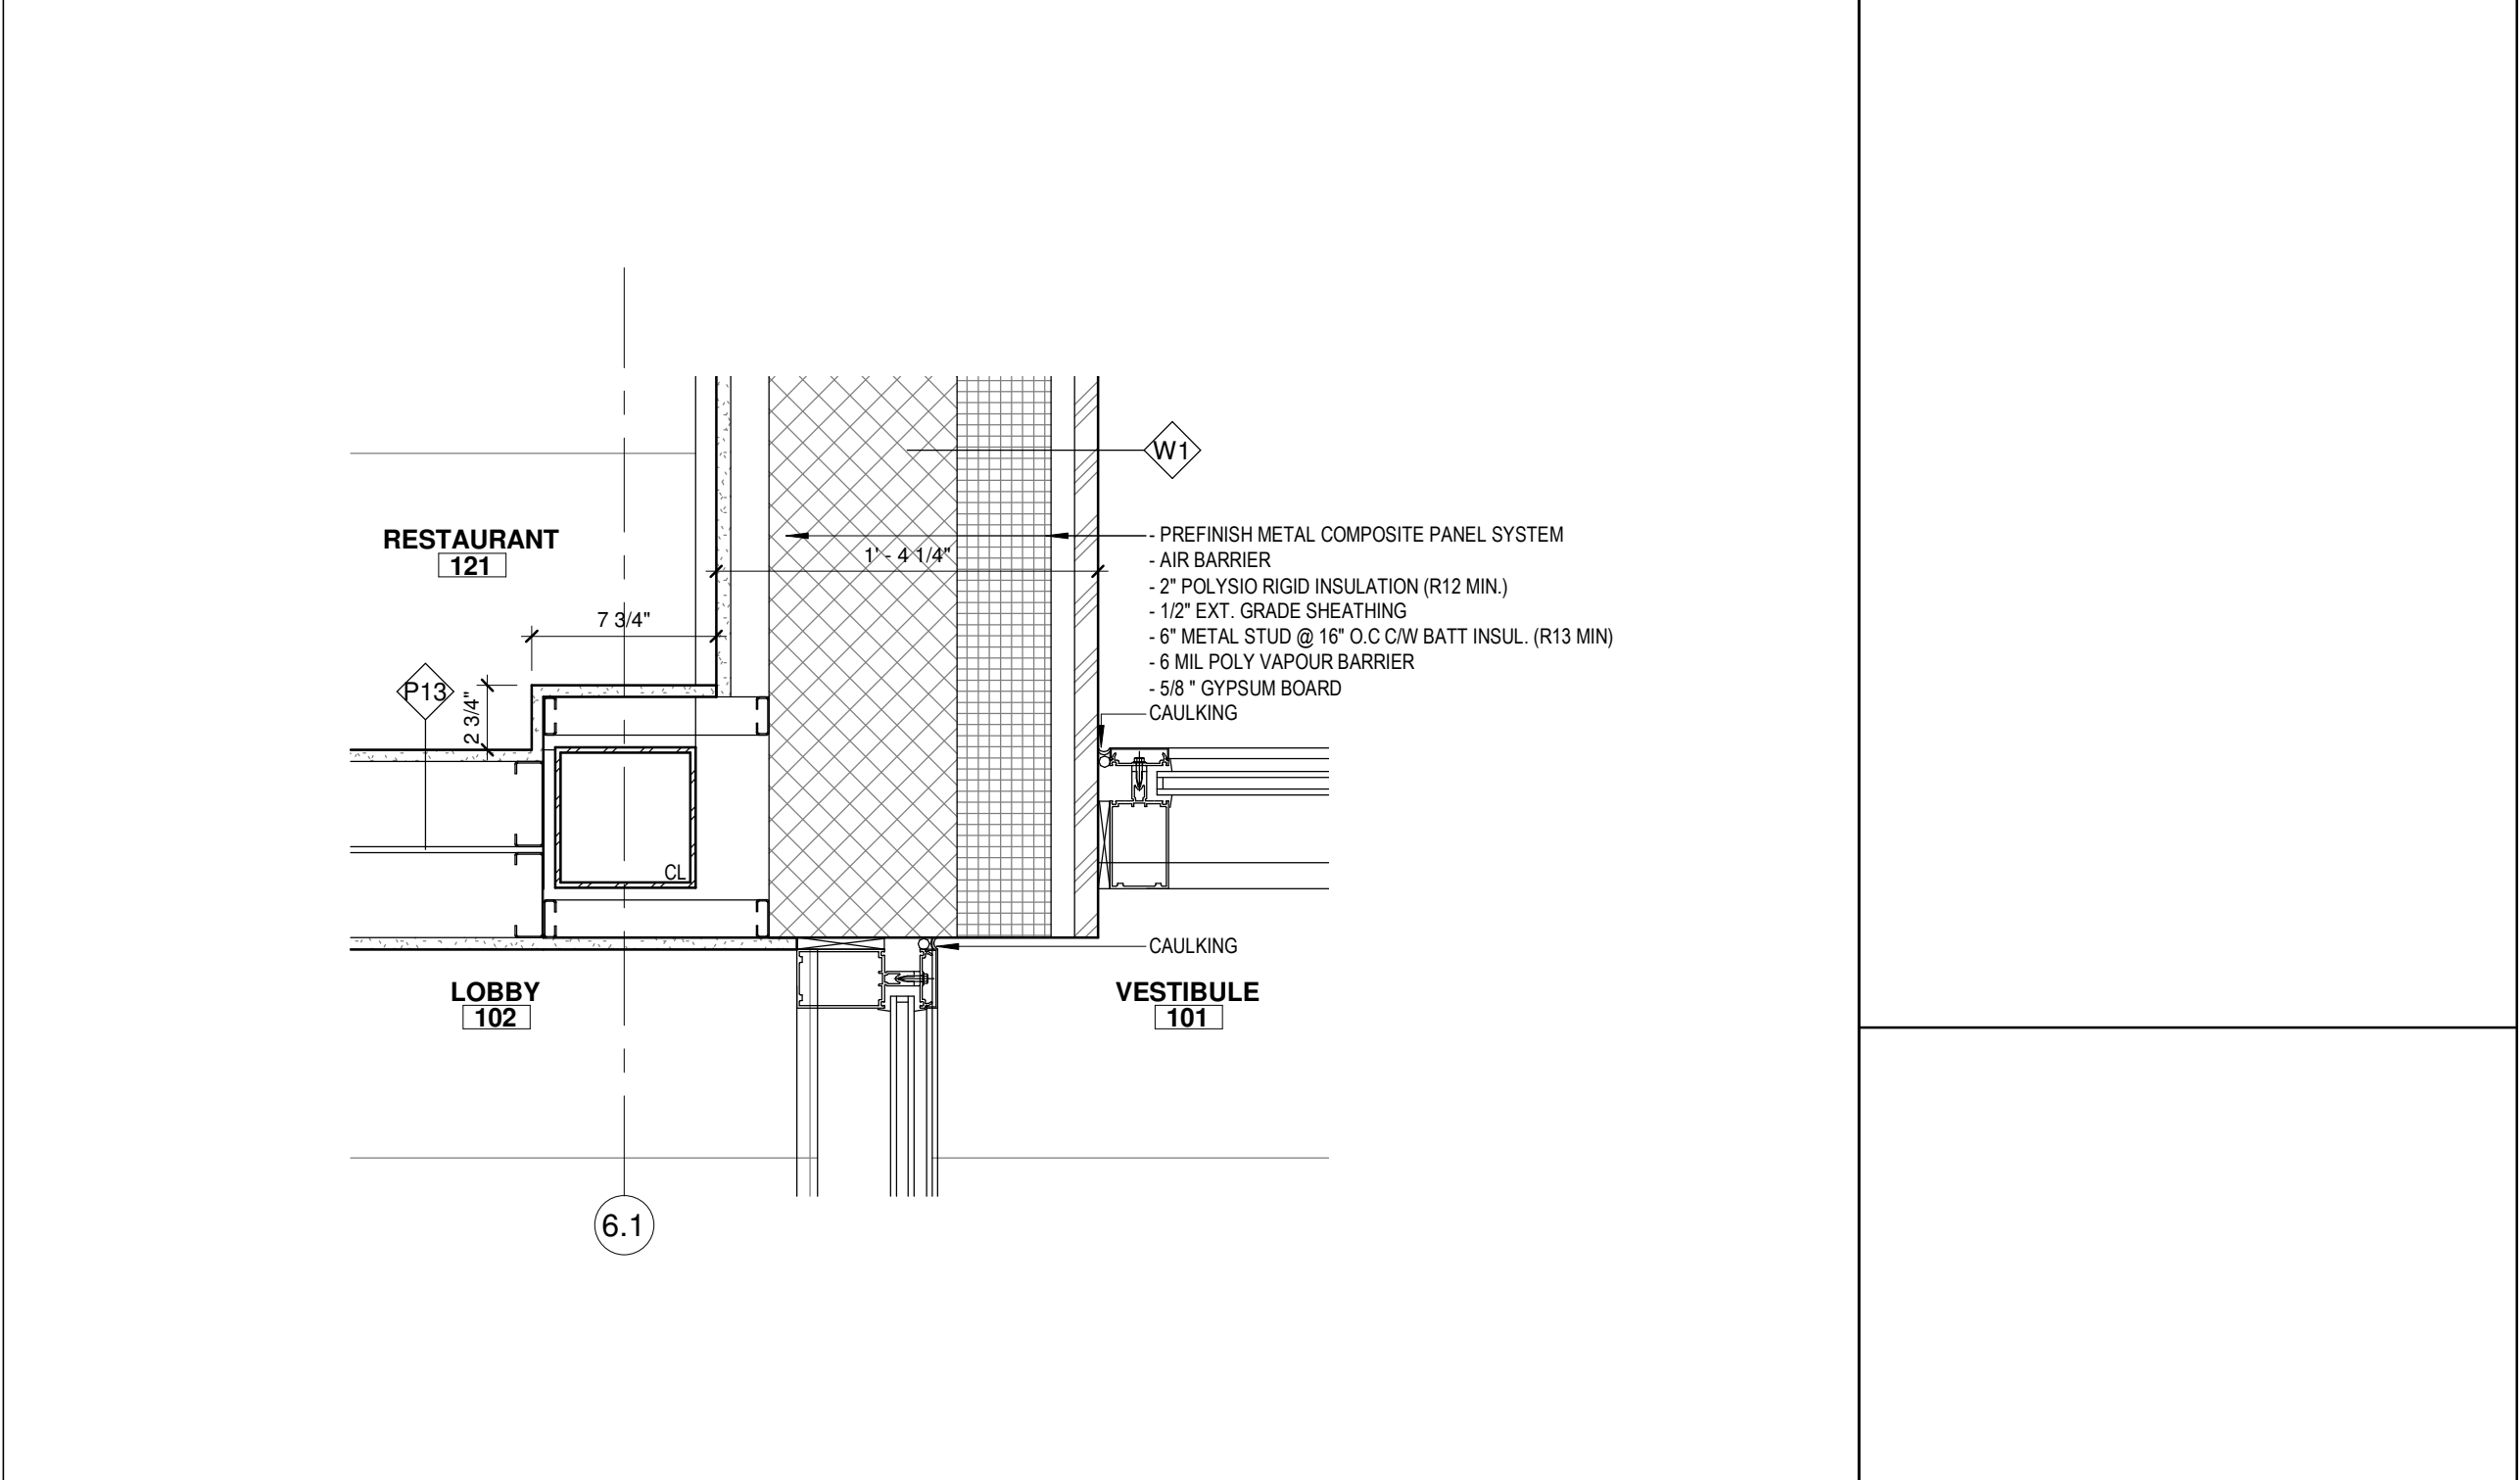

3 PLAN DETAIL 3
1 1/2" = 1'-0"

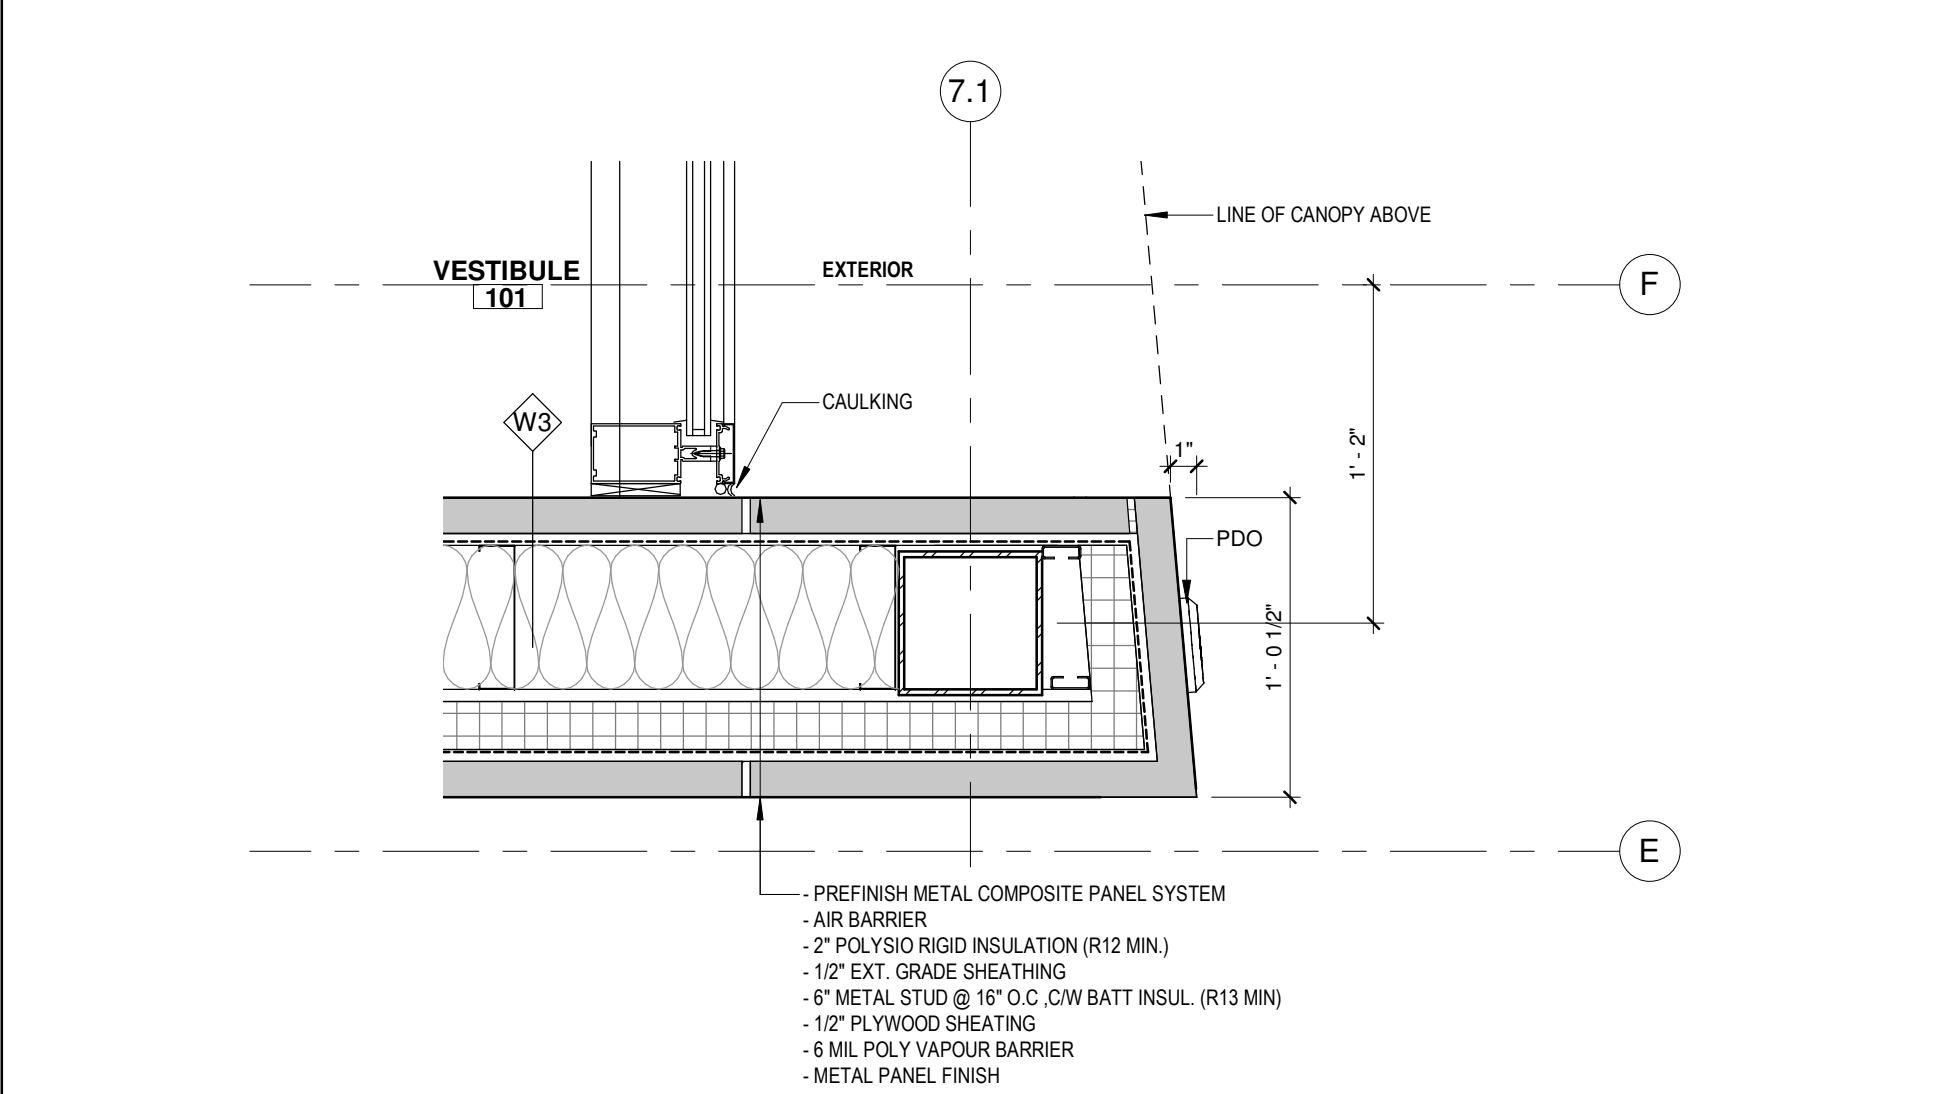

4 PLAN DETAIL 4
1 1/2" = 1'-0"

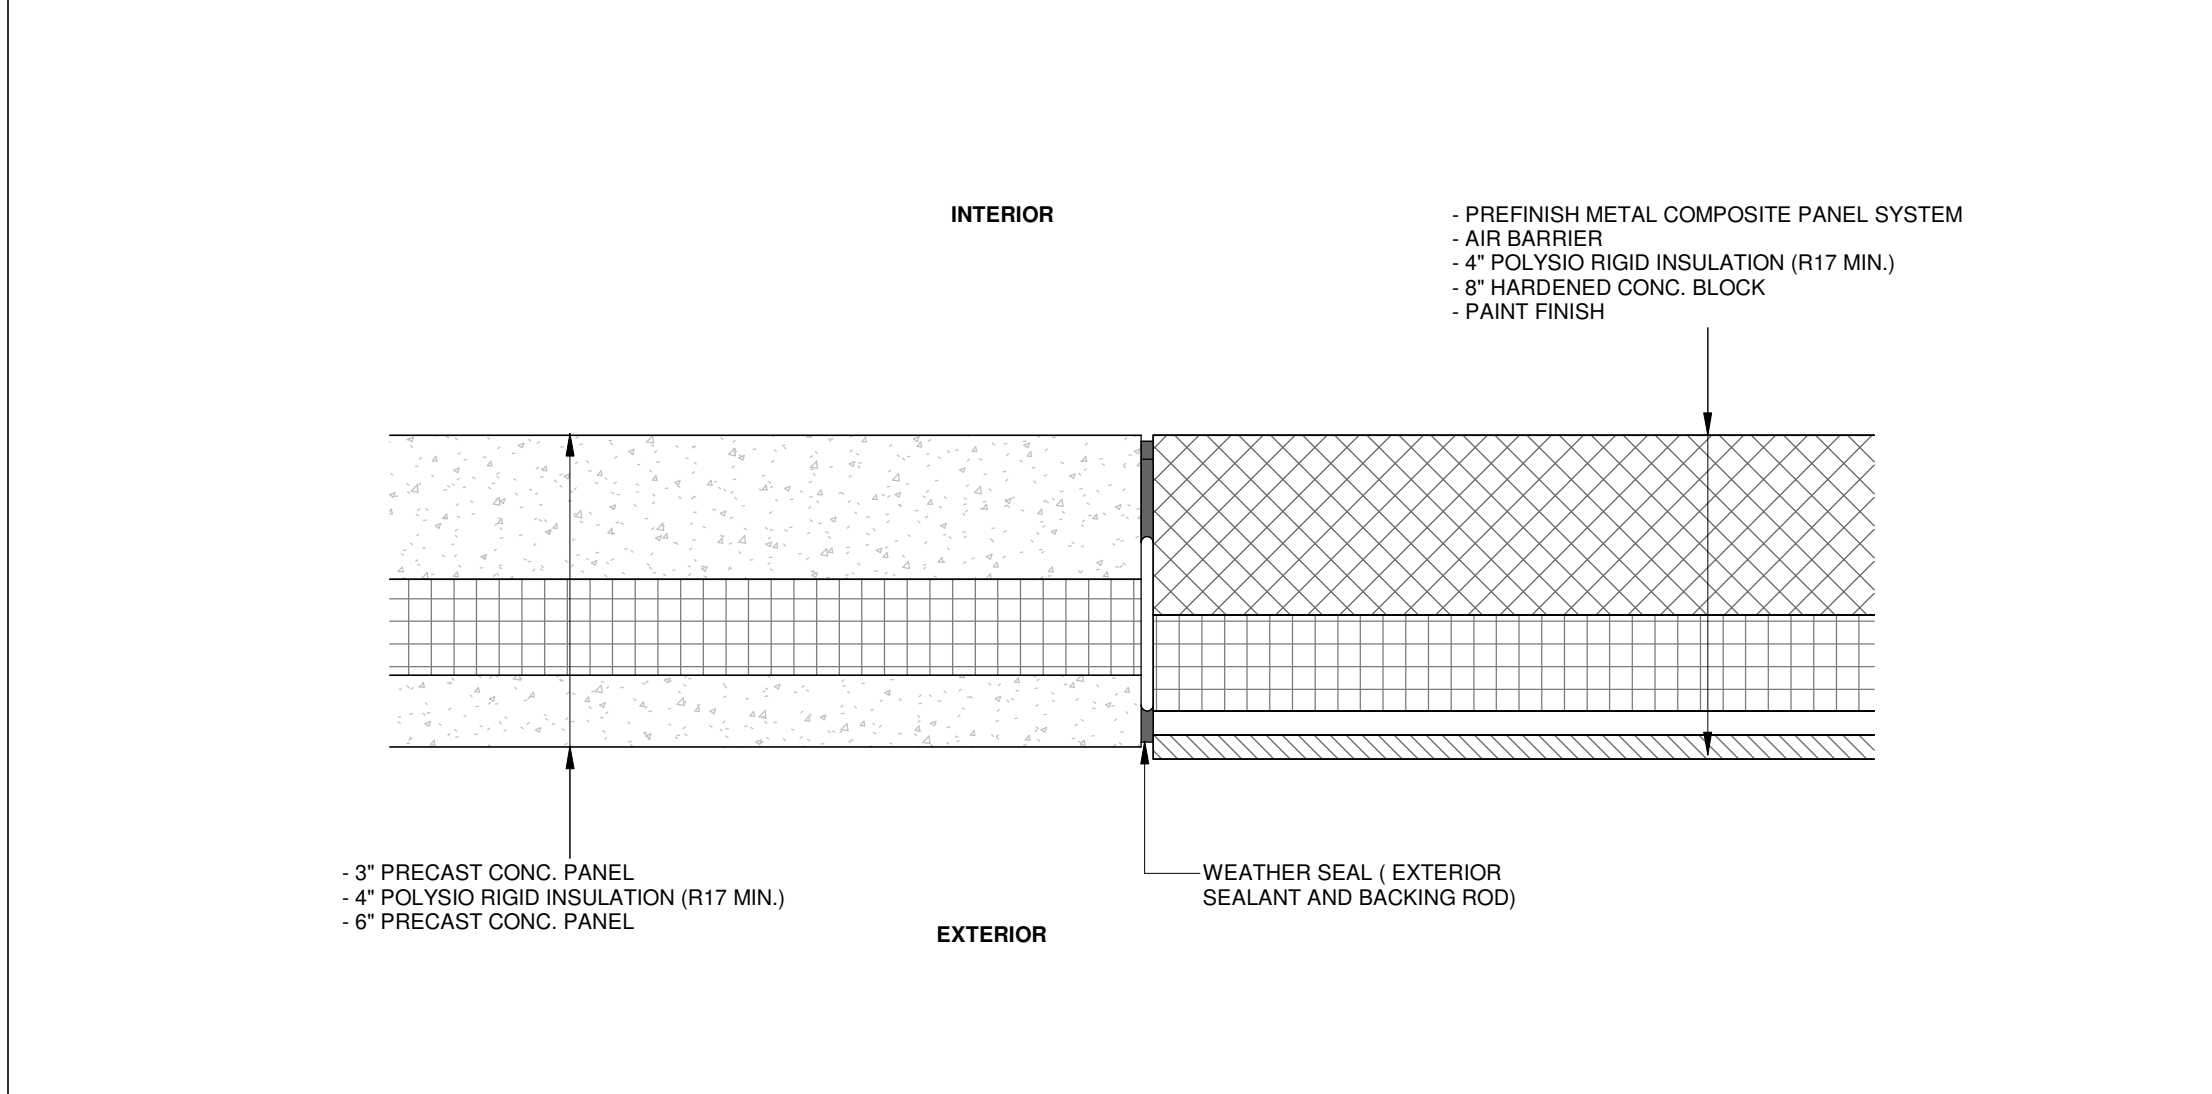

5 PLAN DETAIL 5
1 1/2" = 1'-0"

1	05/28/2025	ISSUED FOR PERMIT	HW
No.	Date:	Issued/Revision:	By

Client:



WANG ARCHITECTS INC.
3950 14th Ave, Unit 609
Markham, ON L3R 0A9
T: 905-604-6960
E: info@wangarchitects.ca
www.wangarchitects.ca



Project :
FIREARMS OUTLET CANADA

725 WESTNEY RD. S.,
AJAX, ON L1S 7J7

Drawing Name :
PLAN DETAILS

Scale :	1 1/2" = 1'-0"	Project No :	00026
Drawn by :	JW	Drawing No :	
Checked by :	HW		

A5.3