

CONCEAL CONDUITS/CABLES IN -

WALL FURRING

FOR POWEŔ.

NUMBER

CONDUIT C/W WIRE -

TYPE WRITTEN CIRCUIT


SINGLE GANG BACK BOX-

DEDICATED DUPLEX

(TO BE BLACK WITH STAINLESS STEEL

RECEPTACLE


SCALE = NTS

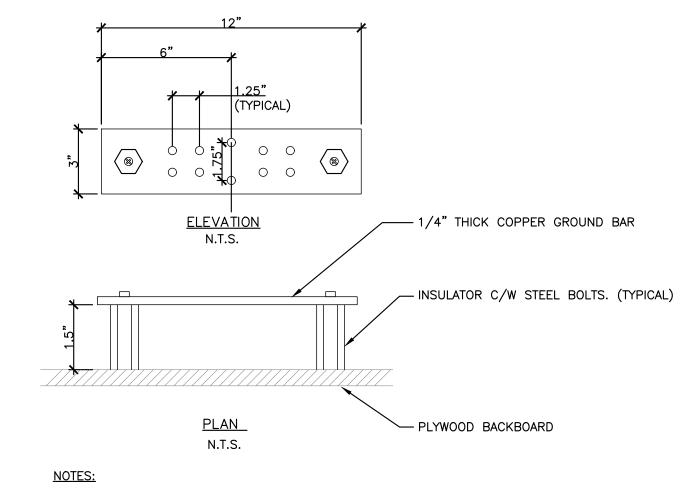

- 1. COVER TIPS, LUGS AND COPPER GROUND BAR WITH 'PENETROX E' FROM 'BURNDY' OR 'KOPR-SHIELD' FROM 'THOMAS & BETTS'.
- 2. INSTALL 2 HOLE COMPRESSION LUGS 'BURNDY/HYLUG' TYPE YAL2T FROM GROUND CONDUCTORS C/W DRUIUM BOLTS, NUTS AND WASHERS.
- 3. PROVIDE ONE #6 GREEN INSULATED GROUNDING CONDUCTOR TO MAIN BUILDING GROUND IN THE NEAREST BASE BUILDING ELECTRICAL ROOM ON THIS FLOOR.

GROUND BAR DETAIL - SCALE = NTS

SCALE = NTS

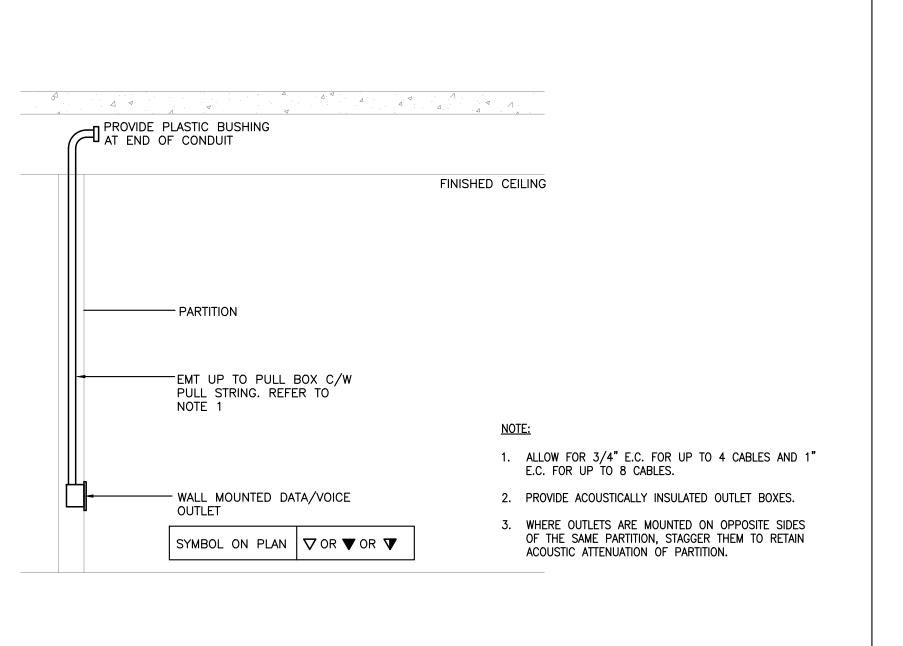

· 3/4" CONDUIT UP TO ACCESSABLE CEILING

- PHONE/DATA JACKS AND PLATES SUPPLIED AND

INSTALLED BY COMMUNICATIONS CONTRACTOR

1. PROVIDE ACOUSTICALLY INSULATED OUTLET BOXES.

ACOUSTIC ATTENUATION OF PARTITION.

2. WHERE OUTLETS ARE MOUNTED ON OPPOSITE SIDES

OF THE SAME PARTITION, STAGGER THEM TO RETAIN

SPACE FOR COMMUNICATIONS CABLES.

SECTIONS OF DATA/VOICE WALL OUTLET

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PH.: (905) 946 4260 FAX: (905) 946 0901

Job No : 25016

2025-05-28 ISSUED FOR PERMIT/TENDER REVIEW JG 2025-05-02 ISSUED FOR REVIEW Issued/Revision: No. Date:

2025-06-12 ISSUED FOR TENDER




FIREARMS OUTLET CANADA


725 WESTNEY ROAD SOUTH, AJAX, ONTARIO L1S 7J7


rawing Name:

ELECTRICAL LEGEND AND DETAILS

JAN 2025 Project No: AS NOTED E1.0

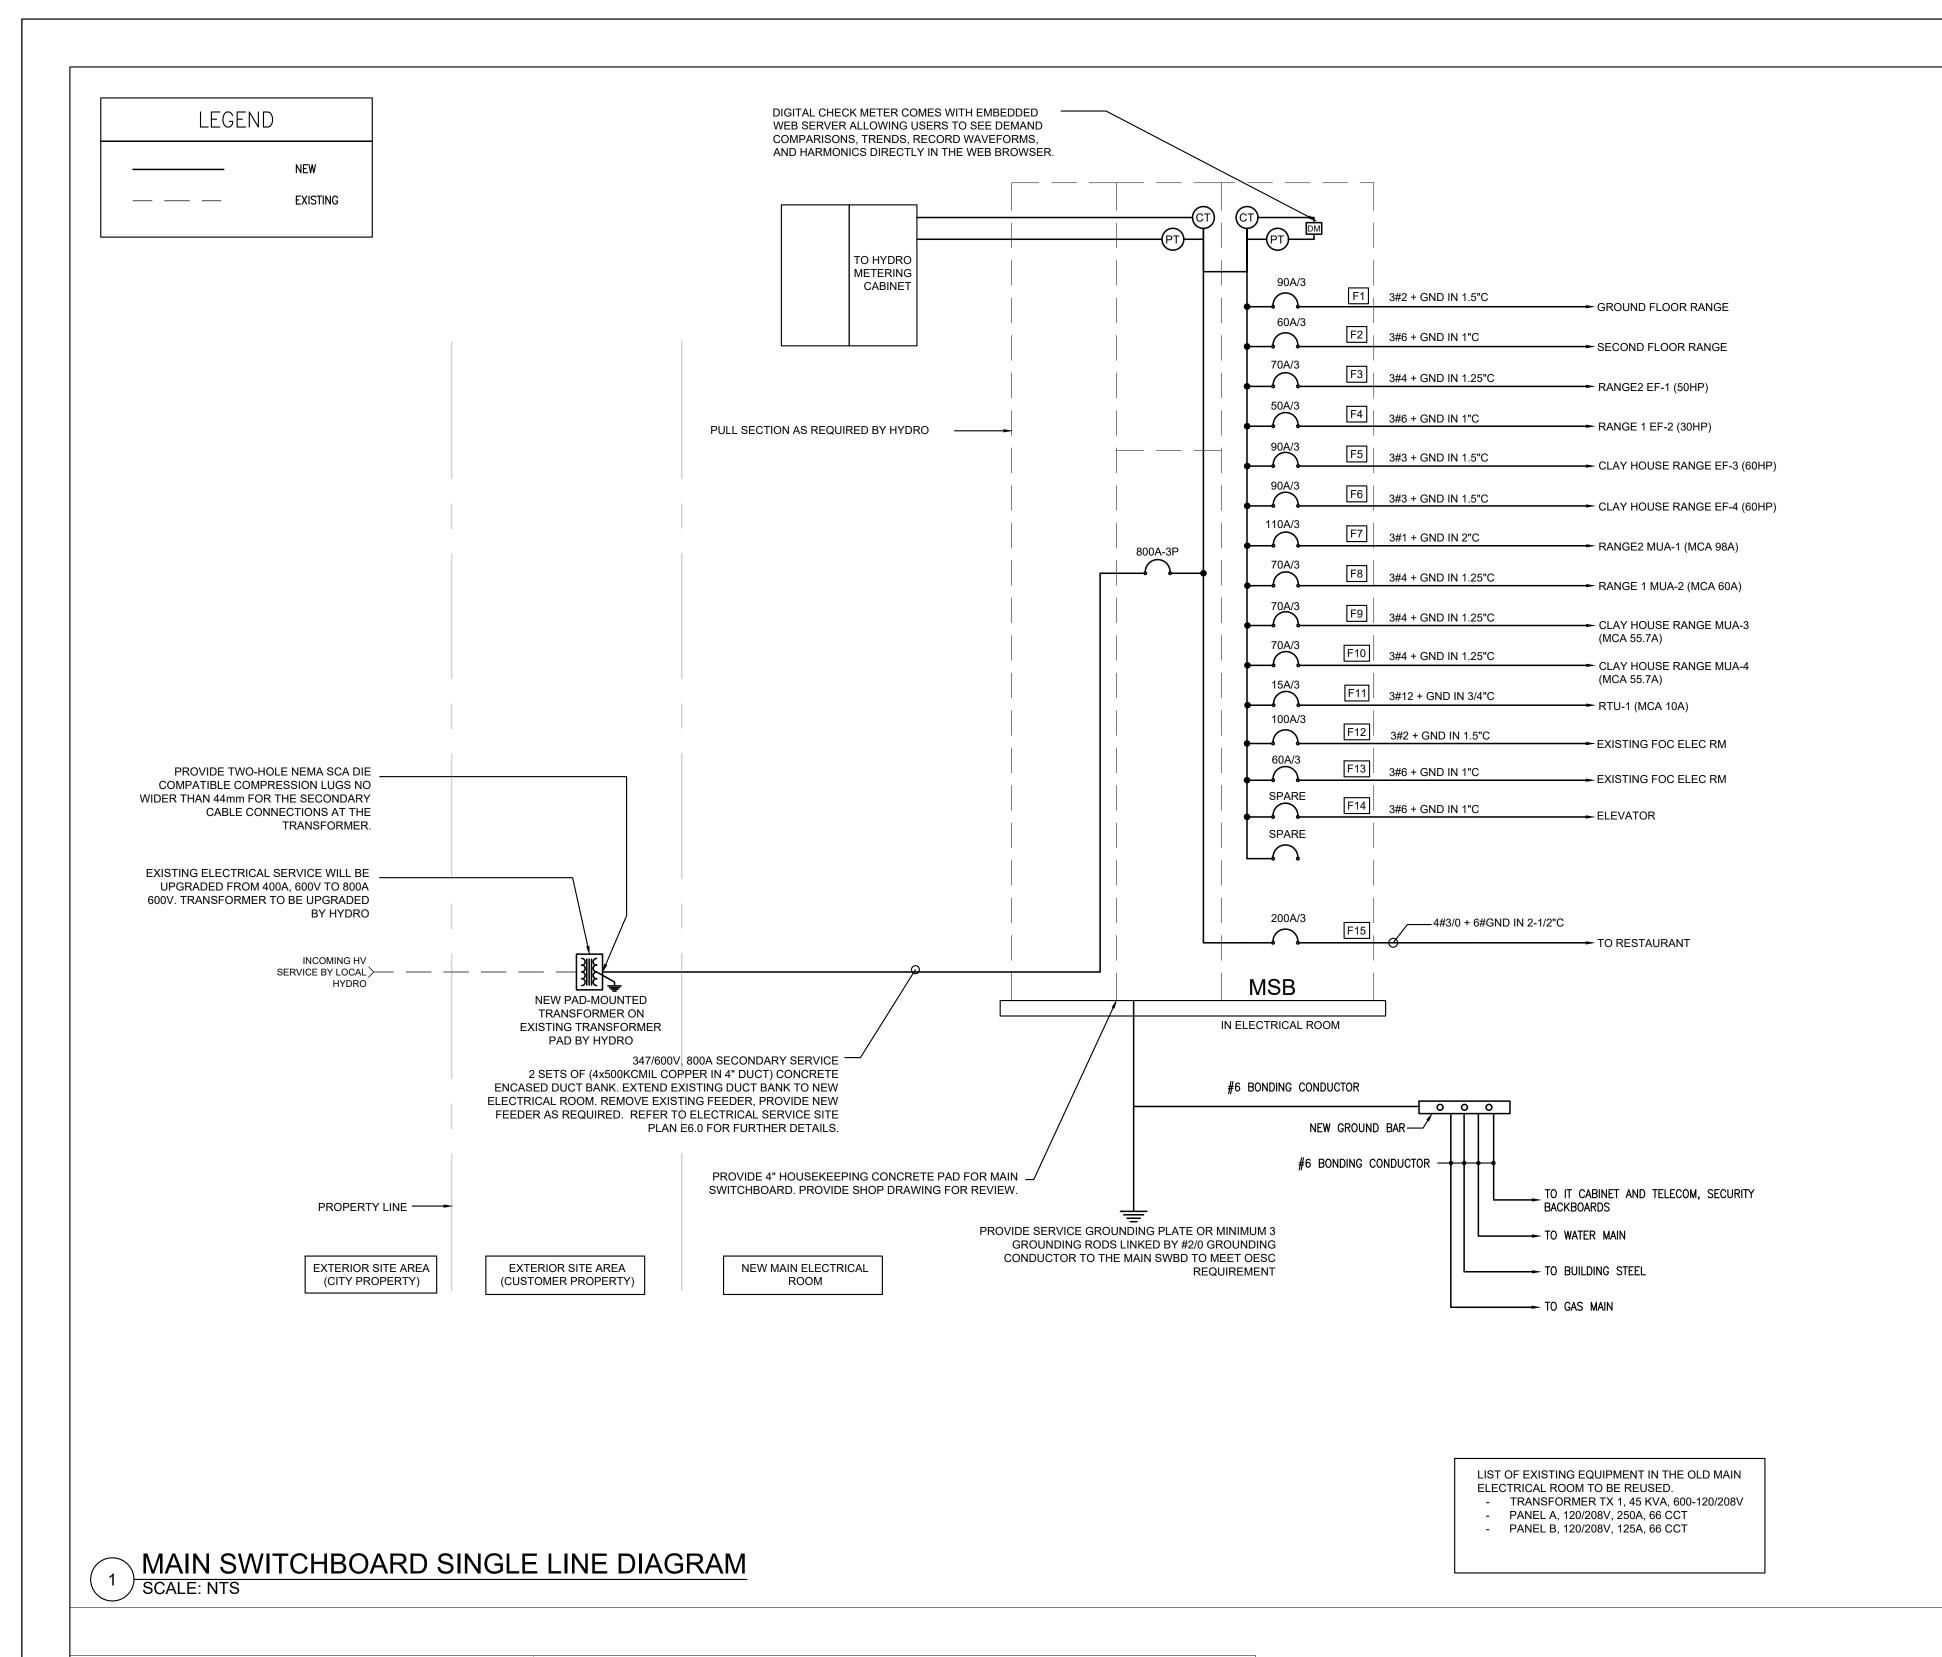

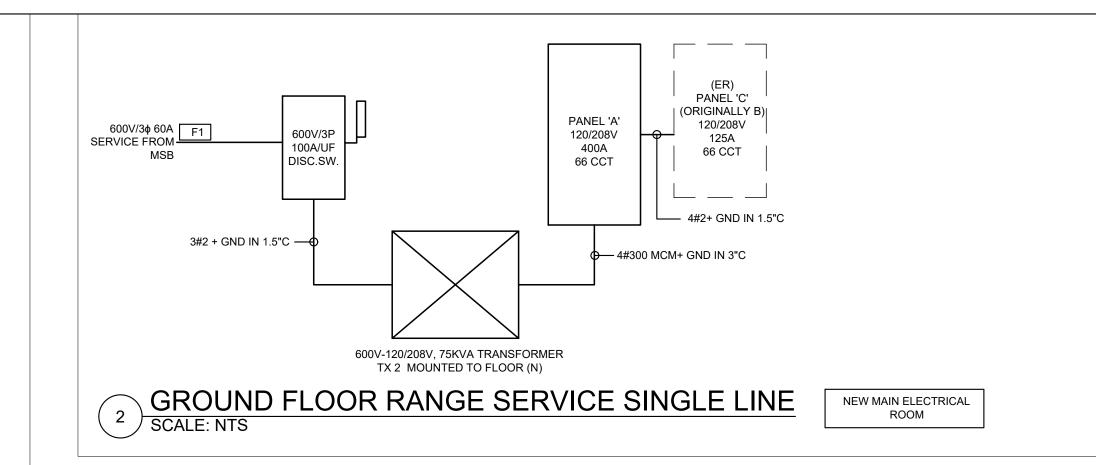

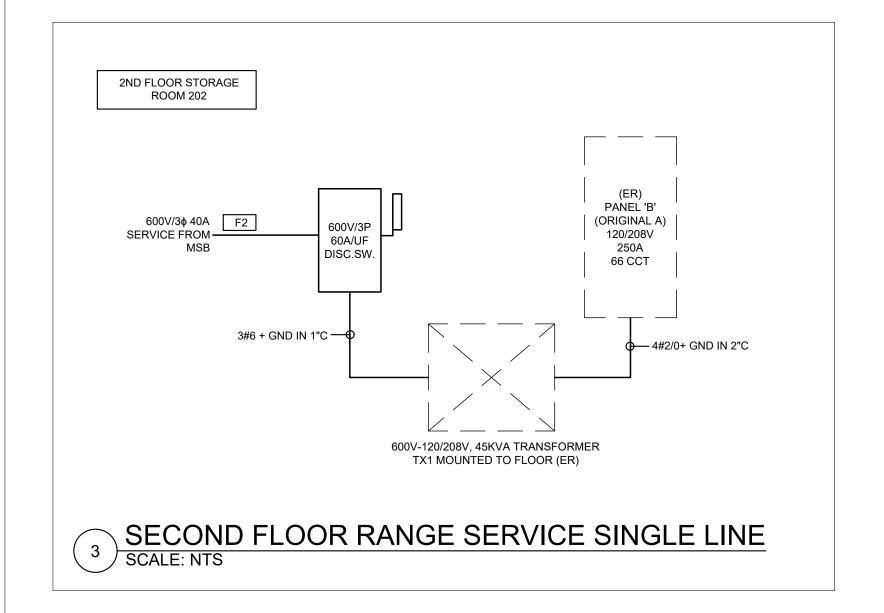

3 2025-06-12 ISSUED FOR TENDER JG
2 2025-05-28 ISSUED FOR PERMIT/TENDER REVIEW JG
1 2025-05-02 ISSUED FOR REVIEW JAC
No. Date: Issued/Revision: By

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THOMAS A. FEKETE LIMITED

7181 WOODBINE AVE. UNIT 229

PH.: (905) 946 4260 FAX: (905) 946 0901

Job No : 25016



ect:

FIREARMS OUTLET CANADA

725 WESTNEY ROAD SOUTH, AJAX, ONTARIO L1S 7J7

Drawing Name :

ELECTRICAL SINGLE LINE DIAGRAMS

te JAN 2025 Project No : 25016

ale :


AS NOTED


awn by :

JAC

Drawing No :

E1.1

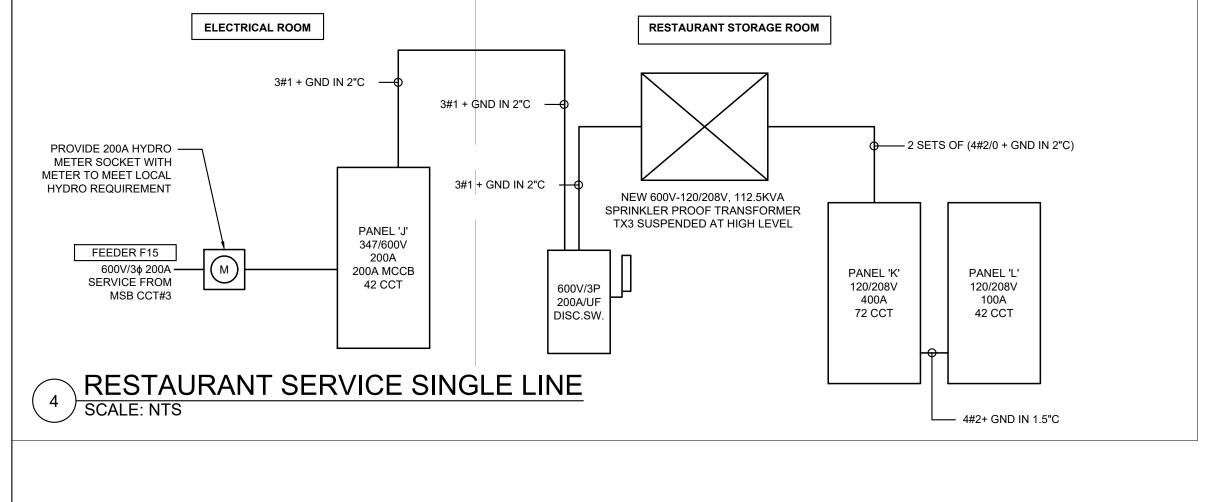

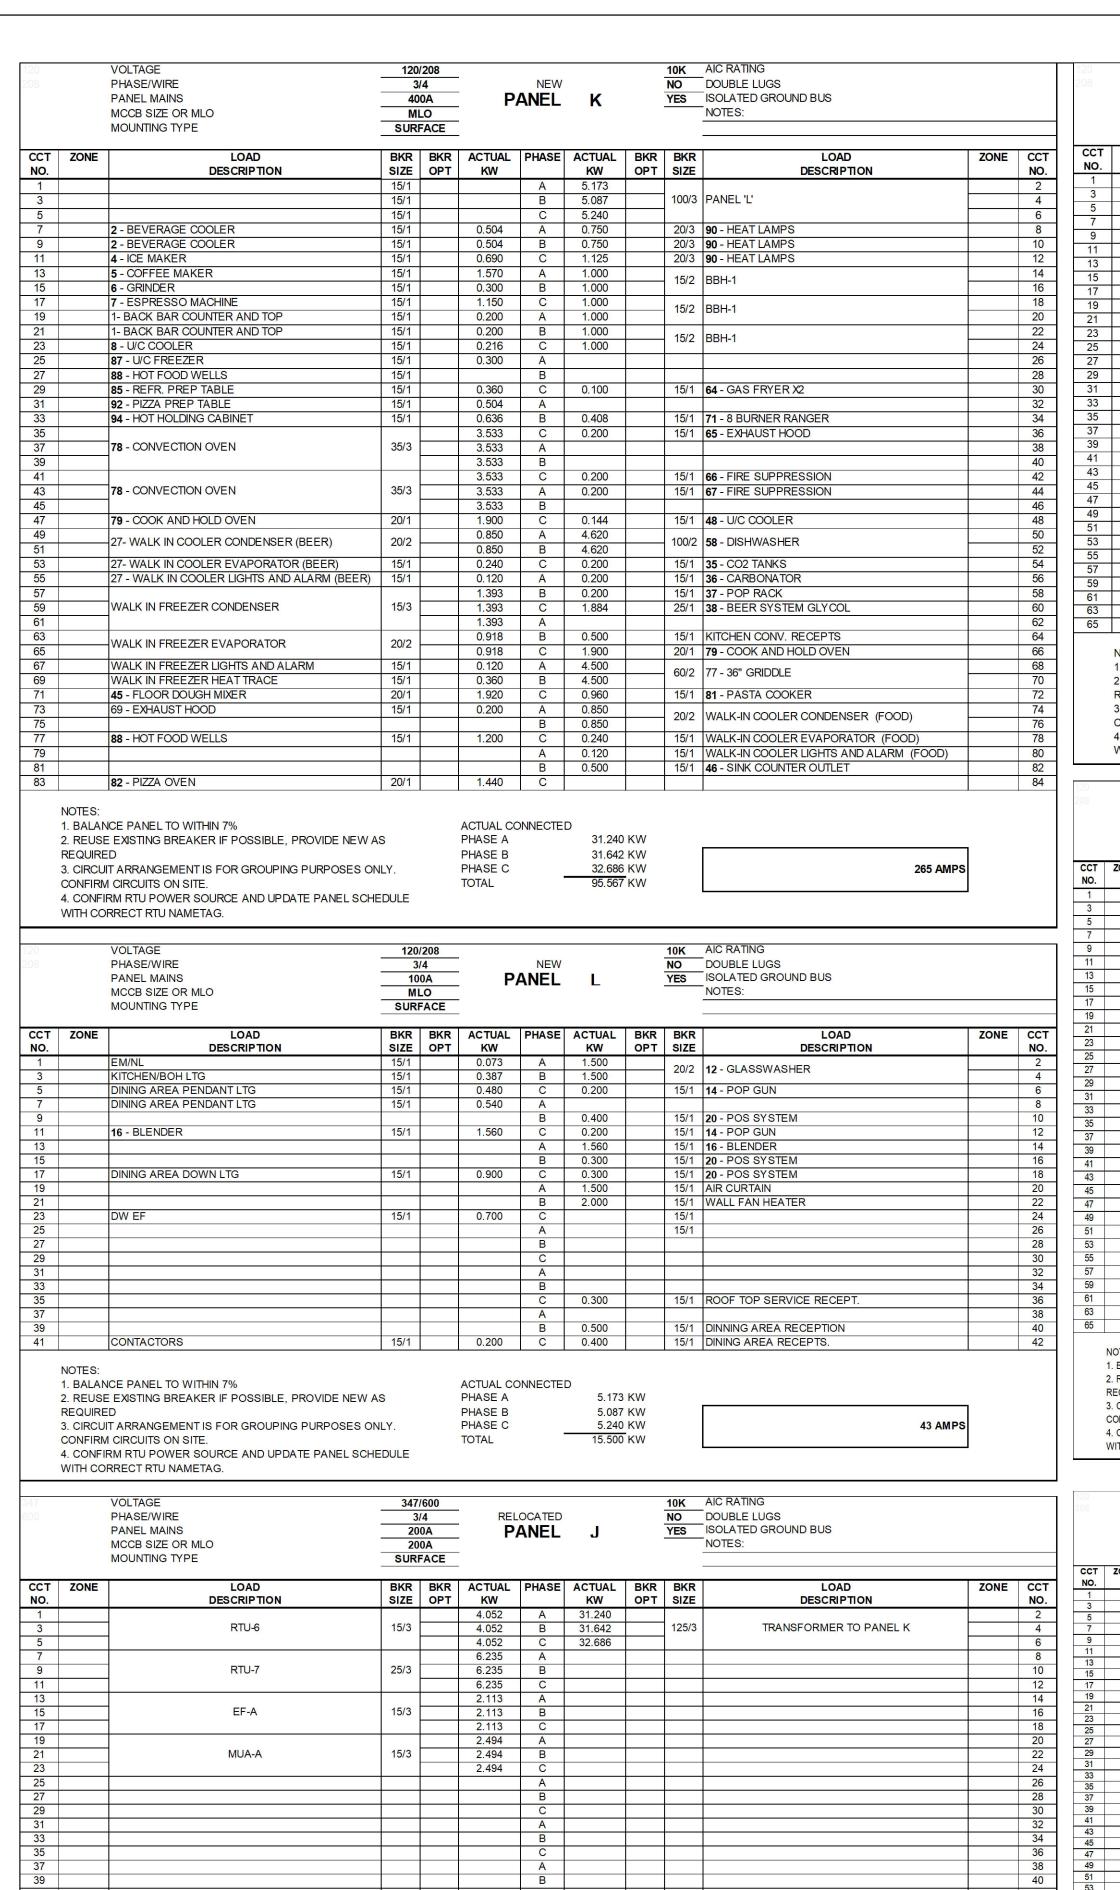

ACTUAL CONNECTED

46.134 KW

46.536 KW

47.580 KW

140.249 KW

135 AMPS

PHASE A

PHASE B

PHASE C

TOTAL

NOTES:

REQUIRED

1. BALANCE PANEL TO WITHIN 7%

CONFIRM CIRCUITS ON SITE.

WITH CORRECT RTU NAMETAG.

2. REUSE EXISTING BREAKER IF POSSIBLE, PROVIDE NEW AS

3. CIRCUIT ARRANGEMENT IS FOR GROUPING PURPOSES ONLY.

4. CONFIRM RTU POWER SOURCE AND UPDATE PANEL SCHEDULE

CCT ZONE	MOUNTING TYPE	ML		P	NEW ANEL	Α		NO YES	AIC RATING DOUBLE LUGS ISOLATED GROUND BUS NOTES:		
NO.	LOAD DESCRIPTION	BKR SIZE	BKR OPT	ACTUAL KW	PHASE	ACTUAL KW	BKR OPT	BKR SIZE	LOAD DESCRIPTION	ZONE	CC
	EM/NL	15/1	OFI	0.217	Α	0.200	OF I		EXIT SIGNS		2
	GF RANGE 1 LTG	20/1		0.900	В	0.500		600,000 5	SIGNAGE		4
-	GF RANGE 1 LTG	20/1		1.200	C	0.994		0.000	EXTERIOR LIGHTING		6
	GF RANGE 2 LTG	15/1		1.200	A	0.300	<u> </u>		WASHROOM GFI		8
	GF RANGE 2 LTG	15/1		1.200	В	0.500			CLASSROOM RECEPS		10
	GF RANGE 2 LTG	15/1		1.200	C	0.300		0.0000 0	CLASSROOM RECEPS		12
1811811	GF RANGE 2 LTG	15/1		0.600	A	0.300		-	CLASSROOM RECEPS		14
	WAREHOUSE LTG	15/1		0.540	В	0.500			OFFICE RECEPTS		16
17	GUN LOCKER/CLASSROOM AREA LTG	15/1		0.451	C	0.800			PRINTERS		18
19	LOBBY/CORRIDOR LTG	15/1		0.707	A	0.800	<u> </u>	B10 x 000 /5	PRINTERS		20
	WASHROOM LTG	15/1		0.707	В	0.800			PRINTERS		22
	SERVICE AREA LTG	15/1		0.266	C	0.500			RANGE LOBBY COUNTER RECEPS		24
	RANGE DRIVE UNIT	15/1		0.600	A	0.500			RANGE LOBBY BACK RECEPTS		26
N. C. 101	RANGE DRIVE UNIT	15/1		0.600	В	0.500		N 1511071 11	RANGE NMC		28
	RANGE DRIVE UNIT	15/1		0.600	C	0.300			RANGE WI-FI ROUTERS		30
	RANGE DRIVE UNIT	15/1		0.600	A	0.500	<u> </u>		RANGE LOBBY RECEPTION RECEPS		32
	RANGE DRIVE UNIT	15/1		0.600	В	0.300			RANGE GENERAL RECEPT.		34
	RANGE DRIVE UNIT	15/1		0.600	C	0.500	<u> </u>	BITTON A	STORAGE 2 PC		36
	RANGE DRIVE UNIT	15/1		0.600	A	0.800		P. 150000 V.	ELEVATOR MACHINE RM/PIT LTG		38
	RANGE DRIVE UNIT	15/1		0.600	В	0.200			CONTACTORS		40
41	RANGE DRIVE UNIT	15/1		0.600	C	0.500			CONVENIENCE RECEPTS.		42
	RANGE DRIVE UNIT	15/1		0.600	A	0.500			W/R AUTODOOR		44
4.90	RANGE DRIVE UNIT	15/1		0.600	В	0.300		7 1	MECH ROOM RECEPT.		46
77	RANGE DRIVE UNIT	15/1		0.600	C	0.300			WAREHOUSE PC		48
	RANGE DRIVE UNIT	15/1		0.600	A	1.000		15/1			50
	RANGE DRIVE UNIT	15/1		0.600	B	1.000	<u> </u>	15/1	HD		52
100.70	20 28 - AB 100 RG BLUC SOCIONE 988 B 1000 MA R BROW X	15/1		0.600	C	1.000	<u> </u>	15/1	N5. 70-10		54
	RANGE DRIVE UNIT	15/1		0.600	A	0.200	<u> </u>		The same and		56
<u> </u>	RANGE DRIVE UNIT	15/1		0.800	B	0.200			ELEV PIT RECEPT. ROOF TOP SERVICE RECEPT.		58
	RANAGE BOOTH LIGHT	15/1		0.330	C		<u> </u>				60
59		13/1		0.040		0.400	<u> </u>		ROOF TOP SERVICE RECEPT.		
61	PANEL "C"	100/3		8.810 10.880	A B	0.500	<u> </u>		WAREHOUSE PC ELEVATOR CAB LIGHTING		62 64
65	FANEL C	100/3		10.350	C	0.300			SPARE SPARE		66

LOAD DESCRIPTION LIGHTING DOTH LIGHTING UNGE LIGHTING	BKR SIZE 15/1 15/1 15/1 15/1 15/1 15/1 20/1 20/1 20/1	BKR OPT	ACTUAL KW 0.164 0.000 0.570 0.250 0.350	A B C A B	ACTUAL KW 0.100 0.700 0.700 0.700	BKR OPT		LOAD DESCRIPTION EXIT SIGN CLAY THROWER	ZONE
DOTH LIGHTING INGE LIGHTING INGE LIGHTING INGE LIGHTING INGE LIGHTING INGE LIGHTING	15/1 15/1 15/1 15/1 15/1 15/1 20/1 20/1		0.000 0.570 0.250	B C A	0.700 0.700		15/1		
DOTH LIGHTING INGE LIGHTING INGE LIGHTING INGE LIGHTING INGE LIGHTING INGE LIGHTING	15/1 15/1 15/1 15/1 15/1 20/1 20/1		0.570 0.250	C A	0.700		A 50.0	CLAY THROWER	
DOTH LIGHTING INGE LIGHTING INGE LIGHTING INGE LIGHTING INGE LIGHTING INGE LIGHTING	15/1 15/1 15/1 15/1 20/1 20/1		0.570 0.250	Α	-10.50		AFIA		
DOTH LIGHTING INGE LIGHTING INGE LIGHTING INGE LIGHTING INGE LIGHTING INGE LIGHTING	15/1 15/1 15/1 20/1 20/1		0.570 0.250		0.700		15/1	CLAY THROWER	
DOTH LIGHTING INGE LIGHTING INGE LIGHTING INGE LIGHTING INGE LIGHTING INGE LIGHTING	15/1 15/1 20/1 20/1		0.250	B			15/1	CLAY THROWER	
NGE LIGHTING NGE LIGHTING NGE LIGHTING NGE LIGHTING	15/1 20/1 20/1				0.700		15/1	CLAY THROWER	
NGE LIGHTING NGE LIGHTING NGE LIGHTING NGE LIGHTING	15/1 20/1 20/1		0.350	С	0.700		15/1	CLAY THROWER	
NGE LIGHTING NGE LIGHTING NGE LIGHTING NGE LIGHTING	20/1			A	0.700		15/1	CLAY THROWER	
NGE LIGHTING NGE LIGHTING NGE LIGHTING	20/1		0.600	В	0.700		15/1	CLAY THROWER	
NGE LIGHTING		1	1.200	C	0.700		0.00.0	CLAY THROWER	
NGE LIGHTING	20/		1.200	A	0.500			RANAGE RECP.	
CONTRACTOR AND CONTRACTOR CONTRAC	20/1		1.200	В	0.500		15/1	TV	
	20/1		1.200	C	0.500		15/1	TV	
NGE BLUE LT	20/1		0.780	A	0.500		15/1	TV	
NGE BLUE LT	20/1		0.780	В	0.300		15/1	TV	
NGE BLUE LT	20/1		0.780	C	0.500		15/1	CONVEN. RECEPT.	
Director activities and				75			615.61	The Control of the Co	
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MINACOLO SI MILLON MINA		_	50.000000000000000000000000000000000000				0.50.01	BLOOK EXCENSION OF THE PROPERTY THE TOO SO IS NOT SO THE STREET OF THE S	
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INGE BLUE LI	20/1		0.760	1000			0.50.01	2009/PERO 3/400-3/400-001 - 5/400 00 - 599/PERO 5/400 - 5/400	
							0.000.0		
					0.500		15/1	CCTV RACK	
				-					
				10.00					
	\longrightarrow								
				100					
				10.00					
				100					
VA	NT IS FOR GROUPING PURPOS	ANGE BLUE LT 20/1 ANGE BLUE LT 20/1 WITHIN 7% AKER IF POSSIBLE, PROVIDE NEW AS NT IS FOR GROUPING PURPOSES ONLY.	ANGE BLUE LT 20/1 ANGE BLUE LT 20/1 WITHIN 7% AKER IF POSSIBLE, PROVIDE NEW AS NT IS FOR GROUPING PURPOSES ONLY.	ANGE BLUE LT 20/1 0.780 WITHIN 7% AKER IF POSSIBLE, PROVIDE NEW AS PHASE A PHASE B PHASE C TOTAL	ANGE BLUE LT	ANGE BLUE LT	ANGE BLUE LT	ANGE BLUE LT	ANGE BLUE LT

	MCCB SIZE OR MLO MOUNTING TYPE	ML SURF			OCATED ANEL	С		10K NO YES	DOUBLE LUGS ISOLATED GROUND BUS NOTES:		
CT ZO	DNE LOAD DESCRIPTION	BKR SIZE	BKR OPT	ACTUAL	PHASE	ACTUAL KW	BKR OPT	BKR SIZE	LOAD DESCRIPTION	ZONE	CC
1	SPARE	15/1		0.000	Α	0.500		15/1	MAIN LOBBY COUNTER RECEPT.		
3	EF-C	15/1		0.130	В	0.500		15/1	CONVENIENT RECEP		1
5	111.0	45/0		1.000	С			15/1	SPARE		(
7	UH-2	15/2		1.000	Α	0.300		15/1	LOBBY AUTODOOR		8
9	UH-3	15/0		1.000	В	0.200		15/1	RANGE CONTROL BOX		1
11	Un-3	15/2		1.000	С	0.500		15/1	OFFICE 3 PC		1
13	UH-1	15/2		1.000	Α	0.200		15/1	MAIN LOBBY COUNTER RECEPT.		1
15	U⊓-1	15/2		1.000	В	1.500		25/2	CU-1		1
17	EFH-1	25/2		2.000	С	1.500		2312	00-1		1
19	Ern-I	25/2		2.000	Α	0.300		15/1	RANGE SYSTEM 1 CONTROLLER		2
21	EFH-1	25/2		2.000	В	0.300		15/1	RANGE SYSTEM 2 CONTROLLER		2
23	P-35, /3 (8) 81	25/2		2.000	С	0.300		15/1	TELECOM RECEPT.		2
25	EF-D	15/1		0.140	Α	0.500		15/1	STORAGE 3 PC		2
27	EF-E	15/1		0.050	В	0.100		15/1	HWT-1		2
29	EF-F	15/1		0.050	С	0.500		15/1	SECURITY OUTLET		3
31	EF-G	15/1		0.070	Α	0.500		15/1	SECURITY OUTLET		3
33	EFH-1	25/2		2.000	В	0.100		15/1	HWT-2		3
35	L1 11-1	23/2		2.000	C			15/1	SPARE		3
37	EFH-1	25/2		2.000	Α	0.800		15/1	LOBBY TV		3
39	LI 11=1	23/2		2.000	В	0.500		15/1	CCTV RACK		4
41	LOBBY TV	15/1		0.200	С	0.500		15/1	CCTV RACK		4
43	SPARE	15/1			Α						4
45	SPARE	15/1			В						4
47	SPARE	20/1			С						4
49					Α						5
51					В						5
53					С						5
55					Α						5
57					В						5
59					С						6
61					Α						6
63					В					-	6
65					C						6

	45	KVA TX1 TRANSF	ORMER LOAD SUMM	ARY
	LOAD DESCRIPTION	ACTUAL CONNECTED KW	DEMAND FACTOR	ACTUAL DEMAND KW
	LIGHTING	13.854	100%	13.854
Т	SIGNAGE	0.000	100%	0.000
).	WATER HEATER	0.000	100%	0.000
	KITCHEN EQUIPMENT	0.000	65%	0.000
	GEN. POWER	9.100	60%	5.460
	HEATING	0.000	100%	0.000
)	KEF/FREEZER/COOLER	0.000	100%	0.000
<u>?</u> I	COOLING	0.000	100%	0.000
3	MAU	0.000	100%	0.000
3	MOTOR	0.000	125%	0.000
)		22.954	TOTAL KW	19.314
2			TOTAL AMPS	18.58490517
	1			

NOTES: KVA USAGE 19.29 KVA TRANSFORMER SIZE

75	KVA TX2 TRANSFO	RMER LOAD SUMM	ARY	
LOAD DESCRIPTION	ACTUAL CONNECTED KW	DEMAND FACTOR	ACTUAL DEMAND KW	
LIGHTING	10.369	100%	10.369	
SIGNAGE	0.500	100%	0.500	
WATER HEATER	1.000	100%	1.000	
KITCHEN EQUIPMENT	0.000	65%	0.000	
GEN. POWER	26.800	60%	16.080	
HEATING	22.000	75%	16.500	
KEF/FREEZER/COOLER	0.000	100%	0.000	
COOLING	3.000	100%	3.000	
MAU	0.000	100%	0.000	
MOTOR	0.440	125%	0.550	
	64.109	TOTAL KW	47.999	
	,	TOTAL AMPS	46.18705928	

NOTES:

NOTES:

45 KVA

47.94 KVA

75 KVA

68.4350921

112.	5 KVA TX3 TRANSF	ORMER LOAD SUMI	WARY
LOAD DESCRIPTION	ACTUAL CONNECTED KW	DEMAND FACTOR	ACTUAL DEMAND KW
LIGHTING	2.380	100%	2.380
SIGNAGE	0.000	100%	0.000
WATER HEATER	0.000	100%	0.000
KITCHEN EQUIPMENT	66.505	65%	43.228
GEN. POWER	3.300	60%	1.980
HEATING	8.000	100%	8.000
FREEZER/COOLER	12.282	100%	12.282
COOLING	0.000	100%	0.000
MAU	0.000	100%	0.000
MOTOR	2.600	125%	3.250

KVA USAGE

TRANSFORMER SIZE

TOTAL KW

TOTAL AMPS

KVA USAGE 71.04 KVA TRANSFORMER SIZE 112.5 KVA

ELECTRI	CAL LOAD SUMMARY	347/ 600 V	SYSTEM
LOAD DESCRIPTION	ACTUAL CONNECTED KW	DEMAND FACTOR	ACTUAL DEMAND KW
LIGHTING	26.603	100%	26.603
SIGNAGE	0.500	100%	0.500
WATER HEATER	1.000	100%	1.000
KITCHEN EQUIPMENT	66.505	65%	43.228
GEN. POWER	39.200	60%	23.520
HEATING	30.000	0%	0.000
FREEZER/COOLER	12.282	100%	12.282
COOLING	101.409	75%	76.057
MAU	287.546	75%	215.660
MOTOR	232.807	75%	174.605
BUILDING A FOC LTG+PW			30.000
	797.852	TOTAL KW	603.455


		101.002	TOTALITATI	000.400
NOTES:				
	DEMAND KW			MIN. REQ'D ELECTRICAL SERVICE
	SYSTEM VOLTAGE x 1.732	= MINIMUM FEEDER AMPI	ERAGE	347/ 600 V-3P-3W
				726
	603.5 KW X 1000			INCOMING SERVICE SIZE
	600 V x 1.732	= 581 AMPS		347/ 600 V-3P-3W
				800A

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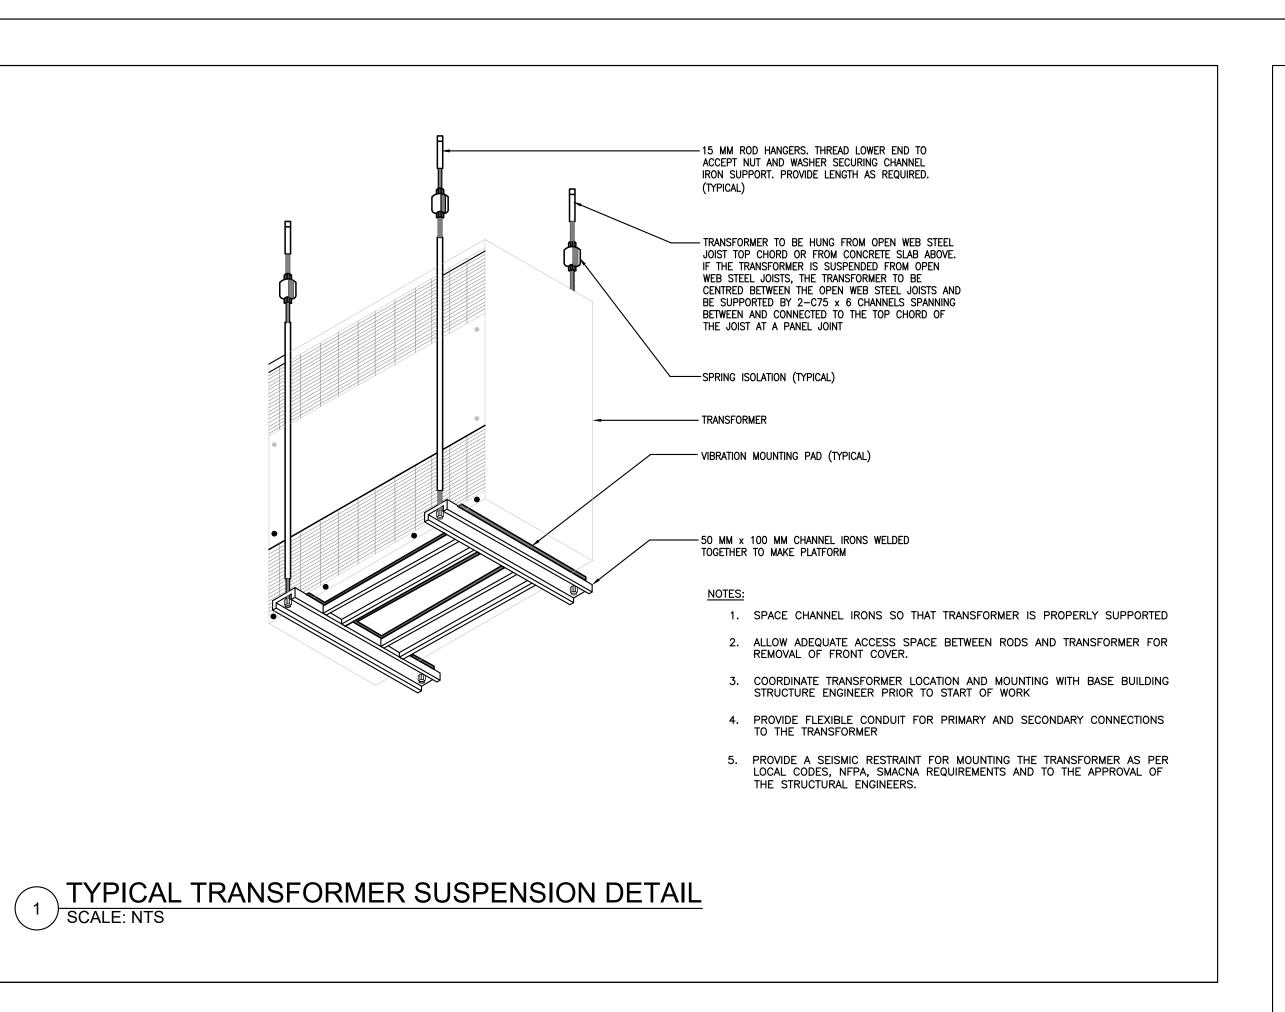
FIREARMS OUTLET CANADA


725 WESTNEY ROAD SOUTH, AJAX, ONTARIO L1S 7J7

Drawing Name:

ELECTRICAL PANEL SCHEDULES

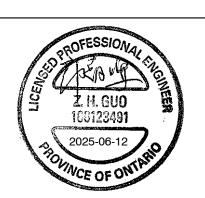Date	JAN 2025	Project No :	25016
Scale :	AS NOTED		
Drawn by :	JAC	Drawing No :	1
Checked by	: 10		∟1.2



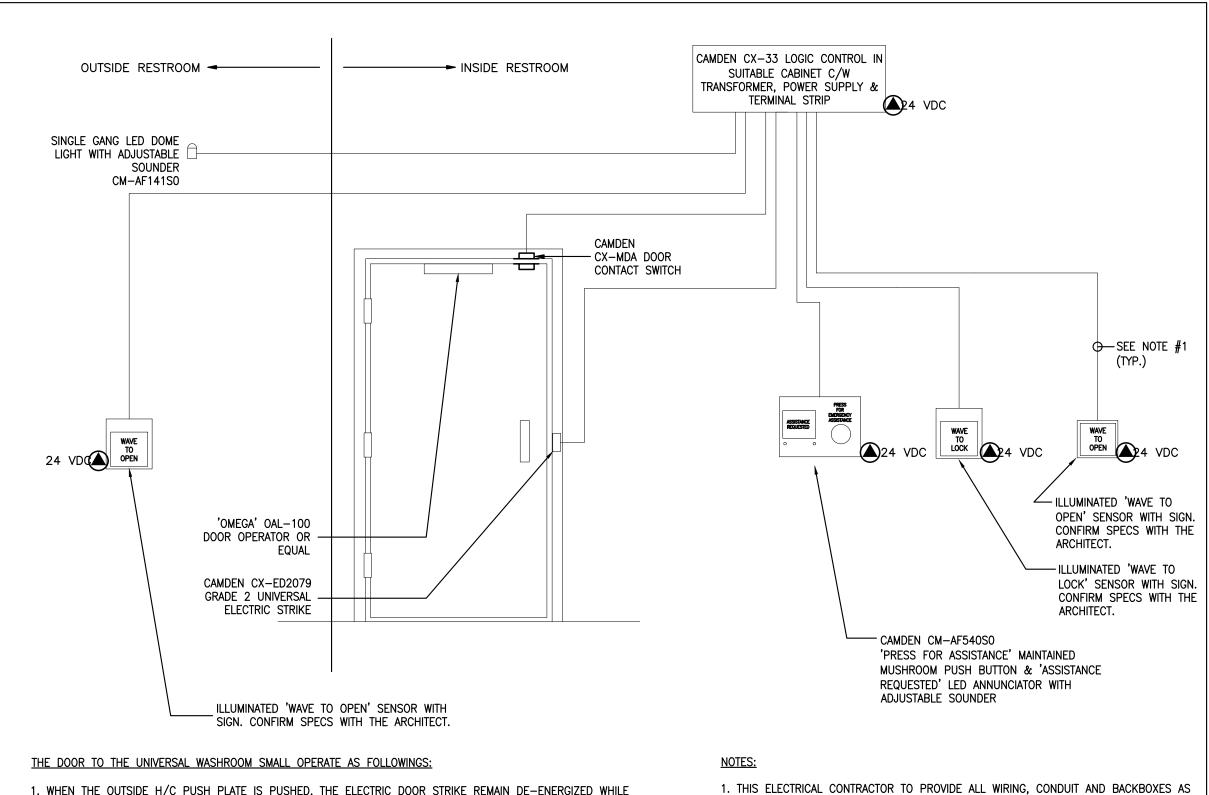

REQUIRED FOR A COMPLETE AND FUNCTIONAL SYSTEM. WIRING SMALL BE RUN IN CONDUIT

2. COORDINATE WITH DOOR HARDWARE SUPPLIER FOR INSTALLATION OF ALL DEVICES.

WITH ARCHITECTURAL DRAWINGS AND LOCAL INSPECTOR PRIOR TO ROUGH-IN.

3. COORDINATE EXACT LOCATIONS AND MOUNTING HEIGHTS OF ALL DEVICES AND PLATES

4. LETTERS FOR SIGNAGE SHALL BE AT LEAST 25mm HIGH WITH A 5mm STROKE. WITH

5. SYSTEM SHALL BE CAMDEN CAT.# CX-WEC SERIES TO BE SUITABLE FOR USAGE WITH

AS PER DOOR HARDWARE MANUFACTURE'S WIRING REQUIREMENTS.

SIGN POSTED ABOVE THE EMERGENCY BUTTON.

DOOR OPERATOR AND CONTROL KIT, OR APPROVED EQUAL.

1. WHEN THE OUTSIDE H/C PUSH PLATE IS PUSHED, THE ELECTRIC DOOR STRIKE REMAIN DE-ENERGIZED WHILE THE OPERATOR CYCLES OPEN AND CLOSED.

2. WHEN THE DOOR IS CLOSED AND THE "PUSH TO LOCK" BUTTON INSIDE THE WASHROOM IS PRESSED, THE ELECTRIC DOOR STRIKE IS ENERGIZED AND THE DOOR IS SOLIDLY LOCKED.

3. WHEN THE "PUSH TO OPEN" BUTTON INSIDE THE WASHROOM IS PRESSED, THE ELECTRIC DOOR STRIKE IS AGAIN DE-ENERGIZED, THE OPERATOR CYCLES OPEN AND CLOSED.4. WHEN THE DOOR IS CLOSED AFTER EXIT. THE ELECTRIC DOOR STRIKE REMAINS IN THE DE-ENERGIZED MODE

READY FOR THE NEXT ENTRY/EXIT OR FOR A MANUAL OPENING OF THE DOOR.

5. WHEN DOOR IS LOCKED, THE OUTSIDE PUSH PLATE WILL LIT RED, WHEN DOOR IS UNLOCKED, THE OUTSIDE


5. WHEN DOOR IS LOCKED, THE OUTSIDE PUSH PLATE WILL LIT RED, WHEN DOOR IS UNLOCKED, THE OUTSIDE PUSH PLATE WILL LIT GREEN.6. UPON ACTIVATION OF THE EMERGENCY CALL BUTTON, THE AUDIBLE AND VISUAL ALARMS ARE ACTIVATED AND

THE DOOR IS DE-ENERGIZED AND UNLOCKED.

7. FOR EMERGENCY ACCESS, THE DOOR CAN ALSO BE OPENED FROM OUTSIDE BY A MASTER KEY.

BARRIER-FREE WASHROOM DETAIL

SCALE: NTS

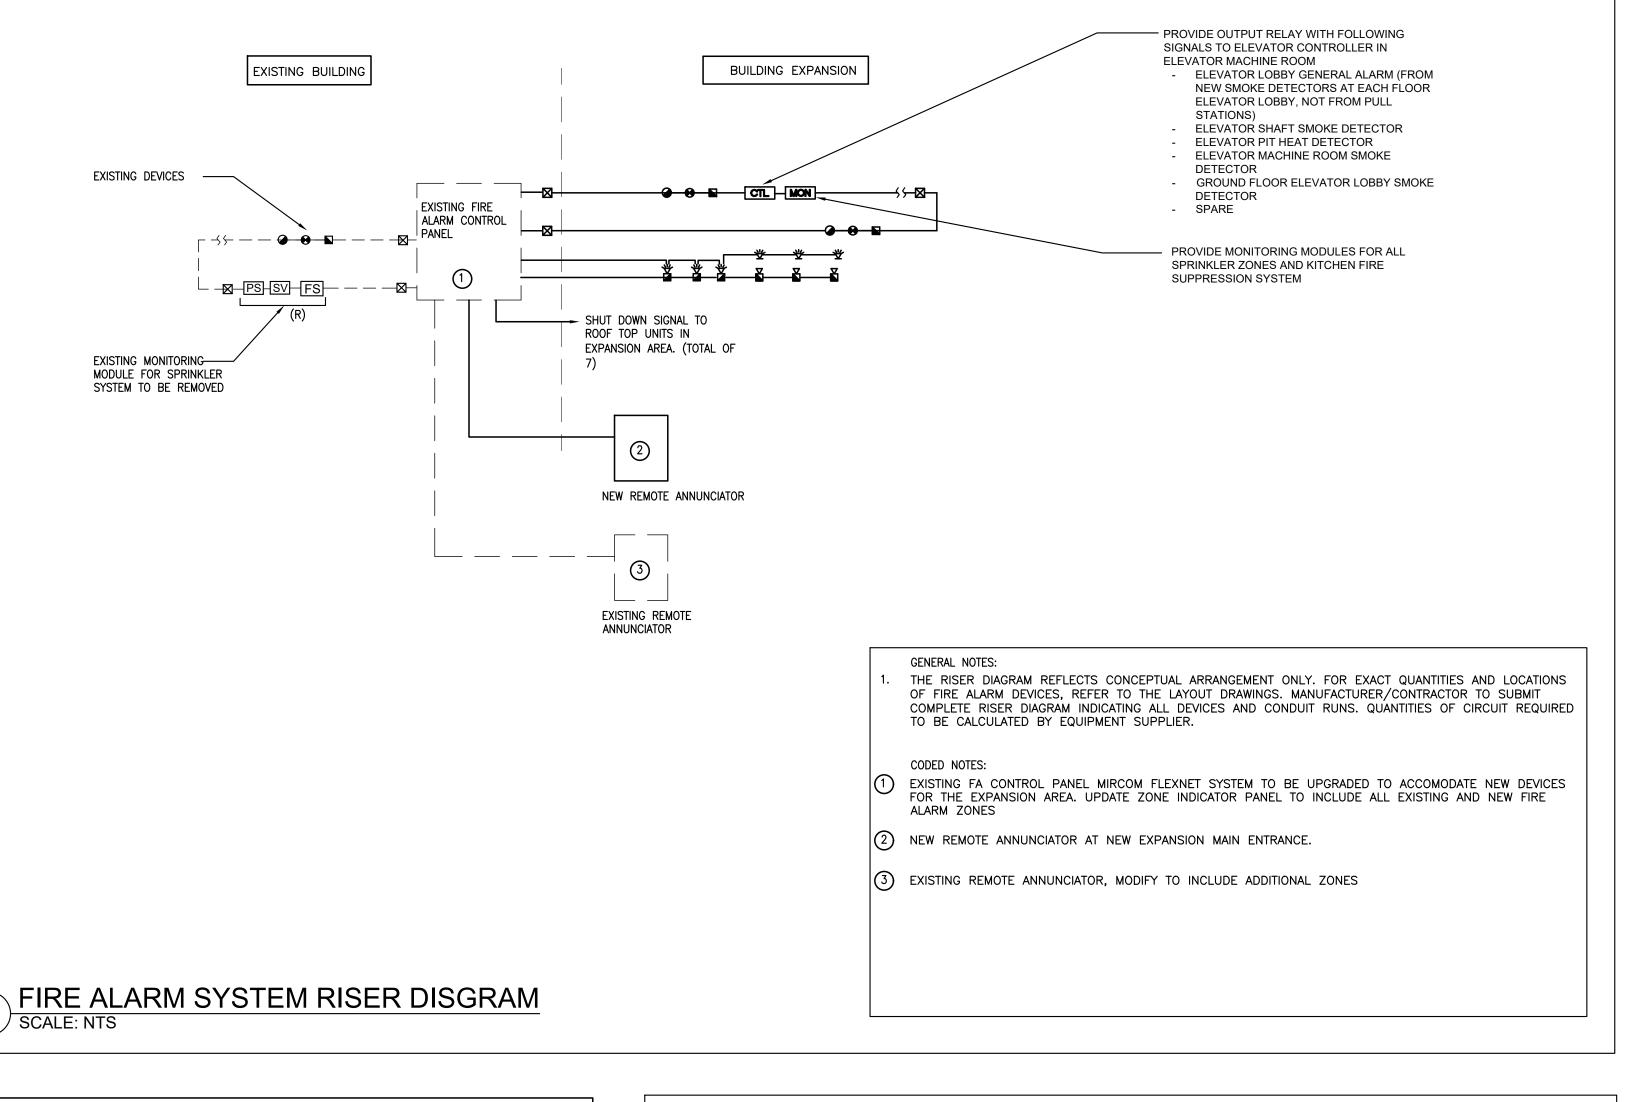

ZONE	DESCRIPTION		CTION	NOTES
	2237.111 7.31	ALARM	SUPERV.	
ZONE 1	BUILDING A	YES		
ZONE 2	BUILDING B GROUND FLOOR	YES		
ZONE 3	BUILDING B 2ND FLOOR	YES		
ZONE 4	BUILDING B MAIN ELEC ROOM	YES		
ZONE 5	BUILDING B MAIN MECHANICAL ROOM	YES		
ZONE 6	BUILDING B GF ELEVATOR LOBBY	YES		SMOKE DETECTO
ZONE 7	BUILDING B ELEVATOR SHAFT	YES		
ZONE 8	BUILDING B ELEVATOR PIT	YES		
ZONE 9	BUILDING B ELEVATOR MACHINE ROOM	YES		
ZONE 10	RESTAURANT FIRE SUPPRESSION	YES		
ZONE 11	MAIN SV#1		YES	2.
ZONE 12	MAIN SV#2		YES	2.
ZONE 13	PRESSURE SWITCH		YES	2.
ZONE 14	GROUND FLOOR SV#3		YES	2.
ZONE 15	SPARE		YES	2.
ZONE 16	2ND FLOOR FLOOR SV#4		YES	2.
ZONE 17	GROUND FLOOR FLOW SWITCH	YES		2.
ZONE 18	SPARE	YES		2.
ZONE 19	2ND FLOOR FLOW SWITCH	YES		2.
ZONE 20				
ZONE 21				
ZONE 22	SPARE			
ZONE 23	SPARE			
ZONE 24	SPARE			

FIRE ALARM SYSTEM

- 1. EXITING BUILDING HAS A MIRCOM FLEXNET FIRE ALARM SYSTEM. ALL NEW DEVICES SHOULD BE TIE—IN TO THE EXISTING PANEL AND PROVIDE ALL REQUIRED EQUIPMENT AND ACCESSORIES FOR ADDITIONAL ZONES AND DEVICES FOR THE EXPANSION AREA. PROVIDE A REMOTE ANNUNCIATOR IN EXPANSION AREA MAIN ENTRANCE AND TIE—IN TO EXITING SYSTEM.
- 2. EXISTING FA AND ANNUNCIATOR PANEL SHALL BE MODIFIED TO INCLUDE NEW ZONES FOR THE EXPANSION.
- 3 PULL STATIONS SHALL BE INSTALLED TO BARRIER FREE HEIGHTS IN ACCORDANCE TO O.B.C.
- 4. ADJUST THE SETTING OF AUDIBLE DEVICE INSTALLED IN SMALL ROOM TO LOWER LEVEL AS REQUIRED.

REQUIREMENTS. PROVIDE MATCHING CLEAR PLASTIC GUARD FOR PULL STATIONS IN PUBLIC AREA.


- 5. SET STROBE LIGHT OUTPUT TO 15cd U.N.O. SET STROBE LIGHT OUTPUT TO EQUAL OR HIGHER THAN LEVELS SHOWN ON DRAWINGS
- 6. ALL DEVICE END OF LINE RESISTOR SHALL BE LABELED WITH CIRCUIT SEVERED. ALL CONTROL AND MONITORING MODULE SHALL BE LABELED WITH DEVICES SEVERED. ALL LABELS SHALL BE TYPE WRITTEN.
- 7. FIRE ALARM SYSTEMS SHALL BE INSTALLED IN CONFORMANCE WITH CAN/ULC-S524, "STANDARD FOR THE INSTALLATION OF FIRE ALARM SYSTEMS"
- 8. ALLOW FOR MONITORING OF TWO ADDITIONAL SPRINKLER ZONES. DEVICE WILL BE LOCATED IN EXISTING BUILDING SPRINKLER ROOM. CONTRACTOR TO COORDINATE WITH SPRINKLER SYSTEM DESIGNER FOR ADDITIONAL ZONES REQUIRED TO BE MONITORED.

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PH.: (905) 946 4260 FAX: (905) 946 0901

Job No : 25016



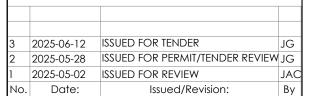

roject :

FIREARMS OUTLET CANADA

725 WESTNEY ROAD SOUTH, AJAX, ONTARIO L1S 7J7

Drawing Name :

DETAILS AND FIRE ALARM RISER

Date	JAN 2025	Project No :	25016
Scale :	AS NOTED		
Drawn by :	JAC	Drawing No :	- 4 0
Checked by	: JG		E1.3

Symbol	Label	Image	Quantity	Manufacturer	Catalog Number	Description	Number Lamps	Lumens Per Lamp	Light Loss Factor	Wattage	Distribu ion
	R1			Lithonia Lighting	TBD	2X4 LED FLAT PANEL 80CRI 4000 K,	1	Lamp	0.9	40	DIREC SC- 0=1.3, SC- 90=1.5
	\$70			1.555666 1.555565	(\$5.57.695). (\$6.557) (\$76.45)	125 6 5 1 1 26 6 6 1 2 6 6 6 6 6 6 6 6 6 6 6 6					1555955 1557 1577 1577 1577 1577 1577 15
	R3			Lithonia Lighting	2BLT4 48L LUGRT LP840	2X4 BLT 4800, Curved low UGR lens with trim 82CRI 4000 K,	1	5636	0.9	39.28	DIREC SC- 0=1.24 SC- 90=1.4
	R4			Lithonia Lighting	2BLT2 20L LUGR LP840	2X2 BLT 2000, Curved low UGR lens, 82CRI 4000 K,	1	2332	0.9	16.37	DIREC SC- 0=1.21 SC- 90=1.4
	R4D			Lithonia Lighting	2BLT2 20L LUGR LP840	2X2 BLT 2000, Curved low UGR lens, 82CRI 4000 K, C/W DRY WALL MOUNTING KIT	1	2332	0.9	16.37	DIRECT SC- 0=1.21 SC- 90=1.4
\bigcirc	R5			Gotham Architectural Lighting	IVO4 D 15LM 40K 80CRI 30D P WR	IVO4 Downlight 1500 Lumens 4000K 80+ CRI 30° Beam Angle Open Parabolic White no finish	1	1651	0.9	14.953	DIREC SC- 0=0.46 SC- 90=0.4
	S1			Lithonia Lighting	ZL1D L48 7000LM FST MVOLT 40K 80CRI	ZL1D 48" 7,000 Lumens Frosted Diffuser MVOLT 4,000 K 80CRI	1	7596	0.9	59.23	SEMI- DIREC SC- 0=1.17 SC- 90=1.3
	S2			Lithonia Lighting	ZL1D L48 3000LM FST MVOLT 40K 80CRI	ZL1D 48" 3,000 Lumens Frosted Diffuser MVOLT 4,000 K 80CRI	1	4028	0.9	29.85	SEMI- DIREC SC- 0=1.17 SC- 90=1.3
\bigcirc	S3			Gotham Architectural Lighting	IVO4CYL PC D 25LM 35K 80CRI 45D L9/L14/L16 P WTR LSS	IVO4 Pendant Cylinder 2500 Lumens 3500K 80+ CRI 45° Beam Angle Open Parabolic Wheat Anodized Semi-Specular	1	2058	0.9	26.84	DIRECT SC- 0=0.68 SC- 90=0.6
\bigcirc	S4			LUMINIS	HC1600-L4L75-40K	Hollowcore	1	7789	0.9	77.4	SEMI- DIREC SC- 0=1.51 SC- 90=1.5
	S5			BETA-CALCO, INC. TORONTO, ONTARIO	KIORA 44 1201-30	BETA-CALCO INDOOR LED LUMINAIRE WITH WHITE TRANSLUCENT/CLEAR LENSES AND SEMI-SPECULAR REFLECTOR	1	2263	0.9	30	
₽R G						WALL MOUNTED DOME LIGHT WITH WIREGUARD. 'R' DENOTES RED LIGHT 'G' DENOTES GREEN LIGHT					
	***			Ashoria Asgriffic	REEL ALCAS (AL ANG) ASVOLT ENGAGES (ESCE)	PAERI (Hankey) (100000) MEDMAN TOSHINANON (2014/14) ALCO (1000) (1000) CEC (1000)				766	155071 155071 155071
₩ _{H2}	H2			Lithonia Lighting	REBL ALO13-18L MD UVOLT SWW3-40 80CRI	REBL Highbay 18,000lm MEDIUM Distribution 120-347V ALO13/16 Switchable 4000K CCT 80CRI	1	18851	0.9	117.1	DIREC SC- 0=1.35 SC- 90=1.3
R ₂	R2			Lithonia Lighting	2BLT4 30L LUGRT LP840	2X4 BLT 3000, Curved low UGR lens with trim 82CRI 4000 K,	1	3571	0.9	22.52	DIREC SC- 0=1.24 SC- 90=1.4
R6	R6			Lithonia Lighting	2BLT4 60L LUGR LP840	2X4 BLT 6000, Curved low UGR lens, 82CRI 4000 K,	1	6871	0.9	46.6	DIREC SC- 0=1.3, SC- 90=1.5
\bowtie	B1			Lithonia Lighting HYDREL	HYDREL 8200 108LED -BLU-MVOLT WFL YM	YORK MOUT BLUE FLOOD LT WIDE FLOOD 120-347V ALUMIMUM HOUSING, IP67	1	13070	0.9	260	

RESTAURANT/OF	RESTAURANT/OFFICE AREA LIGHTING FIXTURE SCHEDULE			
	2' x 2' RECESSED LIGHT: PHILIPS CFI SofTrace LED 2X2			
	2' x 4' RECESSED LIGHT: PHILIPS CFI SofTrace LED 2X4			
	SUSPENDED LINEAR LIGHT: PHILIPS FLATLINE Suspended LED 4'			
0	RECESSED POT LIGHT PHILIPS LIGHTOLIER LyteCaster LED 5" Round Downlight			
0	CYLINDRICAL POT LIGHT: LUXSPACE SURFACE MOUNTED (DN570C LED20S/840 DIA-VLC-E C WH)			
•	PENDANT LIGHT #1 ROBINSON LIGHT & BATH RENITY 1 LIGHT PENDANT (Matteo)			
+	PENDANT LIGHT #2 (BAR AREA) ROBINSON LIGHT & BATH CHARISMO 1-LIGHT CYLINDER PENDANT			
	RED LIGHT (WALL MOUNTED)			

1 INDOOR ULUMINAIRE SCHEDULE SCALE: NTS

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3 2025-06-12 ISSUED FOR TENDER JG
2 2025-05-28 ISSUED FOR PERMIT/TENDER REVIEW JG
1 2025-05-02 ISSUED FOR REVIEW JAC
No. Date: Issued/Revision: By



Project


FIREARMS OUTLET CANADA

725 WESTNEY ROAD SOUTH, AJAX, ONTARIO L1S 7J7

Drawing Name :

LUMINAIRE SCHEDULES

Date	JAN 2025	Project No :	2501
Scale :	AS NOTED		
Drawn by :	JAC	Drawing No :	
Checked by	: JG		E1.4

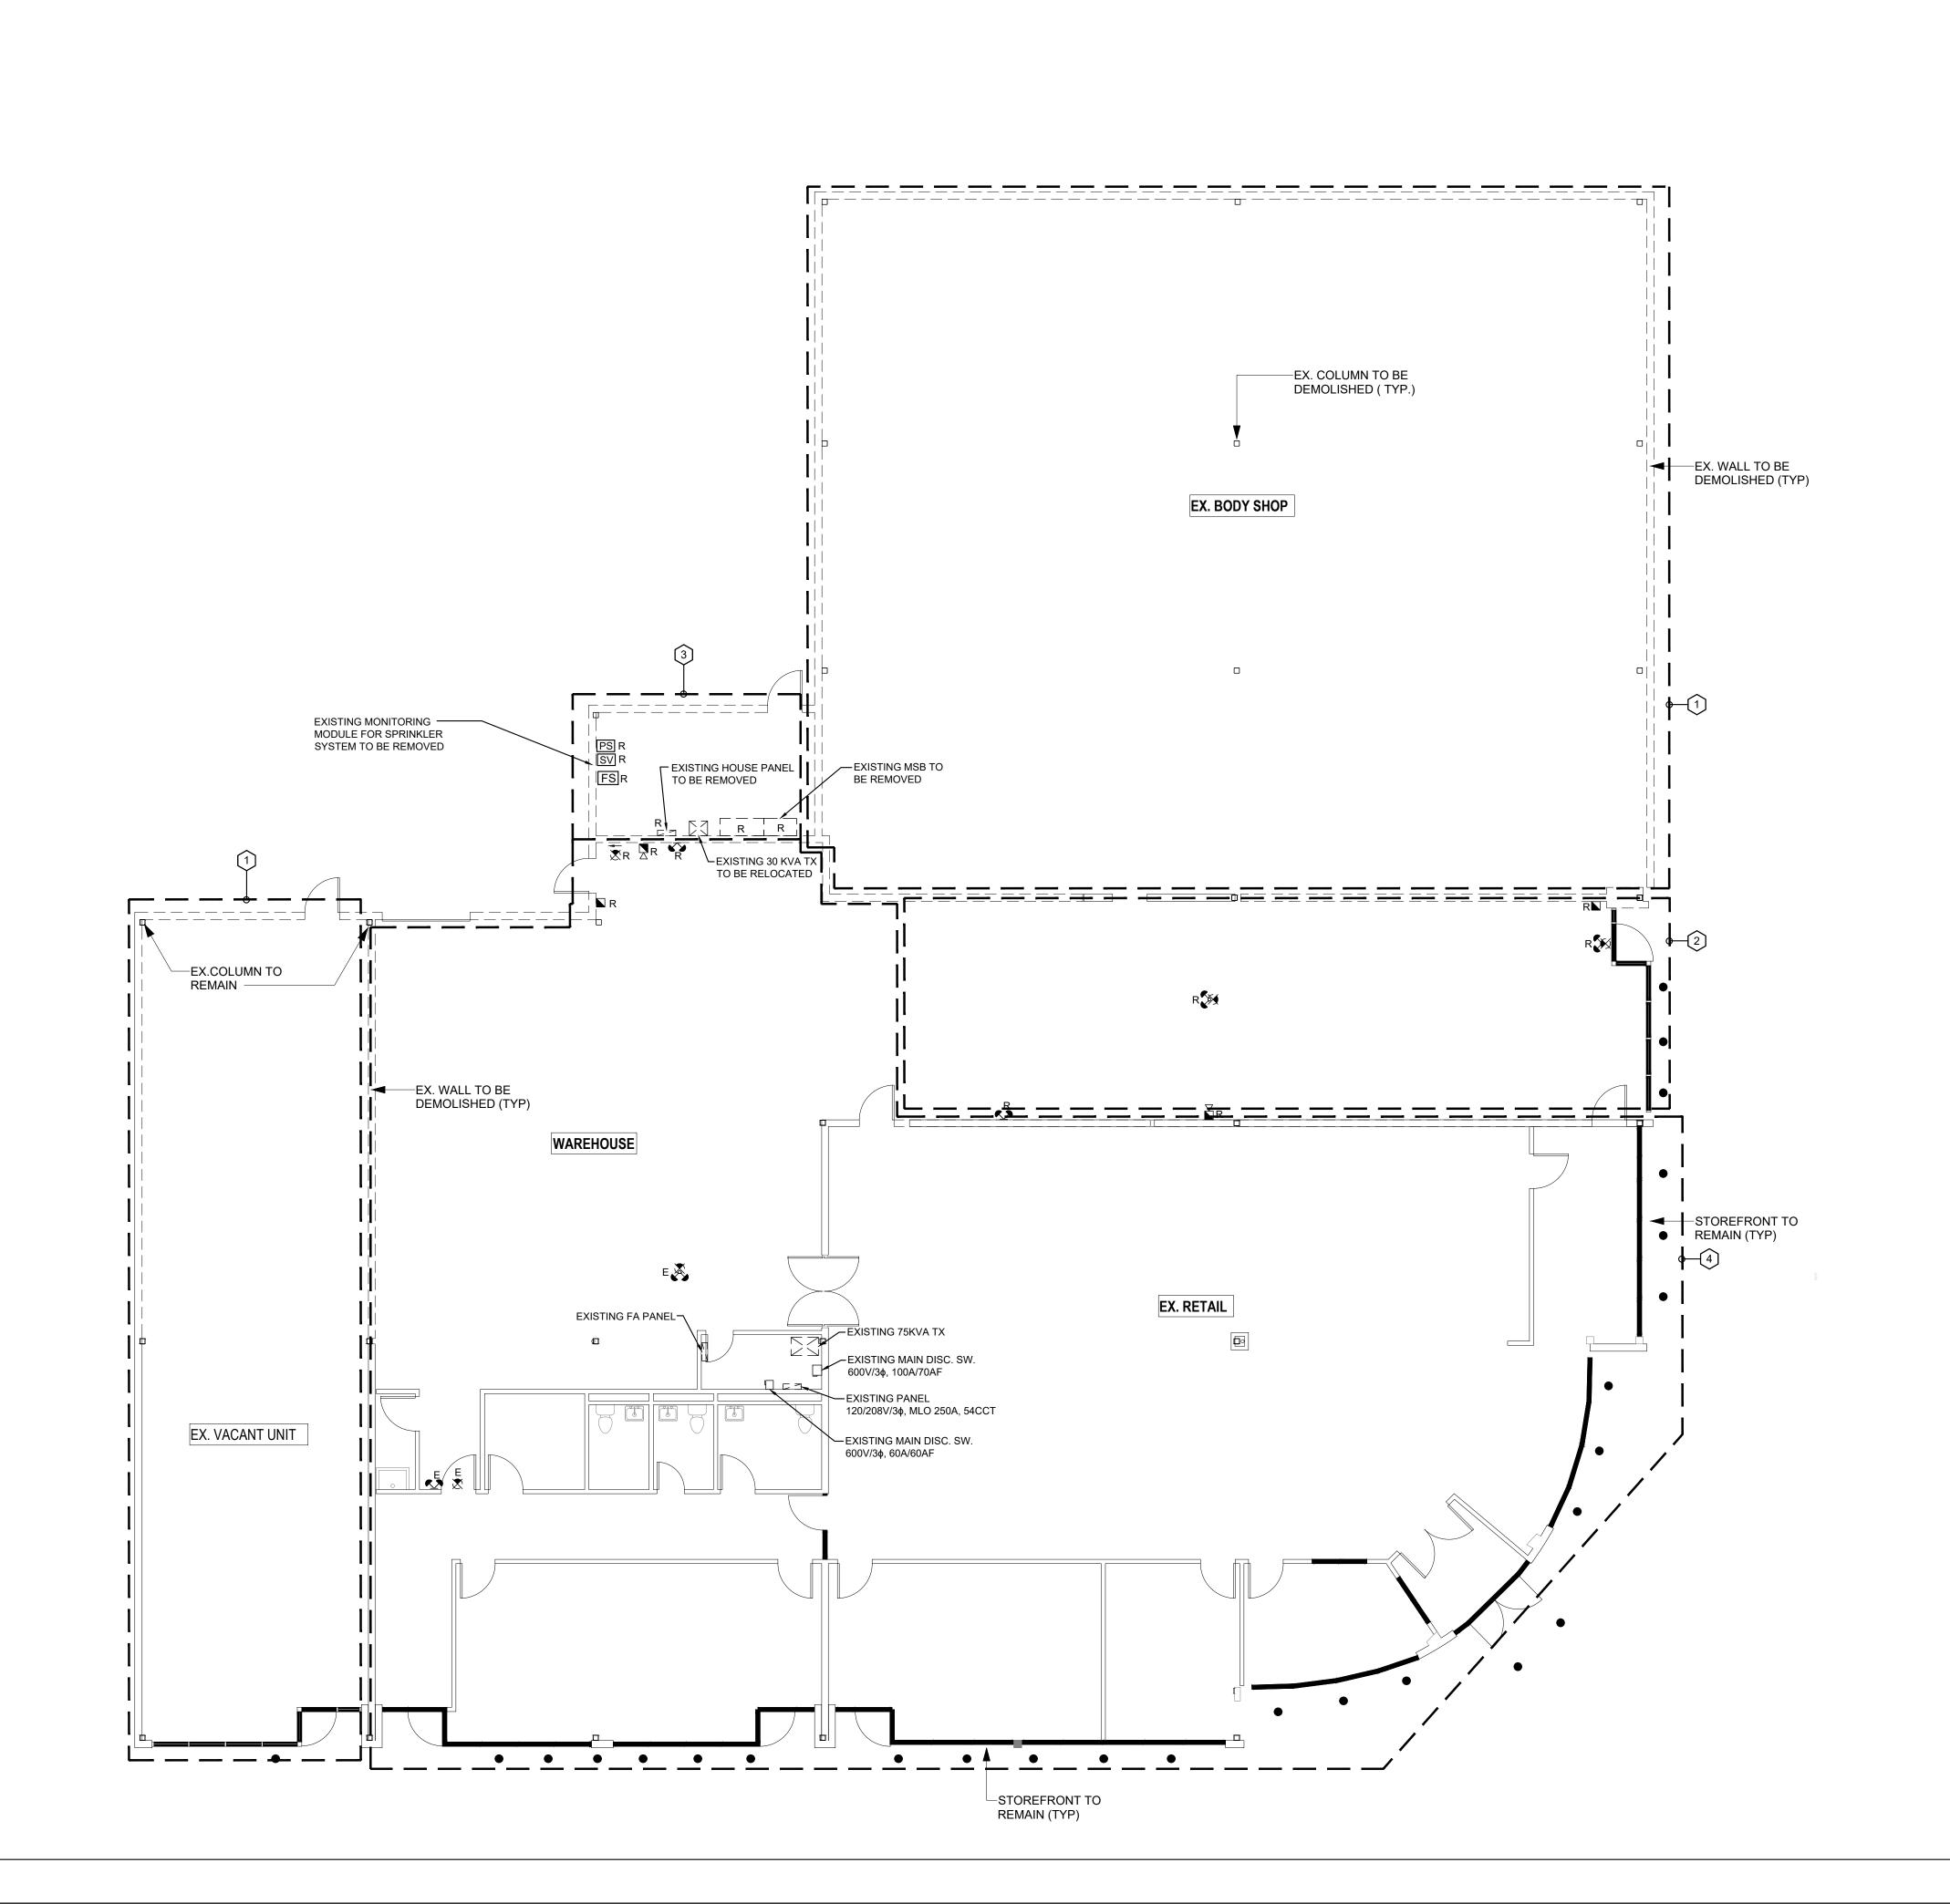

GENERAL DEMOLITION NOTES

- IN EVERY INSTANCE OF DEMOLITION AND/OR REMODELING, THE E.C. SHALL FIGURE A COMPLETE JOB AS NONE OTHER SHALL BE ACCEPTED.
- 2. THE DRAWINGS ARE TO BE USED ONLY AS A GUIDELINE FOR DEMOLITION.
 THE E.C. MUST VISIT THE SITE PRIOR TO BIDDING TO VERIFY ALL WORK
 REQUIRED FOR A COMPLETE JOB & INCLUDE THE COST OF SUCH WORK IN
- 3. THE E.C. SHALL MAINTAIN EXISTING SERVICES TO & IN THE EXISTING AREA AS REQUIRED.
- 4. IF NECESSARY, THE E.C. SHALL PROVIDE TEMPORARY SERVICES IN THE EXISTING AREAS.
- THE E.C. SHALL DISCONNECT & REMOVE ELECTRIC SERVICE TO ALL MECHANICAL EQUIPMENT BEING REMOVED AS A RESULT OF THE REMODELING.
- 6. ELECTRICAL EQUIPMENT & DEVICES SHALL BE REMOVED COMPLETE

INCLUDING CONDUIT & WIRE.

- 7. FLUSH MOUNTED WALL OUTLETS SHALL BE REMOVED AND THE WALL PATCHED AND FINISHED TO MATCH THE ADJACENT WALL FINISHES.
- 8. ANY EXISTING CONDUIT, WIRING AND/OR ELECTRICAL & MECHANICAL DEVICES BEING DISTURBED BY THE WORK SHALL BE REWORKED BY THIS CONTRACTOR AS REQUIRED TO RETURN TO ITS FORMER EXISTING OPERATING CONDITION.
- 9. ANY CIRCUITS FEEDING THROUGH DEVICES OR EQUIPMENT BEING RELOCATED, REWORKED, OR ABANDONED & SERVING OTHER ELECTRICAL DEVICES, AND/OR EQUIPMENT SHALL BE MAINTAINED BY PROVIDING J-BOXES OR OTHER ACCEPTABLE METHOD AS REQUIRED.

10. ALL WALLS, CEILINGS, FLOORS, ETC., BEING DISTURBED BY THE WORK

- SHALL BE RETURNED TO FINISHED CONDITIONS TO MATCH EXISTING BY THE E.C. & HE SHALL DO HIS OWN CUTTING & PATCHING AS NECESSARY UNDER HIS CONTRACT.
- 11. EXISTING MATERIALS SHALL BE TURNED OVER TO THE OWNER. IF NOT REQUIRED BY OWNER, THE E.C. SHALL REMOVE THESE MATERIALS FROM THE PREMISES.
- 12. NO CONDUIT, BOXES, WIRING, OR CABLES SHALL BE INSTALLED WITHIN 1 1/2"
 OF THE LOWEST POINT OF THE UNDERSIDE OF THE ROOF DECKING, NOR
 SHALL THEY BE INSTALLED CONCEALED WITHIN METAL-CORRUGATED ROOF
 DECKING. THE E.C. SHALL BE RESPONSIBLE TO REPLACE AND/OR REWORK
 EXISTING CONDUIT, BOXES, WIRING, AND CABLING THAT IS NOT IN
 COMPLIANCE WITH THIS REQUIREMENT.
- 13. ALL CONDUIT AND CABLING SHALL BE PROPERLY SUPPORTED AS REQUIRED BY THE CANADIAN ELECTRICAL CODE. THE E.C. SHALL BE RESPONSIBLE TO REPLACE AND/OR REWORK EXISTING CONDUIT AND/OR CABLING THAT IS NOT IN COMPLIANCE WITH THIS REQUIREMENT.
- 14. E.C. SHALL FIELD VERIFY SLAB ON GRADE FLOOR CONSTRUCTION TYPE PRIOR TO CUTTING. UNDER NO CIRCUMSTANCES SHALL THE CONTRACTOR CUT A STRUCTURAL FLOOR SLAB THICKER THAN FOUR (4") INCHES WITHOUT PRIOR WRITTEN APPROVAL FROM ENGINEER OF RECORD. NOTIFY ENGINEER OF RECORD OF ANY SLAB THICKNESS GREATER THAN FOUR (4") INCHES PRIOR TO PROCEEDING WITH ANY SAW CUTTING.

CODED DEMOLITION NOTES

- DISCONNECT AND REMOVE ALL EXISTING RETAIL TENANTS ELECTRICAL SYSTEMS INCLUDING ALL LOW VOLTAGE SYSTEMS BACK TO SOURCE AND MAKE SAFE. EXISTING ELECTRICAL SERVICE TO BE REMOVED BACK TO EXISTING ELECTRICAL ROOM AND MAKE SENSE.
- 2. DISCONNECT AND REMOVE EXISTING LIGHTING, LIGHTING CONTROL AND OTHER LOW VOLTAGE SYSTEM IN THE EXISTING FOC AREA BACK TO SOURCE AND MAKE SAFE, INCLUDING BUT NOT LIMITED TO ITEMS
- 3. ALL EXISTING ELECTRICAL POWER DISTRIBUTION AND LOW VOLTAGE SYSTEMS IN EXISTING FOC ELEC RM AREA TO REMAIN. TWO EXISTING 600V FEEDERS ARE FED FROM A 200A TEMPORARY SERVICE. THESE TWO FEEDERS WILL NEED TO BE DISCONNECTED FROM THE TEMPORARY SERVICE AND EXTEND TO THE NEW ELECTRICAL SERVICE AS SHOWN ON THE SINGLE LINE DIAGRAM WHEN NEW SERVICE IS ACTIVATED.
- 4. EXISTING ELECTRICAL SYSTEMS IN FOC AREA TO REMAIN UNLESS NOTED OTHERWISE.

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7181 WOODBINE AVE. UNIT 229

Job No : 25016

3 2025-06-12 ISSUED FOR TENDER JG
2 2025-05-28 ISSUED FOR PERMIT/TENDER REVIEW JG
I 2025-05-02 ISSUED FOR REVIEW JAC
No. Date: Issued/Revision: By



geor .

FIREARMS OUTLET CANADA

725 WESTNEY ROAD SOUTH, AJAX, ONTARIO L1S 7J7

Drawing Name :


ELECTRICAL DEMOLITION PLAN - GROUND FLOOR


te JAN 2025 Project No : 25016


ale : AS NOTED


awn by : JAC


necked by : E2.0

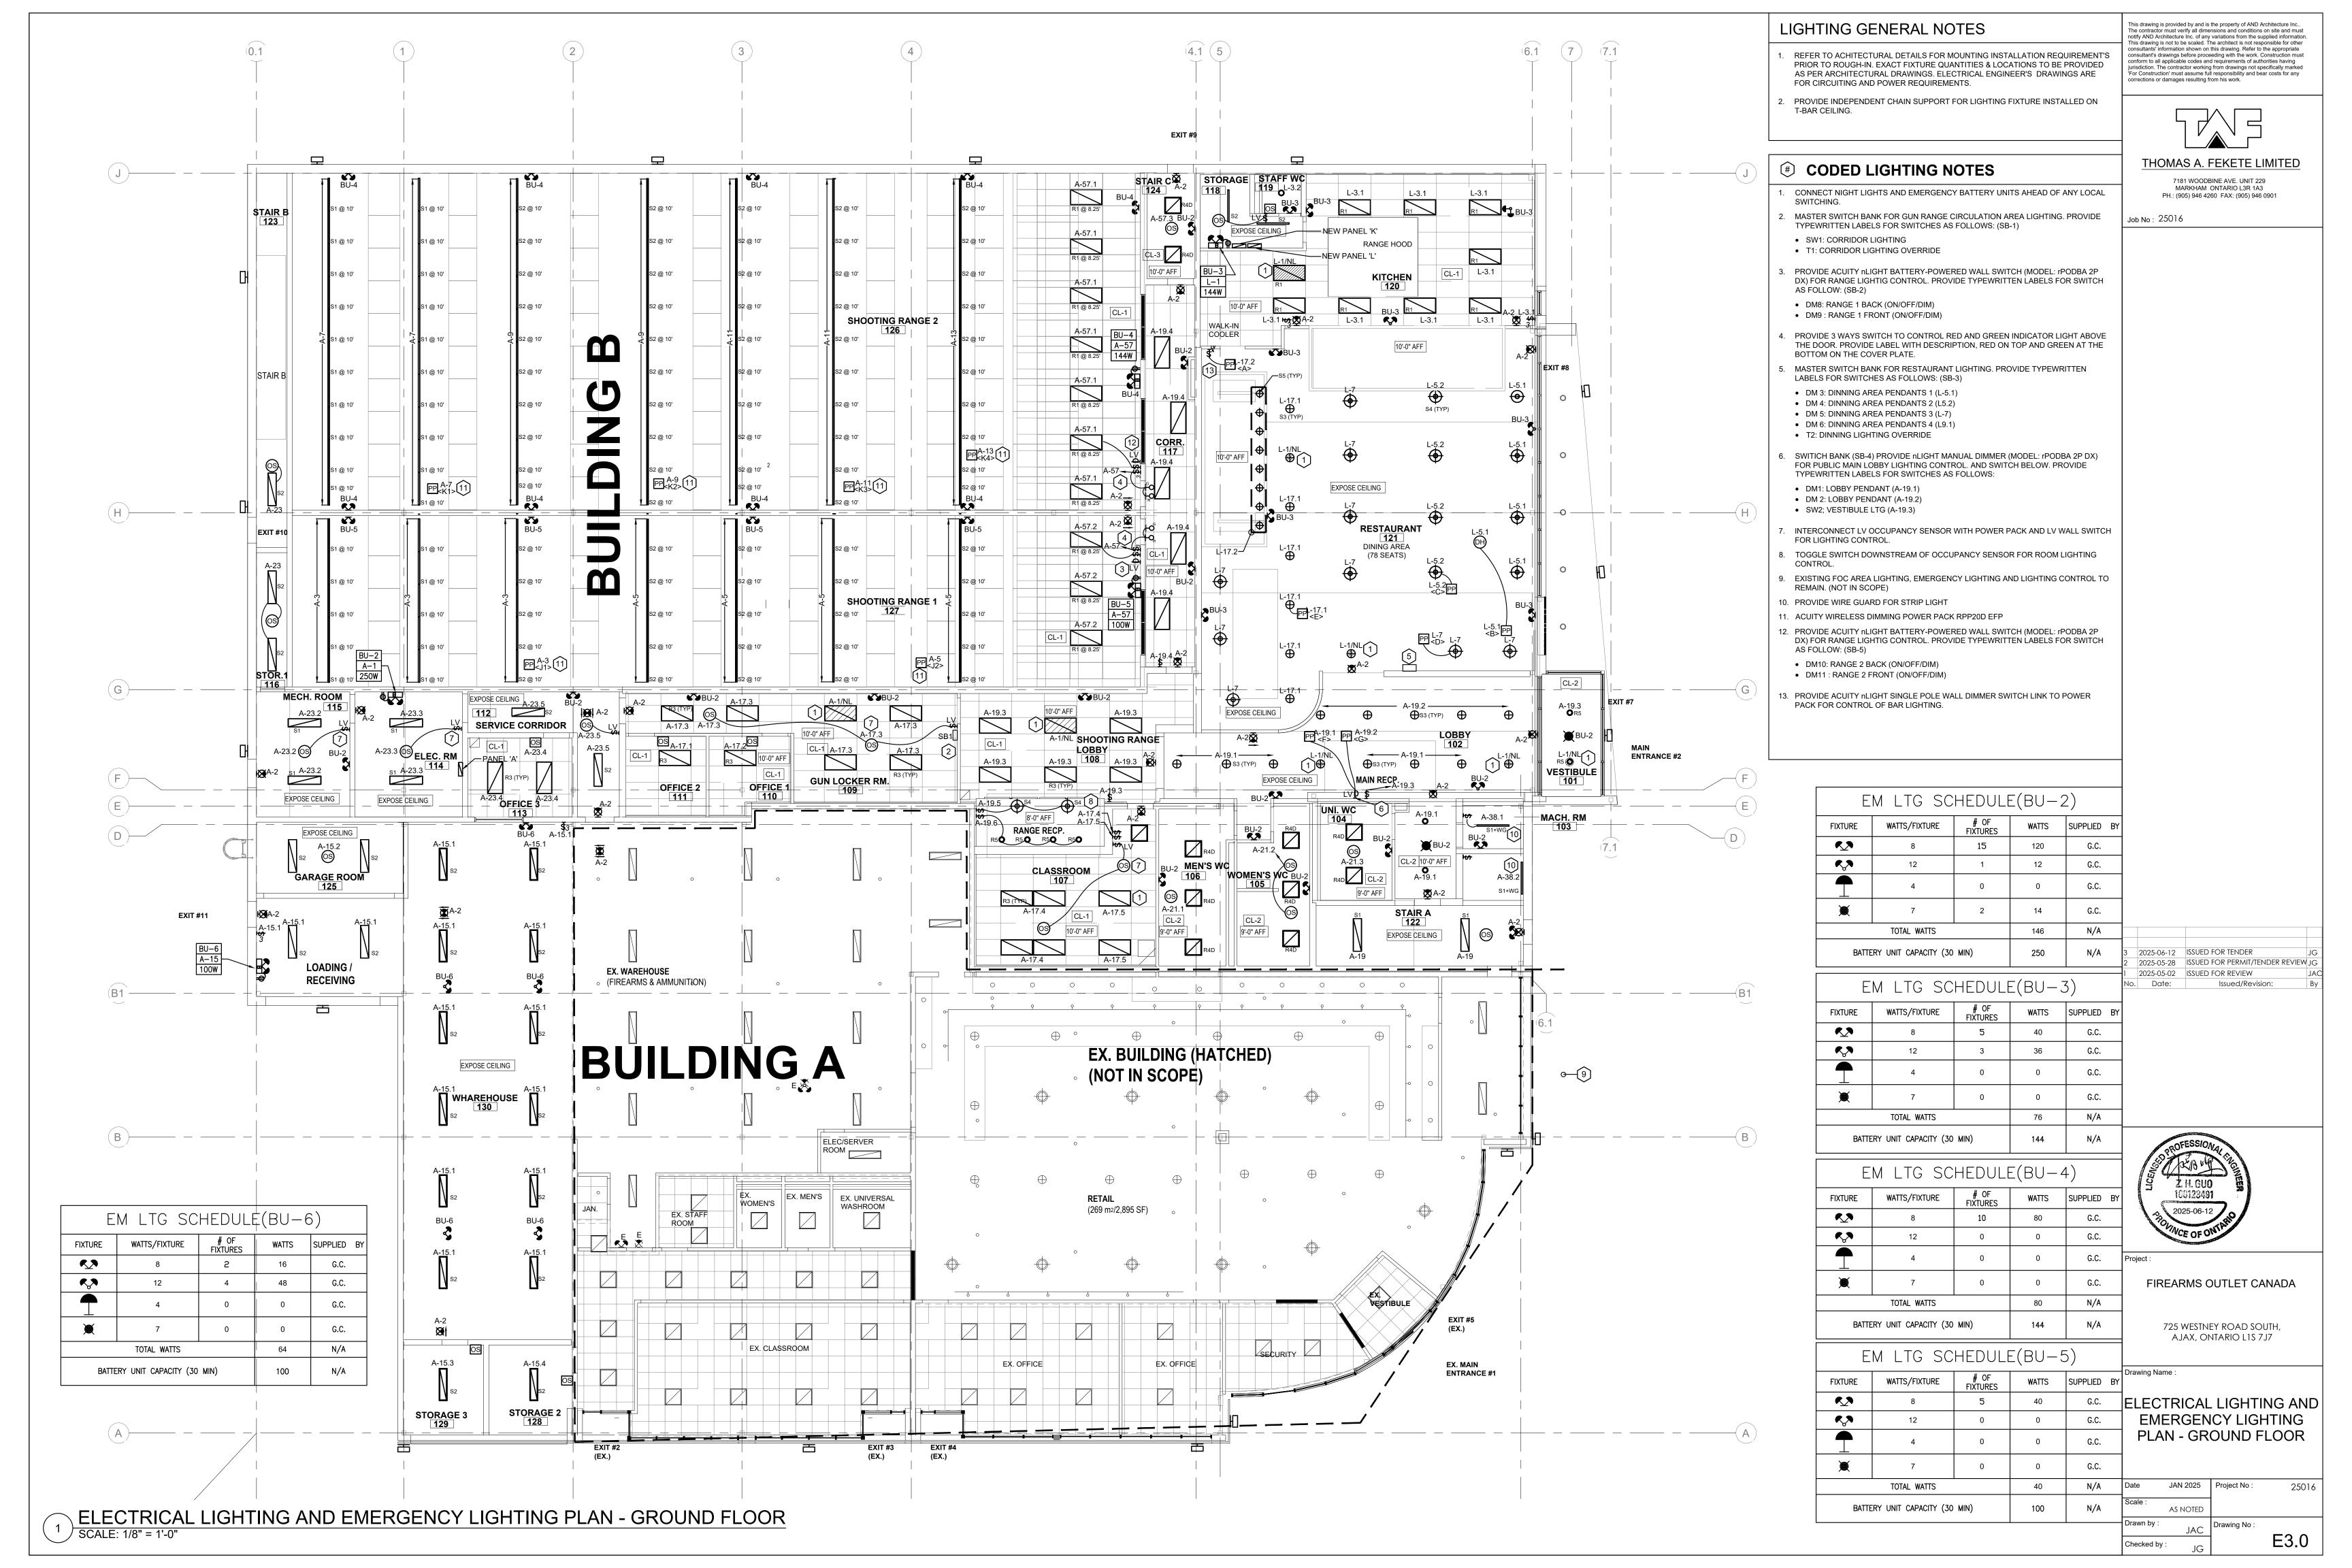


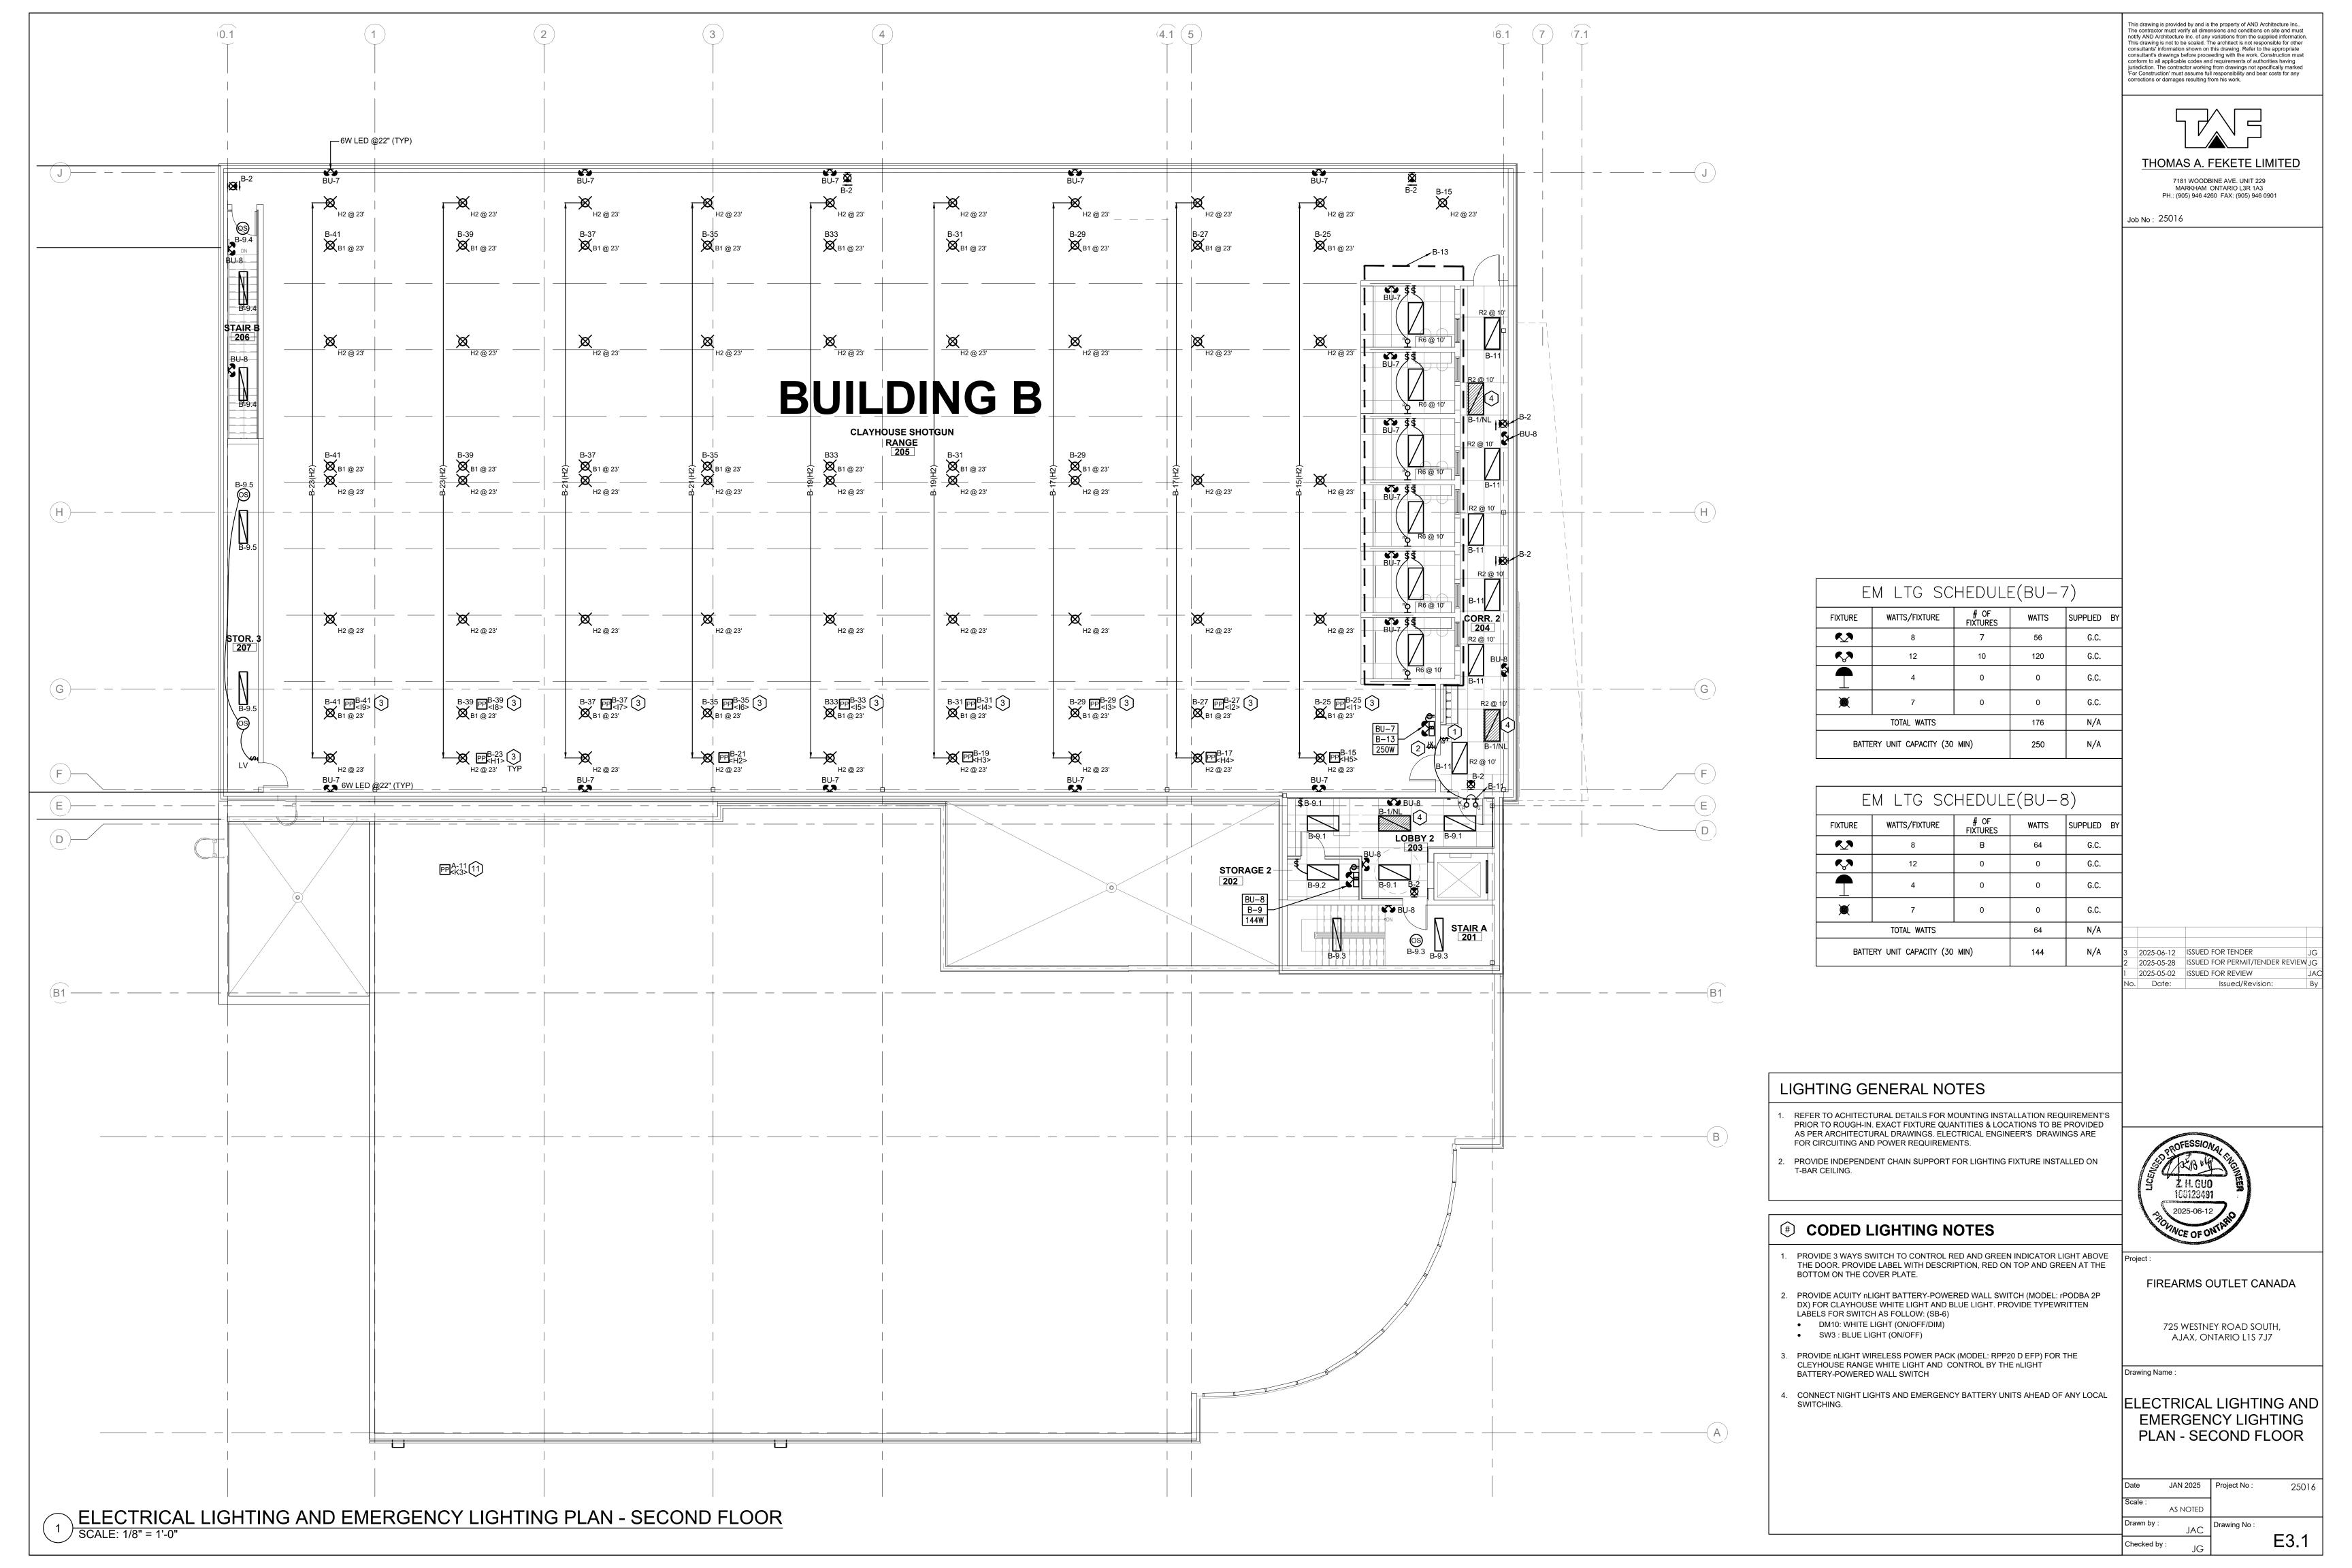

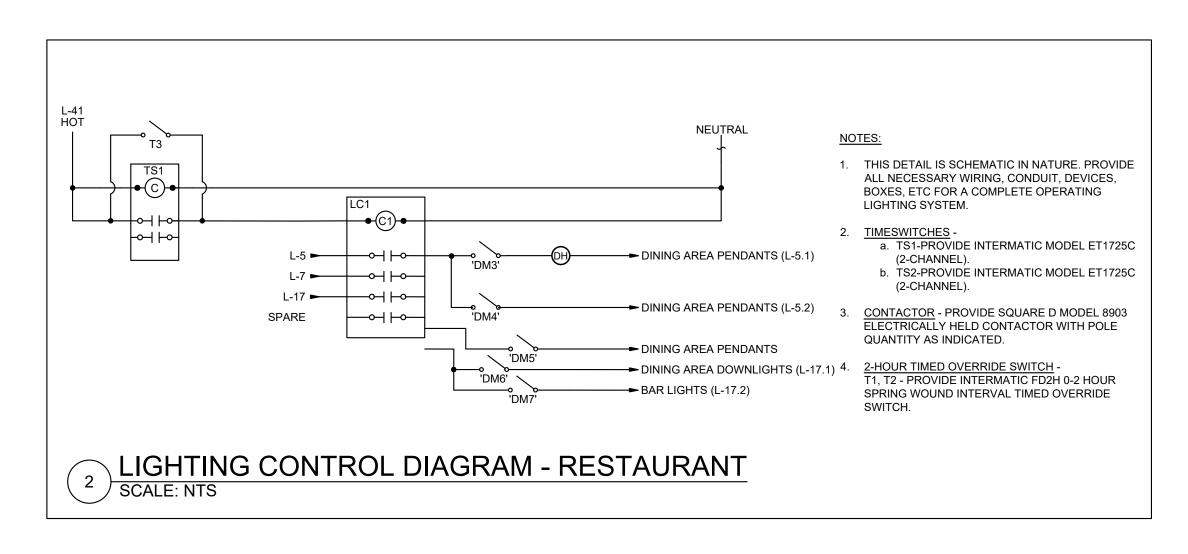

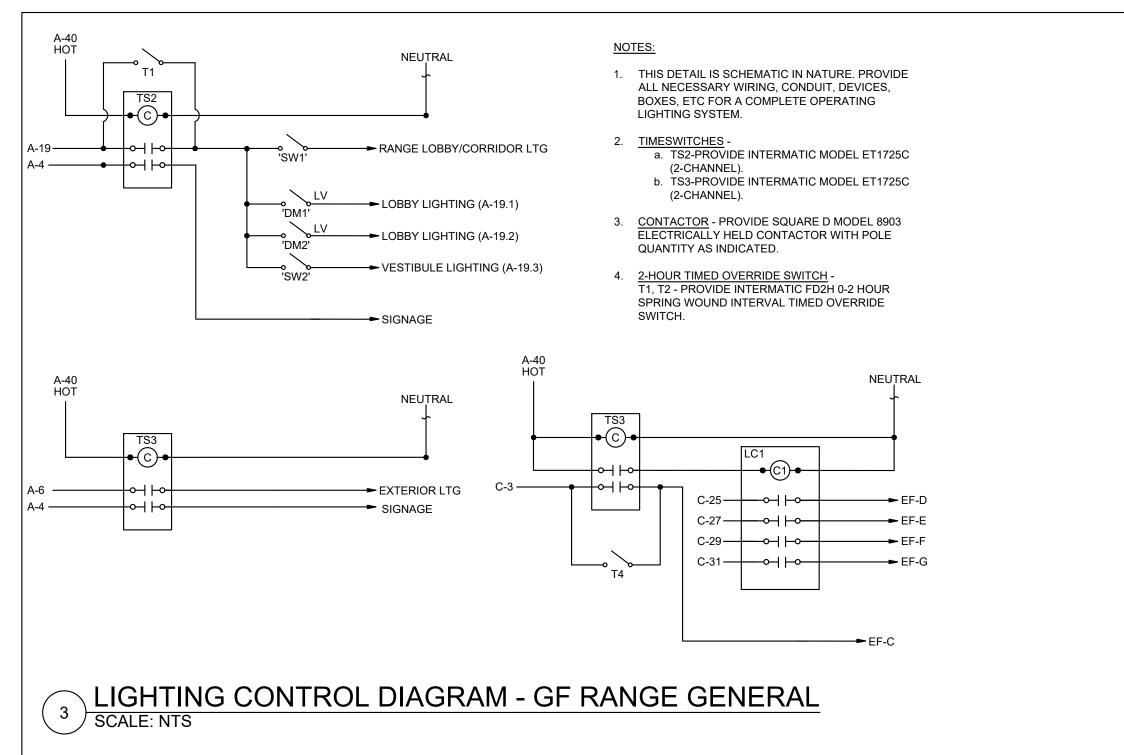

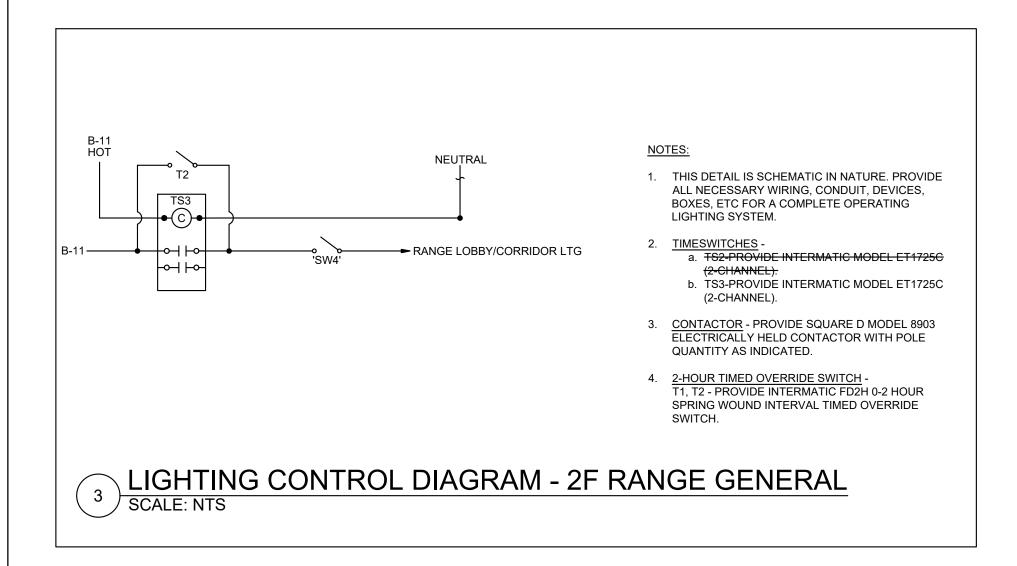

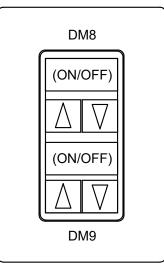

BUTTON	DESCRIPTION	POWER PACKS CONTROLLED	CIRCUIT
1	RANGE 1 BACK LIGHTING	J1	A-3
2	RANGE 1 FRONT LIGHTING	J2	A-5


7181 WOODBINE AVE. UNIT 229 PH.: (905) 946 4260 FAX: (905) 946 0901


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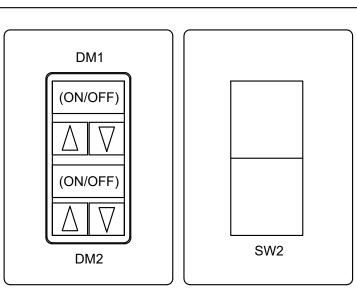
SB-2 FOR RANGE 1
SCALE: NTS






BUTTON	DESCRIPTION	POWER PACKS CONTROLLED	CIRCUIT
1	DINNING AREA PENDANTS 1	В	L-5.1
2	DINNING AREA PENDANTS 2	С	L5.2
3	DINNING AREA PENDANTS 3	D	L-7
4	DINNING AREA PENDANTS 4	E	L9.1

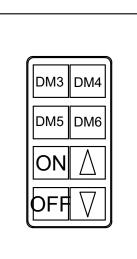SB-3 FOR DINNING AREA SCALE: NTS

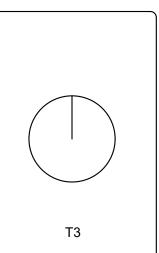


BUTTON	DESCRIPTION	POWER PACKS CONTROLLED	CIRCUIT
1	GF MAIN LOBBY LIGHTING AREA 1	F	A-19.1
2	GF MAIN LOBBY LIGHTING AREA 2	G	A-19.2
2	GF MAIN LOBBY LIGHTING AREA 2	G	A-19.2

SB4 FOR PUBLIC MAIN LOBBY 4 SCALE: NTS

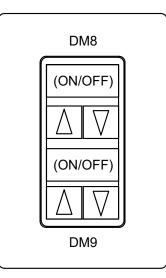

BUTTON	DESCRIPTION	POWER PACKS CONTROLLED	CIRCUIT
1	RANGE 2 BACK LIGHTING	K1,K2	A-7, A-9
2	RANGE 2 FRONT LIGHTING	K3,K4	A-11, A-13

SB-5 FOR RANGE 2
SCALE: NTS

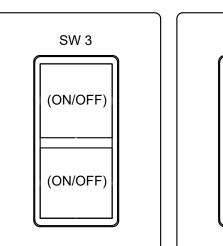



	DM10		
	(ON/OFF)		
	\Box		
l		'	

BUTTON	DESCRIPTION	POWER PACKS CONTROLLED	CIRCUIT
1	CLAYHOUSE WHITE LIGHT	IHI I() H5 I	B-15, B-17, B-19, B-21, B-23
2	CLAYHOUSE BLUE LIGHT	I1 TO 19	B-25, 27,29,31,33,25,37 ,39,41

SB-6 FOR CLAY HOUSE RANGE

4 SCALE: NTS

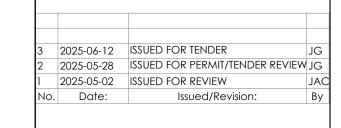

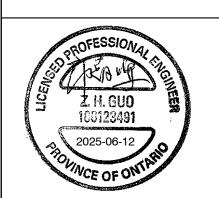


FIREARMS OUTLET CANADA


725 WESTNEY ROAD SOUTH, AJAX, ONTARIO L1S 7J7

Drawing Name:

ELECTRICAL LIGHTING SCHEDULES AND DETAILS

> JAN 2025 Project No : **AS NOTED** E3.2

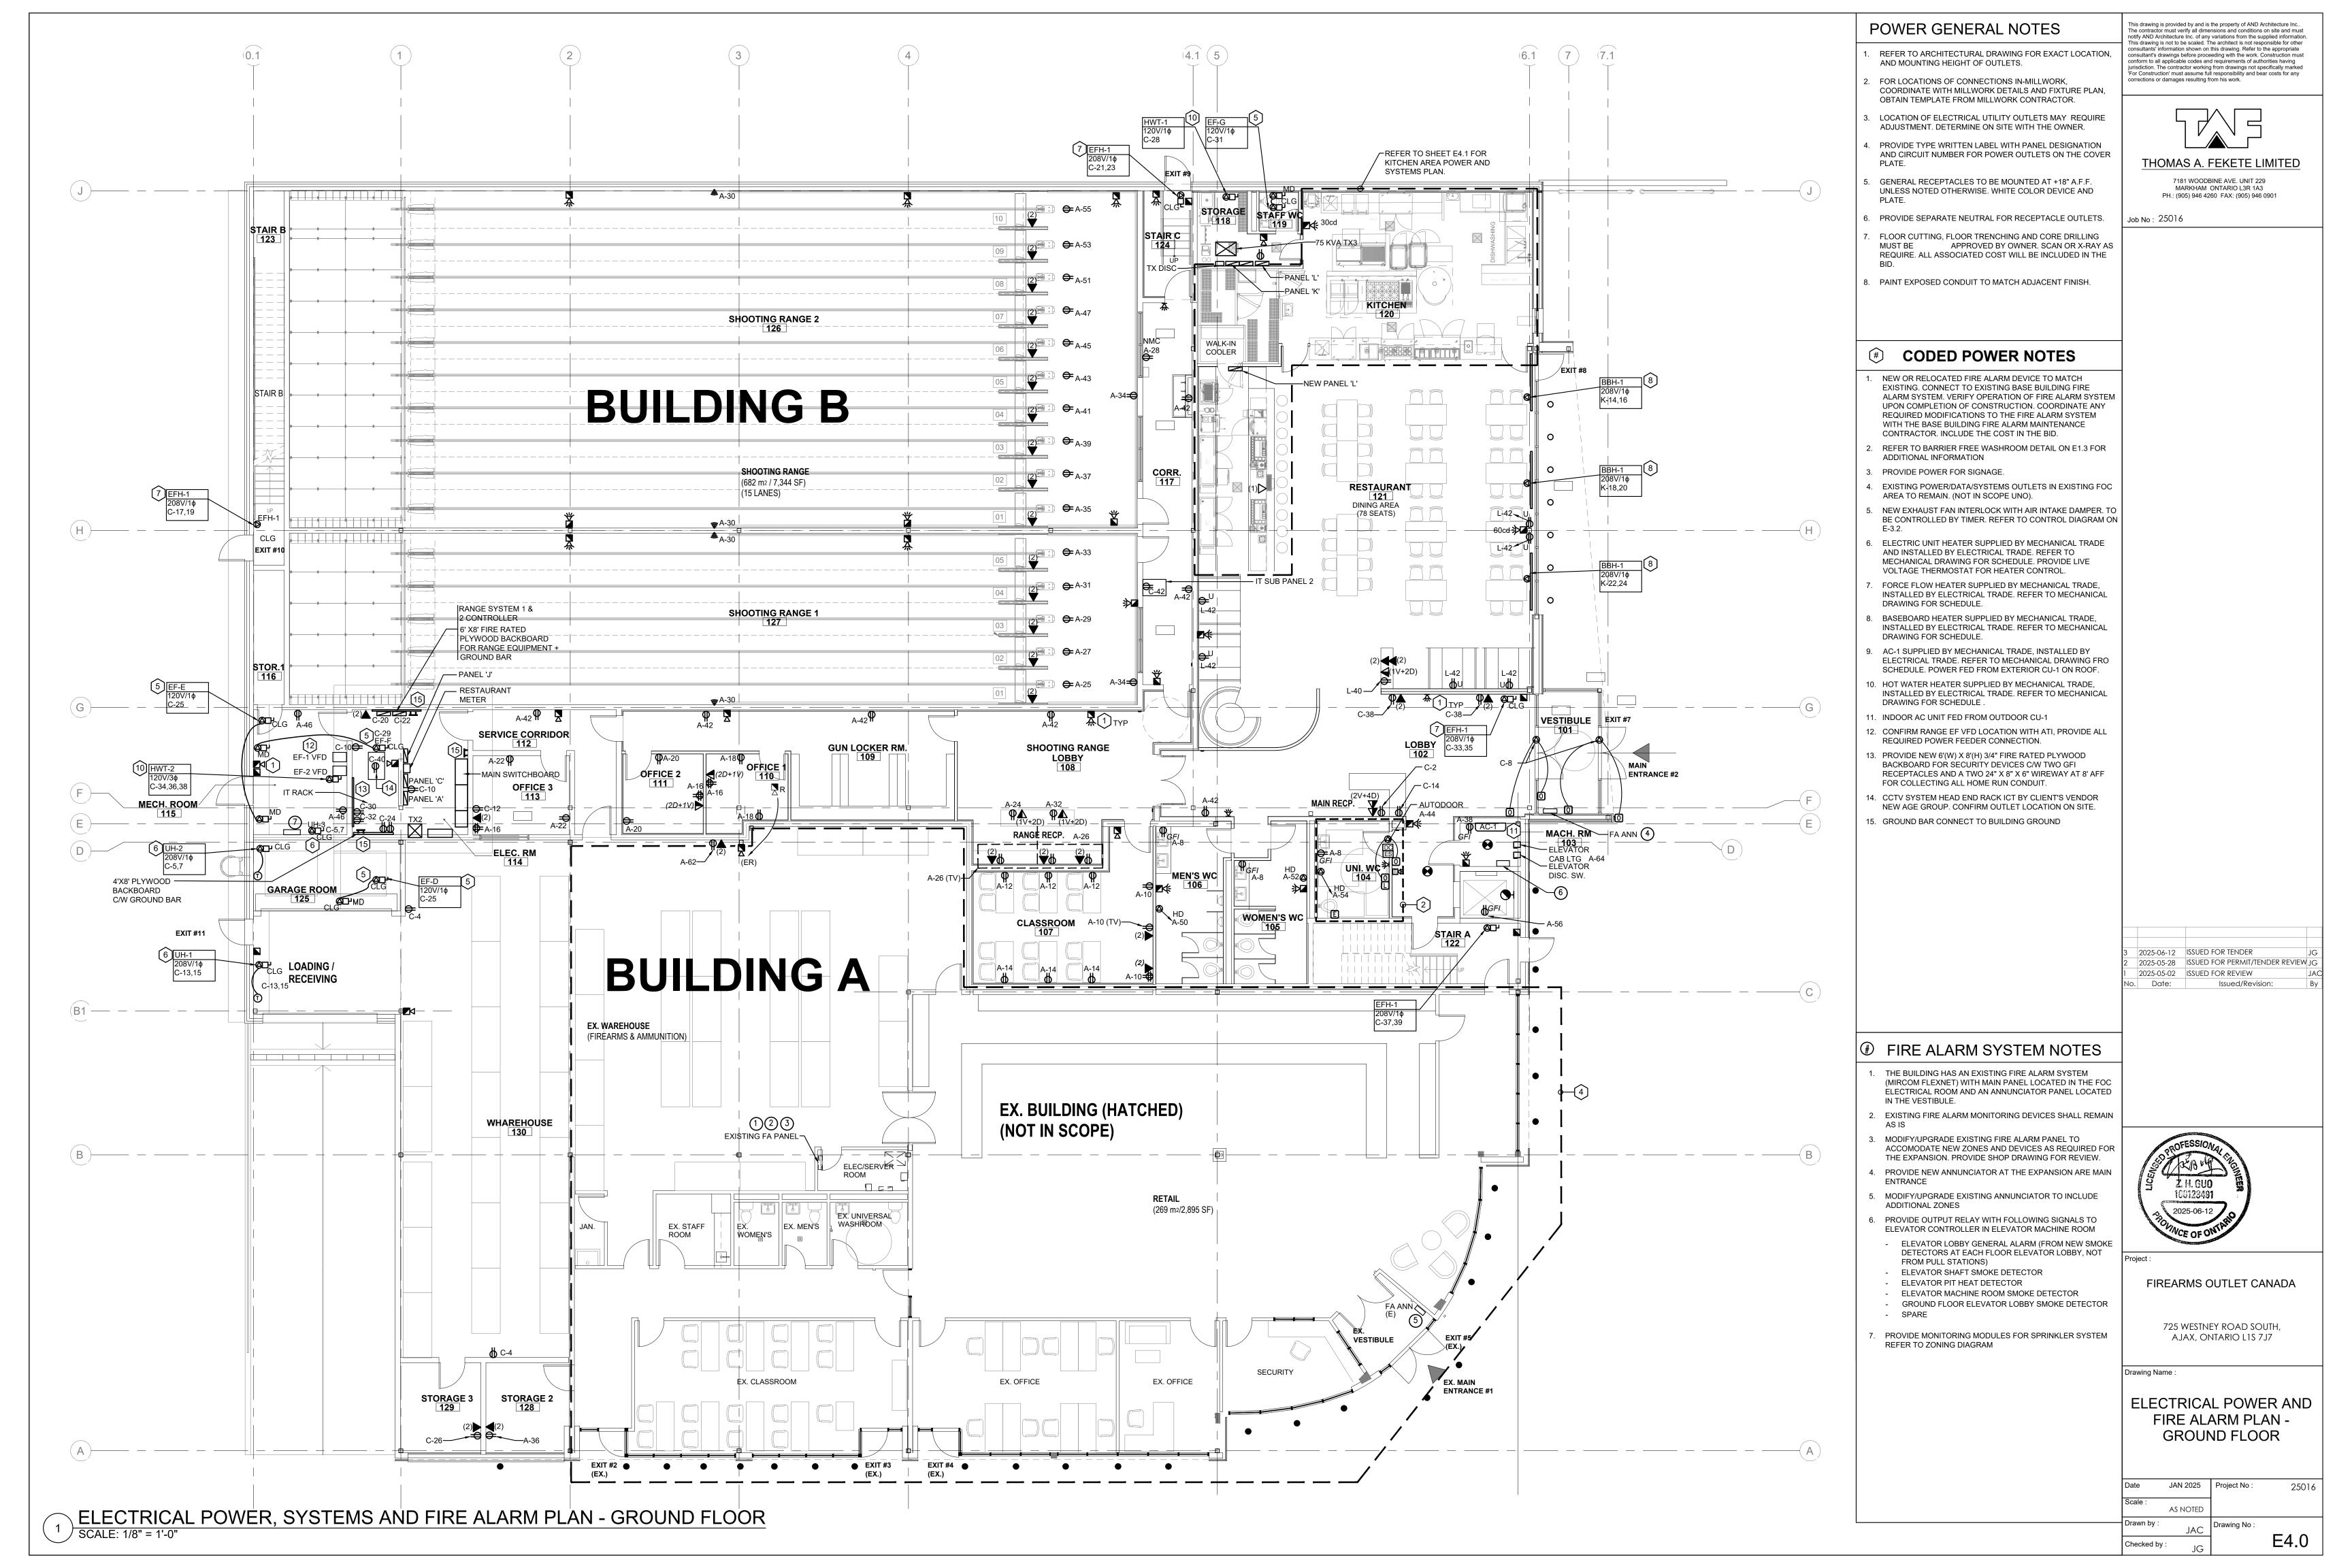

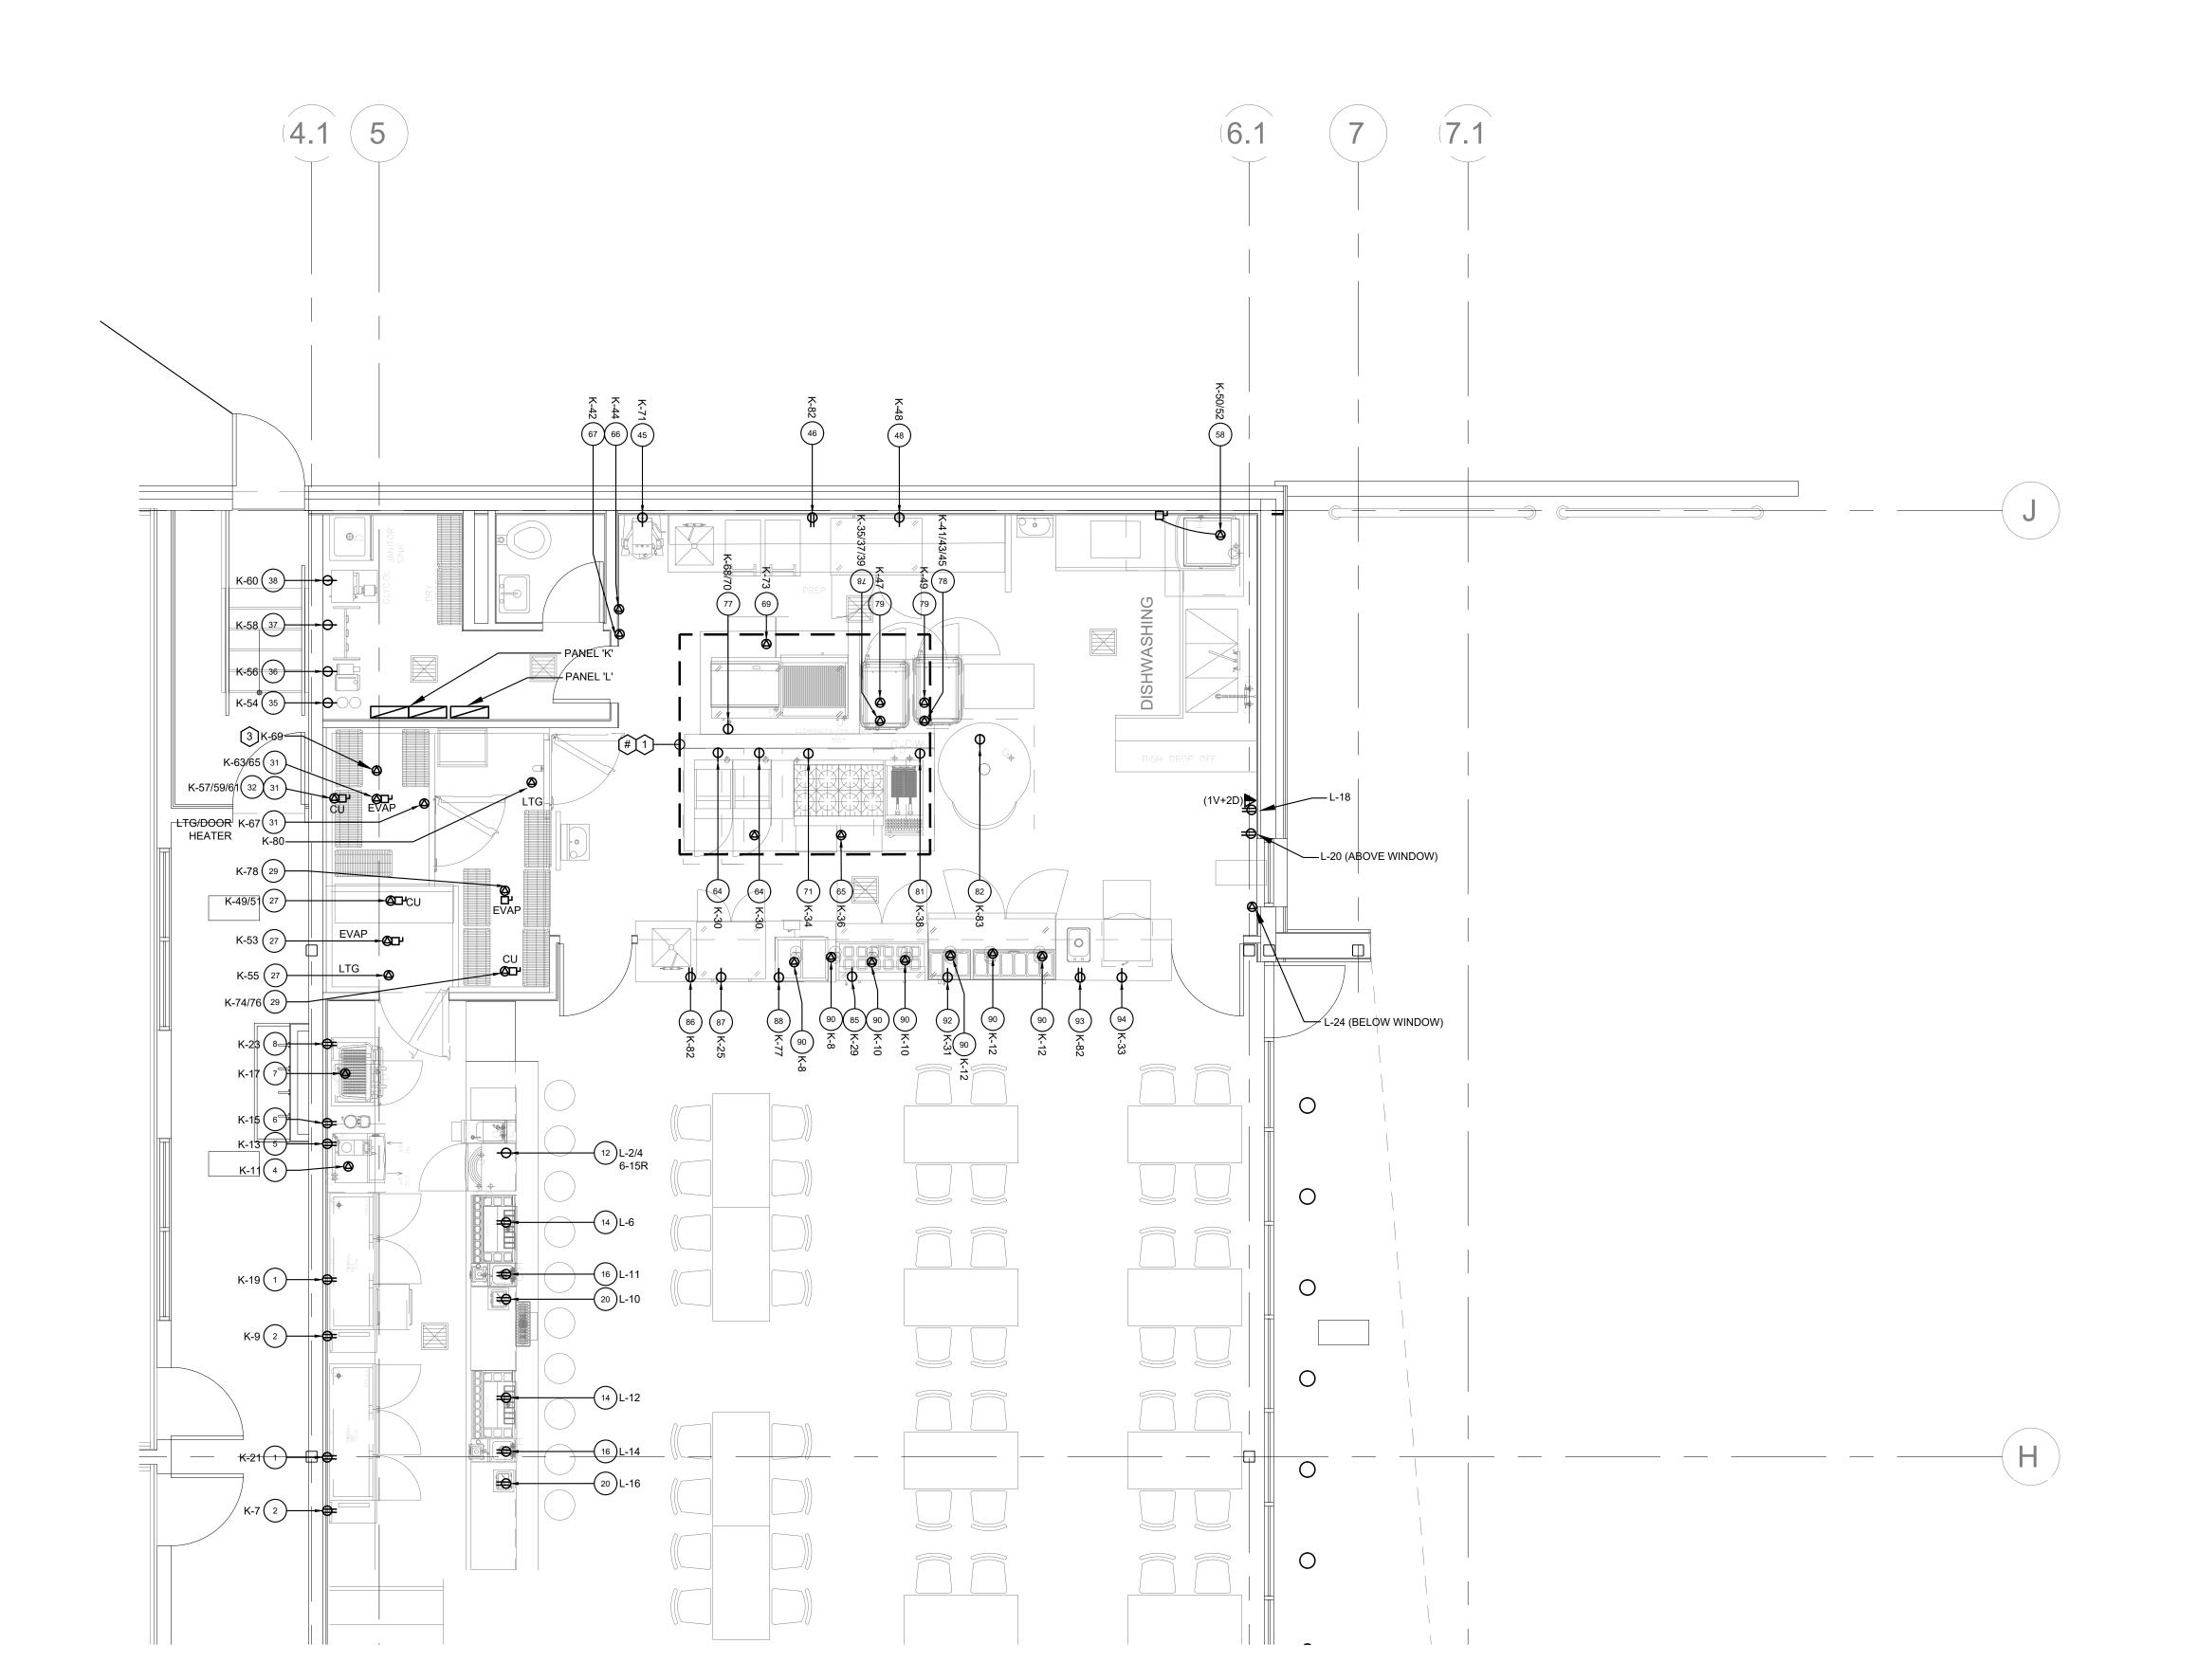

POWER GENERAL NOTES

- 1. REFER TO ARCHITECTURAL DRAWING FOR EXACT LOCATION, AND MOUNTING HEIGHT OF
- 2. FOR LOCATIONS OF CONNECTIONS IN-MILLWORK, COORDINATE WITH MILLWORK DETAILS AND FIXTURE PLAN, OBTAIN TEMPLATE FROM MILLWORK CONTRACTOR.
- 3. LOCATION OF ELECTRICAL UTILITY OUTLETS MAY REQUIRE ADJUSTMENT. DETERMINE ON SITE WITH THE OWNER.
- 4. PROVIDE TYPE WRITTEN LABEL WITH PANEL DESIGNATION AND CIRCUIT NUMBER FOR POWER OUTLETS ON THE COVER PLATE. ALL KITCHEN AREA OUTLET TO BE BLOCK WITH STAINLESS STEEL COVER PLATE.
- 5. GENERAL RECEPTACLES TO BE MOUNTED AT +18" A.F.F. UNLESS NOTED OTHERWISE. WHITE COLOR DEVICE AND PLATE.
- 6. FLOOR CUTTING, FLOOR TRENCHING AND CORE DRILLING MUST BE APPROVED BY OWNER. SCAN OR X-RAY AS REQUIRE. ALL ASSOCIATED COST WILL BE INCLUDED IN THE
- 7. PAINT EXPOSED CONDUIT TO MATCH ADJACENT FINISH.

CODED POWER NOTES

- . KITCHEN EQUIPMENT UNDER THIS HOOD TO SHUT DOWN UPON ACTIVATION OF HOOD FIRE SUPPRESSION SYSTEM. PROVIDE NECESSARY CONTACTS, BOXES, WIRING ETC FOR AN OPERATIONAL SYSTEM. REFER TO DETAIL 3 ON THIS DRAWING FOR ADDITIONAL INFORMATION.
- PROVIDE SIGNAL FROM HOOD FIRE SUPPRESSION SYSTEM TO EXISTING BUILDING FIRE ALARM SYSTEM AS AN ADDITIONAL FIRE ALARM ZONE. PROGRAM EXISTING FIRE ALARM SYSTEM AS REQUIRED.
- PROVIDE GFI PROTECTION DEVICE TO FEED SELF REGULATED HEAT TRACING CABLE FOR FREEZER CONDENSATE LINE. CONFIRM WITH FREEZER SUPPLIER FOR INSTALLATION DETAILS.

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o. Date: Issued/Revision: By



Project :

FIREARMS OUTLET CANADA

725 WESTNEY ROAD SOUTH, AJAX, ONTARIO L1S 7J7

Drawing Name :

ELECTRICAL ENLARGED POWER PLAN - KITCHEN

 Date
 JAN 2025
 Project No : 2501

 Scale :
 AS NOTED


 Drawn by :
 JAC


 Checked by :
 IC


Project No : 2501

Drawing No : E4.1

1 ELECTRICAL ENLARGED POWER PLAN - KITCHEN SCALE: 1/4" = 1'-0"

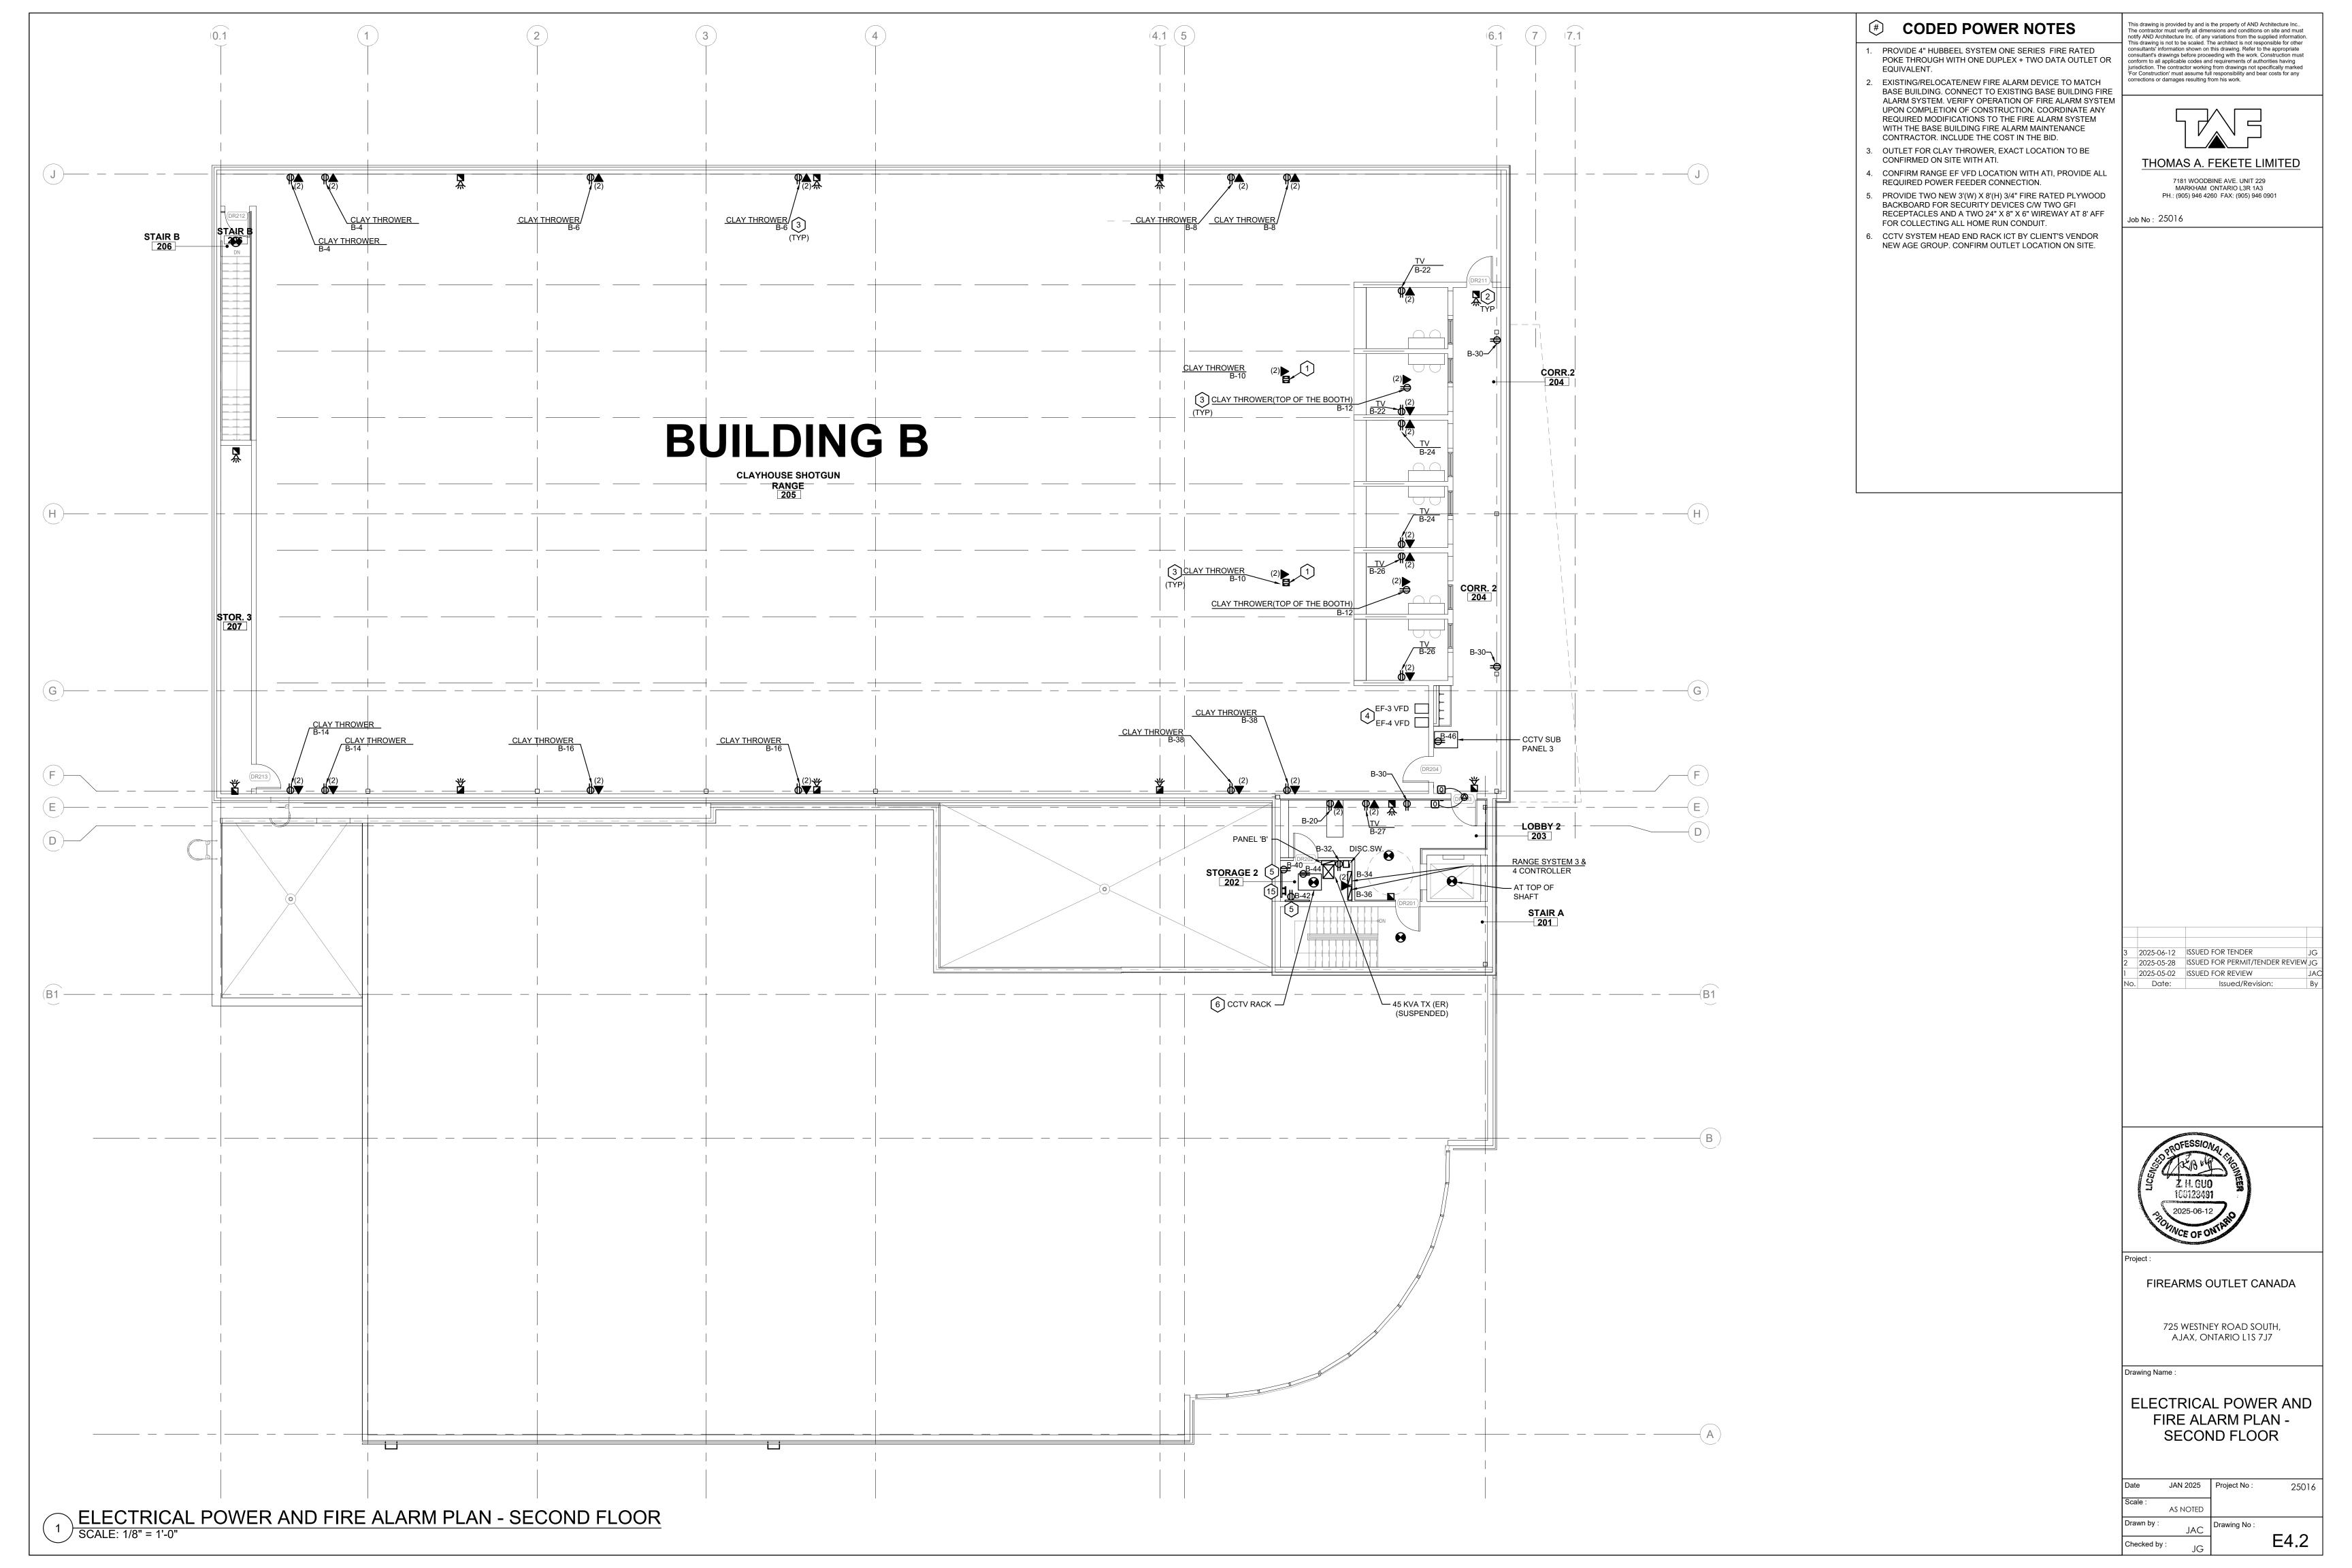

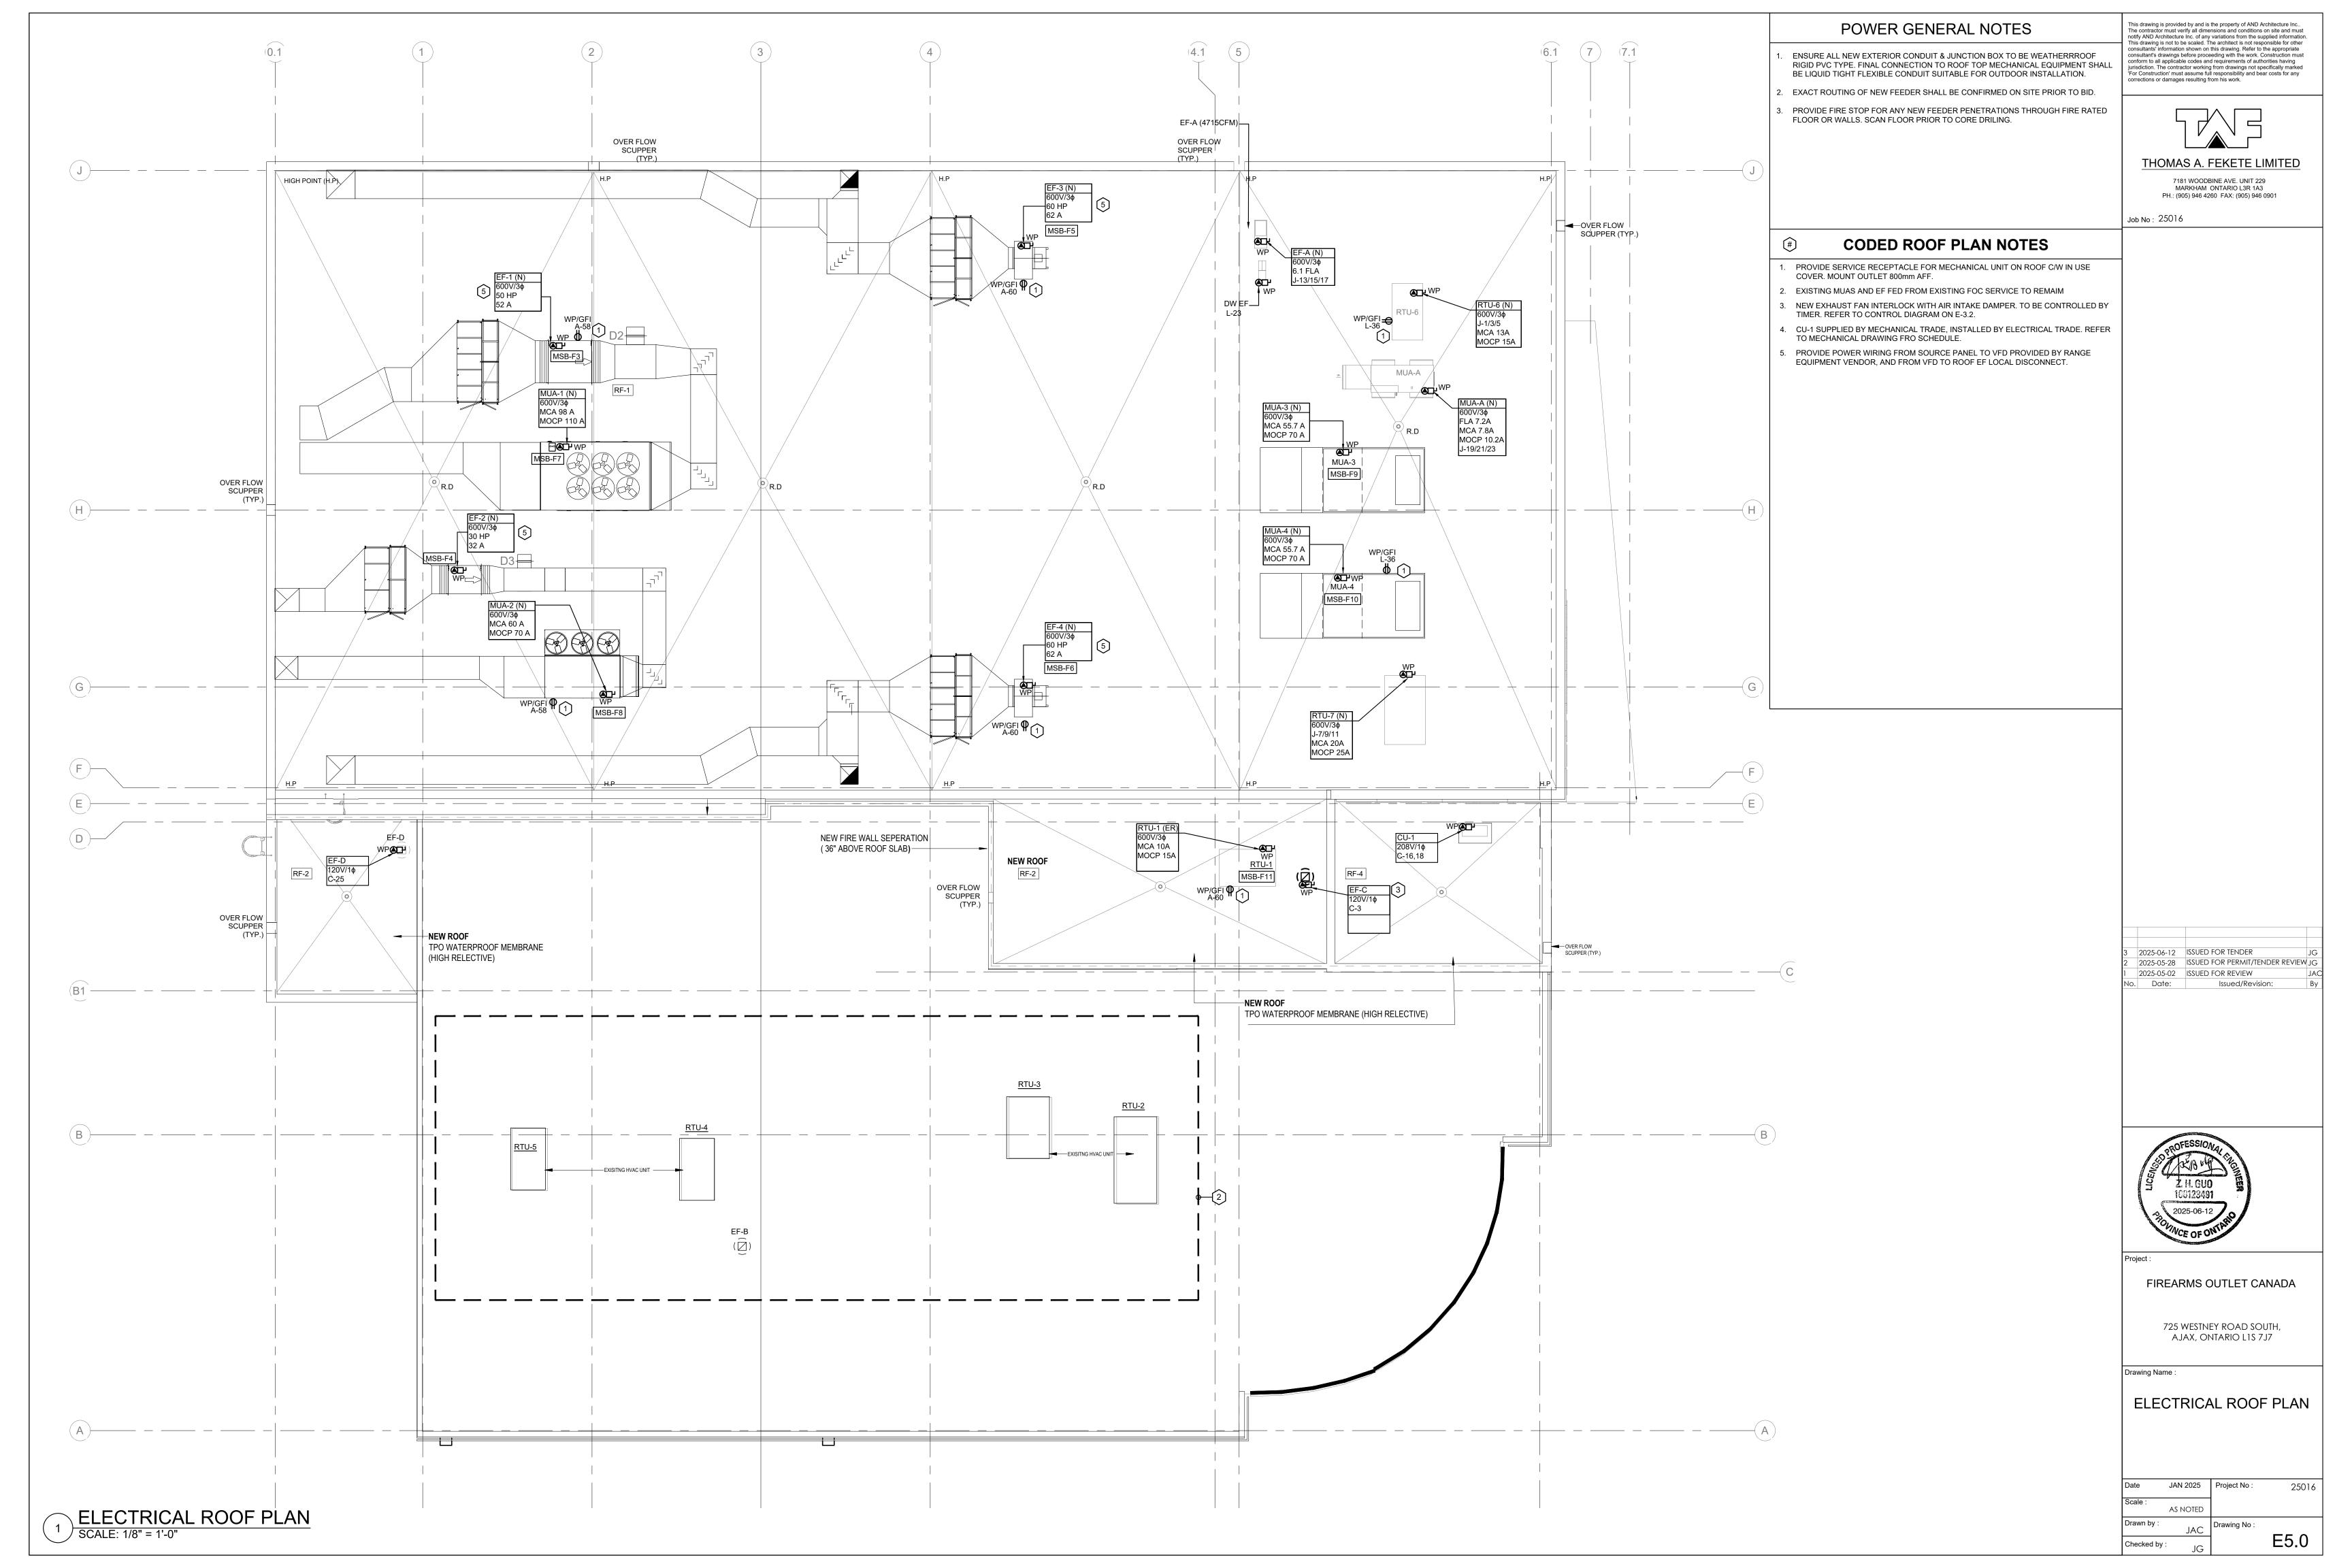

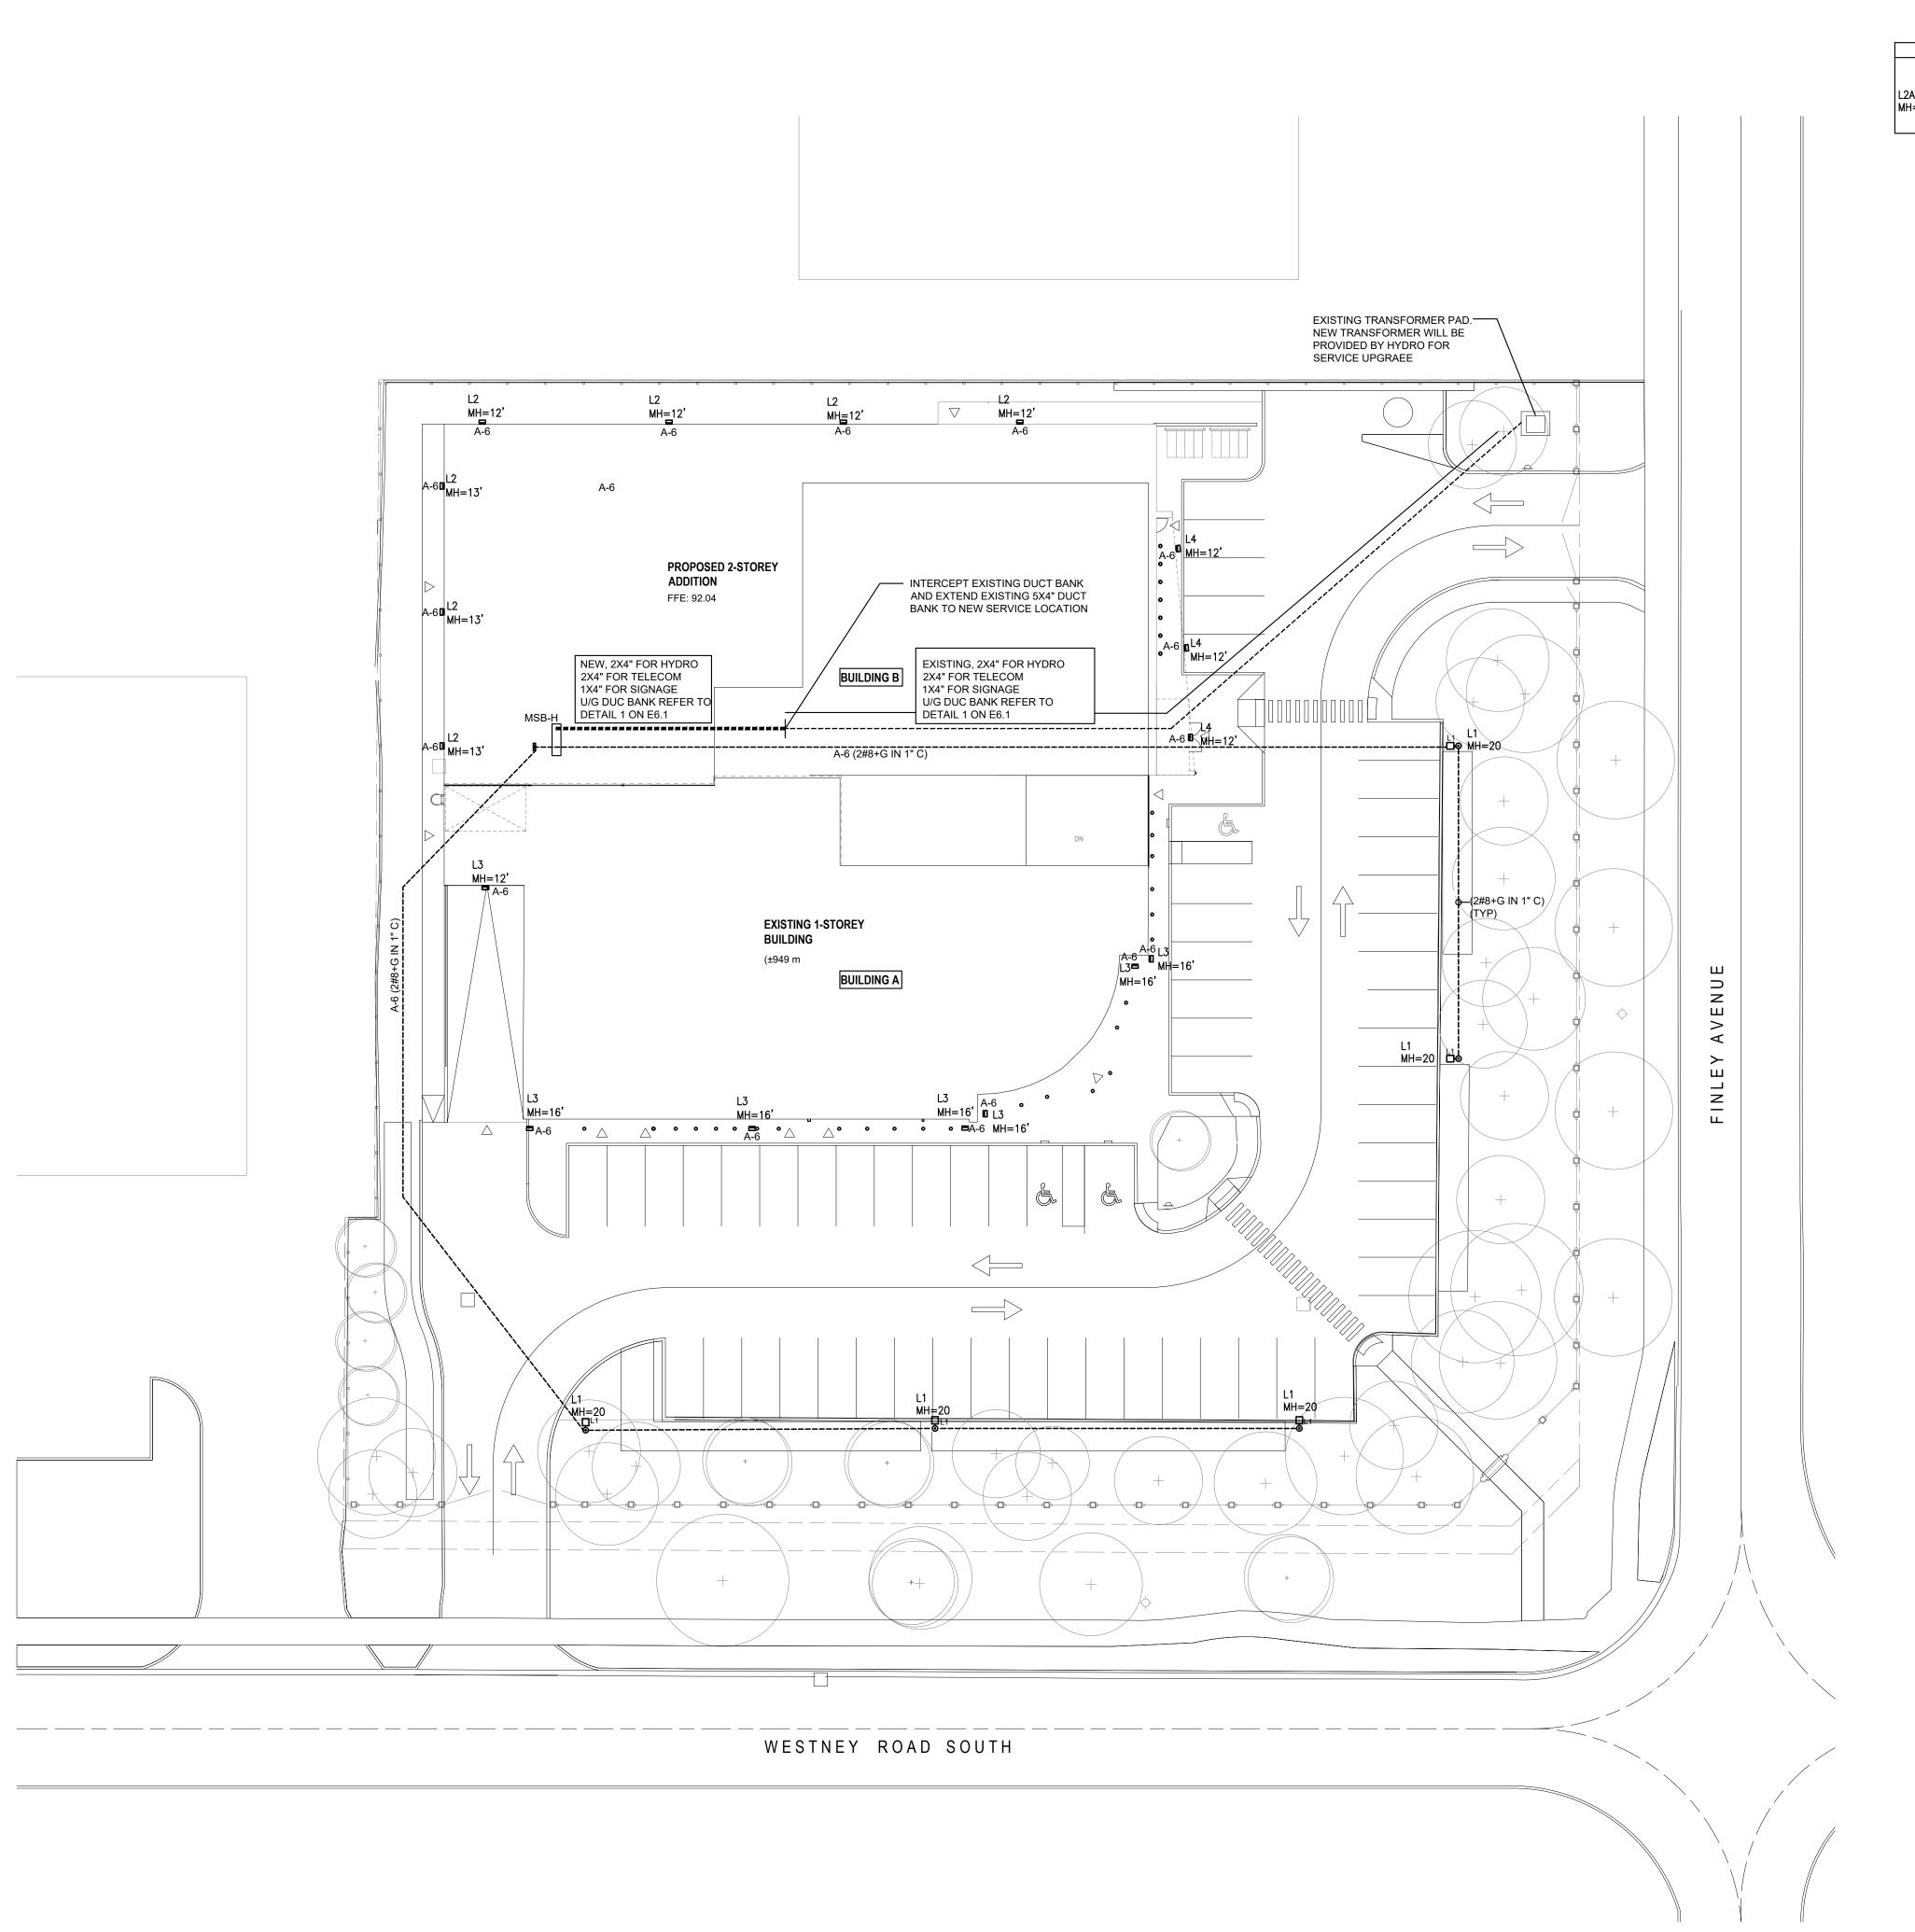

L2A O—XX (FIXTURE TYPE) MH=20 MH=YY (MOUNTING HEIGHT IN FEET)

LEGEND

GENERAL NOTES

- COORDINATE UNDERGROUND SERVICES WITH ALL OTHER TRADES PRIOR TO COMMENCEMENT OF WORK. PROVIDE LOCATES THROUGH THE PROPOSED PATH OF NEW DUCT BANK TO ENSURE NEW DUCT BANK WILL NOT INTERFERE WITH OTHER EXISTING UNDERGROUND
- 2. IT IS THIS CONTRACTOR'S RESPONSIBILITY TO OBTAIN LOCAL HYDRO ELEXICON'S LATEST STANDARDS AND SPECIFICATIONS AND ADHERE TO ALL REQUIREMENTS RELATED TO ELECTRICAL SERVICE WORK.
- PRIMARY HYDRO DUCT BANK, TRANSFORMER BASE AND GROUNDING FOR TRANSFORMER ARE EXISTING TO REMAIN. THIS CONTRACTOR TO PROVIDE NEW SECONDARY DUCT BANK TO NEW MAIN SWITCH BOARD IN NEW ELECTRICAL ROOM LOCATION. SECONDARY WIRING WILL BE PROVIDED BY THIS CONTRACTOR.
- 4. THE ELECTRICAL CONTRACTOR SHALL MAKE ARRANGEMENTS FOR A SITE MEETING WITH THE GENERAL CONTRACTOR, AND LOCAL HYDRO PRIOR TO INSTALLATION OF BUILDING POWER SUPPLY INFRASTRUCTURE. THE PURPOSE OF THE MEETING IS TO COORDINATE THE WORK, REVIEW THE RESPONSIBILITIES OF HYDRO, THE GENERAL CONTRACTOR AND THE ELECTRICAL CONTRACTOR TO ENSURE THAT THE INSTALLATION OF THE TRANSFORMER AND CABLE DUCTS ADHERE TO HYDRO SPECIFICATIONS.
- LIGHTING POLE BASES AND CONDUIT WITH PULL STRING WILL BE PROVIDED BY THIS CONTRACTOR TO. THIS CONTRACTOR TO PROVIDE CONDUIT AND WIRING AS NOTED ON THE PLAN. ALL LIGHTING CONDUITS SHALL BE MINIMUM 27MM PVC TYPE DB-2.
- PROVIDE TWO 100MM COMMINCATIONS DUCT BANK FROM EXISTING BELL PEDESTAL TO NEW ELECTRICAL ROOM.
- EXACT ROUNTING OF CONDUIT ON THE SITE PLAN TO BE CONFIRMED WITH GENERAL CONTRACTOR AND TO BE REFLECTED ON AS BUILT PACKAGE.
- 8. PROVIDE PULL ROPE FOR ALL EMPTY CONDUIT SYSTEMS INSTALLED.
- 9. FOLLOWING WORK RELATED TO THE INCOMING SERVICE MUST BE INCLUDED IN THE BASE BID PRICE:
- NEW SECONDARY DUCT BANK. SECONDARY FEEDER AS SHOWN.
- LUGS AT THE TRANSFORMER • METER CABINET C/W EMPTY CONDUIT BETWEEN THE METER CABINET AND SWITCHBOARD. ONE TELEPHONE OUTLET IN THE HYDRO METER CABINET.
- NEW SWITCHBOARD C/W UTILITY COMPARTMENT AND CT'S AND PT'S ETC.
- 10. MOUNTING HEIGHT OF LIGHTING FIXTURE ARE SHOWN ON FLOOR PLAN IN FEET.


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Job No : 25016

2025-06-12 ISSUED FOR TENDER JG 2025-05-28 ISSUED FOR PERMIT/TENDER REVIEW JG 2025-05-02 ISSUED FOR REVIEW No. Date: Issued/Revision:



FIREARMS OUTLET CANADA


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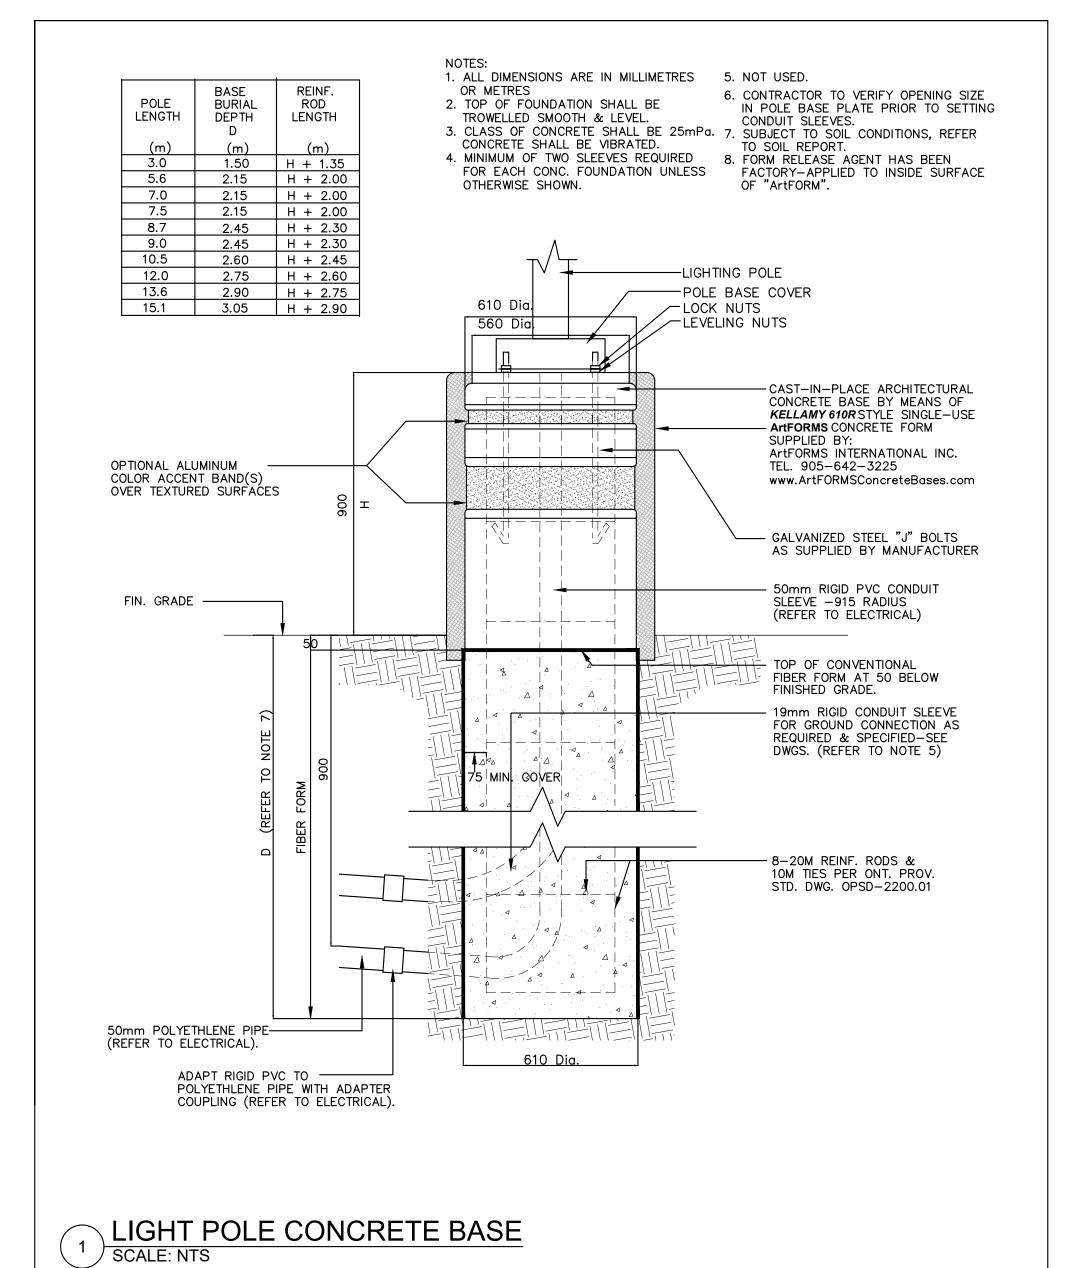
Drawing Name:

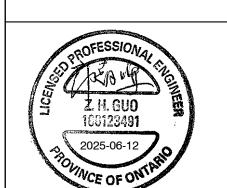ELECTRICAL SITE PLAN

Date	JAN 2025	Project No :	25016
Scale :	AS NOTED		
Drawn by :	JAC	Drawing No :	-
Checked by :			E6.0

	EXTERIOR LIGHTING FIXTURE SCHEDULE					
TYPE	DESCRIPTION	LAMPS	VOLT	MOUNTING	REMARKS	
L1 ⊡ ⊚	LED AREA LUMINAIRE POLE MOUNTED FIXTURE WITH HOUSE SIDE SHIELD LITHONIA DSX0-LED-P7-30K-80CRI-T3M-HS	171 W	120V	POLE MOUNTING HEIGHT AS SHOWN ON PLAN	- 3000K - 19273 LUMEN - C/W MATCHING SQUARE HOT DIP GALVANIZED POLE - FINISH TBD	
L2 모	LED WALL SCONCE -NARROW WIDE OPTIC LITHONIA WDEG2 LED PO 30K 80CRI T1S MVOLT	7 W	120V	WALL MOUNTING HEIGHT AS SHOWN ON PLAN	- 3000K - 750 LUMEN - FINISH TBD	
L3 🖵	LED WALL SCONCE —FORWARD THROW OPTIC LITHONIA WDEG2 LED P4 30K 80CRI VF MVOLT	10 W	120V	WALL MOUNTING HEIGHT AS SHOWN ON PLAN	- 3000K - 4096 LUMEN - FINISH TBD	
L4 모	LED WALL SCONCE -WIDE OPTIC LITHONIA WDEG2 LED P4 30K 80CRI VW MVOLT	10 W	120V	WALL MOUNTING HEIGHT AS SHOWN ON PLAN	- 3000K - 4202 LUMEN - FINISH TBD	



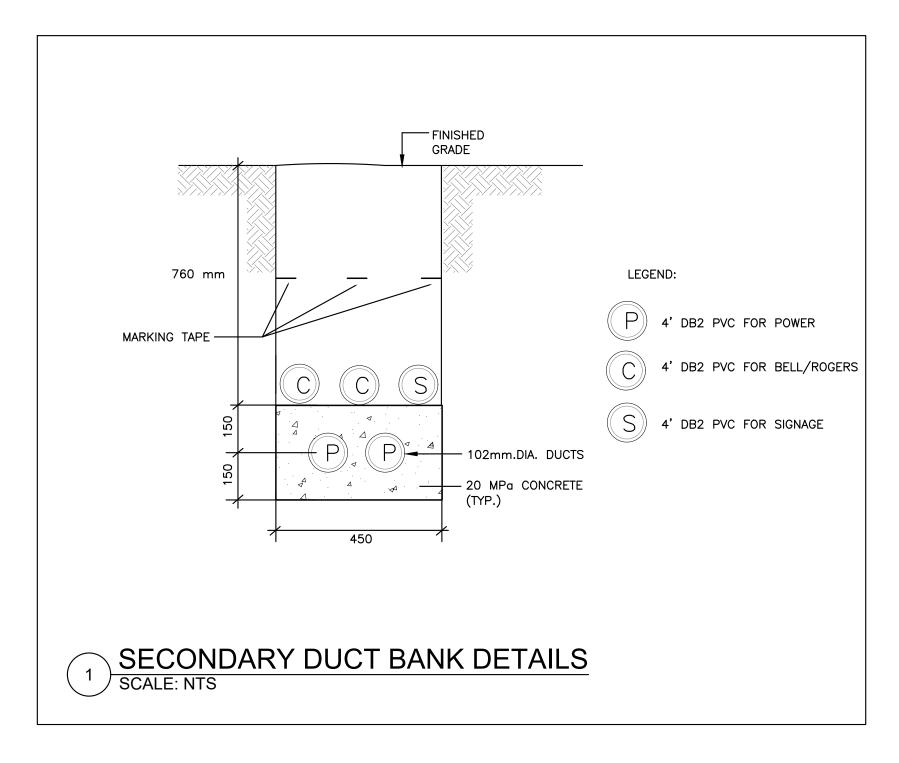

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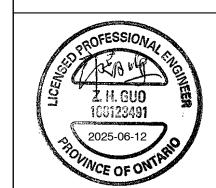
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Project :

FIREARMS OUTLET CANADA

725 WESTNEY ROAD SOUTH, AJAX, ONTARIO L1S 7J7

Drawing Name :

ELECTRICAL SITE PLAN DETAILS

Date JAN 2025 Project No : 25016

Scale : AS NOTED

Drawn by : JAC

Checked by : IG

ELECTRICAL SPECIFICATIONS

16.1 GENERAL CONDITIONS

PROVIDE LABOR, MATERIAL, EQUIPMENT, ETC. REQUIRED TO COMPLETE WORK SHOWN ON THE DRAWINGS OR HEREIN SPECIFIED. THE WORK WILL BE IN ACCORDANCE WITH LATEST RULES AND REGULATIONS OF AUTHORITIES HAVING LEGAL JURISDICTION OVER THE WORK. INCLUDE ANY SMALL ITEMS OF WORK NOT SPECIFICALLY FOR BUT REQUIRED TO COMPLETE THE INTENDED INSTALLATION.

THE ENGINEER RESERVES THE RIGHT TO APPROVE THE QUALITY OF MATERIAL AND WORKMANSHIP. ALSO TO CALL FOR ANY TESTS WHICH ARE DEEMED NECESSARY DURING THE PROGRESS OF THE WORK AND A COMPLETE TEST OF EACH SYSTEM AT THE COMPLETION OF THE WORK. THE COST OF SUCH TESTS ARE NOT TO BE CONSIDERED AS EXTRAS.

ITEMS OR SPECIFICATIONS RELATED TO THE SERVICES INDICATED ON THE DRAWINGS WILL APPLY TO THE PROJECT. THE BIDDING REQUIREMENTS AND GENERAL REQUIREMENTS (APPLICABLE SECTIONS) OF ARCHITECTURAL SPECIFICATIONS WILL ALSO GOVERN THE WORK OF THIS DIVISION.

16.2 SCOPE OF WORK

WORK TO BE DONE WILL INCLUDE FURNISHING OF LABOUR, MATERIALS AND EQUIPMENT REQUIRED FOR INSTALLATION, TESTING AND PUTTING INTO PROPER OPERATION FOR COMPLETE ELECTRICAL SYSTEMS AS SHOWN, AS SPECIFIED AND AS OTHERWISE REQUIRED

16.3 CODES, STANDARDS, PERMITS AND INSPECTION

WORK TO MEET OR EXCEED THE MINIMUM STANDARDS OF THE FOLLOWING:

CANADIAN ELECTRICAL CODE, CURRENT EDITION, PART 1, CSA STANDARDS AS ADOPTED AND AMENDED BY PROVINCIAL REGULATIONS AND PROVINCIAL BUILDING

PROVINCIAL ELECTRICAL SAFETY CODE, CURRENT EDITION AND BULLETINS.

LOCAL ELECTRICAL SUPPLY UTILITY CODES AND REGULATIONS. ELECTRICAL WORK WILL COMPLY WITH LANDLORD'S REQUIREMENTS AND BASE BUILDING STANDARD

THE ABOVE CODES AND ANY ADDITIONAL REQUIREMENTS OF THE LOCAL OR PROVINCIAL AUTHORITY WILL FORM AN INTEGRAL PART OF THIS SPECIFICATION AS IF WRITTEN IN

BE RESPONSIBLE TO APPLY FOR AND OBTAIN PERMITS, INSPECTIONS, EQUIPMENT APPROVALS ETC. AS REQUIRED BY AUTHORITIES HAVING JURISDICTION OVER THIS WORK AND PAY FOR SAME. THESE COSTS WILL BE INCLUDED IN THE TENDER PRICE.

DELIVER PERMITS TO THE OWNER'S REPRESENTATIVE AS SOON AS THEY BECOME **AVAILABLE**

ARRANGE FOR INSPECTION OF ELECTRICAL WORK BY THE ELECTRICAL SAFETY AUTHORITY h) INSPECTION DEPARTMENT. ON COMPLETION OF THE WORK, PRESENT, TO THE OWNER, THE FINAL UNCONDITIONAL CERTIFICATE OF APPROVAL

CONTRACTOR WILL MAINTAIN SUCH INSURANCE TO FULLY PROTECT BOTH THE OWNER AND HIMSELF FROM CLAIMS UNDER THE WORKMANS COMPENSATION ACT AS WELL AS INSURANCE AS NOTED WITHIN ARCHITECTURAL GENERAL CONDITIONS.

16.5 CONTRACT DOCUMENT

SPECIFICATIONS AND DRAWINGS ARE INTENDED TO COVER THE EQUIPMENT SPECIFIED. IT IS NOT THE INTENT TO DESCRIBE OR SHOW EVERY DETAIL. AND IT WILL BE AGREED THAT THE CONTRACTOR PROVIDE WORK AND MATERIAL REQUIRED FOR A COMPLETE AND WORKING SYSTEM ACCORDING TO THE REQUIREMENTS AND INTENT OF THE SPECIFICATIONS AND DRAWINGS.

ANY DISCREPANCIES WILL BE SUBMITTED TO THE CONSULTANT FOR HIS INSTRUCTIONS.

DO NOT SCALE OR MEASURE DRAWINGS, BUT OBTAIN INFORMATION REGARDING ACCURATE DIMENSIONS BY SITE REQUIREMENTS.

16.6 EXAMINATION OF SITE

VISIT THE SITE OF THE PROJECT AND FAMILIARIZE YOURSELF WITH CONDITIONS PERTAINING TO THE WORK PRIOR TO SUBMITTING TENDER. NO ALLOWANCE WILL BE MADE FOR OBVIOUS CONSIDERATIONS WHICH MAY BE OVERLOOKED. THIS INCLUDES THE EXISTING SERVICES ABOVE CEILING.

REPORT ANY DEVIATION OR DISCREPANCY AND/OR CONFLICTS TO THE OWNER. OWNER TO COORDINATE WITH CONSULTANT.

SCHEDULE AND PERFORM WORK TO MEET THE COMPLETION DATES AS SET OUT BY THE OWNER'S REPRESENTATIVE. COSTS OF ANY OVERTIME TO MEET THE SCHEDULE WILL BE DEEMED TO BE INCLUDED IN THE TENDER PRICE.

16.7 SHOP DRAWINGS

SUBMIT PDF FILES OF MANUFACTURER'S SHOP DRAWINGS TO THE CONSULTANT FOR REVIEW. SUBMITTED SHOP DRAWINGS MUST INDICATE DETAILS OF CONSTRUCTION, DIMENSIONS, SCALE, CAPACITIES, WEIGHTS AND ELECTRICAL PERFORMANCE CHARACTERISTICS OF EQUIPMENT OR MATERIALS, AS WELL AS PROJECT NAME.

REVIEW SUBMITTALS PRIOR TO SUBMISSION TO CONSULTANT. THIS REVIEW REPRESENTS THAT NECESSARY REQUIREMENTS HAVE BEEN DETERMINED AND VERIFIED, OR WILL BE, AND THAT EACH SUBMITTAL HAS BEEN CHECKED AND CO-ORDINATED WITH REQUIREMENTS OF THE WORK AND CONTRACT DOCUMENTS.

NO EQUIPMENT WILL BE DELIVERED TO THE JOB SITE UNLESS THE MANUFACTURER HAS RECEIVED A "REVIEWED" OR "REVIEWED AS NOTED" COPY OF THE PERTINENT SHOP

REVIEW OF SHOP DRAWINGS BY THE CONSULTANT WILL NOT ALLEVIATE THE ELECTRICAL CONTRACTOR FROM HIS CONTRACTUAL RESPONSIBILITY FOR ITS CORRECTNESS AND COMPLIANCE WITH THE CONTRACT DOCUMENTS, DIMENSIONS AND DESIGN DETAILS.

16.8 AS BUILT DRAWINGS

AT THE COMPLETION OF THE WORK, ONE ELECTRONIC COPY OF LATEST DRAWINGS IN LATEST AUTOCAD FORMAT WILL BE PROVIDED BY THE CONSULTANT TO THE ELECTRICAL CONTRACTOR, FOR THE PURPOSE OF PREPARING RECORD DRAWINGS.

RECORD, AS THE JOB PROGRESSES, APPROVED CHANGES AND DEVIATIONS MADE TO ANY WORK SHOWN ON THE ORIGINAL CONTRACT DRAWINGS WHETHER BY ADDENDA, REQUESTED CHANGES, JOB INSTRUCTIONS, AND CHANGES DUE TO JOB CONDITIONS.

MAIN BRANCH CONDUIT RUNS, JUNCTIONS BOX LOCATIONS, ETC., MUST BE REFLECTED ON THE AS-BUILT DRAWINGS.

CLEARLY INDICATE 'AS-BUILT' IN THE TITLE BLOCK COLUMN OF THE DRAWINGS AS WELL AS THE ELECTRICAL CONTRACTOR'S NAME AND ADDRESS.

SUBMIT A PRINT TO CONSULTANT FOR REVIEW. WHEN FOUND ACCEPTABLE BY THE CONSULTANT, SUBMIT FIVE (5) SETS OF PRINTS TOGETHER WITH THE CAD-DISK FOR PRESENTATION TO OWNER.

16.9 OPERATION AND MAINTENANCE MANUAL

PROVIDE THREE (3) SETS OF OPERATION AND MAINTENANCE MANUALS SUBMITTED IN HARD COVER 3-RING BINDERS, INCLUDE THE FOLLOWING INFORMATION IN THE OPERATIONS AND MAINTENANCE MANUALS:

NAME AND ADDRESS OF LOCAL SUPPLIERS FOR THE ITEMS INCLUDED TECHNICAL DATA AND DESCRIPTION OF ITEMS AND PARTS LISTED THE CONSULTANT'S REVIEWED SHOP DRAWINGS. CERTIFICATE(S) OF ACCEPTANCE FROM THE AUTHORITIES INSPECTION DEPARTMENT WRITTEN GUARANTEE

PERFORM TEST ON EACH SYSTEM TO THE SATISFACTION OF THE CONSULTANT AND SUBMIT TEST RESULTS FOR APPROVAL PRIOR TO THE FINAL ACCEPTANCE OF THE

PANELS WILL BE BALANCED WITHIN 5% ACROSS PHASES GROUNDING WILL BE AS REQUIRED BY ELECTRICAL SAFETY AUTHORITY CODE AND LOCAL UTILITY REQUIREMENTS.

16.11 PRECAUTIONS DURING CONSTRUCTION

COORDINATE WITH LANDLORD.

PROVIDE SCHEDULE AND OBTAIN APPROVAL FROM BASE BUILDING AND CLIENT PRIOR TO COMMENCEMENT OF WORK. ALSO OBTAIN INSTRUCTION FROM OWNER REGARDING WHAT TYPE OF WORK CAN BE DONE WITHIN NORMAL HOURS AND WHAT TYPE OF WORK HAVE TO BE DONE AFTER HOURS. TAKE ABOVE MENTIONED RESTRICTIONS INTO CONSIDERATION WHEN SUBMITTING BID. NO ADDITIONAL COST WILL BE OWED TO COMPENSATE COST ASSOCIATED WITH THESE FACTORS.

- CARRY OUT WORK WITH A MINIMUM OF NOISE, DUST AND DISTURBANCE. PROVIDE DAILY CLEAN UP AND PROPER DISPOSAL OF DEBRIS GENERATED BY DAILY OPERATIONS. ON COMPLETION OF THE WORK, TOOLS, SURPLUS MATERIALS AND WASTE MATERIAL WILL BE REMOVED AND THE PREMISES LEFT IN A CLEAN AND
- BE RESPONSIBLE AND PAY FOR ANY DAMAGE TO THE BASE BUILDING INCURRED BY WORK OF THIS DIVISION, OR REPAIR TO THE SATISFACTION OF OWNER . OWNER TO
- ENSURE EXISTING EQUIPMENT WIHICH ARE TO BE REUSED IS THOROUGHLY INSPECTED AND REFURBISHED TO ENSURE PROPER OPERATION AND MEETS THE LOCAL ELECTRICAL SAFETY AUTHORITY'S REQUIREMENTS. CONDUIT OR OUTLET BOXES WHICH ARE CORRODED OR DAMAGED WILL BE REPLACED.
- CLEAN SURFACES, REFLECTOR AND LAMPS OF NEW AND EXISTING LUMINAIRE,
- CLEAN PANEL BOARD, DEVICES, OUTLETS AT THE END OF CONSTRUCTION. WHEN DELETING AND/OR MAKING SAFE EXISTING ELECTRICAL WORK. ENSURE THAT IT INCLUDES REMOVAL OF DISCONNECTED WIRING BACK TO SOURCE.
- DISCONNECT AND REMOVE EXISTING LUMINAIRES, DEVICES WHICH ARE NOT TO BE REUSED. REMOVE REDUNDANT COMMUNICATIONS CABLE IN THE CONSTRUCTION
- ELECTRICAL EQUIPMENT AND DEVICES WHICH ARE NO LONGER REQUIRED WILL BE REMOVED AND DISPOSED OF, OFF SITE.

16.12 IDENTIFICATION

- PROVIDE LAMACOID IDENTIFICATION NAMEPLATES. THESE WILL BE WHITE WITH BLACK ENGRAVED LETTERS AND WILL BE INSTALLED WITH SCREWS ON EQUIPMENT, NAMEPLATES WILL BE 3MM (1/8") THICK WITH BEVELLED EDGES.
- INFORMATION REQUIRED TO BE SHOWN ON THE NAMEPLATE FOR VARIOUS EQUIPMENT ARE DESCRIBED BELOW:
 - DISCONNECTS, STARTERS AND CONTACTORS: INDICATE EQUIPMENT BEING CONTROLLED AND VOLTAGE. LOCATION, VOLTAGE AND RATING OF UPSTREAM
 - BREAKER OR DISCONNECT SWITCH. TERMINAL CABINETS AND PULL BOXES: INDICATE SYSTEM AND VOLTAGE. TRANSFORMERS: INDICATE CAPACITY, PRIMARY AND SECONDARY VOLTAGES, UPSTREAM AND DOWNSTREAM DEVICE OR EQUIPMENT LOCATIONS & DESIGNATION.
- EACH NEW PANEL WILL HAVE TYPEWRITTEN DIRECTORY SHOWING LOADS CONNECTED TO EACH CIRCUIT. DIRECTORIES WILL BE MOUNTED ON THE INSIDE OF THE PANEL DOOR IN A TRANSPARENT PLASTIC COVER. FOR EXISTING PANELS BEING MODIFIED, UPDATE THE EXISTING DIRECTORIES TO SUIT NEW WORK. PROVIDE NEW TYPE WRITTEN SCHEDULE.

16.13 RESPONSIBILITY

BE RESPONSIBLE FOR ELECTRICAL WORK UNTIL COMPLETION AND FINAL ACCEPTANCE, BY OWNER, FOR REPLACING ANY ITEM THAT MAY BE DEFECTIVE, DAMAGED, LOST OR STOLEN, WITHOUT ADDITIONAL COST TO THE OWNER OR DELAY TO THE COMPLETION OF THE PROJECT.

- a) WARRANT WORK AND APPARATUS INSTALLED, UNDER THIS CONTRACT, AGAINST DEFECTS IN MATERIAL OR WORKMANSHIP FOR A PERIOD OF ONE YEAR AFTER FINAL ACCEPTANCE OF SAME BY THE OWNER.
- b) THESE GUARANTEE WILL IN NO WAY SUPPLANT ANY OTHER GUARANTEES OF A LONGER PERIOD, BUT WILL BE BINDING ON OTHER WORK.

16.15 EQUIPMENT AND MATERIAL

EQUIPMENT AND MATERIAL, UNLESS SPECIFICALLY NOTED OTHERWISE, WILL BE NEW AND FREE OF BLEMISH OR DEFECT. MATERIAL AND EQUIPMENT WILL BE OF THE TYPE SUBJECT TO FACTORY MUTUAL, UNDERWRITERS' LABORATORIES OF CANADA AND/OR CANADIAN STANDARDS ASSOCIATION INSPECTION AND APPROVAL AND WILL BEAR ULC OR CSA LABELS.

16.16 CUTTING AND PATCHING

a) THE CONTRACTOR WILL EMPLOY THE PARTICULAR TRADES TO DO REQUIRED CUTTING AND PATCHING AND REPAIRING OF SURFACES FOR HIS WORK.

SUPPORTING MEMBERS OF ANY FLOOR, W OR THE BUILDING STRUCTURE WILL BE CUT ONLY

IN SUCH A LOCATION AND MANNER AS DIRECTED BY THE CONSULTANT/OWNER. HOLES AND SURFACES WILL BE REPAIRED WITH THE TYPE OF MATERIAL REMOVED BY THE TRADESMEN EXPERT IN THE TYPE OF REPAIR REQUIRED.

PROVIDE FIRE BARRIERS AROUND COMPONENTS IN HOLES THAT PENETRATE FIRE SEPARATIONS. THE FIRE BARRIER MEDIUM PROVIDED WILL MAKE THE FIRE SEPARATION EQUAL TO OR BETTER THAN THE ONE WHICH WAS CUT AWAY. MATERIALS WILL BE CSA APPROVED AND UL LISTED.

16.17 FLOOR CUTTING AND CORE DRILLING

- WHERE CORE DRILLING OR FLOOR CUTTING IS REQUIRED, THIS CONTRACTOR WILL NOTIFY OWNER OF THE LOCATION AND OBTAIN ITS APPROVAL PRIOR TO COMMENCING. X-RAY FLOOR OR W AS REQUIRED BY OWNER. OWNER TO COORDINATE WITH LANDLORD.
- INCLUDE ALLOWANCE IN THE BID PRICE SHOULD CORE DRILLS ARE REQUIRED TO BE CARRIED OUT AFTER NORMAL HOURS.
- ANY DAMAGES AS A RESULT OF CORE DRILLING WILL BE REPAIRED IMMEDIATELY AT NO COST TO OWNER.

16.18 INTERRUPTION OF SERVICE

- a) CO-ORDINATE REQUIRED POWER SHUTDOWNS WITH OWNER. PROVIDE TWO-WEEKS NOTICE TO OWNER AND OBTAIN THEIR APPROVAL BEFORE PROCEEDING WITH THE WORK THAT REQUIRES SHUTDOWN. OWNER TO COORDINATE WITH LANDLORD.
- THE BID SUBMITTED WILL INCLUDE ALLOWANCES FOR TIME SPENT ON COORDINATION OF INTERRUPTION.

16.19 PRICING FOR CHANGES

- a) PROVIDE DETAILED BREAKDOWN FOR MATERIAL LABOUR REQUIRED CHANGES SHOULD BE CALCULATED BASED ON THE LATEST ISSUE OF NATIONAL ELECTRICAL CONTRACTORS ASSOCIATION (NECA) MANUAL, COLUMN ONE FOR THE DURATIONS OF THIS
- THE HOURLY LABOUR RATE WILL INCLUDE CHARGES FOR SUPERVISION, VARIABLE LABOUR FACTORS, HAND TOOLS, STORAGE, RENTALS, ADDITIONAL BONDING, PARKING, CLEAN-UP, AS-BUILT DRAWINGS, FREIGHT AND DELIVERY, BUT EXCLUSIVE OF OVERHEAD AND PROFIT.

16.20 SYSTEM START-UP

- a) INSTRUCT OWNER AND OPERATING PERSONNEL IN THE OPERATION, CARE AND MAINTENANCE OF SYSTEMS, SYSTEM EQUIPMENT AND COMPONENTS.
- ARRANGE AND PAY FOR SERVICES OF MANUFACTURER'S FACTORY SERVICE ENGINEER TO SUPERVISE START-UP OF INSTALLATION, CHECK, ADJUST, BALANCE AND CALIBRATE COMPONENTS AND INSTRUCT OPERATING PERSONNEL
- PROVIDE THESE SERVICES FOR SUCH PERIOD, AND FOR AS MANY VISITS AS NECESSARY TO PUT EQUIPMENT IN OPERATION, AND TO ENSURE THAT OWNER ARE CONVERSANT WITH c) ASPECTS OF ITS CARE AND OPERATION.

PROVIDE GROUNDING FOR EQUIPMENT TO THE LATEST VERSION OF ELECTRICAL SAFETY CODE AND INSPECTION AUTHORITIES PROVIDE SEPARATE GREEN INSULATED GROUND CONDUCTOR IN EVERY CONDUIT TO EQUIPMENT/DEVICES CONDUIT WILL NOT BE USED AS A BONDING SYSTEM.

16.22 TEMPORARY SERVICES

- PROVIDE TEMPORARY ELECTRICAL SERVICES, AS REQUIRED, WILL BE PART OF
- PROVIDE TEMPORARY GENERAL LIGHTING THROUGHOUT CONSTRUCTION SITE. REUSE EXISTING LUMINAIRES AT SUITABLE CENTRES TO CONFORM TO CONSTRUCTION STANDARDS AND AUTHORITIES HAVING JURISDICTION.
- PROVIDE TEMPORARY GENERAL POWER SUPPLIES WITH RECEPTACLES FOR TRADES AS DIRECTED BY THE GENERAL CONTRACTOR.
- d) MAINTAIN THE TEMPORARY FACILITIES IN GOOD REPAIR AND SAFE WORKING ORDER THROUGHOUT THE DURATION OF THE PROJECT.
- e) AT THE END OF THE PROJECT, REMOVE THE ABOVE NOTED TEMPORARY SYSTEM.

16.23 SUPPORTS AND BASES AND HANGERS

- HANGERS FOR ELECTRICAL CONDUITS WILL BE GALVANIZED AFTER FABRICATION. DO NOT USE PERFORATED STRAPPINGS (GRABBER BARS) TO HANG CONDUITS.
- PROVIDE INDEPENDENT SUPPORTS FOR NEW EQUIPMENT, DEVICES LIGHTING FIXTURES AND CONDUITS. DO NOT USE SUPPORTS OR EQUIPMENT INSTALLED FOR OTHER TRADES FOR CONDUIT OR CABLE SUPPORT EXCEPT WITH PERMISSION OF OTHER TRADE AND APPROVAL OF CONSULTANT.

16.24 CONDUIT AND FITTINGS

- CONDUIT SIZES WILL BE AS INDICATED ON DRAWINGS AND WILL NOT BE REDUCED WITHOUT AUTHORIZATION, CONDUITS IN FINISHED AREAS WILL BE CONCEALED. ALL SURFACE CONDUITS.
- UNI ESS OTHERWISE NOTED. CONDUITS FOR PANEL FEEDERS AND BRANCH CIRCUIT WIRING WILL BE THIN W (EMT). CONDUIT EXPOSED TO WEATHER WILL BE RIGID GALVANIZED. USE RIGID PVC CONDUIT WHEN EMBEDDED IN CONCRETE. USE APPROVED CONCRETE TIGHT FITTINGS. USE BX CABLES ONLY IN PARTITION WALLS AND IN CEILING SPACE FOR FINAL DROPS TO LIGHTING FIXTURES AND W OUTLETS. BX CABLE IN CEILING SPACE WILL NOT EXCEED 10' (3M).
- CONDUITS WILL BE INSTALLED AT A MINIMUM OF 6" (152mm) FROM UNINSULATED HEATING PIPES AND CONDUITS CARRYING DATA CABLES.
- CLEAN INTERIOR OF CONDUITS TO REMOVE DEBRIS AND WATER AND REMOVE ANY BURRS PRIOR TO PULLING WIRES.
- PROVIDE SEPARATE INSULATED GROUND CONDUCTOR IN CONDUITS, REGARDLESS OF TYPE.
- FIRESTOPPING IS REQUIRED WHERE HOLES ARE DRILLED THROUGH FLOORS OR WALLS. HOLES WILL BE PACKED AROUND CONDUIT (OR RACEWAY) WITH AN APPROVED CAULKING COMPOUND. ("CIRAFIBRE 2300" OR "FLAMESEAL" PUTTY) OR EQUIVALENT.
- PROVIDE FLEXIBLE METAL CONDUIT FOR CONNECTIONS TO MOTORS, UPS UNITS AND TRANSFORMERS.
- MINIMUM CONDUIT SIZE WILL BE 1/2" (13mm) UNLESS NOTED OTHERWISE
- CONDUITS, ARMORED CABLES AND OTHER RACEWAYS WILL BE SUPPORTED INDEPENDENTLY OF ANY SUSPENDED CEILING.
- j) <u>DO NOT USE ALUMINUM CONDUIT</u>.
- PROVIDE LIQUID-TIGHT FLEXIBLE METAL CONDUIT FOR FINAL CONNECTION TO

16.25 PULL & JUNCTION BOXES

- BOXES WILL BE CODE GAUGE AND SIZED TO MEET ELECTRICAL CODE REQUIREMENTS. SHEET STEEL BOXES FOR CONCEALED WORK AND CAST BOXES FOR EXPOSED WORK. "THROUGH" AND "UTILITY" TYPE BOXES WILL NOT BE USED.
- PROVIDE BARRIERS IN BOXES WHERE DIFFERENT VOLTAGES ARE USED.
- PROVIDE PULL BOXES ON CONDUIT RUNS AT 50ft (15.25m) INTERVALS.
- BOXES WILL BE SUPPORTED INDEPENDENTLY OF CONDUIT.
- IDENTIFY ELECTRICAL BOXES OF DIFFERENT SYSTEMS WITH A DIFFERENT COLOUR, THIS WILL BE ACHIEVED WITH SPRAY PAINT CANS. COLOURS WILL MATCH BASE BUILDING STANDARD.

16.26 INSTALLATION OF OUTLETS

- THE DRAWINGS SHOW APPROXIMATE LOCATION OF OUTLETS ONLY. THE EXACT LOCATION WILL BE COORDINATED ON SITE WITH OTHER TRADES, OUTLETS LOCATED INACCURATELY WILL BE READJUSTED OR RELOCATED AT THE CONTRACTORS EXPENSE PROVIDED THAT THE DISTANCE DOES NOT EXCEED 3m (10'-0"). UNLESS OTHERWISE NOTED, RECEPTACLES WILL BE MOUNTED AT 12" (300mm) AFF.
- b) PROVIDE ACOUSTICALLY INSULATED OUTLET BOXES.
 - WHERE OUTLETS ARE MOUNTED ON OPPOSITE SIDES OF THE SAME PARTITION, STAGGER THEM TO RETAIN ACOUSTIC ATTENUATION OF PARTITION.

16.27 INSTALLATION OF PLYWOOD BACKBOARDS

PROVIDE 19mm (3/4") THICK, FIRE RETARDANT PLYWOOD BACKBOARDS AS REQUIRED FOR ALL WALL MOUNTED ELECTRICAL EQUIPMENT/DEVICE OF THIS

16.28 WIRE AND CABLE

- UNLESS OTHERWISE NOTED, WIRES WILL BE COPPER RW90 RATING AS REQUIRED ON SITE AND AS DICTATED BY ELECTRICAL SAFETY AUTHORITY CODE. ALUMINUM WIRE WILL NOT BE USED.
- THE MINIMUM PERMISSIBLE SIZE FOR BRANCH CIRCUIT WIRING WILL BE #12
- WIRE #10 AWG AND SMALLER WILL BE SOLID COPPER, #8 AWG AND LARGER WILL BE COPPER STRANDED.
- WIRING WILL BE COLOUR CODED AND WILL BE IDENTIFIED SHOWING SIZE, **VOLTAGE RATING AND INSULATION TYPE:**
- BRANCH WIRING WILL BE NO. 12 AWG UP TO 70 FT. AND NO.10 AWG FROM 70 FT. TO 120 FT. FOR A LONGER DISTANCE , THE VOLTAGE DROP WILL BE CALCULATED AT 3%.
- CABLES INSTALLED FREE AIR INSIDE THE CEILING SPACE AS RETURN AIR PLENUM WILL BE FT6 PLENUM RATED. ELECTRICAL CONTRACTOR WILL COORDINATE WITH GENERAL CONTRACTOR AND PROVIDE INSTRUCTION TO OTHER WIRING CONTRACTOR AT THE BEGINNING OF CONSTRUCTION AND MONITOR WIRING INSTALLATION BY OTHERS TO ENSURE PROPER TYPES OF CABLES ARE INSTALLED.
- MINIMUM WIRE SIZE FROM BATTERY UNIT TO REMOTE LIGHT HEADS WILL BE NO.10 AWG. MAXIMUM VOLTAGE DROP WILL BE 5%

16.29 WIRING DEVICES

- RECEPTACLES TYPES ARE SHOWN ON FLOOR PLAN OR SINGLE LINE DIAGRAM BESIDE RECEPTACLE.
- ACCEPTABLE MANUFACTURER OF RECEPTACLES ARE HUBBELL, LEVITON, BRYANT OR ARROW HART
- c) RECEPTACLES WILL BE SPECIFICATION GRADE, BACK AND SIDE WIRED EQUAL TO HUBBELL BR15. COLOR TO BE CONFIRMED WITH DESIGNER OR ARCHITECT.
- RECEPTACLES AND OUTLETS WILL BE IDENTIFIED WITH 9mm LAMINATED TAPE WITH SINGLE LINE TEXT PRINTED BY TAPE LABELLER INDICATING PANEL DESIGNATION AND CIRCUIT NUMBER(S).
- - RECEPTACLE AND COVER PLATE TO BE WHITE UNLESS NOTED OTHERWISE. PROVIDE SHEET METAL COVER PLATES FOR WIRING DEVICES MOUNTED IN
 - SURFACE MOUNTED FS OR FD BOXES, OR UTILITY BOXES. PROVIDE WEATHERPROOF IN USE TYPE COVER PLATES, COMPLETE WITH GASKETS FOR WEATHERPROOF DUPLEX RECEPTACLES.
- THE OWNER HAS THE RIGHT TO RELOCATE OUTLETS UP TO TEN FEET PRIOR TO INSTALLATION WITHOUT EXTRA CHARGE.
- KITCHEN EQUIPMENT CONNECTIONS INCLUDING RECEPTACLES MOUNTING HEIGHT WILL BE COORDINATED ON SITE WITH THE LATEST KITCHEN EQUIPMENT INFORMATION TO BE PROVIDED BY EQUIPMENT SUPPLIER.

16.30 DISTRIBUTION EQUIPMENT

- a) RATING AND TYPE OF NEW PANELBOARDS, DISCONNECT SWITCHES, METERS, TRANSFORMERS WILL BE OF SAME STANDARD AS EXISTING BASE BUILDING EQUIPMENT. ACCEPTABLE MANUFACTURES ARE LISTED AS FOLLOWS IF UNABLE TO MATCH BASE BUILDING EQUIPMENT. EQUIPMENT WILL HAVE COPPER BUS OR
- SCHNEIDER **CUTLER-HAMMER**
- SIEMENS b) MODULE CASE CIRCUIT BREAKERS WILL BE BOLT-ON TYPE

WINDING AND MUST BE COMMERCIAL GRADE PRODUCT.

- DISCONNECT SWITCHES WILL BE HEAVY DUTY, QUICK MAKE, QUICK BREAK, VOIDABLE COVER INTERLOCK, LOCKABLE IN "OFF" POSITION WITH NEUTRAL BAR WHERE REQUIRED.
- d) PANELBOARDS WILL C/W FACTORY INSTALLED BOLT-ON CIRCUIT BREAKERS RATED AS SHOWN ON THE DRAWINGS. MULTI-POLE BREAKERS WILL HAVE COMMON TRIP. BREAKERS WILL BE SUITABLE FOR SWITCHING DUTY. RESIDENTIAL LOAD CENTERS ARE NOT ACCEPTABLE. PROVIDE SPRINKLER HOOD FOR SURFACE

MOUNTED PANELS IN A SPRINKLERED SPACE.

- e) MINIMUM STANDARD FOR DRY TYPE TRANSFORMERS.
- TYPE: ANN. K FACTOR OF 13
- INSULATION: CLASS 220 C, 150°C TEMPERATURE RISE. BASIC IMPULSE LEVEL (BIL): 600 V CLASS - 10KV
- AVERAGE SOUND LEVEL: AS PER TABLE 9 OF CSA STANDARD WINDING: COOPER WINDING, ELECTROSTATICALLY SHIELDED

SPRINKLER PROOF TYPE IN SPRINKLERED BUILDING

POLYGON/MAGNETEK.

OF IT AND COMMUNICATIONS CABLES AND ASSOCIATED EQUIPMENT.

16.31 COMMUNICATION RACEWAY SYSTEMS

1. SUPPLY AND INSTALL THE REQUIRED EMPTY RACEWAY SYSTEM C/W CONDUITS PULLBOXES, PANELS, OUTLET BOXES, COVER PLATES, SUITABLE FOR THE INSTALLATION

• BY ONE OF FOLLOWING MANUFACTURER: DELTA, SCHNEIDER, ACME, HAMMOND,

2. RACEWAYS SHALL BE RIGID, GALVANIZED STEEL CONDUIT WHERE EXPOSED TO MECHANICAL INJURY. IN ALL OTHER LOCATIONS, EMT MAY BE USED. MINIMUM CONDUIT SIZE TO BE 19mm. WORK TO BE DONE TO CSA T527 AND CSA T530.

3. ALL DATA OUTLETS SHALL BE WIRED WITH MINIMUM CAT6 CABLING AND TERMINATED AT

BOTH ENDS. USE A BIX BLOCK IN TELEPHONE ROOMS AND RJ45 OUTLETS IN DATA BOXES.

- CERTIFY AND PROVIDE RECORD OF CERTIFICATION FOR ALL CABLES AT END OF 4. PROVIDE A 110V POWER OUTLET ADJACENT TO THE IT EQUIPMENT LOCATIONS FOR
- UTILITY COMPANY'S STEP DOWN TRANSFORMER. 5. UNLESS OTHERWISE SHOWN, STEEL PULLBOXES SHALL BE INSTALLED EVERY 30m OR LESS OF STRAIGHT CONDUIT RUN; EVERY 25m OR LESS OF STRAIGHT CONDUIT RUN AND ONE 90 DEGREE BEND OR EQUIVALENT; EVERY TWO 90 DEGREE BENDS OR EQUIVALENT.
- SERVICE GROUND TO PROVIDE A GROUND FOR THE TELEPHONE SYSTEM. 7. REFER TO COMMUNICATIONS SPECIFICATIONS AND COMMUNICATIONS CABLING AND

TERMINATION CHART FOR ADDITIONAL REQUIREMENTS.

6. A #6 GROUND WIRE SHALL BE RUN FROM THE TELEPHONE SERVICE PANEL TO THE

16.34 LIGHTING FIXTURES AND LAMPS

- PROVIDE LUMINAIRES AND LAMPS AS INDICATED ON LUMINAIRE SCHEDULE AND/OR SPECIFIED HEREIN. LUMINAIRES ARE TO BE COMPLETE WITH NECESSARY FRAMES, HANGERS, LAMPS, LOUVERS, DIFFUSERS, CANOPIES, SUPPORTS ETC. ACCEPTABLE MANUFACTURERS OF FLUORESCENT LUMINAIRES ARE AS INDICATED, OR APPROVED EQUAL.
- BALLASTS WILL BE LONG LIFE, FULL LIGHT OUTPUT, ENERGY SAVING TYPE, SOUND RATED "A", RAPID START ELECTRONIC TYPE AS SPECIFIED. PROVIDE PROGRAM START BALLAST FOR LAMPS CONTROLLED BY OCCUPANCY
- UNLESS OTHERWISE NOTED ON THE DRAWINGS, FLUORESCENT LAMPS WILL BE RAPID START "T8", 3500 K, 20,000 HOURS RATED LIFE BY GE, PHILIPS OR OSRAM.

SUPPORT CHAIN ON LUMINAIRES. SEPARATE ON THE CEILING FOR SUPPORT.

- d) WHERE LUMINAIRES ARE INSTALLED IN LAY-IN TILE CEILINGS, PROVIDE SAFETY
- e) LUMINAIRES WILL BE SUPPORTED FROM STRUCTURAL MEMBERS
- f) EXISTING LUMINAIRES INDICATED TO BE REUSED WILL BE TAKEN DOWN, CLEANED, RELAMPED AND PROVIDED WITH NEW LENSES AND BALLAST AS REQUIRED.

16.35 CLOSE OUT DOCUMENTATION

INDEPENDENTLY.

THE FOLLOWING INFORMATION MUST BE PROVIDED TO THE ENGINEER PRIOR TO FINAL SITE INSPECTION AND ISSUANCE OF THE ENGINEERS FINAL SIGN OFF

FIRE ALARM VERIFICATION REPORT

LETTER TO OBTAIN OCCUPANCY.

- LETTER OF ACCEPTANCE FROM THE ELECTRICAL SAFETY AUTHORITY. EMERGENCY LIGHTING LETTER ATTESTING TO THE FACT THAT THE SYSTEM IS INSTALLED AS PER THE DESIGN DRAWINGS AND OPERATES TO MEET
- LOCAL BUILDING CODES REQUIREMENTS. SEISMIC LETTER FROM SEISMIC ENGINEER

DEGREE BENDS OR EQUIVALENT.

SYSTEM DETAILS IN NEW AGE GROUP DOCUMENT.

THE FOLLOWING INFORMATION MUST BE PROVIDED TO THE OWNER UPON PROJECT COMPLETION;

LETTERS OF WARRANTY FROM THE ELECTRICAL CONTRACTORS. AS BUILT DRAWINGS AND MANUALS.

- 1. SECURITY AND CCTV SYSTEM WILL BE SUPPLIED AND INSTALLED BY CLIENT'S VENDOR NEW AGE GROUP. ELECTRICAL CONTRACTOR IS RESPONSIBLE FOR PROVIDING ALL CONDUITS AND POWER AS INDICATED IN THE SYSTEM REQUIREMENT DOCUMENTS.
- 2. SUPPLY AND INSTALL THE REQUIRED EMPTY RACEWAY SYSTEM C/W CONDUITS, PULL BOXES, PANELS, OUTLET BOXES, COVER PLATES, SUITABLE FOR THE INSTALLATION OF ALL SECURITY SYSTEM AND CCTV CABLES AND ASSOCIATED EQUIPMENT.
- MINIMUM CONDUIT SIZE TO BE 19mm. WORK TO BE DONE TO CSA T527 AND 4. UNLESS OTHERWISE SHOWN, STEEL PULLBOXES SHALL BE INSTALLED EVERY 30m OR LESS OF STRAIGHT CONDUIT RUN; EVERY 25m OR LESS OF STRAIGHT

3. RACEWAYS SHALL BE RIGID, GALVANIZED STEEL CONDUIT WHERE EXPOSED

TO MECHANICAL INJURY. IN ALL OTHER LOCATIONS. EMT MAY BE USED.

5. A #6 GROUND WIRE SHALL BE RUN FROM BUILDING GROUND TO A GROUND BAR AT ALL SECURITY BACKBOARD LOCATION. AND CCTV RACK LOCATION.

6. REFER TO DETAILED CONDUIT REQUIREMENT FOR ALL CCTV AND SECURITY

CONDUIT RUN AND ONE 90 DEGREE BEND OR EQUIVALENT; EVERY TWO 90

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No. Date:



FIREARMS OUTLET CANADA

725 WESTNEY ROAD SOUTH, AJAX, ONTARIO L1S 7J7

Drawing Name:

JAN 2025 Project No:

AS NOTED E7.0

THOMAS A. FEKETE LIMITED 7181 WOODBINE AVE. UNIT 229 PH.: (905) 946 4260 FAX: (905) 946 090

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ELECTRICAL

SPECIFICATIONS