Existing Tree Reference Chart

Tree Number (No.), Tree Species, Diameter at Breast Height (DBH), Condition Rating (CR), Tree Category (TC), Location Comments, and Recommendations

No.	Tree Species	DBH (cm)	CR (%)	TC	Comments	Recommendations
#1	Black Maple	11	75	Town	Tree in good condition	To REMAIN; tree beyond limit of development
#2	Black Maple	11	72.5	Town	Tree in good condition	To be PRESERVED; refer to Town standard tree protection fencing
#3	Linden tree	10	60	Town	Tree with coppice growth	To be PRESERVED; refer to Town standard tree protection fencing
#4	Linden tree	10	65	Town	Remove tree with coppice on lower stem	To be REMOVED
#5	Burl Oak	8	75	Town	Remove tree with crown base at 1.2 m	To be REMOVED
#6	Red Oak	8	75	Town	Tree in good condition	To REMAIN; tree beyond limit of development
#7	Red Oak	9	60	Town	Tree with exposed deadwood	To REMAIN; tree beyond limit of development

No.	Tree Species	DBH (cm)	CR (%)	TC	Comments	Recommendations
#8	Green Ash	26		Ravine SW		
#9	Manitoba Maple	21	70	Ravine SW	Leaning tree within 2 m of site	1
#10	Manitoba Maple	21-23	60	Ravine	Leaning tree within 2 m of site]
#11	Manitoba Maple	29	60	Ravine	Leaning tree march into site margin	To REMAIN; tree beyond
#12	Manitoba Maple	31	60	Ravine	Leaning tree march into site margin	limit of development.
#13	Manitoba Maple	36	60	Ravine	Leaning tree march close to site margin	Existing chainlink fence to
#14	Manitoba Maple	48	60	Ravine	Leaning tree march into site margin	act as tree protection fencing
#15	Green Ash	62	40	Ravine	Moribund tree over 8 m from site	for all trees within the ravine.
#16	Green Ash	62-82	20	Ravine	Moribund tree over 8 m from site	1
#17	Green Ash	28	0	Ravine	Fallen dead tree	1
#18	Green Ash	22	0	Ravine NW	Fallen dead tree leaning near neighbour	1




Key Map



Tree Protection

Deciduous Tree

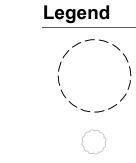



Existing Deciduous Tree to be Removed Existing



(Final Location) Property Line

Tree Canopy



Existing Tree Refrence Key

Reference Key

Toronto, Ontario, Canada. M3C 2G3 tel. 416.492.9966 | email. info@msla.ca Development Consultant: Architect: CONSULTANTS 1282 CORNWALL ROAD OAKVILLE, ONTARIO L6J 7W5 P: 905.337.7249 ex 202

STARNIGHT IMPORTS & EXPORT NIGHT

35B Ironside Cres, Scarborough, ON M1X 1G5

SAPLYS ARCHITECTS INC.

P: 905.510.0595

60 ST. CLAIR AVE W,. SUITE 806

TORONTO, ONTARIO M4T 1N5

MARTON SMITH LANDSCAPE ARCHITECTS


170 The Donway W Suite 206.

Municipality

Notes:

Client/Owner:

06 Issued for Submission 05 Re-Issued for Submission 04 Rev. per Town Comments 03 Re-Issued for Submission 05/29/24 02 Issued for Submission 04/22/24 01 Issued for Coordination No. Revision

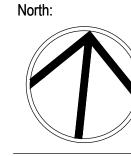




Proposed Landscape and Site Upgrades 45 Blowers Cres Ajax, Ontario

1:200 Date: **Mar 2024** J.B. Checked By: L.M. Drawn By:

Drawing Title:

Tree Inventory & **Preservation Plan**

Project No. Sheet No. 24113 L1-01

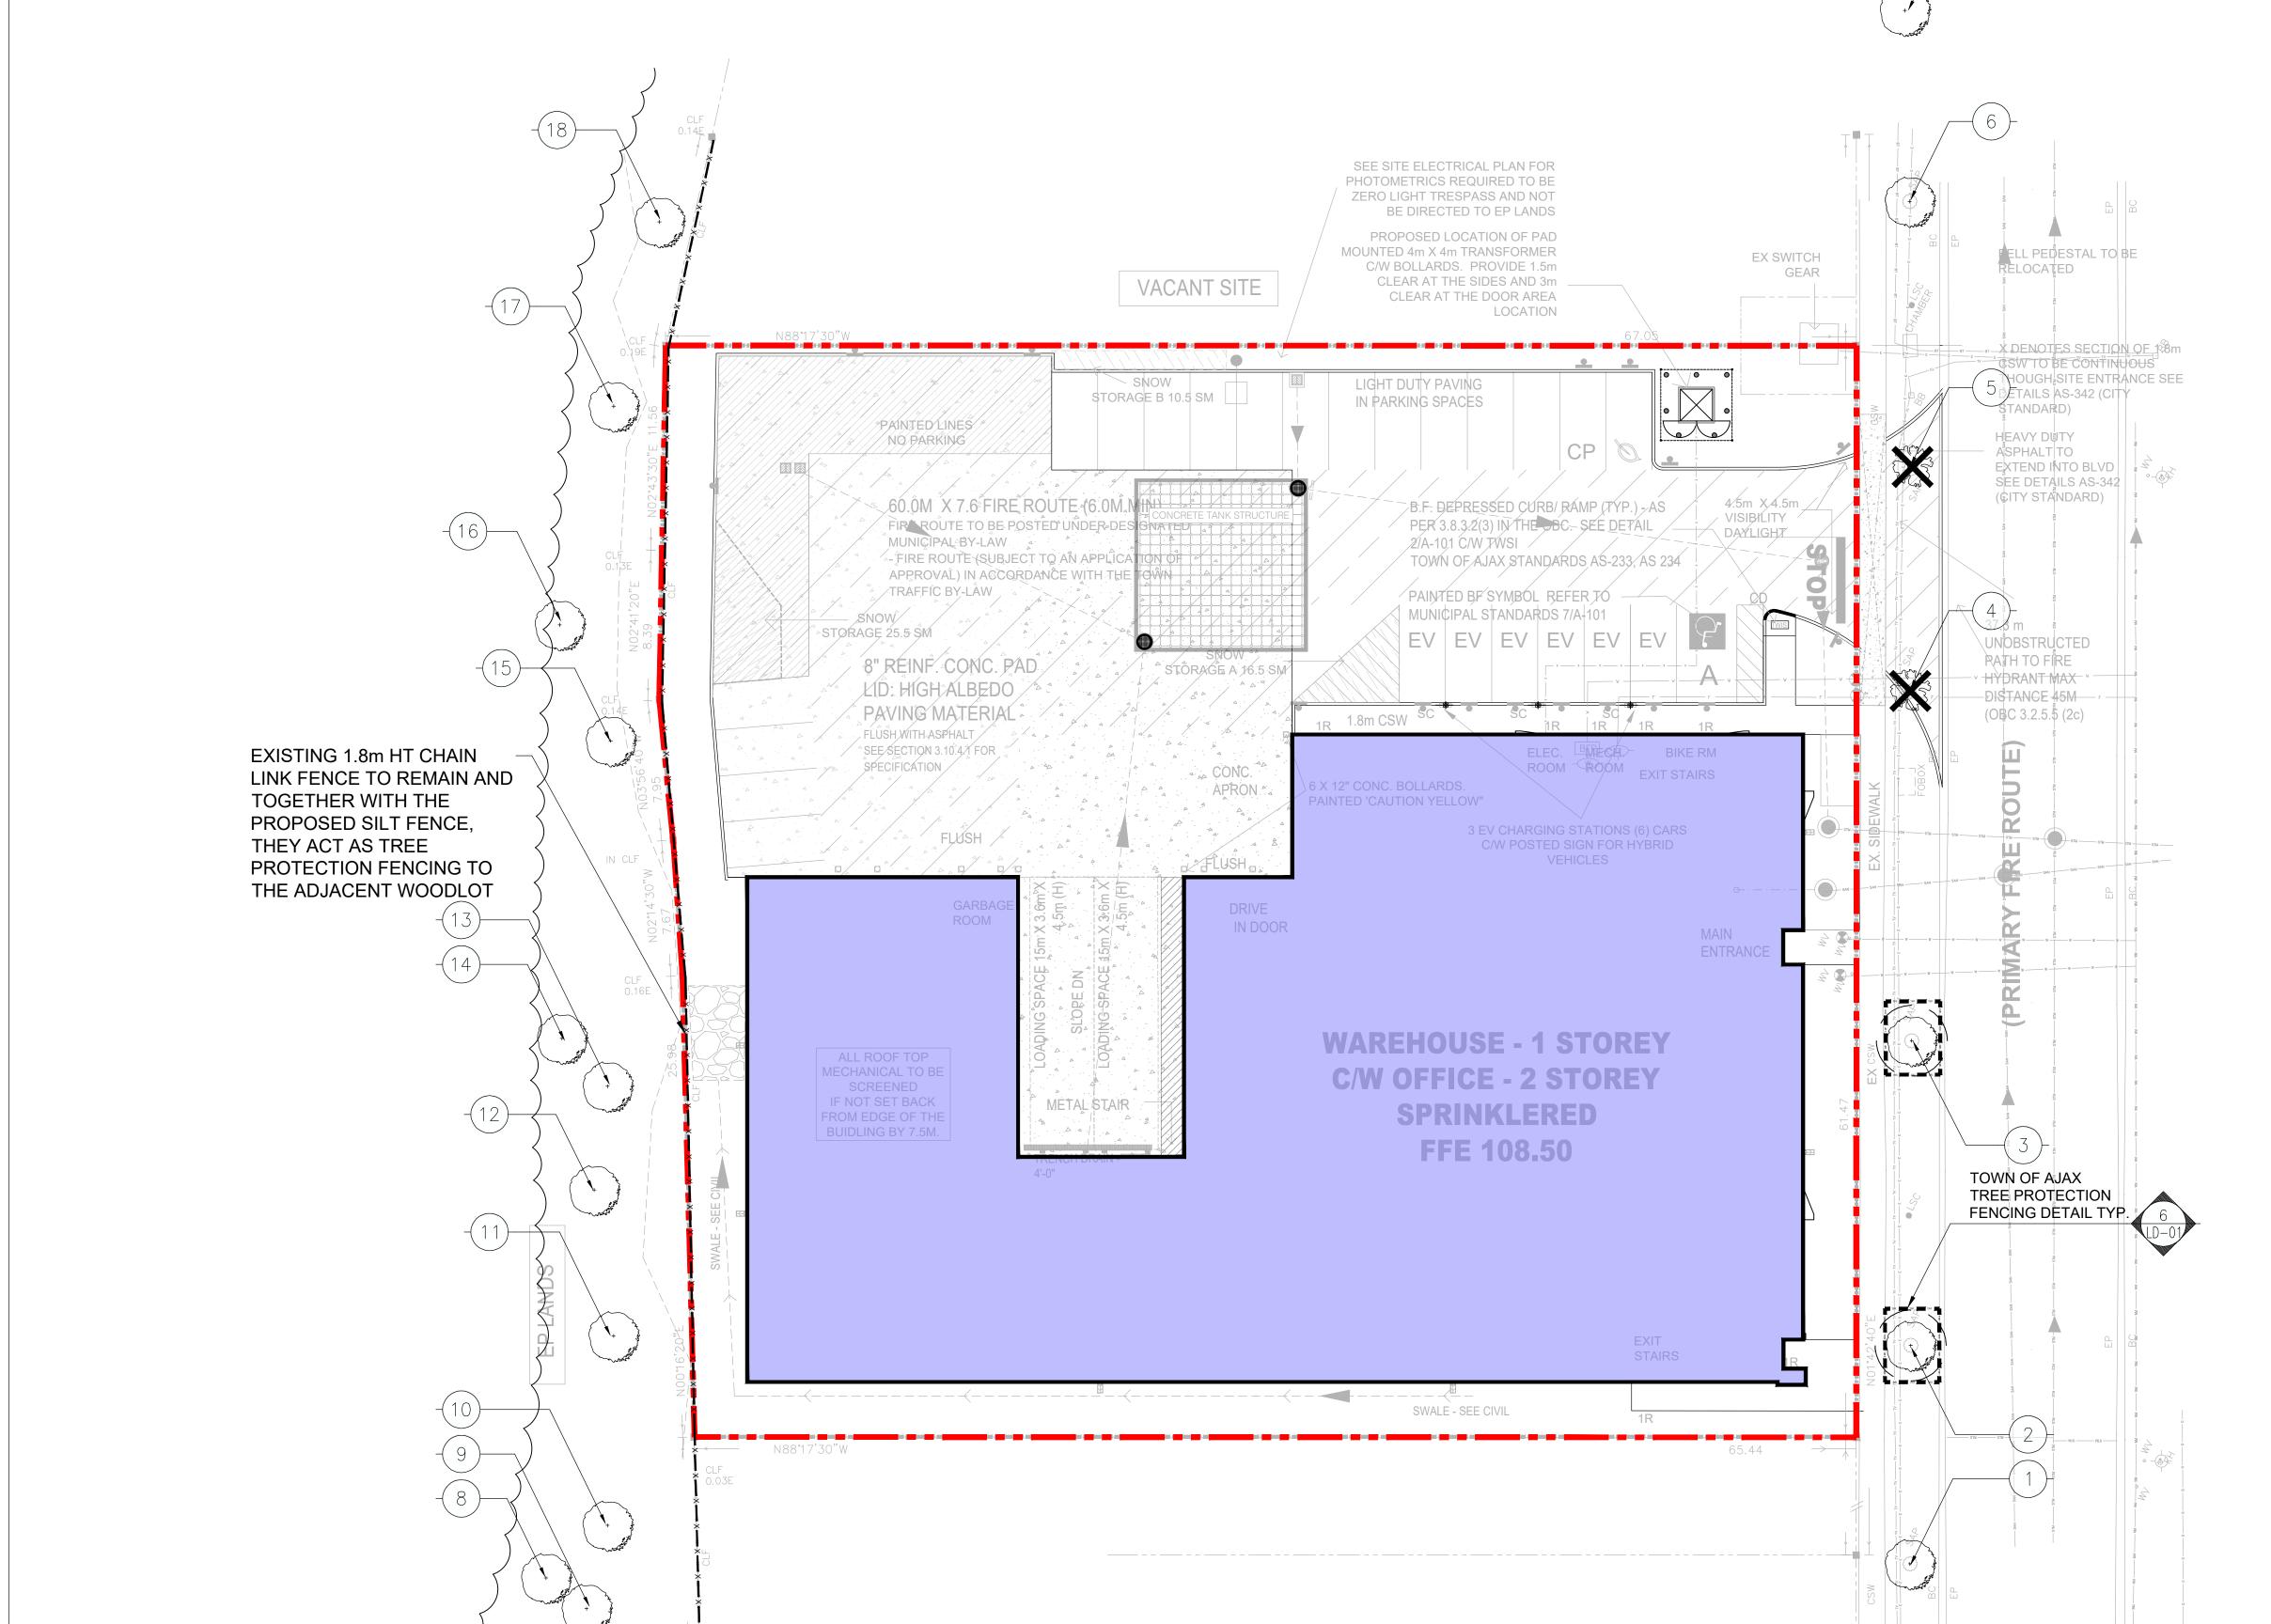

Proposed Plant Material List

	1								
KEY	QNTY	BOTANICAL NAME	COMMON NAME	HT/CAL	SPREAD	ROOT	DROUGHT TOLERANT	NATIVE	REMARKS
DECIDUC	OUS TREE	S							
AXA	5	Acer x freemanii 'Armstrong'	Armstrong Freeman Maple	70 mm		B.&B.	Yes	Yes	Full Form
GDI	3	Gymnocladus dioicus	Kentucky Coffee Tree	70 mm		B.&B.	Yes	Yes	Full Form
GSS	2	Gleditsia triacanthos 'Shademaster'	Shademaster Honey-Locust	70 mm		B.&B.	Yes	No	Full Form
QRB	4	Quercus rubra	Red Oak	70 mm		B.&B.	Yes	Yes	Full Form
TAM	1	Tilia Americana	Basswood Linden	70 mm		B.&B.	Yes	Yes	Full Form
SPECIME	NS						•		
ACB	5	Amelancier canadensis 'Ballerina'	Ballerina Serviceberry	200 cm		B.&B.	Yes	Yes	Multi Stem
CEDARS									
ТОВ	38	Thuja occidentalis 'Brandon'	Brandon Cedar	180 cm		B.&B.	No	Yes	Full Form
DECIDUOUS SHRUBS									
CNS	44	Cornus sericea 'Farrow'	Artic Fire Dogwood	60 cm		C.G.	Yes	Yes	Full Form
НРВ	22	Hydrangea paniculata 'Bombshell'	Dwarf Bombshell Hydrangea	60 cm		5 gal.	No	No	Full Form
SJL	39	Spirea japonica 'Little Princess'	Dwarf Red Spirea	60 cm		C.G.	Yes	Yes	Full Form
RHG	24	Rhus aromatica 'Gro-Low'	'Gro-Low' Fragrant Sumac	60 cm		C.G.	Yes	Yes	Full Form

1.5m HT BLACK

PLACE ON THE

PROP. LINE

VINYL CHAIN LINK

FENCE DETAIL TYP.

PAINTED LINES

MUNICIPAL BY-LAW

TRAFFIC BY-LAW

8" RÉINF. CONC. PAD

LID: HIGH ALBEDO

FLUSH WITH ASPHALT

SEE SECTION 3.10.4 FOR

1.5m HT BLACK

PLACE ON THE

PROP. LINE

VINYL CHAIN LINK

FENCE DETAIL TYP.

SNOW/

STØRAGE 25.5 SM

EXISTING 1.8m HT. CHAINLINK -

NOTE: EXISTING CHAINLINK FENCE PROVIDED AS PART OF THE ORIGINAL PROTECTION LF AND BUFFERING TO THE EP . 1

FENCE TO REMAIN.

60.0M X 7.6 FIRE ROUTE (6.0M.

- FIRE ROUTE (SUBJECT TO AN APPLICA

APPROVAL) IN ACCORDANCE WITH THE

METAL STAIR

TREES TO BE 1.5m

OFFSET FROM THE

PROPERTY LINE.

AVOID TREES.

CONTRACTOR TO

ADJUST SWALE TO

NO PARKING

KEY	QNTY	BOTANICAL NAME	COMMON NAME	HT/CAL	SPREAD	ROOT	DROUGHT TOLERANT	NATIVE	REMARKS
CONIFEROUS SHRUBS									
TCF	13	Taxus x media 'Fairview'	Fairview Yew		65 cm	C.G.	No	No	Full Form
PERENNI	ALS								
GER	56	Geranium 'Rozanne'	Hardy Cranesbill Geranium			2 Gal.	Yes	Yes	Full Form
HSD	51	Hemerocallis 'Stella D'oro'	Stella D'oro (Yellow) Daylilies			2 Gal.	Yes	No	Full Form
PAT	10	Perovskia atriplicifolia	Russian Sage			2 Gal.	Yes	No	Full Form (PPOY Winner)
RUH	24	Rudbeckia hirta	Native Black Eyed Susan			2 Gal.	Yes	Yes	Full Form
GRASSES									
PVN	25	Panicum virgatum 'Northwind'	Northwind Switch Grass			2 Gal.	Yes	Yes	Full Form

ELL PEDESTAL TO BE

X DENOTES SECTION OF 1.8m CSW TO BE CONTINUOUS

THOUGH SITE ENTRANCE SEE

DETAILS AS-342 (CITY

STANDARD)

HEAVY DUTY

BIKE RINGS

DETAIL TYP.

J(1220mm(O;C))

PROVIDE 6 SPACES

3 UNITS TO

RATH TO FIRE

HYDRANT WAX

-DISTANCE 45M-

(OBC 3.2.5.5 (2c)

TOWN OF AJAX

PRECAST CONC.

UNIT PAVERS

DETAIL TYP. TYPE T.B.D.

FENCING

DETAIL TYP.

TREE PROTECTION

RELOCATED

ALL QUANTITIES IN THE LIST OF PLANT MATERIALS ARE TO BE CHECKED BY THE LANDSCAPE CONTRACTOR. ANY DISCREPANCIES ARE TO BE REPORTED TO THE LANDSCAPE ARCHITECT. THE QUANTITIES INDICATED ON THE DRAWINGS SUPERCEDE THE TOTAL QUANTITIES

EX SWITCH

4.5m X.4.5m

VISIBILITY

GEAR

TOTAL PLANTS = 366 DROUGHT TOLERANT = 293 (80%)

SEE SITE ELECTRICAL PLAN FOR

PHOTOMETRICS REQUIRED TO BE

ZERO LIGHT TRESPASS AND NOT

BE DIRECTED TO EP LANDS

PROPOSED LOCATION OF PAD

C/W BOLLARDS. PROVIDE 1.5m

CLEAR AT THE SIDES AND 3m CLEAR AT THE DOOR AREA

2/A-10,1 C/W TWSI

MOUNTED 4m X 4m TRANSFORMER

IN PARKING SPACES

1R 1.8m CSW SC

X 12" CONC. BOLLARDS.

STORAGE B 10.5 SM

STÖRAGE A 16.5 SM

APRON *

NATIVE PLANTS = 268 (73%) SEE L3-01 FOR QUANTITY AND PERCENTAGE BREAKDOWNS

B.F. DEPRESSED CURB/RAMP (TYP.) - AS

TOWN OF AJAX STANDARDS AS-233, AS 234

PER 3.8.3.2(3) IN THE DBC. SEE DETAIL

PAINTED BY SYMBOL REFER TO

MUNICIPAL STANDARDS 7/A-101

WAREHOUSE - 1 STOREY

C/W OFFICE - 2 STOREY

SPRINKLERED

FFE 108.50



Key Map

Existing Deciduous Proposed Tree Canopy Deciduous Tree Tree Protection Specimen Multistem Zone (TPZ) Deciduous Shrubs Proposed Property Line _____ Shrub/Perennial Existing Chain Link — x— x— Fence Prop. 1.5m HT Reference Key Chain Link Fence Tree Protection Plant Material Fencing Reference Key Prop. Concrete Paving Typ. Seed Mix Prop. Unit Reference Key Paving Type 1 Proposed Light $\bigcirc \longleftarrow$ Prop. Sodded Total Area: Standard (by others) $^{^{\downarrow}}$ 65 $^{^{\prime}}$ $^{^{\prime}}$ $^{^{\prime}}$ Area Typ. Prop. Native ⁺ ₊Total Area: ⁺ Seed Mix Typ. . ⁺ +2[†]42 [†]m² ⁺ +

Native Seed Mix Information (TERRASEED application or approved equal)

Legend

2 STOREY MEI

■ The specified seed mix(es) should be applied at a rate of 22-25 kg/ha or at a rate of 125 g/45 m² for smaller areas.

> Cover Crop: ANNUAL RYE NURSE CROP

> (OSC 7115 or approved equal)

• A cover crop should be utilized with each of the seed mixes. The cover crop will act as a nurse crop, provide short term erosion control and weed control.

• The cover crop should be applied at a maximum rate of 20 kg/ha and should be mixed with the proposed seed blend for a single application.

• Mix annual rye with the proposed native seed mixes to provide quick germination and help reduce weed seed germination, stop soil from blowing away and reduce erosion damage from run-off. NOTE: do not over apply annual rye when using it as a nurse crop.

• A depth of 25mm of terraseeding should be applied across the entire area shown to be seeded. This depth is recommended to ensure that seeds are not too deep to germinate

Installations Notes:

• Ideally, sowing should take place in the fall, between Oct 15th to late November. An early spring sowing will work but not as effectively. If moisture is not present, some of the seed may go dormant and not germinate until the following spring. Whenever possible, work up the soil a little to ensure good seed-to-soil contact for improved germination. Call OSC Ltd for more information: 519-886-0557.

• In general, a minimum of 30 cm of topsoil should be applied to disturbed areas prior to terraseeding applications.

• All disturbed areas should be seeded as soon as possible following the completion of works. Erosion controls must remain in place until seeding has sufficiently stabilized the site (i.e.

• Seeding should not be executed during the drought-prone season (i.e. June through August), unless adequate irrigation can be supplied.

• Survey site for invasive species & remove. Clean away surface debris. This increases sunlight penetration to the soil surface and eases sowing. Lightly cultivate soil to accept seed and improve aeration & water retention.

• Make sure the soil and seed are in close contact by gently tamping or rolling the seedbed. Do not compact. Excessive force will destroy soil structure and inhibit germination.

CVC 7 - Upland Native Meadow Mix*

+ + + + -	
+ C1 +	
+3 + -	
+ + + +	
+ + + -	
+ + + +	

Common Name	Scientific Name	Percent of Mix
Black Eyed Susan	Rudbeckia hirta	10%
Heart Leaved Aster	Aster cordifolius	1%
Canada Anemone	Anemone canadensis	1%
Canada Goldenrod	Solidago canadensis	2%
Common Milkweed	Asclepias syriaca	2%
Evening Primrose	Oenethera biennis	25%
Grass Leaved Goldenrod	Euthamia graminifolia	1%
Meadow Sedge	Carex granularis	15%
New England Aster	Aster novae-angliae	1%
Riverbank Wild Rye	Elymus riparius	40%
Virgins Bower	Clematis virginiana	1%
Wild Bergamot	Monarda fistulosa	1%

*Note: Developed by OSC (Ontario Seed Company) **Mixture conforms to the TRCA Native Seed Mix Guidelines



170 The Donway W Suite 206. Toronto, Ontario, Canada. M3C 2G3 tel. 416.492.9966 | email. info@msla.ca

Development Consultant: Architect:



Client/Owner:

P: 905.337.7249 ex 202



STARNIGHT IMPORTS & EXPORT 35B Ironside Cres, Scarborough, ON M1X 1G5

P: 905.510.0595

Municipality



Watering Note:

 The Contractor is responsible for the installation of the trees and shall be responsible to ensure that adequate water is provided to all trees from the point of installation until the date of acceptance. Following the date of acceptance, the owner, or owner's agent, is responsible for ensuring water requirements are being

 The contractor (or owner's agent) shall adjust the automatic irrigation system, if available, and shall apply additional water, using hoses, or gator bags, as required.

 During the initial establishment period, and particularly immediately after installation do not rely on the irrigation system to water the plants. Plants will uptake water only within the root ball and a short distance outside the ball. It is possible to over water the soil while under watering the root ball with the irrigation system. Hand water root balls of all trees and the soil immediately around the root ball to ensure that the root balls have adequate moisture. Test the moisture content in each root ball to determine the water content. Maintain root ball moisture and soil beyond the root ball moisture between 10 and 20% as measured using a General Digital Moisture Meter. Do not over water the soil around the plants.

06 Issued for Submission 05 Re-Issued for Submission 04 Rev. per Town Comments 12/20/24 03 Re-Issued for Submission 05/29/24 02 Issued for Submission 04/22/24 03/25/24 01 Issued for Coordination No. Revision Date North:



Proposed Landscape and Site Upgrades 45 Blowers Cres Ajax, Ontario

1:200 Date: **Mar 2024** J.B. Checked By: L.M. Drawn By:

Drawing Title:

Landscape Plan

Sheet No. **L2-01**



Soil Volume Reference Chart

Soil Area	Soil Area (m²)			Tree Quantity	Soil Volume per tree (m³)
Α	125	1.0	125	2	62.5
В	330	1.1	363	12	30
С	41	1.0	41	1	41
	496		529	15	

Drought Tolerant Landscape Area

VACANT SITE

2.049.10.014.11 241.140	
Total Landscape Area	= 555 m ²
Drought Tolerant Plants	$= 200 \text{ m}^2$
Drought Tolerant Seed Mix	$= 240 \text{ m}^2$
Total Drought Tolerant Area	= 440.0 r
Total Drought Tolerant %	= 79 %

Native Species Landscape Area

manife operate Earlines	шро / шош
Total Landscape Area	= 555 m²
Native Species Plants	= 182.5 n
Native Seed Mix	$= 240 \text{ m}^2$
Total Native Species Area	= 422.5 n
Total Native Species %	= 76 %

EX SWITCH

GEAR

SOIL AREA C:

SEE SITE ELECTRICAL PLAN FOR

ZERO LIGHT TRESPASS AND NOT

BE DIRECTED TO EP LANDS

PROPOSED LOCATION OF PAD MOUNTED 4m X 4m TRANSFORMER

C/W BOLLARDS. PROVIDE 1.5m

CLEAR AT THE SIDES AND 3m


CLEAR AT THE DOOR AREA


PHOTOMETRICS REQUIRED TO BE


Town of Ajax Soil Reuse Requirements

"Planting beds must have topsoil layer with an organic matter content of 10 to 15% by dry weight and a pH of 6.0 to 8.0. The topsoil layer should have a minimum depth of 60cm. The subsoil should have a total uncompacted soil depth of 90 cm."

Legend

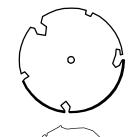

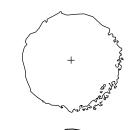

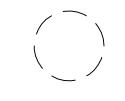

Tree Protection Zone (TPZ)



Tree Protection

Soil Volume

Property Line





1282 CORNWALL ROAD OAKVILLE, ONTARIO L6J 7W5 P: 905.337.7249 ex 202

CONSULTANTSING



STARNIGHT IMPORTS & EXPORT 35B Ironside Cres, Scarborough, ON M1X 1G5

P: 905.510.0595

SAPLYS ARCHITECTS INC.

60 ST. CLAIR AVE W,. SUITE 806

TORONTO, ONTARIO M4T 1N5

Municipality:




MARTON SMITH LANDSCAPE ARCHITECTS

170 The Donway W Suite 206.

Toronto, Ontario, Canada. M3C 2G3

Notes:

05 Re-Issued for Submission 04 Rev. per Town Comments 03 Re-Issued for Submission 02 Issued for Submission 01 Issued for Coordination No. Revision

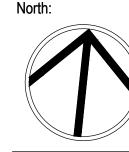




Proposed Landscape and Site Upgrades 45 Blowers Cres Ajax, Ontario

1:200 Date: **Mar 2024** J.B. Checked By: L.M. Drawn By:

Drawing Title:

Soil Volume Plan

Project No. 24113 L3-01

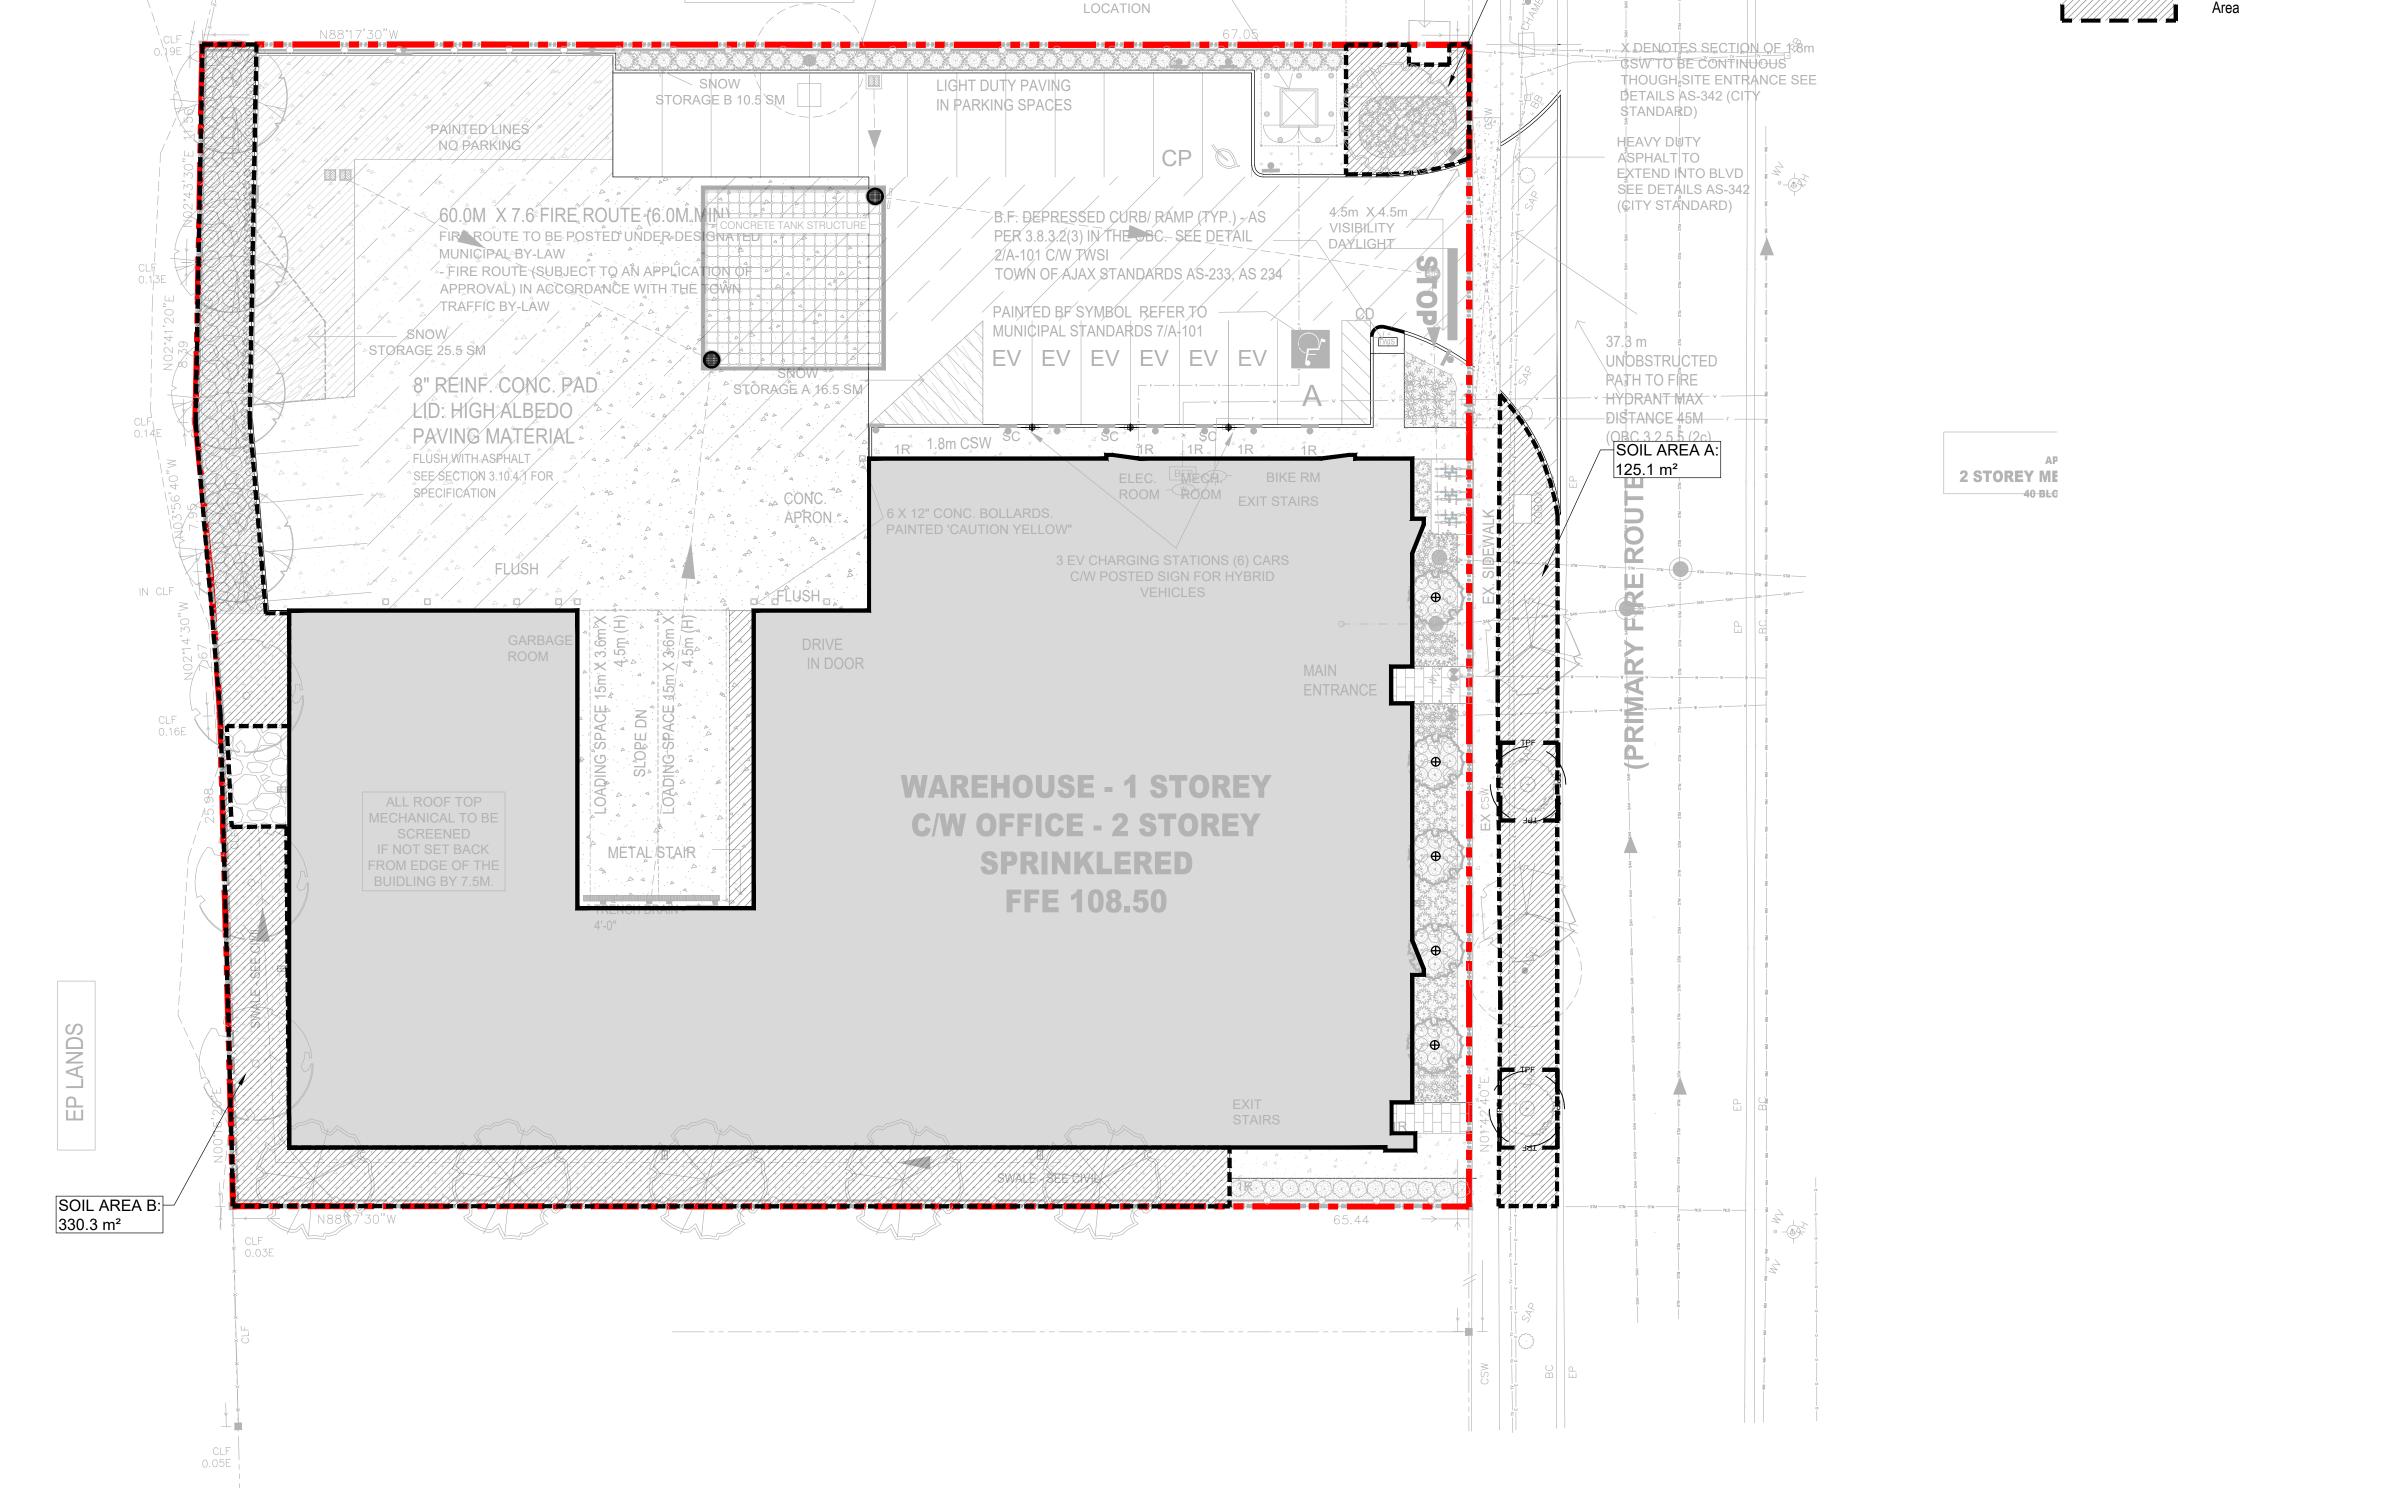

LANDSCAPE SPECIFICATIONS

CONTRACTOR MUST CONTACT ALL UTILITY COMPANIES FOR STAKE OUTS PRIOR TO ANY EXCAVATION OR PLANTING.

ROUGH GRADE AND FILL AREAS TO ESTABLISH SUBGRADE AS REQUIRED. PROVIDE DRAINAGE PATTERN AS INDICATED ON DRAWINGS. ROUND SMOOTHLY ALL TOPS AND TOES OF SLOPES. COMPACT ALL AREAS TO 95% STANDARD PROCTOR DENSITY UNLESS SPECIFIED OTHERWISE. EXISTING TREES TO REMAIN ON SITE ARE TO BE PROTECTED AS DETAILED.

ROUGH GRADING

FINE GRADE ALL AREAS TO FINISHED GRADES AS SHOWN ON LAYOUT OR GRADING PLAN OR ARCHITECT'S SITE PLAN. PROVIDE UNIFORM SLOPES AWAY FROM THE BUILDING, UNLESS SPECIFIED OTHERWISE. SLOPES MAY NOT EXCEED 33 1/3% (3:1).

SCARIFY THE SUBSOIL PRIOR TO THE SPREADING THE TOPSOIL. REMOVE ALL DEBRIS AND LEAVE A FINE-TEXTURED EVEN SURFACE. ALL TOPSOIL TO BE IMPORTED UNLESS PREVIOUSLY APPROVED BY LANDSCAPE ARCHITECT. OBTAIN APPROVAL FOR THE QUALITY OF ANY IMPORTED TOPSOIL BEFORE DELIVERY TO THE SITE. TOPSOIL IS TO BE COMPACTED TO CREATE A FIRM AND EVEN SURFACE.

USE NO. 1 GRADE TURFGRASS NURSERY SOD WHICH CONFORMS WITH THE SPECIFICATIONS OF THE NURSERY SOD GROWERS ASSOCIATION OF ONTARIO. ALL LAWN AREAS SHALL RECEIVE A MINIMUM OF 100MM (4") OF COMPACTED TOPSOIL, AND SHALL BE SODDED WITH #1 KENTUCKY BLUEGRASS - FESCUE. NO SOD SLOPES ARE TO EXCEED 3:1. SLOPE IN EXCESS OF 4:1 TO BE PEGGED.

MINERAL FERTILIZER

SPREADING OF TOPSOIL

APPLY THE FOLLOWING MINERAL FERTILIZER UNLESS SOILS TESTS SHOW OTHER REQUIREMENTS:

MIXTURE. FAILURE TO DO THIS MAY RESULT IN DELAY OF APPROVAL AND ACCEPTANCE.

1. SODDED AREAS - 11% NITROGEN, 8% PHOSPHORUS AND 4% POTASH (11-8-4) AT THE RATE OF 4.5 KG OVER M2 (10 LBS OVER 1000 SQ. FT.).

2. PLANTING BEDS - 7% NITROGEN, 7% PHOSPHORUS AND 7% POTASH (7-7-7) AT THE RATE OF 40 GRAMS (4 OZ.) FOR EVERY BUSHEL OF TOPSOIL. PREPARATION OF PLANTING BEDS

ALL PLANT BEDS TO BE CONTINUOUS. EXCAVATE ALL PLANTING BEDS TO THE DEPTH AS INDICATED ON THE DRAWINGS AND DETAILS, MIN 450mm(18"). BACKFILL ALL PLANTING BEDS WITH A SOIL MIXTURE CONSISTING OF SIX (6) PARTS OF SAND LOAM, ONE (1) PART OF FINELY PULVERIZED PEAT MOSS. TWO (2) PARTS OF WELL-ROTTED MANURE AND THE MINERAL FERTILIZER AS SPECIFIED ABOVE. ALSO ADD .58 KILOS BONEMEAL/CUBIC METER OF

PLANTING SOIL (1 LB./CUBIC YARD). PREPARE THE PLANTING BEDS FOR PLANTING BEFORE THE DELIVERY OF THE PLANT MATERIAL TO THE JOB SITE. NOTE: IF THE EXISTING SOIL CONDITIONS ARE CLAY OR WET IN NATURE, CONTACT THE LANDSCAPE ARCHITECT FOR INSTRUCTIONS OF A SUITABLE SOIL

TOWN OF AJAX SOIL REUSE NOTE

IF REUSING TOPSOIL: PLANTING BEDS MUST HAVE TOPSOIL LAYER WITH AN ORGANIC MATTER CONTENT OF 10 TO 15% BY DRY WEIGHT AND A PH OF 6.0 TO 8.0. THE TOPSOIL LAYER SHOULD HAVE A MINIMUM DEPTH OF 60CM. THE SUBSOIL SHOULD HAVE A TOTAL UNCOMPACTED SOIL DEPTH OF 90 CM. PLANT MATERIALS

ALL PLANT MATERIAL SHALL CONFORM TO THE STANDARDS OF THE CANADIAN NURSERY TRADES ASSOCIATION FOR SIZE AND SPECIES.

ALL SHRUB AND TREE MATERIAL SHALL BE CONTAINER GROWN, POTTED, S/B OR B/B, UNLESS OTHERWISE NOTED. BARE ROOT PLANTING SHALL BE ACCEPTABLE FOR CERTAIN SPECIES DURING EARLY SPRING OR LATE FALL PLANTING SEASON. CONTRACTOR SHALL MAKE REQUESTS FOR ROOT CONDITION SUBSTITUTION IN WRITING TO THE LANDSCAPE ARCHITECT PRIOR TO COMMENCEMENT OF PLANTING OPERATIONS. ALL PLANT MATERIAL TO BE CLAY GROWN STOCK UNLESS OTHERWISE NOTED.

LANDSCAPE SPECIFICATIONS

SCALE: N.T.S. DATE:

PLANT MATERIAL INSTALLATION

ALL TREES, SHRUBS AND GROUNDCOVERS SHALL BE PLANTED AS DETAILED & AS SHOWN ON THE PLANTING PLAN. ALL BEDS TO RECEIVE A COVER OF CLEAN MULCH TO A DEPTH OF 100mm(4"). FOR GUYING AND STAKING TREES, REFER TO PLANTING DETAILS. WRAP ALL DECIDUOUS TREES UNDER EXPERIENCED SUPERVISION ONLY TO THE SPECIFICATIONS OF THE ONTARIO LANDSCAPE

PLANT MATERIAL SIZES AND CONDITIONS ARE TO BE AS INDICATED ON THE LANDSCAPE DRAWING.

THE INDIVIDUAL PLANT GROUPING TOTAL AS ILLUSTRATED ON THE PLANTING PLAN SUPERSEDES THE ESTIMATED QUANTITY ON THE MASTER PLANT LIST. CONTRACTOR MUST REPORT ANY DISCREPANCIES TO THE LANDSCAPE ARCHITECT IN WRITING BEFORE COMMENCING ANY WORK. CONTRACTOR WILL ASSUME FULL RESPONSIBILITY IF LANDSCAPE ARCHITECT IS NOT NOTIFIED. OF

* MULCH - SHREDDED PINE MULCH BY "GRO BARK" OR APPROVED EQUAL. LANDSCAPE ARCHITECT TO APPROVE MULCH BEFORE INSTALLATION.

GENERAL MAINTENANCE

PROPER MAINTENANCE PROCEDURES ARE TO BE FULLY ADMINISTERED FOR ALL NEWLY CONSTRUCTED LANDSCAPE WORK, IN ACCORDANCE WITH LANDSCAPE ONTARIO SPECIFICATIONS (SECTION 1E - MAINTENANCE WORK). THIS SHALL APPLY ONLY DURING THE CONSTRUCTION PERIOD, UNLESS OTHERWISE SPECIFIED. CONTRACTOR IS RESPONSIBLE FOR MAINTENANCE OF SOD AND PLANTING UNTIL FINAL ACCEPTANCE BY LANDSCAPE ARCHITECT.

RODENT PROTECTION

THE CONTRACTOR SHALL BE RESPONSIBLE FOR THE PROTECTION OF ALL TREES AND SHRUBS FOR WINTER PROTECTION AND FROM RODENT INJURY FOR THE DURATION OF GUARANTY PERIOD. PROTECTIVE GUARDS SHALL BE EMPLOYED AROUND ALL DECIDUOUS TREES. GUARDS TO BE 150MM DIA. PVC PIPE OR AS MUNICIPAL GUIDELINES. GUARDS SHALL BE INSTALLED PRIOR TO THE APPLICATION OF THE MULCH AND SHOULD BE PLACED A MINIMUM OF 50MM (2") OUT FROM THE TREE TRUNK ON ALL SIDES.

ALL SHRUBS AND CONIFEROUS TREES SHALL HAVE AN APPLICATION OF "SKOOT" OR APPROVED EQUIVALENT RODENT FORMULA, TO BE APPLIED AT THE END OF OCTOBER. FOLLOW MANUFACTURER'S DIRECTIONS FOR APPLICATION.

GENERAL REQUIREMENTS

USE ABOVE SPECIFICATIONS IN CONJUNCTION WITH THE GENERAL LANDSCAPE SPECIFICATIONS OF THE ONTARIO LANDSCAPE CONTRACTORS ASSOCIATION, THE NURSERY SOD GROWERS ASSOCIATION OF ONTARIO AND WITH THE GUIDE SPECIFICATIONS FOR NURSERY STOCK OF THE CANADIAN NURSERY TRADES ASSOCIATION. USE ONLY PLANT MATERIAL TRUE TO NAME, SIZE AND GRADE AS SPECIFIED ON PLANTING PLAN; PROVIDE SUFFICIENT LABELS OR MARKINGS TO INDICATE CLEARLY THE VARIETY, SIZE AND GRADE OF EACH SPECIMEN OR BUNDLE.


OBTAIN APPROVAL FOR SUBSTITUTIONS AS TO VARIETY, SIZE OR GRADE FROM THE LANDSCAPE ARCHITECT. USE ONLY NURSERY STOCK GROWN UNDER PROPER HORTICULTURAL PRACTICES, VIABLE, FREE FROM PEST AND DISEASE AND UNDAMAGED. CHECK LOCATIONS AND OBTAIN STAKEOUTS OF ALL UTILITY LINES BEFORE EXCAVATION. OBTAIN ALL NECESSARY PERMITS BEFORE COMMENCEMENT OF CONSTRUCTION. REPORT IN WRITING ANY DISCREPANCIES IN THE DRAWINGS, SPECIFICATIONS AND CONTRACT DOCUMENTS TO THE LANDSCAPE ARCHITECT BEFORE THE END OF THE BIDDING PROCESS AND COMMENCEMENT OF CONSTRUCTION. THESE SPECIFICATIONS MAY BE SUPERCEDED BY ADDITIONAL SPECIFICATIONS SET OUT IN THE TENDER DOCUMENTS. CONTRACTOR TO REVIEW ALL DOCUMENTS.

PROVIDE ONE FULL YEAR GUARANTEE ON ALL LANDSCAPE WORK FROM DATE OF FINAL ACCEPTANCE BY LANDSCAPE ARCHITECT. GUARANTEE PERIOD MAY BE EXTENDED TO TWO FULL YEARS DEPENDING ON MUNICIPAL STANDARDS. CONTRACTOR TO VERIFY WITH OWNER AND LANDSCAPE ARCHITECT.

PLANT MATERIAL INSTALLATION

SCALE: N.T.S. DATE:




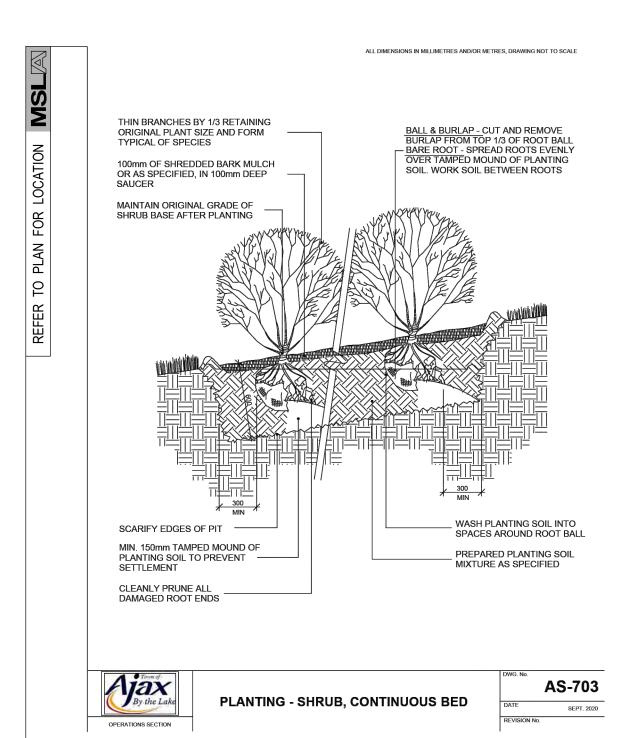




SCALE: N.T.S. DATE:

SCALE: N.T.S. DATE:

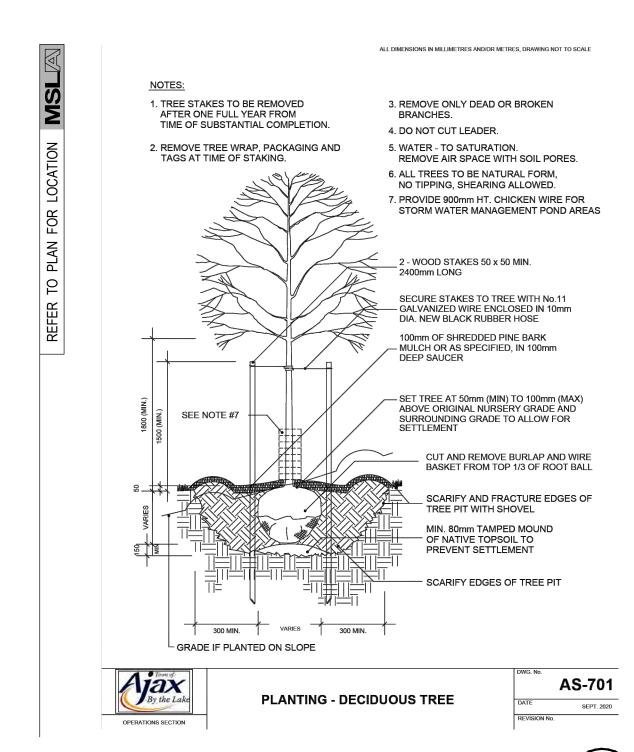


STANDARD DECIDUOUS TREE DETAIL


SCALE: N.T.S. DATE:

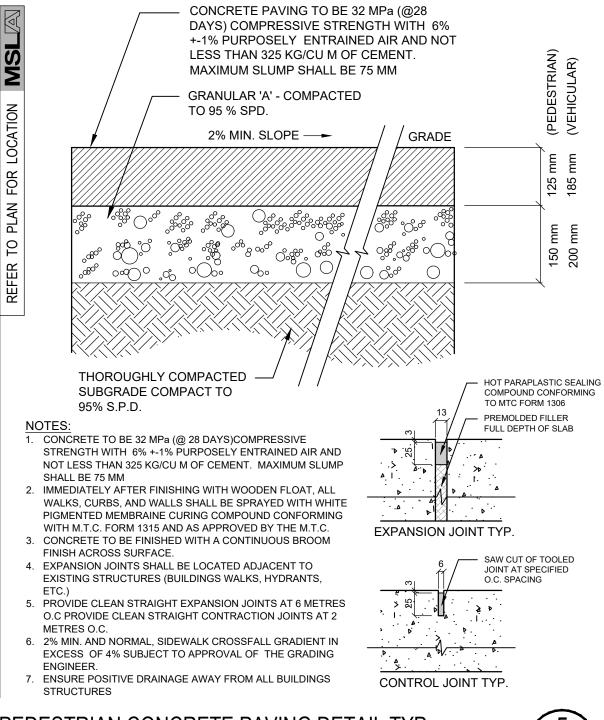

PEDESTRIAN CONCRETE PAVING DETAIL TYP.


SCALE: N.T.S. DATE:

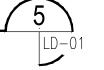


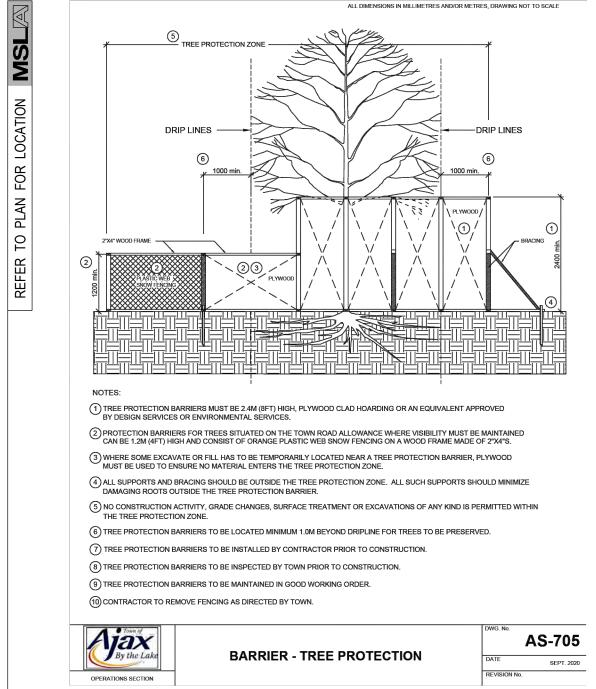


STANDARD TREE PROTECTION FENCING DETAIL

SCALE: N.T.S. DATE:

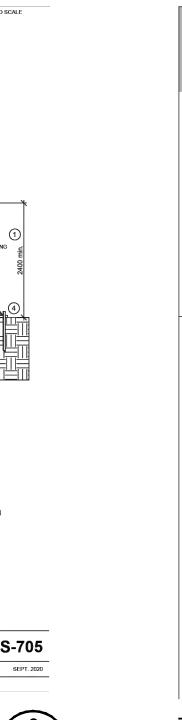


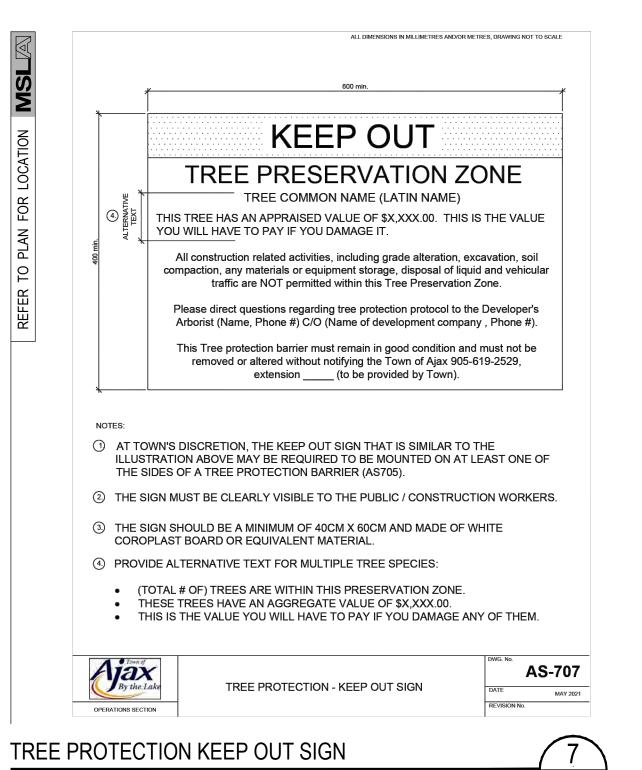



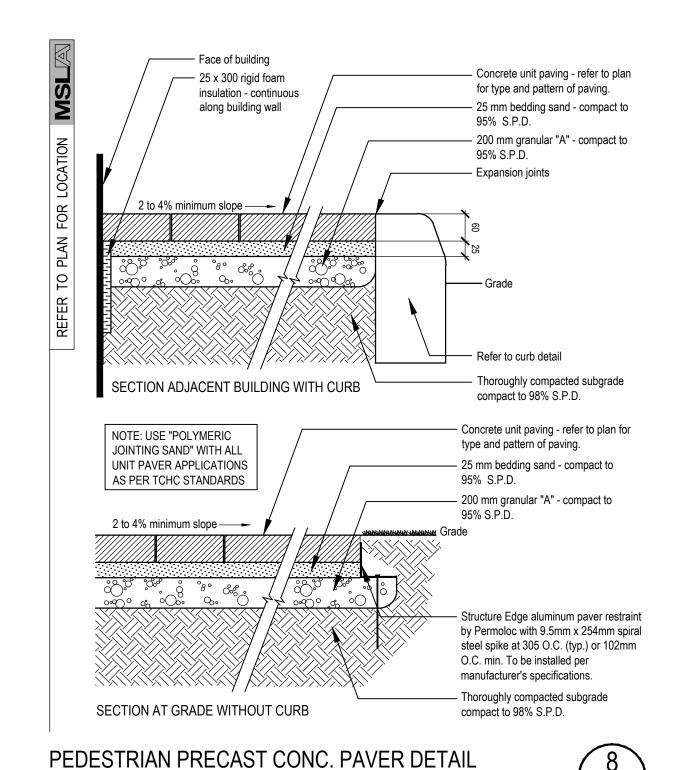



SCALE: N.T.S. WITH ALUMINUM EDGE RESTRAINT

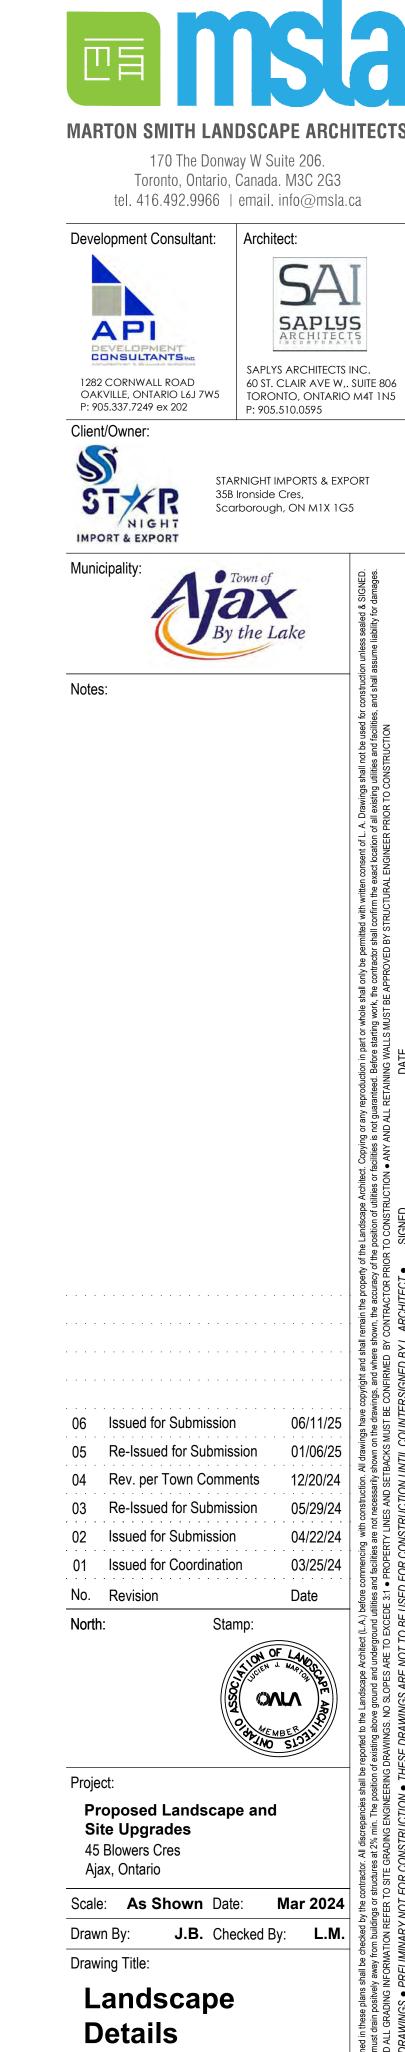

Project No.

LD-01

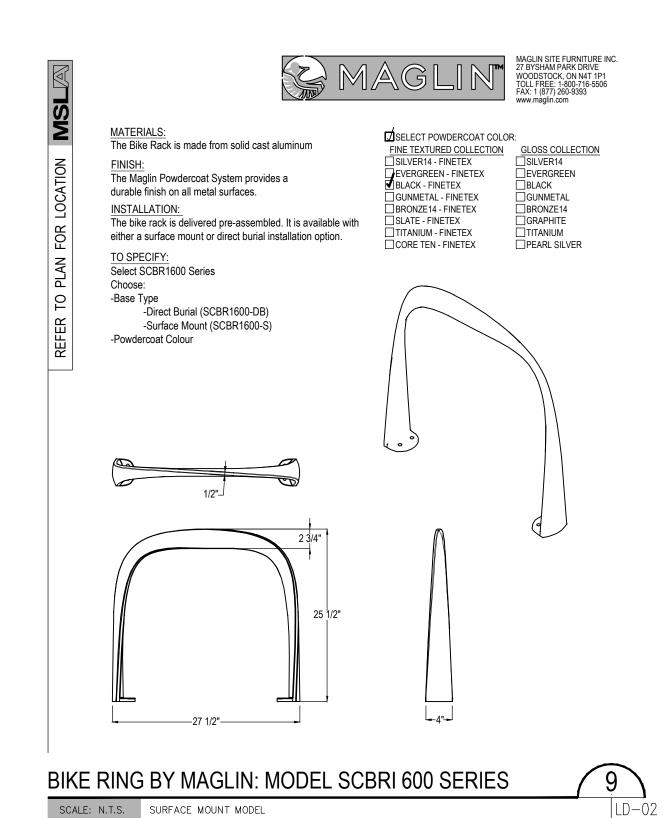

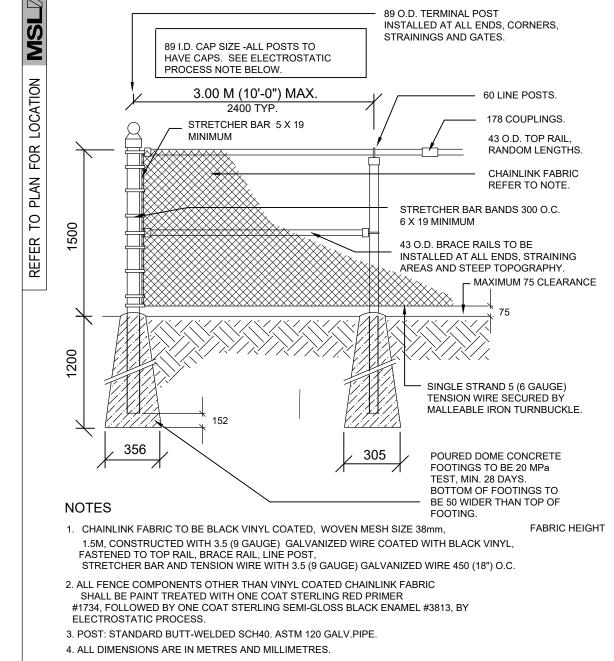

BLACK VINYL CHAINLINK FENCE - HT 1.5 m (5'-0")

MARTON SMITH LANDSCAPE ARCHITECTS

170 The Donway W Suite 206. Toronto, Ontario, Canada. M3C 2G3 tel. 416.492.9966 | email. info@msla.ca

Development Consultant: Architect:



SAPLYS ARCHITECTS INC.

60 ST. CLAIR AVE W,. SUITE 806

TORONTO, ONTARIO M4T 1N5

P: 905.337.7249 ex 202

1282 CORNWALL ROAD

OAKVILLE, ONTARIO L6J 7W5



STARNIGHT IMPORTS & EXPORT 35B Ironside Cres, Scarborough, ON M1X 1G5

P: 905.510.0595

Municipality:



Notes:

06 Issued for Submission 05 Re-Issued for Submission 04 Rev. per Town Comments 03 Re-Issued for Submission 05/29/24 02 Issued for Submission 04/22/24 01 Issued for Coordination 03/25/24 No. Revision North:

Project:

Proposed Landscape and Site Upgrades 45 Blowers Cres Ajax, Ontario

Scale: As Shown Date: Mar 2024

Drawn By: J.B. Checked By: L.M. Drawing Title:

Landscape **Details**

Project No. 24113 **LD-02**

